**ISSUE:** Certificate of Appropriateness for alterations

**APPLICANT:** HF Entwisle LLC

**LOCATION:** 437 N. Columbus Street

Old & Historic Alexandria District

**ZONE:** RM/Residential Townhouse

#### STAFF RECOMMENDATION

Staff recommends approval of the Certificate of Appropriateness, as submitted.

#### **GENERAL NOTES TO THE APPLICANT**

1. APPEAL OF DECISION: In accordance with the Zoning Ordinance, if the Board of Architectural Review denies or approves an application in whole or in part, the applicant or opponent may appeal the Board's decision to City Council on or before 14 days after the decision of the Board.

- 2. COMPLIANCE WITH BAR POLICIES: All materials must comply with the BAR's adopted policies unless otherwise specifically approved.
- 3. BUILDING PERMITS: Most projects approved by the Board of Architectural Review require the issuance of one or more construction permits by Department of Code Administration (<u>including signs</u>). The applicant is responsible for obtaining all necessary construction permits after receiving Board of Architectural Review approval. Contact Code Administration, Room 4200, City Hall, 703-746-4200 for further information.
- 4. ISSUANCE OF CERTIFICATES OF APPROPRIATENESS AND PERMITS TO DEMOLISH: Applicants must obtain a copy of the Certificate of Appropriateness or Permit to Demolish PRIOR to applying for a building permit. Contact BAR Staff, Room 2100, City Hall, 703-746-3833, or preservation@alexandriava.gov for further information.
- 5. EXPIRATION OF APPROVALS NOTE: In accordance with Sections 10-106(B), 10-206(B) and 10-307 of the Zoning Ordinance, any Board of Architectural Review approval will expire 12 months from the date of issuance if the work is not commenced and diligently and substantially pursued by the end of that 12-month period.
- 6. HISTORIC PROPERTY TAX CREDITS: Applicants performing extensive, certified rehabilitations of historic properties may separately be eligible for state and/or federal tax credits. Consult with the <u>Virginia Department of Historic Resources (VDHR)</u> prior to initiating any work to determine whether the proposed project may qualify for such credits.



#### I. <u>APPLICANT'S PROPOSAL</u>

The applicant requests a Certificate of Appropriateness for alterations and repairs to the rear second and third floor porches at 437 N. Columbus Street.

The following alterations are proposed:

- Removal of the existing stair connecting the second and third floors
- Replacement of the wood columns, railings and trim
- Installation of a wood picket railing at the second-floor to match the third floor railing
- Replacement of the existing sloped roof with a new roof with the same slope.
- Painting all wood white

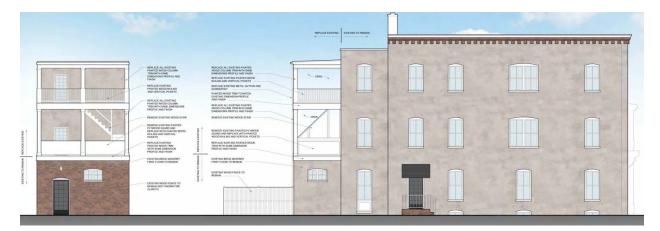


Figure 1: Existing

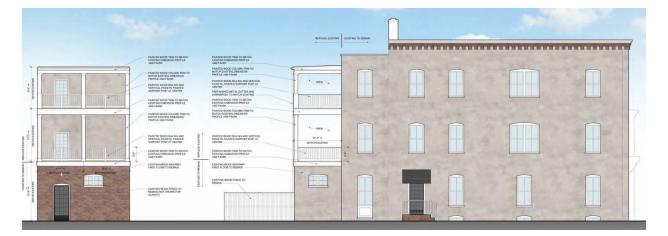


Figure 2: Proposed

#### Site context

The building is located on the corner of N. Columbus and Oronoco streets. The alley behind the subject property is private.

#### II. HISTORY

The three-story Italianate style masonry building was constructed as a grocery store sometime between **1896 and 1902**, according to Sanborn Fire Insurance Maps. The front façade retains many of the original details, including oversized brackets, decorative trim and two-over-two windows on the upper floors. The one-story masonry addition was constructed sometime between 1907 by 1912 (Sanborn).

Previous BAR Approvals

Staff could locate no previous BAR approvals for the subject property.

#### III. <u>ANALYSIS</u>

Staff finds that the proposed porch alterations comply with the following guidelines in the Porch chapter of the *Design Guidelines*: "Porches should be appropriate to the historical style of the structure" and "Porches should generally be painted the predominant color of the building or the color of the trim work." While staff believes that the porches do not date to the original period of construction, they may have been constructed as early as the early 20<sup>th</sup> century when the first-floor addition was constructed. There have been numerous repairs to the porches over the years, but the current condition requires more extensive repair and replacement to make them structurally sound. Staff is pleased that the applicant intends to use wood as the predominant replacement material and supports the replacement of the solid wood railing at the second story with historically appropriate wood pickets.

Staff recommends approval of the project, as submitted.

#### **STAFF**

Stephanie Sample, Historic Preservation Planner, Planning & Zoning Tony LaColla, AICP, Land Use Services Division Chief, Planning & Zoning

#### IV. CITY DEPARTMENT COMMENTS

Legend: C- code requirement R- recommendation S- suggestion F- finding

#### **Zoning**

F-1 The proposed rear porch alterations comply with zoning.

#### **Code Administration**

F-1 A building permit and plan review are required prior to the start of construction.

## **Transportation and Environmental Services CONDITIONS**

- R-1 The building permit must be approved and issued prior to the issuance of any permit for demolition, if a separate demolition permit is required. (T&ES)
- R-2 Applicant shall be responsible for repairs to the adjacent city right-of-way if damaged during construction activity. (T&ES)
- R-3 No permanent structure may be constructed over any existing private and/or public utility easements. It is the responsibility of the applicant to identify any and all existing easements on the plan. (T&ES)

#### **FINDINGS**

- F-1 After review of the information provided, an approved grading plan is not required at this time. Please note that if any changes are made to the plan it is suggested that T&ES be included in the review. (T&ES)
- F-2 If the alley located at the rear of the parcel is to be used at any point of the construction process the following will be required:

<u>For a Public Alley -</u> The applicant shall contact T&ES, Construction Permitting & Inspections at (703) 746-4035 to discuss any permits and accommodation requirements that will be required.

<u>For a Private Alley</u> - The applicant must provide proof, in the form of an affidavit at a minimum, from owner of the alley granting permission of use. (T&ES)

#### **CODE REQUIREMENTS**

- C-1 The applicant shall comply with the City of Alexandria's Solid Waste Control, Title 5, Chapter 1, which sets forth the requirements for the recycling of materials (Sec. 5-1-99). (T&ES)
- C-2 The applicant shall comply with the City of Alexandria's Noise Control Code, Title 11, Chapter 5, which sets the maximum permissible noise level as measured at the property line. (T&ES)
- C-3 Roof, surface and sub-surface drains be connected to the public storm sewer system, if available, by continuous underground pipe. Where storm sewer is not available applicant must provide a design to mitigate impact of stormwater drainage onto adjacent properties and to the satisfaction of the Director of Transportation & Environmental Services. (Sec.5-6-224) (T&ES)
- C-4 All secondary utilities serving this site shall be placed underground. (Sec. 5-3-3) (T&ES)

- C-5 Any work within the right-of-way requires a separate permit from T&ES. (Sec. 5- 2) (T&ES)
- C-6 All improvements to the city right-of-way such as curbing, sidewalk, driveway aprons, etc. must be city standard design. (Sec. 5-2-1) (T&ES)

#### V. <u>ATTACHMENTS</u>

- 1— Application for BAR 2020-00413: 437 N. Columbus Street
- 2 Supplemental Materials

	DAIL Gase #
ADDRESS OF PROJECT: 437 N. COLUMBUS STREET ALEXANDRIA	, VIRGINIA 22314
DISTRICT: Old & Historic Alexandria Parker – Gray	
TAX MAP AND PARCEL: 064.02-08-01	zoning: RM
APPLICATION FOR: (Please check all that apply)	
■ CERTIFICATE OF APPROPRIATENESS	
PERMIT TO MOVE, REMOVE, ENCAPSULATE OR DEMO (Required if more than 25 square feet of a structure is to be demolished/im	
WAIVER OF VISION CLEARANCE REQUIREMENT and/or CLEARANCE AREA (Section 7-802, Alexandria 1992 Zoning Ordina	
WAIVER OF ROOFTOP HVAC SCREENING REQUIREMENT (Section 6-403(B)(3), Alexandria 1992 Zoning Ordinance)	NT
Applicant: Property Owner Business (Please provide in	business name & contact person)
Name: HF ENTWISLE LLC	
Address: 1707 DUKE ST.	_
City: ALEXANDRIA State: VA Zip: 2	2314
Phone: 703-549-6103 E-mail: dan@crho	poff.com
Authorized Agent (if applicable): Attorney Architecture	ct
Name:	Phone:
E-mail:	
Legal Property Owner:	
Name: H F ENTWISLE LLC	_
Address: 1707 DUKE STREET	
City: ALEXANDRIA State: VA Zip: 2	2314
Phone: 703.549.6103 E-mail: dan@crhooff	
Yes No Is there an historic preservation easement on this Yes No If yes, has the easement holder agreed to the property Yes No Is there a homeowner's association for this property Yes No If yes, has the homeowner's association approve	oposed alterations? erty?

If you answered yes to any of the above, please attach a copy of the letter approving the project.

		-	
			BAR Case #
NATUR	RE OF PROPOSED WORK: Please check all that apply	L	
	] doors	ling	C equipment
	RIPTION OF PROPOSED WORK: Please describe to	he	proposed work in detail (Additional pages may
be attach	•		WOOD FRAME EXTERIOR
	OVE AND REPLACE IN KIND DETERIORATION OF THE PROPERTY OF THE P		
-	RED PORCH ON SECOND AND THIRD FLO		
	ONRY WALLS TO REMAIN. REPLACEMENT	_	
	ARANCE MATCHING EXISTING PAINTED	_	
EXIST	TING INTERNAL STAIR CONNECTING THE	St	ECOND AND THIRD FLOORS.
		_	
		_	
SUBM	ITTAL REQUIREMENTS:		
request	sted below comprise the <b>minimum supporting mate</b> additional information during application review. Pleat Guidelines for further information on appropriate treater	se	refer to the relevant section of the
materia docketi	ints must use the checklist below to ensure the applical that are necessary to thoroughly describe the projecting of the application for review. Pre-application meeting icants are encouraged to meet with staff prior to submit	. In	complete applications will delay the are required for all proposed additions.
	lition/Encapsulation: All applicants requesting 25 squ mplete this section. Check N/A if an item in this section does		
N/A	Survey plat showing the extent of the proposed demo Existing elevation drawings clearly showing all element Clear and labeled photographs of all elevations of the to be demolished.  Description of the reason for demolition/encapsulation	nts bu	proposed for demolition/encapsulation.
	Description of the reason for demolition/encapsulation  Description of the alternatives to demolition/encapsulation  considered feasible.		on and why such alternatives are not

BAR Case #
------------

Additions & New Construction: Drawings must be to scale and should not exceed 11" x 17" unless approved by staff. Check N/A if an item in this section does not apply to your project.

_	N/A	
		Scaled survey plat showing dimensions of lot and location of existing building and other structures on the lot, location of proposed structure or addition, dimensions of existing structure(s), proposed addition or new construction, and all exterior, ground and roof mounted equipment.
		FAR & Open Space calculation form. Clear and labeled photographs of the site, surrounding properties and existing structures, if applicable.
		Existing elevations must be scaled and include dimensions.  Proposed elevations must be scaled and include dimensions. Include the relationship to
		adjacent structures in plan and elevations.  Materials and colors to be used must be specified and delineated on the drawings. Actual samples may be provided or required.
	_	Manufacturer's specifications for materials to include, but not limited to: roofing, siding, windows, doors, lighting, fencing, HVAC equipment and walls.
П		For development site plan projects, a model showing mass relationships to adjacent properties and structures.
illun	ninat	& Awnings: One sign per building under one square foot does not require BAR approval unless ed. All other signs including window signs require BAR approval. Check N/A if an item in this section does to your project.
		Linear feet of building: Front:Secondary front (if corner lot):  Square feet of existing signs to remain:  Photograph of building showing existing conditions.  Dimensioned drawings of proposed sign identifying materials, color, lettering style and text.  Location of sign (show exact location on building including the height above sidewalk).  Means of attachment (drawing or manufacturer's cut sheet of bracket if applicable).  Description of lighting (if applicable). Include manufacturer's cut sheet for any new lighting fixtures and information detailing how it will be attached to the building's facade.
Alte	erat	ions: Check N/A if an item in this section does not apply to your project.
	N/A	Clear and labeled photographs of the site, especially the area being impacted by the alterations, all sides of the building and any pertinent details.  Manufacturer's specifications for materials to include, but not limited to: roofing, siding, windows,
×		doors, lighting, fencing, HVAC equipment and walls.  Drawings accurately representing the changes to the proposed structure, including materials and overall dimensions. Drawings must be to scale.
		An official survey plat showing the proposed locations of HVAC units, fences, and sheds.  Historic elevations or photographs should accompany any request to return a structure to an earlier appearance.

	BAR Case #	
ALL APPLICATIONS: Please read and check that you have read	d and understand the following items:	== W

ALL	ALL APPLICATIONS: Please read and check that you have read and understand the following items:					
8	I have submitted a filing fee with this application. (Checks should be made payable to the City of Alexandria. Please contact staff for assistance in determining the appropriate fee.)					
x	I understand the notice requirements and will return a copy of the three respective notice forms to BAR staff at least five days prior to the hearing. If I am unsure to whom I should send notice I will contact Planning and Zoning staff for assistance in identifying adjacent parcels.					
x	I, the applicant, or an authorized representative will be present at the public hearing.					
×	I understand that any revisions to this initial application submission (including applications deferred for restudy) must be accompanied by the BAR Supplemental form and revised materials.					
elevat accura action grants Section this appropriate to main APPI	indersigned hereby attests that all of the information herein provided including the site plan, building tions, prospective drawings of the project, and written descriptive information are true, correct and ate. The undersigned further understands that, should such information be found incorrect, any taken by the Board based on such information may be invalidated. The undersigned also hereby the City of Alexandria permission to post placard notice as required by Article XI, Division A, on 11-301(B) of the 1992 Alexandria City Zoning Ordinance, on the property which is the subject of oplication. The undersigned also hereby authorizes the City staff and members of the BAR to cot this site as necessary in the course of research and evaluating the application. The applicant, if than the property owner, also attests that he/she has obtained permission from the property owner ke this application.  **LICANT OR AUTHORIZED AGANT:**  LICANT OR AUTHORIZED AGANT:**  **LICANT OR AUTHORIZE					



August 25, 2020

City of Alexandria Virginia
Alonzo Hicks, Plans Examiner III
Department of Code Administration
703.746.4195 Direct, 703.746.4200 Office
Alonzo.Hicks@alexandriava.gov

Re: 718 Oronoco Street / 437 N Columbus Street BLDC2020-00717- Permit Review

Dear Mr. Hicks,

I am providing this correspondence for record in response to your permit review comment, and our subsequent conversation on the morning of Wednesday August 19, 2020 on the matter of the existing Means of Egress for this property.

As I've stated, It may not be clear in the application that the work is to be performed in accordance with the VEBC Alteration Level II, and that the existing exterior porch stair connects only the second and third floor porch areas. As it does not lead to the public way it does not and can not serve as a Means of Egress, so its removal in the replacement of the porch does not impact the existing egress.

The existing egress paths as well as the use and occupancy remain unchanged by the proposed work.

I have visited the property and personally observed the existing egress stair, which connects the three occupied residential units, one at each level: ground, two, and three. This existing interior stair appears to be original to the historic building, is centrally located in the floor plan, and leads directly to the public way on the north façade along Oronoco Street. Additional exits from the ground level unit are provided on the West along N Columbus Street, and on the East to the rear yard.

If I can assist you with further understanding my response with regard to this issue, please contact me at (202) 721-1686 or by email <a href="mailto:KTerzian@OPXGlobal.com">KTerzian@OPXGlobal.com</a>.

Sincerely

Ken Terzian, AIA, LEED AP BD+C

Principal

Cc: CF 3355-132

## OWNERSHIP AND DISCLOSURE STATEMENT Use additional sheets if necessary

1. Applicant. State the name, address and percent of ownership of any person or entity owning an interest in the applicant, unless the entity is a corporation or partnership, in which case identify each owner of more than three percent. The term ownership interest shall include any legal or equitable interest held at the time of the application in the real property which is the subject of the application.

Name	Address	Percent of Ownership
1. See attached documents		
2.		
3.		

2. Property. State the name, address and percent of ownership of any person or entityowning an interest in the property located at 437 N Columbus St. Alexandria. VA 22314 (address), unless the entity is a corporation or partnership, in which case identify each owner of more than three percent. The term ownership interest shall include any legal or equitable interest held at the time of the application in the real property which is the subject of the application.

Name	Address	Percent of Ownership
<sup>1</sup> See attached documents	٨	
2.		
3.		

3. Business or Financial Relationships. Each person or entity listed above (1 and 2), with an ownership interest in the applicant or in the subject property is required to disclose **any** business or financial relationship, as defined by Section 11-350 of the Zoning Ordinance, existing at the time of this application, or within the12-month period prior to the submission of this application with any member of the Alexandria City Council, Planning Commission, Board of Zoning Appeals or either Boards of Architectural Review.

Name of person or entity	Relationship as defined by Section 11-350 of the Zoning Ordinance	Member of the Approving Body (i.e. City Council, Planning Commission, etc.)
1.		
2.		
3.		

NOTE: Business or financial relationships of the type described in Sec. 11-350 that arise after the filing of this application and before each public hearing must be disclosed prior to the public hearings.

As the applicant	or the applicant's authorized a	gent, I hereby attest to the best of my ability that
	rovided above is true and corre	
1	16 1 911	fin Shan R. M.D
مرمد ۱۸۷۵	Chrise K Host	Lis X pun (7. /m)
Date	Printed Name	Signature

## EXHIBIT A MEMBERS, MEMBER GROUPS, INTERESTS AND CAPITAL ACCOUNTS

Member Group and Members	Interests	Capital Accounts
Hooff Group		
Hooff Associates Limited Partnership	40%	41.44
Fagelson Group		
Bernard M. Fagelson 2012 Dynasty Trust	10%	
Helen C. Fagelson 2012 Dynasty Trust	10%	
John L. Fagelson and Karen C. Fagelson.	20%	
Tenants by the Entirety		
Billowitz-Holland Group		17.77
Lorna P. Holland	1.670%	
C. Elizabeth Nugent	2.083%	
Mark E. F. Nugent	2.083%	
Patrick R. Nugent	2.083%	
Rebecca H. Nugent	2.083%	
Edward K Billowitz	3.330%	
Lorrain K. Melnicoff	3.330%	
Susan M. Pevenstein and Jack E. Pevenstein	3.330%	
TOTAL	100%	

#### Department of Planning and Zoning Floor Area Ratio and Open Space Calculations as of 12/20/18

B


as 01 12/20/10

A.	<b>Property Info</b>	rmation						
<b>A1</b> .	437 N. COLUMBU Street Address	JS ST. ALEXAND	RIA, V	IRGINIA 22315		RM Zone	•	
A2.	2,000.00 Total Lot Area		x	Floor Area Ratio Allowed by Zone	<b>=</b> (		mum Aliowable Floor Area	
B. B1.	Existing Gross Existing Gross Basement First Floor Second Floor Third Floor Attic Porches Balcony/Deck Lavatory*** Other** Total Gross		B2.	Allowable Exclusions**  Basement** Stairways** Mechanica(**  Attic less than 7'** Porches** Balcony/Deck** Lavatory*** Other** Other**  Total Exclusions 0.00	-	B2.	0.00 Existing Gross Floor Area* 0.00 Allowable Floor Exclusions** 0.00 Existing Floor Area Minus Exclu (subtract 82 from B1)	
c.	Proposed Gross		a	Allowable Exclusions**		•		
	Basement			Basement**		C1.	0.00	Sq. Ft.
	First Floor			Stairways**			Proposed Gross Floor Area*	III THE
	Second Floor			Mechanical**		C2.	0.00	Sq. Ft.
						10	Allowable Floor Exclusions**	
	Third Floor			Attic less than 7'**		С3.	0.00	Sq. Ft.
	Attic			Porches**			Proposed Floor Area Minus Exclusion (subtract C2 from C1)	
	Porches			Balcony/Deck**			1000000 02 110/11 01/	
	Balcony/Deck			Lavatory***				
	Lavatory***			Other**				
	Other			Other**			Notes	
C1.	Total Gross	0.00	C2.	Total Exclusions 0.00			*Gross floor area is the sum of under roof of a lot, measured from	
D.	Total Floor A	rea		E. Open Space			of exterior walls, including be garages, sheds, gazebos, guest and other accessory buildings.	
D1.	0.00 Sq. Ft. Total Floor Area (add B3 and C3)			E1. Sq. Ft.			** Refer to the Zoning Ordinance (Section 2-145(B)) and consult with Zoning Staff	
				Existing Open Space			information regarding allowable exclusion Sections may also be required for s	
D2.	0.00	Sq. Ft.		E2.	Sq. Ft.		exclusions.	ici somo
	Total Floor Area A by Zone (A2)			Required Open Space  E3.  Proposed Open Space	Sq. Ft.		***Lavatories may be excluded maximum of 50 square feet, per The maximum total of excludable lavatories shall be no greater that gross floor area.	lavatory. area for

The undersigned nereby contifies and attests that, to the best of his/her knowledge, the above computations are true and correct.

Signature: Signature:

Date: au 14, 2020

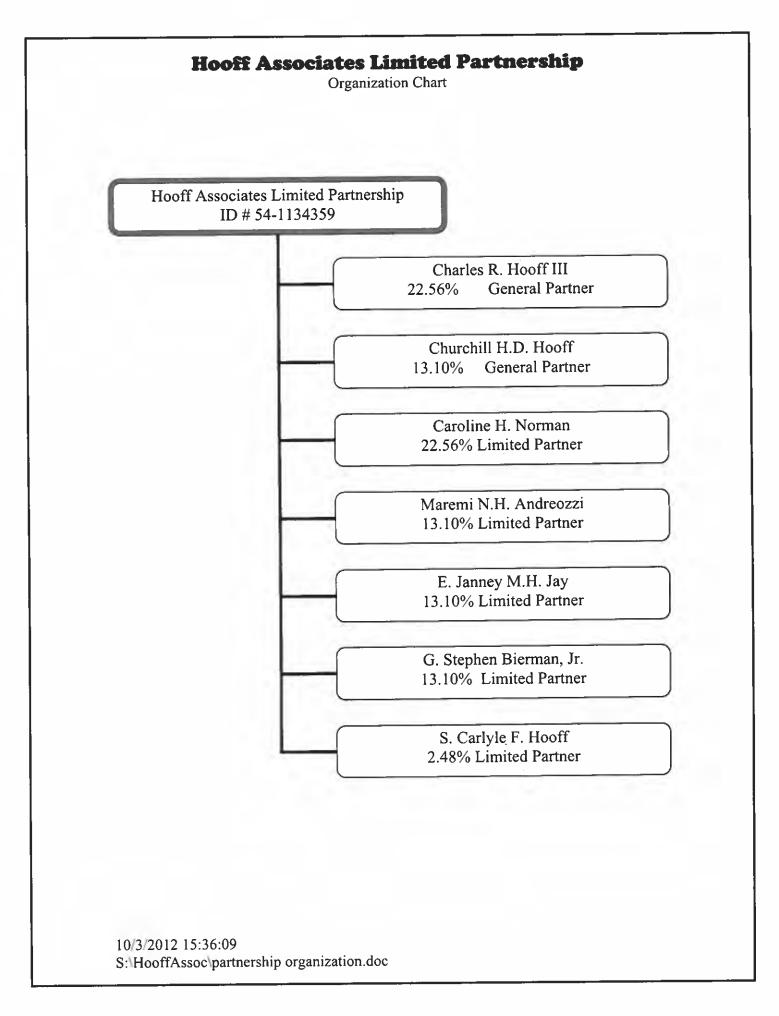


Sep 22 09 11:16a The Manarin Group NOTES :

TODAMENEN BY ALEXANDRIA SURVEYS INTERNATIONAL, LLC THE INFORMATION CONTAINED ON THIS DOCUMENT MAY NOT

1. FENCES ARE STOCKADE UNLESS NOTED. AREA 2,042 S.F.

Edited by Foxit PDF Editor Copyright (c) by Foxit Software Company, 2003 - 2009 For Evaluation Only.

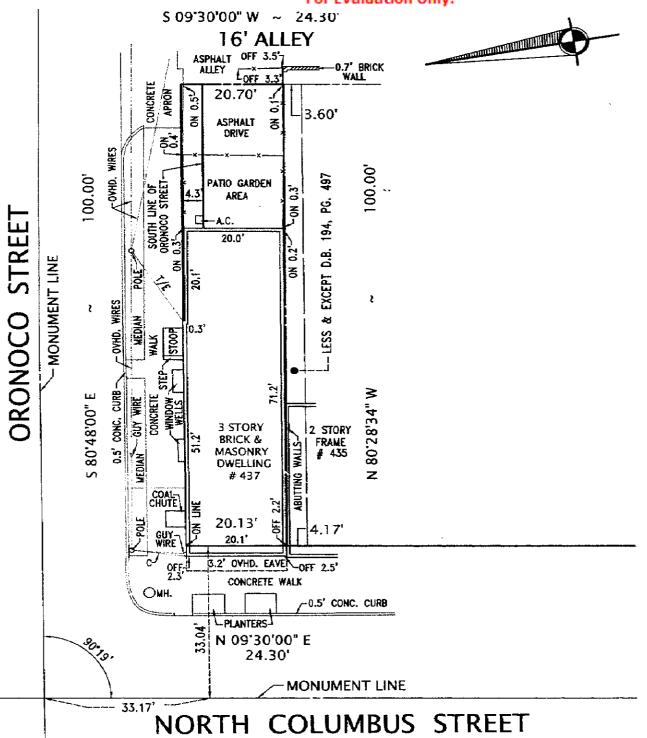

#### **PLAT**

SHOWING HOUSE LOCATION ON THE PROPERTY LOCATED AT

#### COLUMBUS STREET **NORTH** # 437


CITY OF ALEXANDRIA, VIRGINIA SCALE: 1" = 20' MAY 14, 2003

GRAPHIE SEALE



**EXISTING WEST ELEVATION** 

#### **EXISTING SOUTH ELEVATION**

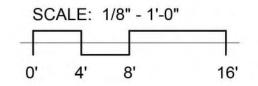




718 ORONOCO STREET 437 N COLUMBUS STREET, ALEXANDRIA, VA 22314 OPX PROJECT NO. 3587 EXISTING EXTERIOR ELEVATIONS 08/06/2020



PROPOSED WEST ELEVATION

#### PROPOSED SOUTH ELEVATION

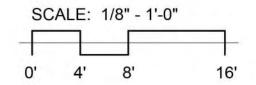



718 ORONOCO STREET 437 N COLUMBUS STREET, ALEXANDRIA, VA 22314 OPX PROJECT NO. 3587 PROPOSED EXTERIOR ELEVATIONS 08/06/2020





## STRUCTURAL NOTES

CONSTRUCTION SHALL COMPLY WITH, AND DESIGN HAS BEEN PERFORMED IN ACCORDANCE WITH, THE NOTES BELOW. IF THERE ARE ANY PERCEIVED CONFLICTS BETWEEN THE NOTES OR THE DRAWINGS, THE CONTRACTOR SHALL SUBMIT A WRITTEN REQUEST FOR CLARIFICATION TO THE STRUCTURAL ENGINEER.

#### A. CODES, STANDARDS, AND REFERENCES

- BUILDING CODE: VIRGINIA UNIFORM STATEWIDE BUILDING CODE (USBC)-2015; INTERNATIONAL BUILDING CODE (IBC)-2015; INTERNATIONAL RESIDENTIAL BUILDING CODE (IRC)-2009; ASCE 7-10.
- 2. STEEL CODES: SPECIFICATION FOR STRUCTURAL STEEL BUILDINGS (ANSI/AISC 360-10). STRUCTURAL WELDING CODE - STEEL (AWS D1.1-2010).
- MASONRY CODE: BUILDING CODE REQUIREMENTS AND SPECIFICATIONS FOR MASONRY STRUCTURES (ACI 530/530.1-13).
- 4. TIMBER CODES: NATIONAL DESIGN SPECIFICATION FOR WOOD CONSTRUCTION (ANSI/AWC NDS-2015).

#### B. OCCUPANCY

1. RISK CATEGORY: II

#### C. LIVE LOADS

- BALCONY: 60 PSF.
- 2. BALCONY ROOF: 20 PSF

#### D. SNOW LOADS

- GROUND SNOW LOAD (Pa): 25 PSF.
- 2. FLAT ROOF SNOW LOAD (P<sub>f</sub>): 20 PSF
- SLOPED ROOF SNOW LOAD (Ps): 20 PSF.
- 4. SNOW IMPORTANCE FACTOR (I<sub>S</sub>): 1.0.
- 5. SNOW EXPOSURE FACTOR (C<sub>e</sub>): 0.9. 6. SNOW LOAD THERMAL FACTOR ( $C_T$ ): 1.2.

## E. WIND LOADS

- BASIC WIND SPEED:
- a. ULTIMATE DESIGN WIND SPEED, Vult, (3-SECOND GUST): 115 MPH.
- b. NOMINAL DESIGN WIND SPEED, Vasd: 90 MPH.
- WIND EXPOSURE CATEGORY: B

#### F. SEISMIC CRITERIA

- 1. SITE CLASS IS: D (ASSUMED)
- 2. SEISMIC IMPORTANCE FACTOR ( $I_F$ ): 1.0.
- MAPPED SPECTRAL RESPONSE ACCELERATION AT SHORT PERIODS (S<sub>S</sub>): 0.118.
- MAPPED SPECTRAL RESPONSE ACCELERATION AT 1-SECOND PERIOD (S₁): 0.051
- DESIGN SPECTRAL ACCELERATION PARAMETER AT SHORT PERIODS (Sps): 0.126.
- DESIGN SPECTRAL ACCELERATION PARAMETER AT 1-SECOND PERIOD (S<sub>D1</sub>): 0.082. 7. SEISMIC DESIGN CATEGORY: B.
- BASIC SEISMIC FORCE RESISTING SYSTEM IS ORDINARY STEEL MOMENT FRAMES.
- 9. SYSTEM OVERSTRENGTH FACTOR ( $\Omega_0$ ): 3.
- 10. DEFLECTION AMPLIFICATION FACTOR (C<sub>d</sub>): 3.
- 11. RESPONSE MODIFICATION COEFFICIENT (R): 3.5.
- 12. ANALYSIS PROCEDURE: EQUIVALENT LATERAL FORCE PROCEDURE.
- 13. DESIGN BASE SHEAR: 0.5 KIPS.

## G. MATERIALS AND PHYSICAL PROPERTIES

- 1. "( )" INDICATES ASTM STANDARD FOR WHICH MATERIAL SHALL CONFORM. NON-SHRINK GROUT (C1107)... . f'c=3,000 psi
- STRUCTURAL STEEL a. W-SHAPES (A992). Fy=50,000 psi b. CHANNELS, ANGLES, & PLATES (A36). .Fy=36,000 psi
- 4. WELDING ELECTRODES: PER TABLE 3.1 OF AWS D1.1 FOR THE SMAW PROCESS OR ANY OTHER PREQUALIFIED WELDING PROCEDURES SPECIFICATIONS (WPS).
- STEEL BOLTS AND THREADED RODS a. HIGH STRENGTH BOLTS (F3125, GRADE A325, TYPE 1).... ...Fu=120,000 psi b. THREADED STEEL RODS (A572, GRADE 50)...
- .. Fy=50,000 psi, Fu=65,000 psi c. ANCHOR RODS (F1554, GRADE 55, S1). ..Fy=55,000 psi, Fu=75,000 psi d. ALL STEEL BOLTS AND THREADED RODS, AS NOTED, SHALL BE HOT-DIP
- GALVANIZED PER ASTM A153. 6. WOOD FRAMING (SOUTHERN PINE, NO. 2). . Fb=750 psi
- E=1,300,000 psi
- 7. WOOD SHEATHING 1/2" THICK, TONGUE & GROOVE EDGES. **EXTERIOR GRADE, SPAN RATING 16"**

#### H. ANCHORS

- PROPOSED ANCHORS SHALL BE SUBMITTED TO THE STRUCTURAL ENGINEER FOR REVIEW AND APPROVAL PRIOR TO FIELD OPERATIONS.
- 2. ALL ANCHORS SHALL BE INSTALLED IN ACCORDANCE WITH THE
- RECOMMENDATIONS OF THE MANUFACTURER MASONRY ADHESIVE ANCHORS:

b. SHALL USE INJECTABLE ADHESIVE:

- a. SHALL BE HILTI HIT-HY 270 MANUFACTURED BY HILTI FASTENING SYSTEMS OR AN APPROVED EQUIVALENT WITH ACCOMPANYING ICC EVALUATION REPORT:
- c. RODS SHALL BE MANUFACTURED WITH CHAMFERED ENDS (EACH END) AND
- MEET ONE OF THE FOLLOWING STANDARDS:
- i. ASTM A3:
- ii. ISO 898 CLASS 5.8;
- 4. IF MINIMUM REQUIREMENTS (EMBEDMENT, SPACING, AND EDGE DISTANCE) FOR ANCHORS CANNOT BE ACHIEVED DUE TO FIELD CONDITIONS, NOTIFY THE STRUCTURAL ENGINEER FOR GUIDANCE PRIOR TO DRILLING HOLES FOR ANCHORS.
- HOLES FOR ANCHORS TO BE INSTALLED IN MASONRY SHALL BE DRILLED WITH A ROTARY DRILL ONLY, NOT A ROTARY-HAMMER DRILL
- 6. A FIELD TECHNICIAN EMPLOYED BY THE ANCHOR MANUFACTURER SHALL BE ON SITE DURING ALL DRILLING AND INSTALLATION PROCESSES FOR EACH TYPE OF
- 7. CURING TIME FOR ADHESIVE AND EPOXY ADHESIVE ANCHOR SYSTEM SHALL BE A MINIMUM OF 48 HOURS OR AS RECOMMENDED BY THE ANCHOR MANUFACTURER WHICHEVER IS MORE STRINGENT.
- PROVIDE SPECIAL INSPECTION FOR ALL MECHANICAL AND ADHESIVE ANCHORS PER THE APPLICABLE BUILDING CODE AND PER THE CURRENT ICC-ES REPORT (IBC 2012 TABLE 1705.3 NOTE B)

#### STRUCTURAL STEEL

- SEE STRUCTURAL NOTES SECTION "MATERIALS AND PHYSICAL PROPERTIES" FOR THE STRENGTHS OF STRUCTURAL STEEL, BOLTS, THREADED RODS, ANCHOR RODS. AND WELDS.
- BEAMS MARKED ON THE DRAWINGS WITH "▶" SYMBOL SHALL HAVE MOMENT CONNECTIONS. SEE CONNECTION DETAILS ON SHEETS S-502 AND S-503
- 3. UNLESS NOTED OTHERWISE, HIGH STRENGTH BOLTS SHALL BE TIGHTENED TO A SNUG TIGHT CONDITION AS DEFINED BY THE RCSC "SPECIFICATION FOR STRUCTURAL JOINTS USING HIGH-STRENGTH BOLTS" (2009 EDITION).
- 4. WELDS SHALL BE INSTALLED BY WELDERS QUALIFIED IN ACCORDANCE WITH AWS PROCEDURES FOR WELDER QUALIFICATION.
- 5. UNLESS NOTED OTHERWISE, ALL STRUCTURAL STEEL MEMBERS SHALL HAVE APPLIED ONE SHOP COAT OF A TWO-COMPONENT EPOXY ANTI-CORROSIVE PRIMER PIGMENTED WITH ZINC, TWO MILS DRY FILM THICKNESS, AND ONE COAT OF A TWO-COMPONENT ACRYLIC POLYURETHANE FINISH COAT, TWO MILS DRY FILM THICKNESS.
- 6. WELDING INSPECTION SHALL BE MADE IN ACCORDANCE WITH THE INSPECTION CHAPTER OF AWS D1.1 (2010).

- SEE STRUCTURAL NOTES SECTION "MATERIALS AND PHYSICAL PROPERTIES" FOR STRENGTH AND PROPERTIES OF TIMBER.
- 2. PROVIDE SIMPSON FACE MOUNT HANGERS SPECIFIED IN DRAWING DETAILS, OR APPROVED EQUIVALENT, AT EACH FLOOR OR ROOF JOIST FRAMING INTO WOOD BLOCKING IN STEEL MEMBER WEB.
- MINIMUM HANGER CAPACITIES FOR EACH JOIST EACH SIZE ARE: a. 2x8: 500 LB (DOWNWARD); 350 LB (UPLIFT).
- b. 2x10: 700 LB (DOWNWARD); 350 LB (UPLIFT).

## L. FINISHES

- CONTRACTOR TO PROVIDE MEMBRANE FINISH AT SECOND AND THIRD FLOORS.
- CONTRACTOR TO PROVIDE ROLLED ROOFING FINISH TO MATCH EXISTING.
- CONTRACTOR TO PROVIDE CLADDING AROUND COLUMNS. PERIMETER BEAMS. AND PERIMETER JOISTS AT THE SECOND FLOOR. THIRD FLOOR. AND ROOF LEVELS PER DETAILS ON SHEETS A-501 AND A-502.
- CONTRACTOR TOP PROVIDE FLASHING AND WATERPROOFING AT CLADDING JOINTS AND TRANSITIONS BETWEEN CLADDING AND EXISTING MASONRY PER DETAILS ON SHEETS A-501 AND A-502.

## M. GENERAL CONTRACTOR

- SHOP DRAWINGS FOR ALL STRUCTURAL ITEMS ARE PART OF THE STRUCTURAL DESIGN AND SHALL BE SUBMITTED TO THE STRUCTURAL ENGINEER FOR REVIEW AND APPROVAL PRIOR TO FABRICATION AND CONSTRUCTION.
- 2. ALL STRUCTURAL ELEMENTS SHALL BE TEMPORARILY SHORED AND BRACED AS REQUIRED TO RESIST THE LOADS TO WHICH THEY MAY BE SUBJECT DURING CONSTRUCTION.
- 3. ALL TEMPORARY SHORING AND BRACING SHALL BE DESIGNED BY A REGISTERED PROFESSIONAL ENGINEER RETAINED BY THE CONTRACTOR AND SHALL REMAIN IN-PLACE UNTIL THE STRUCTURE IS CAPABLE OF SUPPORTING THE LOADS TO WHICH IT MAY BE SUBJECT. DETERMINATION OF WHEN TEMPORARY SHORING AND
- BRACING CAN BE REMOVED IS THE RESPONSIBILITY OF THE SHORING ENGINEER. IMPOSED CONSTRUCTION LOADS, IN EXCESS OF THE STATED DESIGN LOADS MUST BE APPROVED BY THE STRUCTURAL ENGINEER PRIOR TO THE IMPOSITION OF SUCH LOADS.

### N. EXISTING STRUCTURE

- INFORMATION SHOWN ON THE STRUCTURAL DRAWINGS REGARDING THE EXISTING STRUCTURE HAS BEEN OBTAINED FROM FIELD OBSERVATIONS
- 2. DIMENSIONS OF EXISTING CONSTRUCTION SHOWN ON THE STRUCTURAL DRAWINGS ARE APPROXIMATE AND SHALL BE FIELD VERIFIED BY THE CONTRACTOR PRIOR TO BEGINNING CONSTRUCTION
- 3. IF DEVIATIONS ARE FOUND BETWEEN THE EXISTING INFORMATION SHOWN ON THE STRUCTURAL DRAWINGS AND ACTUAL CONDITIONS WHICH WILL NOT PERMIT NEW STRUCTURAL WORK TO BE PERFORMED AS SPECIFIED, THE STRUCTURAL ENGINEER SHALL BE NOTIFIED IN WRITING FOR GUIDANCE PRIOR TO THE START OF THE WORK IN QUESTION.
- 4. CONTRACTOR SHALL SUBMIT METHODS AND SEQUENCING FOR THE REMOVAL OF THE EXISTING STRUCTURE, AS WELL AS TYPES OF TOOLS AND EQUIPMENT TO BE USED, TO THE STRUCTURAL ENGINEER FOR REVIEW AND APPROVAL PRIOR TO COMMENCING ANY DEMOLITION OR ALTERATIONS. EXTREME CARE SHALL BE TAKEN TO PROTECT THE INTEGRITY OF ADJACENT EXISTING STRUCTURE AT ALL TIMES. THE CONTRACTOR SHALL BEAR THE COST OF REPAIRS OR REPLACEMENT FOR DAMAGE TO ANY PART OF EXISTING STRUCTURES OR ADJOINING PROPERTY.

**LEGEND** 

GRAVEL

FOAM

GROUT

STONE

**EARTH** 

CMU

SOLID CMU

**EXISTING** 

### LIST OF ABBREVIATIONS

- AND ΑT DIAMETER (E), EXIST **EXISTING** LOW #. NO. NUMBER **PERCENT** ABV ABOVE ADDL **ADDITIONAL** AF&PA AMERICAN FOREST & PAPER ASSOCIATION
- AMERICAN INSTITUTE OF STEEL CONSTRUCTION AMERICAN IRON AND STEEL
- INSTITUTE AMERICAN NATIONAL STANDARDS INSTITUTE
- APPROXIMATE AMERICAN SOCIETY OF CIVIL **ENGINEERS** AMERICAN SOCIETY FOR **TESTING AND MATERIALS**
- AMERICAN WOOD COUNCIL **AWS** AMERICAN WELDING SOCIETY BUILDING B.O. **BOTTOM OF** BEARING
- CLEAR CONCRETE MASONRY UNIT COL COLUMN CONT CONTINUOUS

CENTERLINE

- COORD COORDINATE DEMOLISH, DEMOLITION DIM(S) DIMENSION(S) DL DEAD LOAD DRAWING(S)
- **ELEVATION EMBED EMBEDMENT** EQ **EQUAL EXTERIOR** EXT
- FT FOOT OR FEET HORIZONTAL INTERNATIONAL BUILDING CODE
- INTERNATIONAL CODE COUNCIL I.D. INSIDE DIAMETER INTERIOR INTERNATIONAL
  - STANDARDIZATION ORGANIZATION JOINT
- KIP(S) KIPS PER SQUARE FOOT KSI KIPS PER SQUARE INCH LB, # POUNDS
- LIVE LOAD LL MAS **MASONRY** MAX MAXIMUM MTL
- METAL MFR MANUFACTURER MIN MINIMUM MISC **MISCELLANEOUS**
- MPH MILES PER HOUR NATIONAL DESIGN SPECIFICATION FOR WOOD CONSTRUCTION
- NIC NOT IN CONTRACT NOM NOMINAL NTS NOT TO SCALE O.C. ON CENTER OPP OPPOSITE
- PLPLATE PREFABRICATED POUNDS PER SQUARE FOOT POUNDS PER SQUARE INCH REQD REQUIRED
- S.F. **SQUARE FEET** SIM SIMILAR SPA SPACES (SPACING) SPECIFICATIONS STD STANDARD T&B TOP AND BOTTOM
- **TEMP TEMPORARY** T&G **TONGUE AND GROOVE THRU** THROUGH T.O. TOP OF
- TYP TYPICAL UNLESS NOTED OTHERWISE **VERT VERTICAL**
- WIND LOAD WITH W/O **WITHOUT**

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PRE-FINAL **REVIEW SET** NOT FOR CONSTRUCTION

718 ORONOCO ST. **BALCONY** REPLACEMENT

718 ORONOCO STREET ALEXANDRIA, VA 22314

Rev.	Date	Description	Approved

Sheet Title
STRUCTURAL NOTES


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S-001

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Sheet No.

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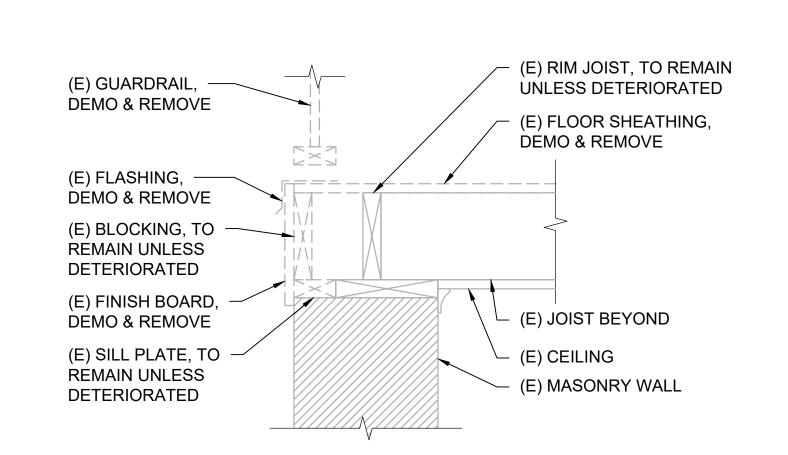
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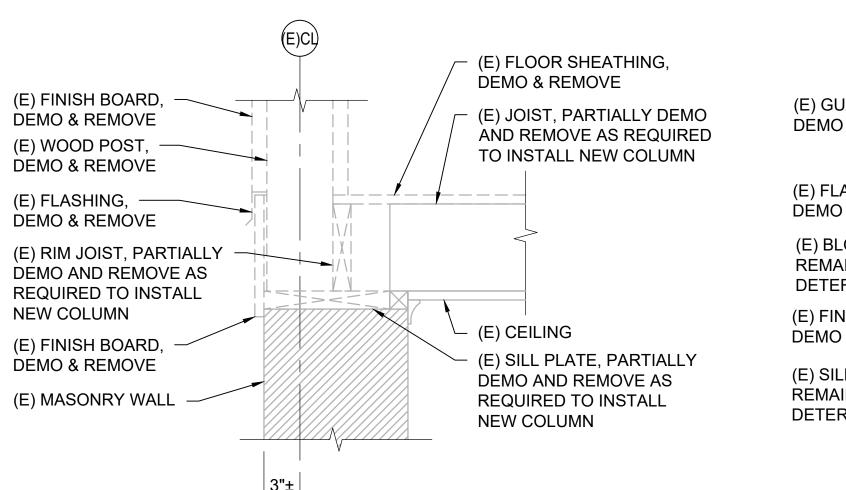
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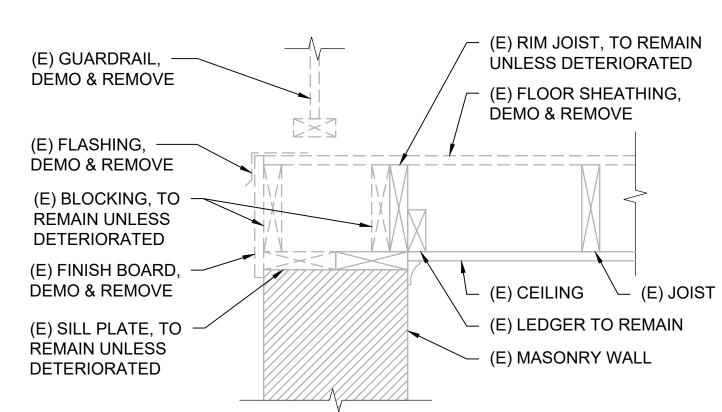
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SD101
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Sheet No.





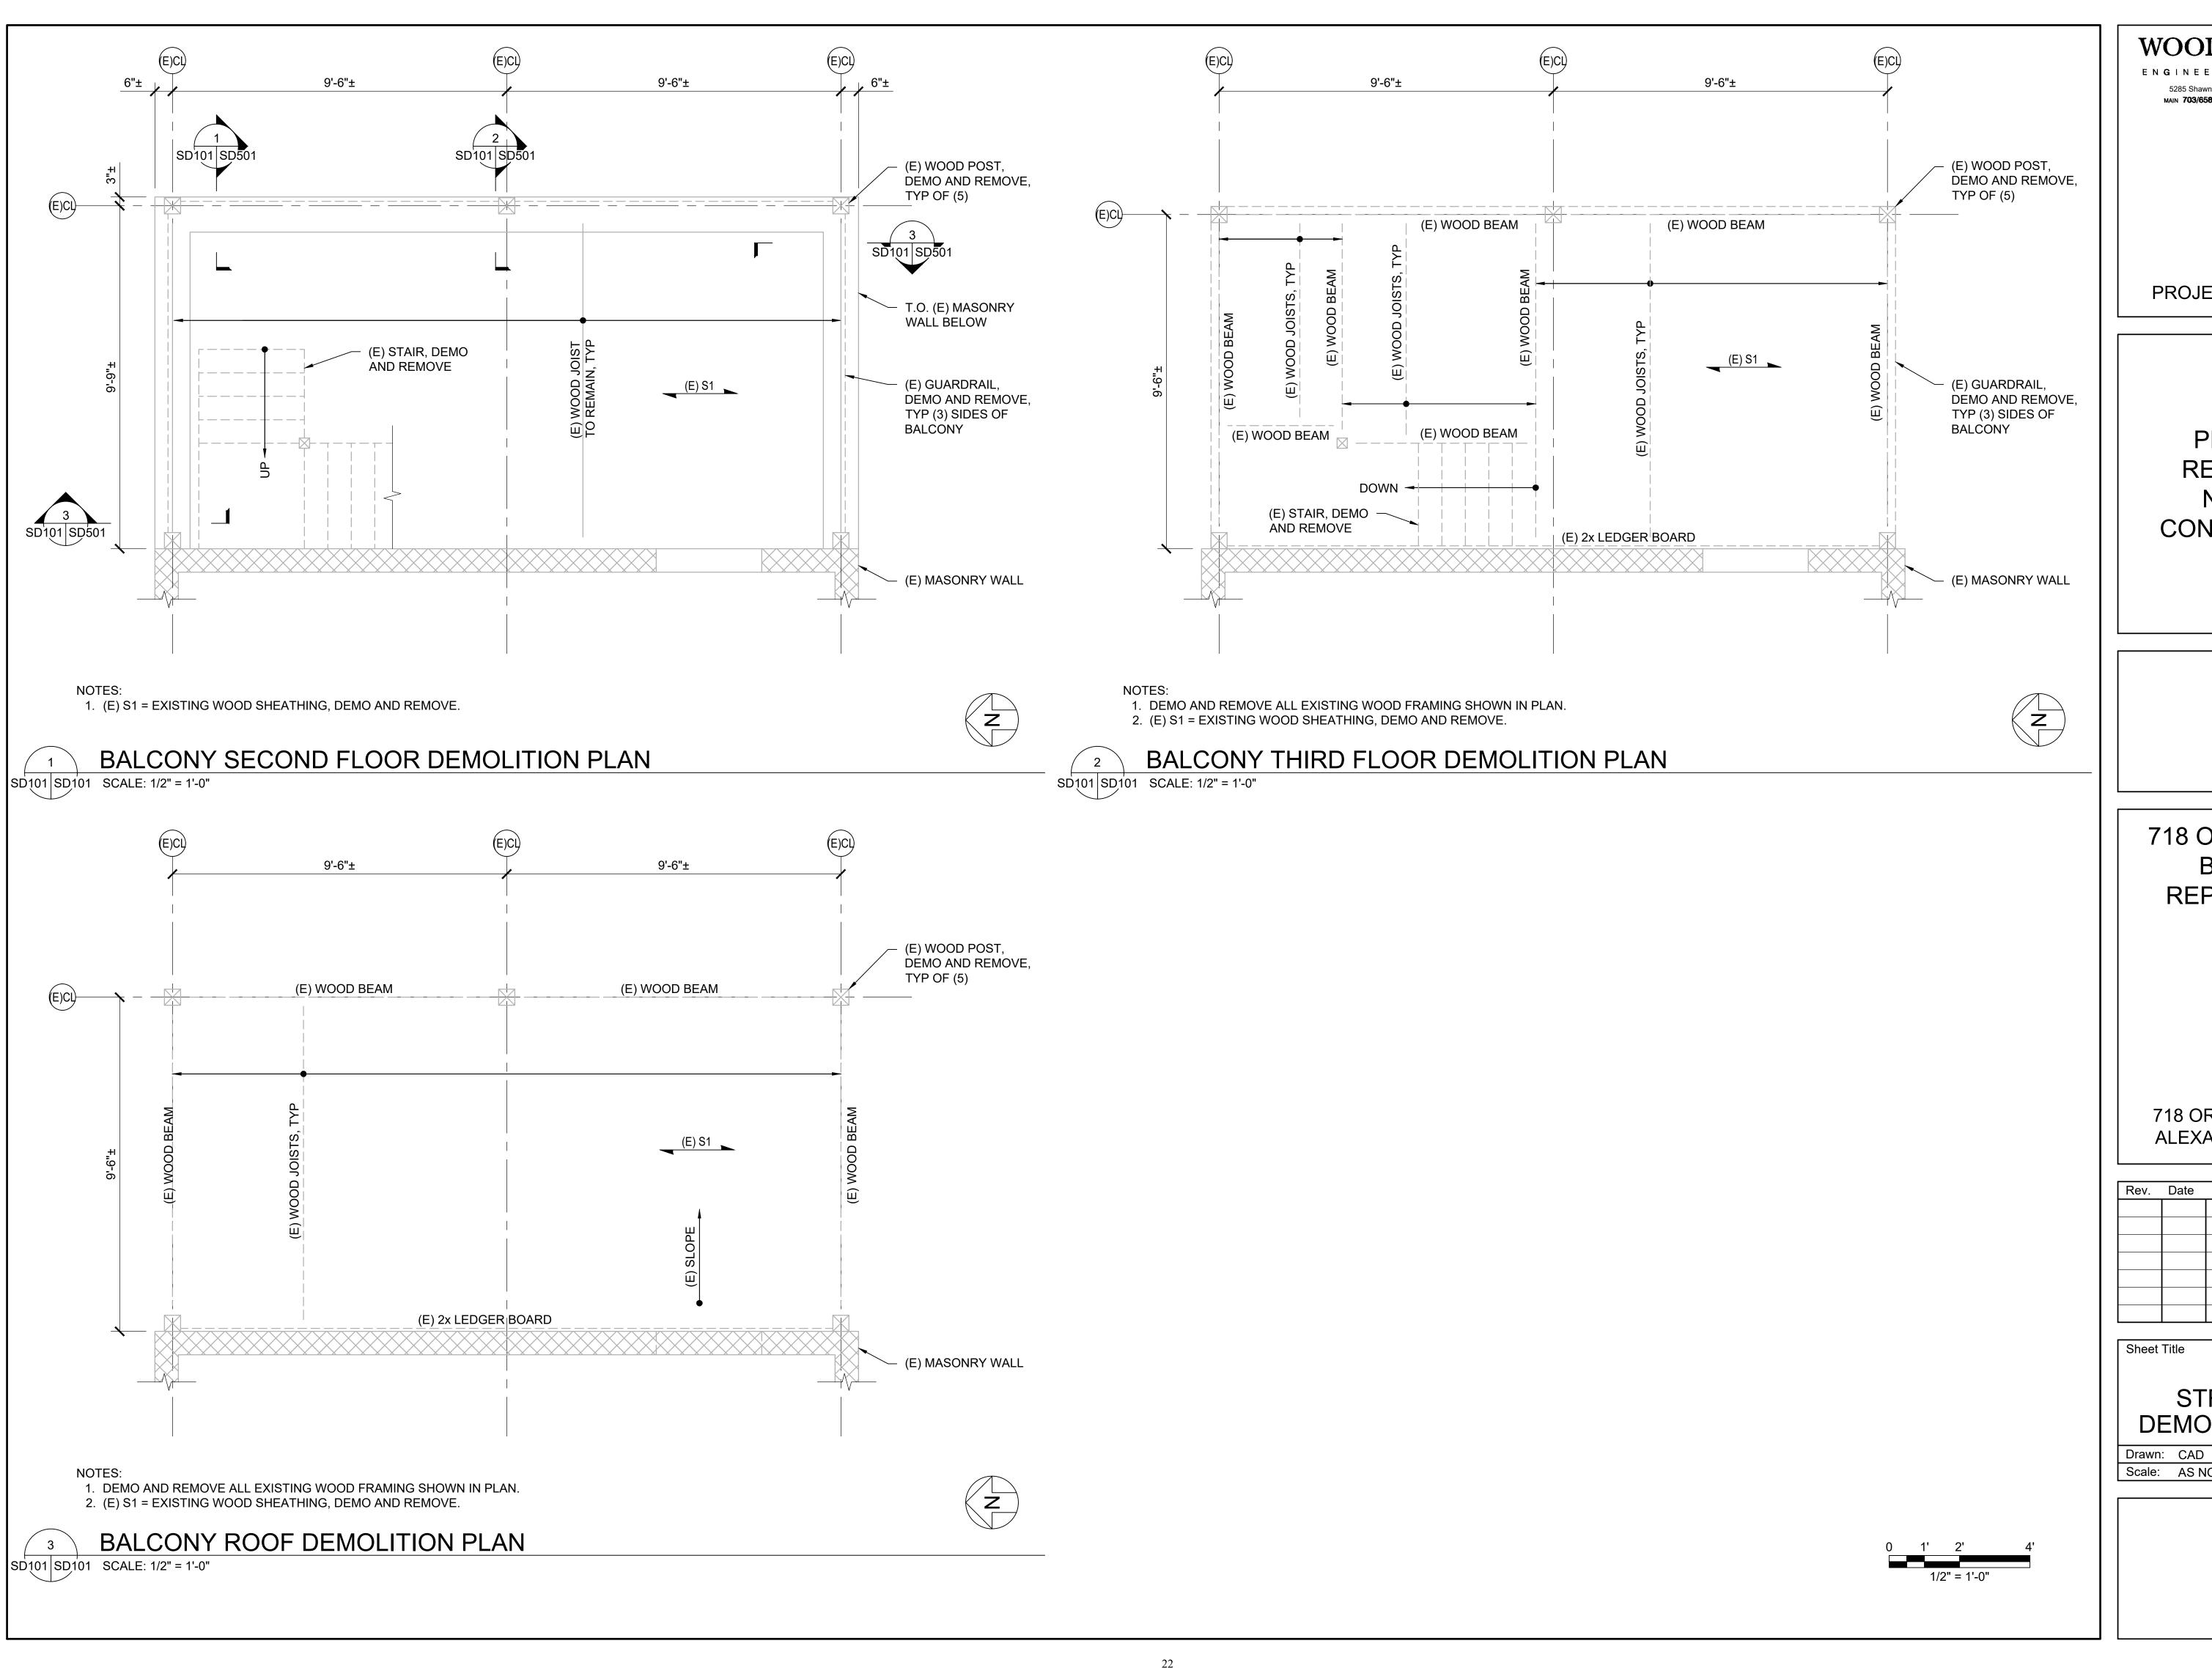

EAST WALL SECOND FLOOR DEMO DETAIL SD101 SD501 SCALE: 1-1/2" = 1'-0"

EAST WALL AT COLUMN SECOND FLOOR DEMO DETAIL

SD101 SD501 SCALE: 1-1/2" = 1'-0"

NORTH AND SOUTH WALLS SECOND FLOOR DEMO DETAIL

SD101 SD501 SCALE: 1-1/2" = 1'-0"

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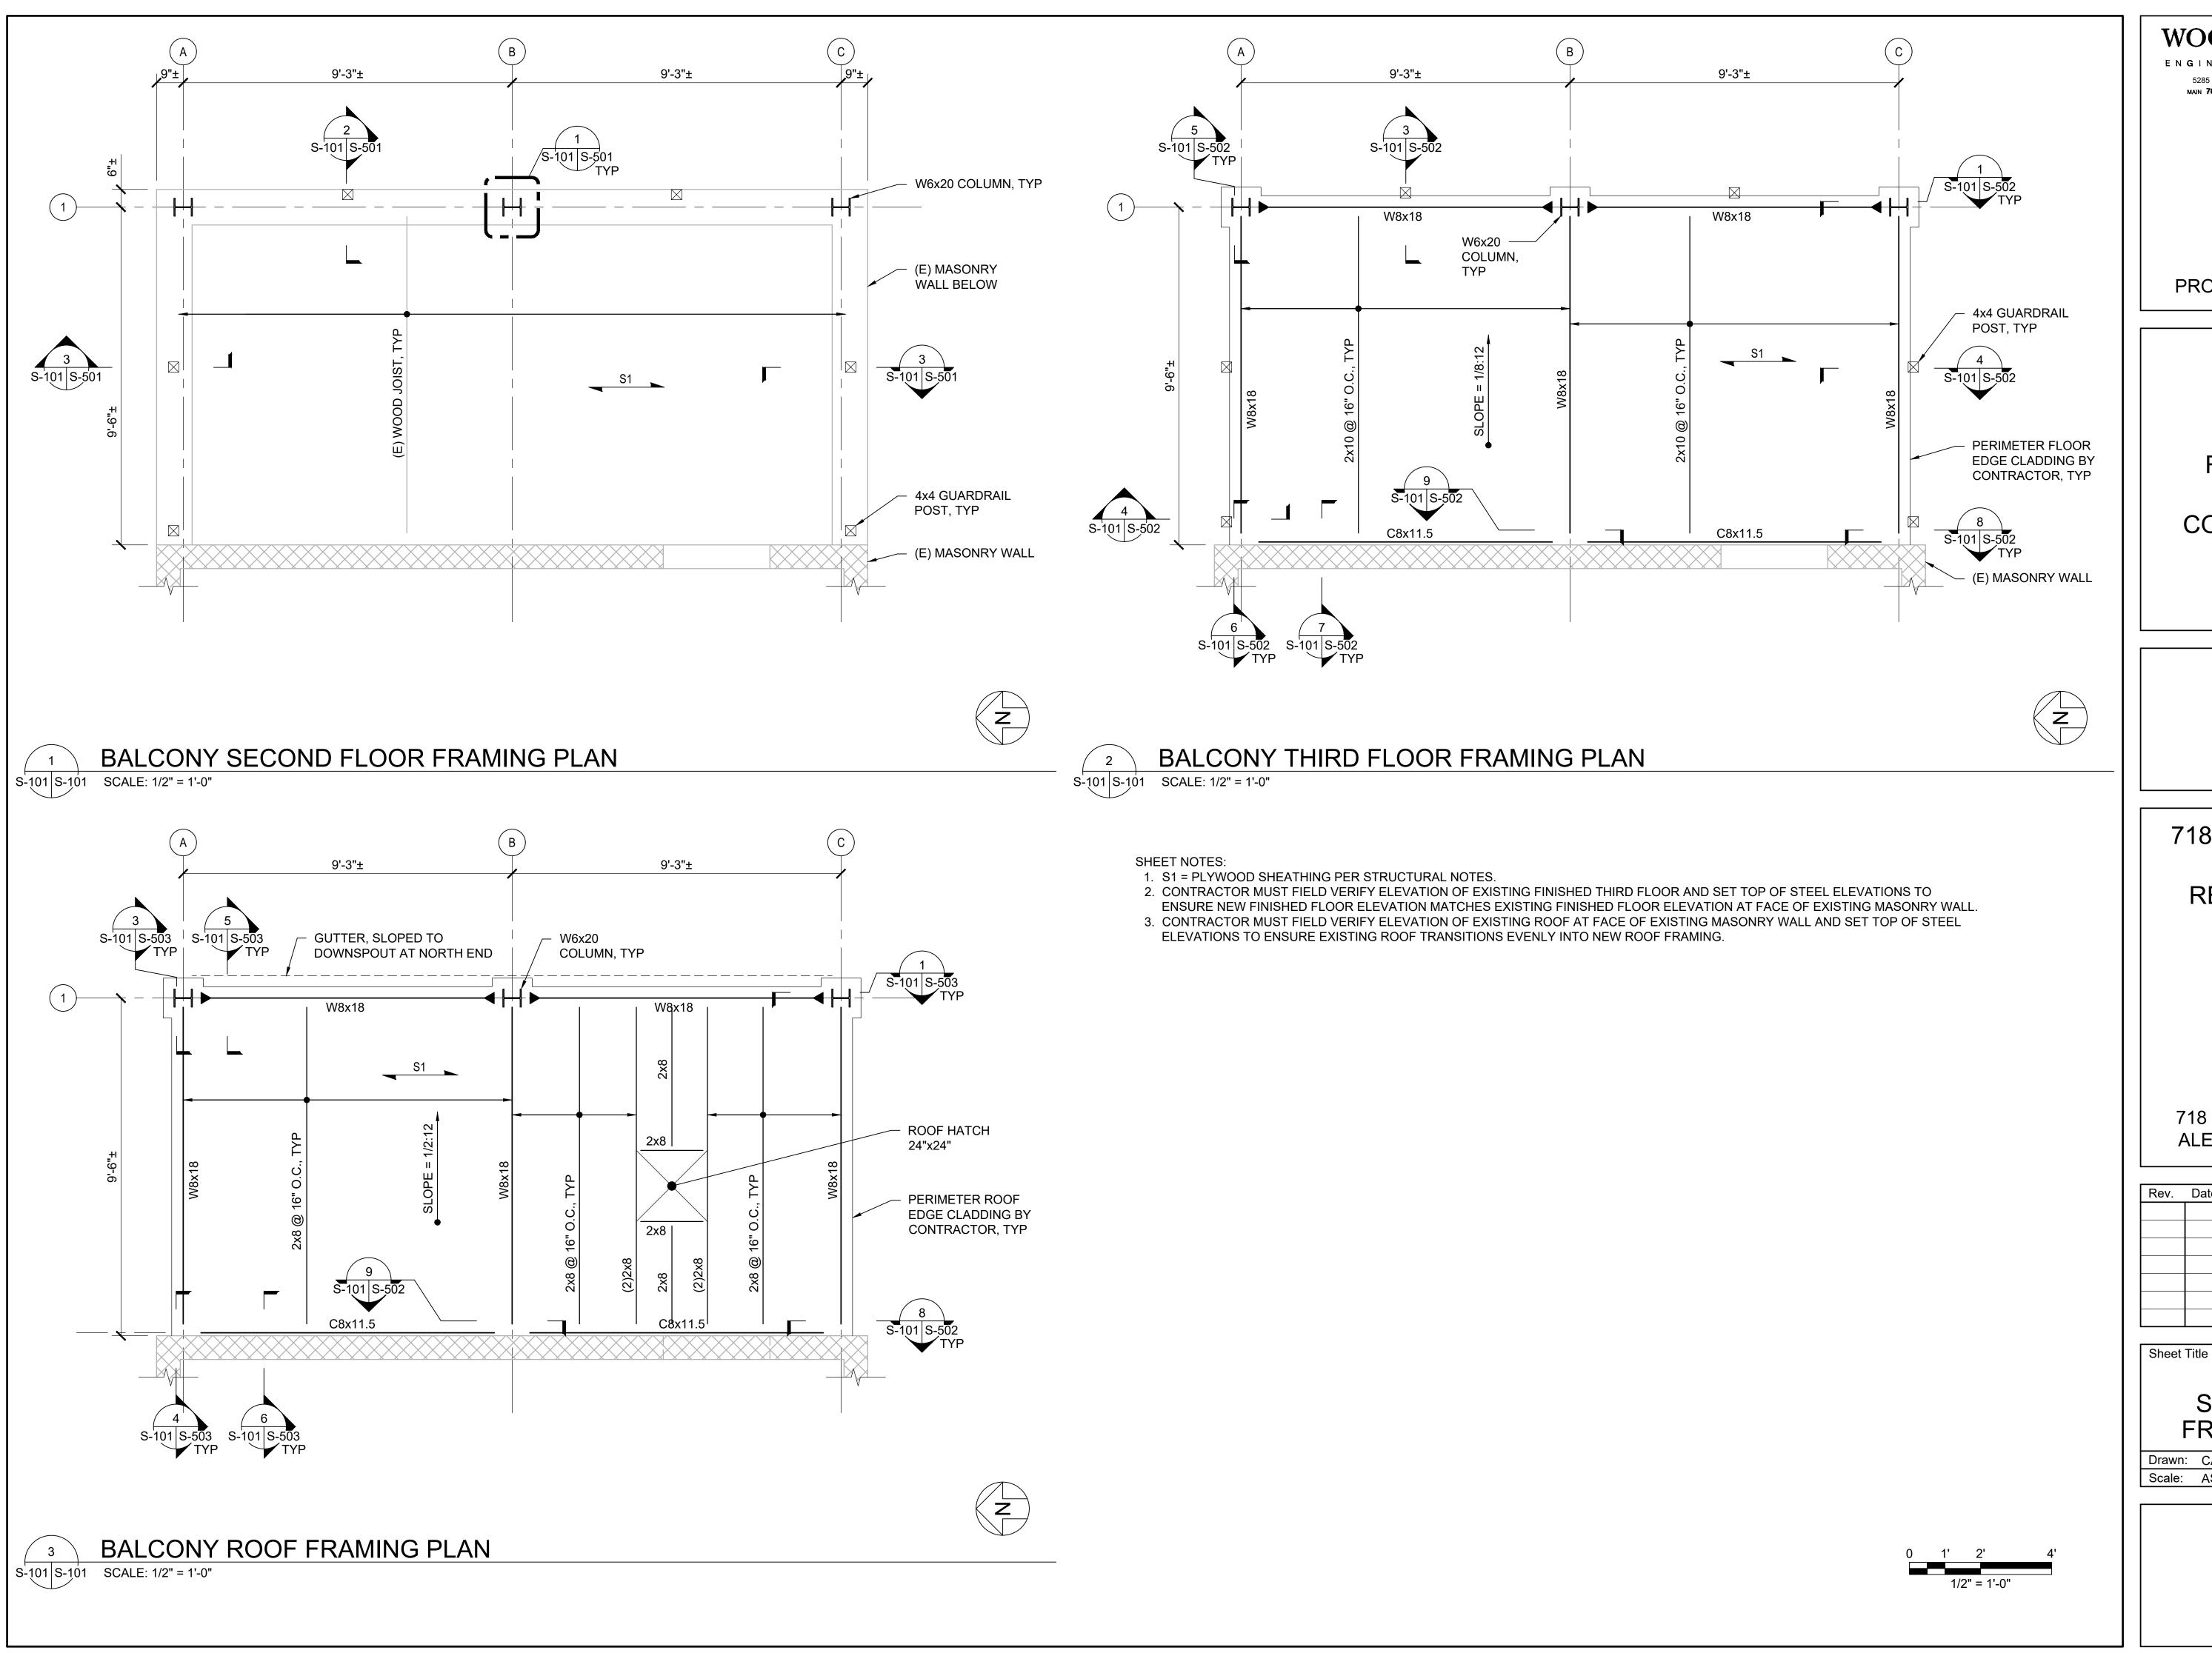
Sheet Title
STRUCTURAL
DEMOLITION
SECTIONS AND DETAILS

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0 1/2' 1' 1 1/2'
1-1/2" = 1'-0"



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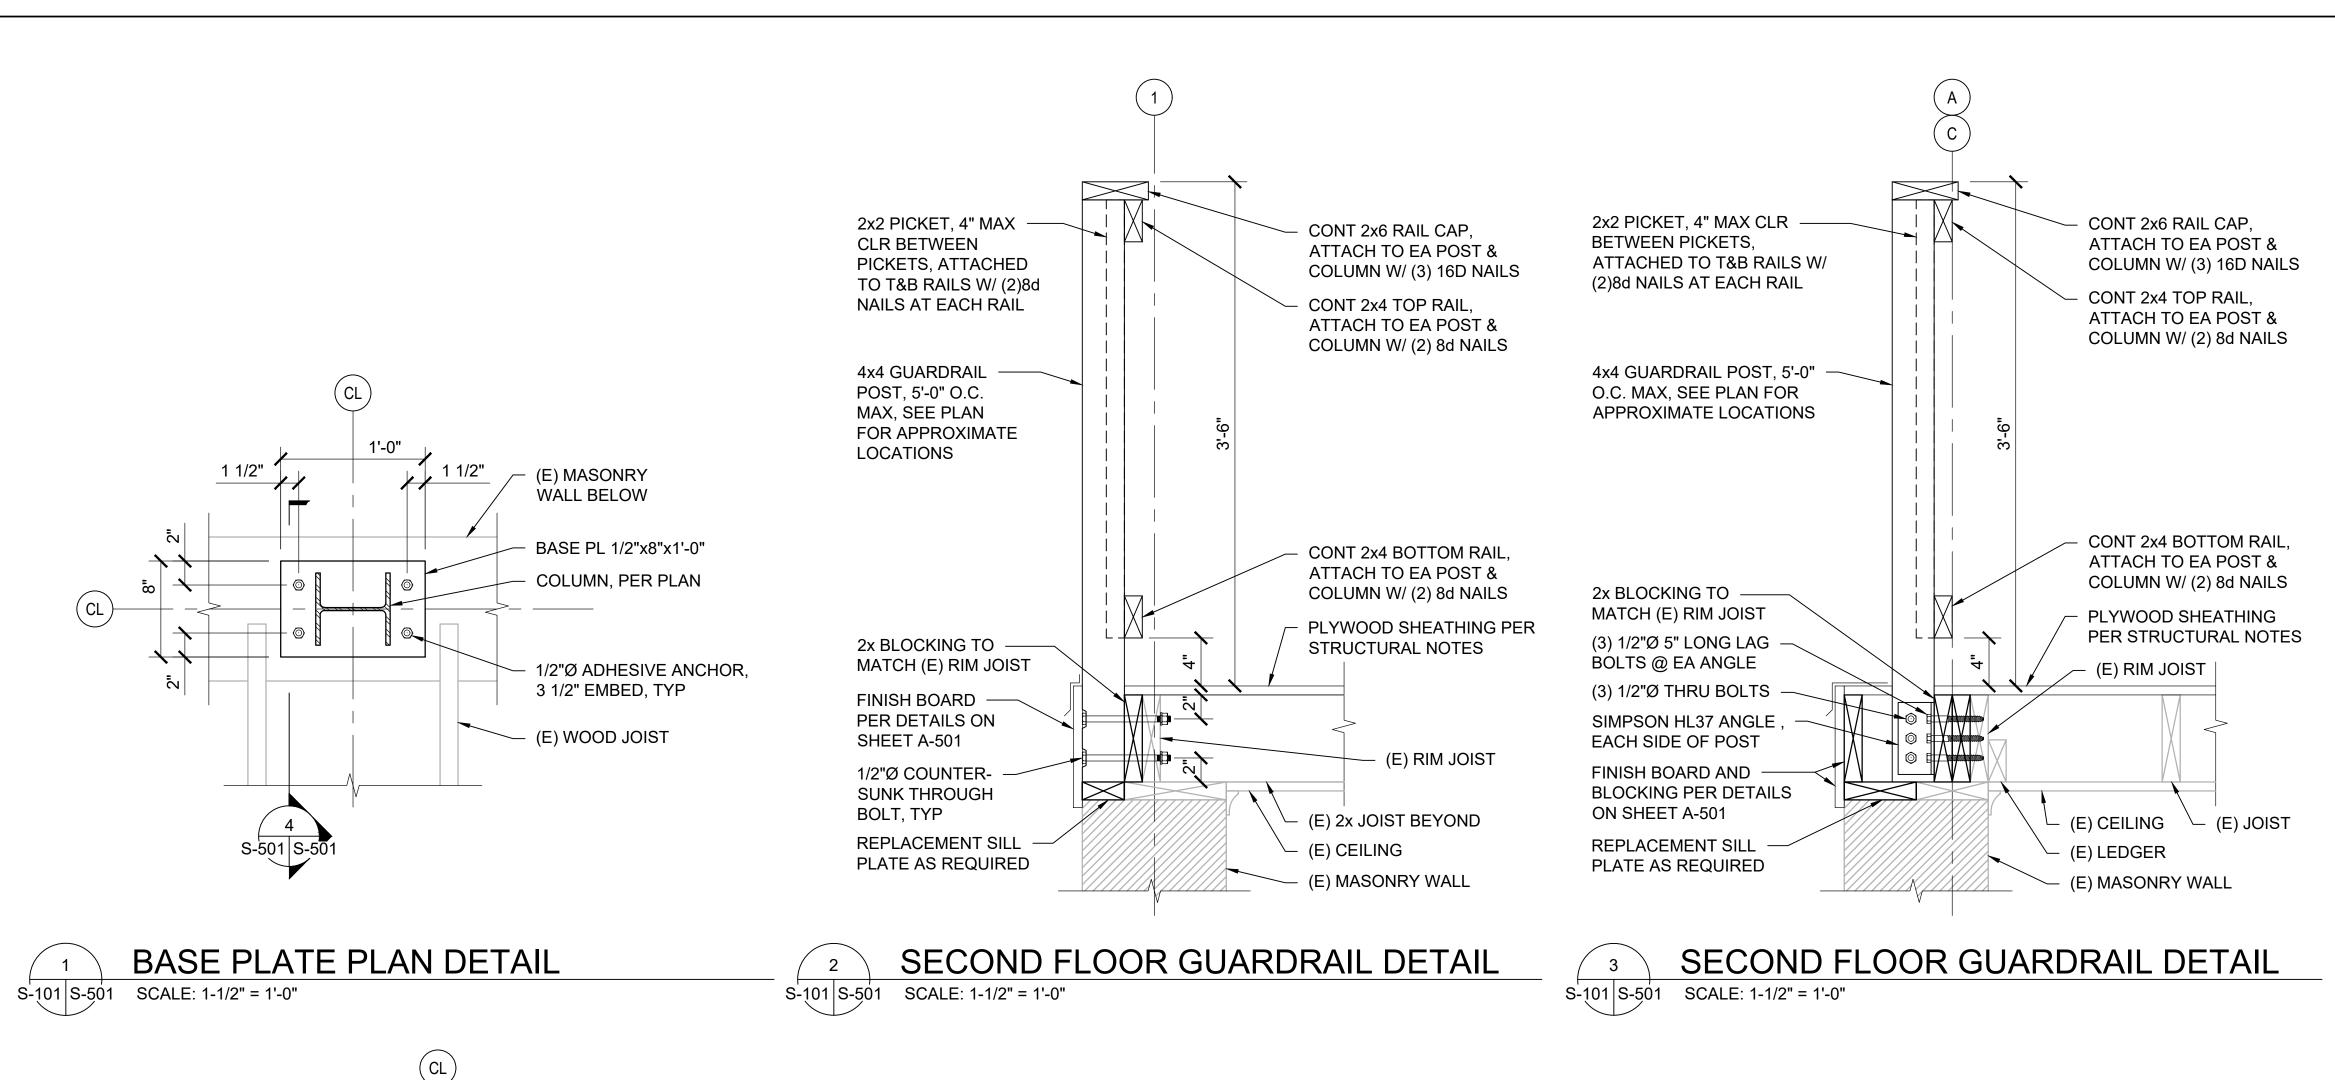
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STRUCTURAL FRAMING PLANS

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S-101

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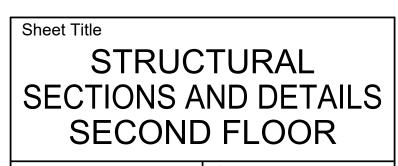
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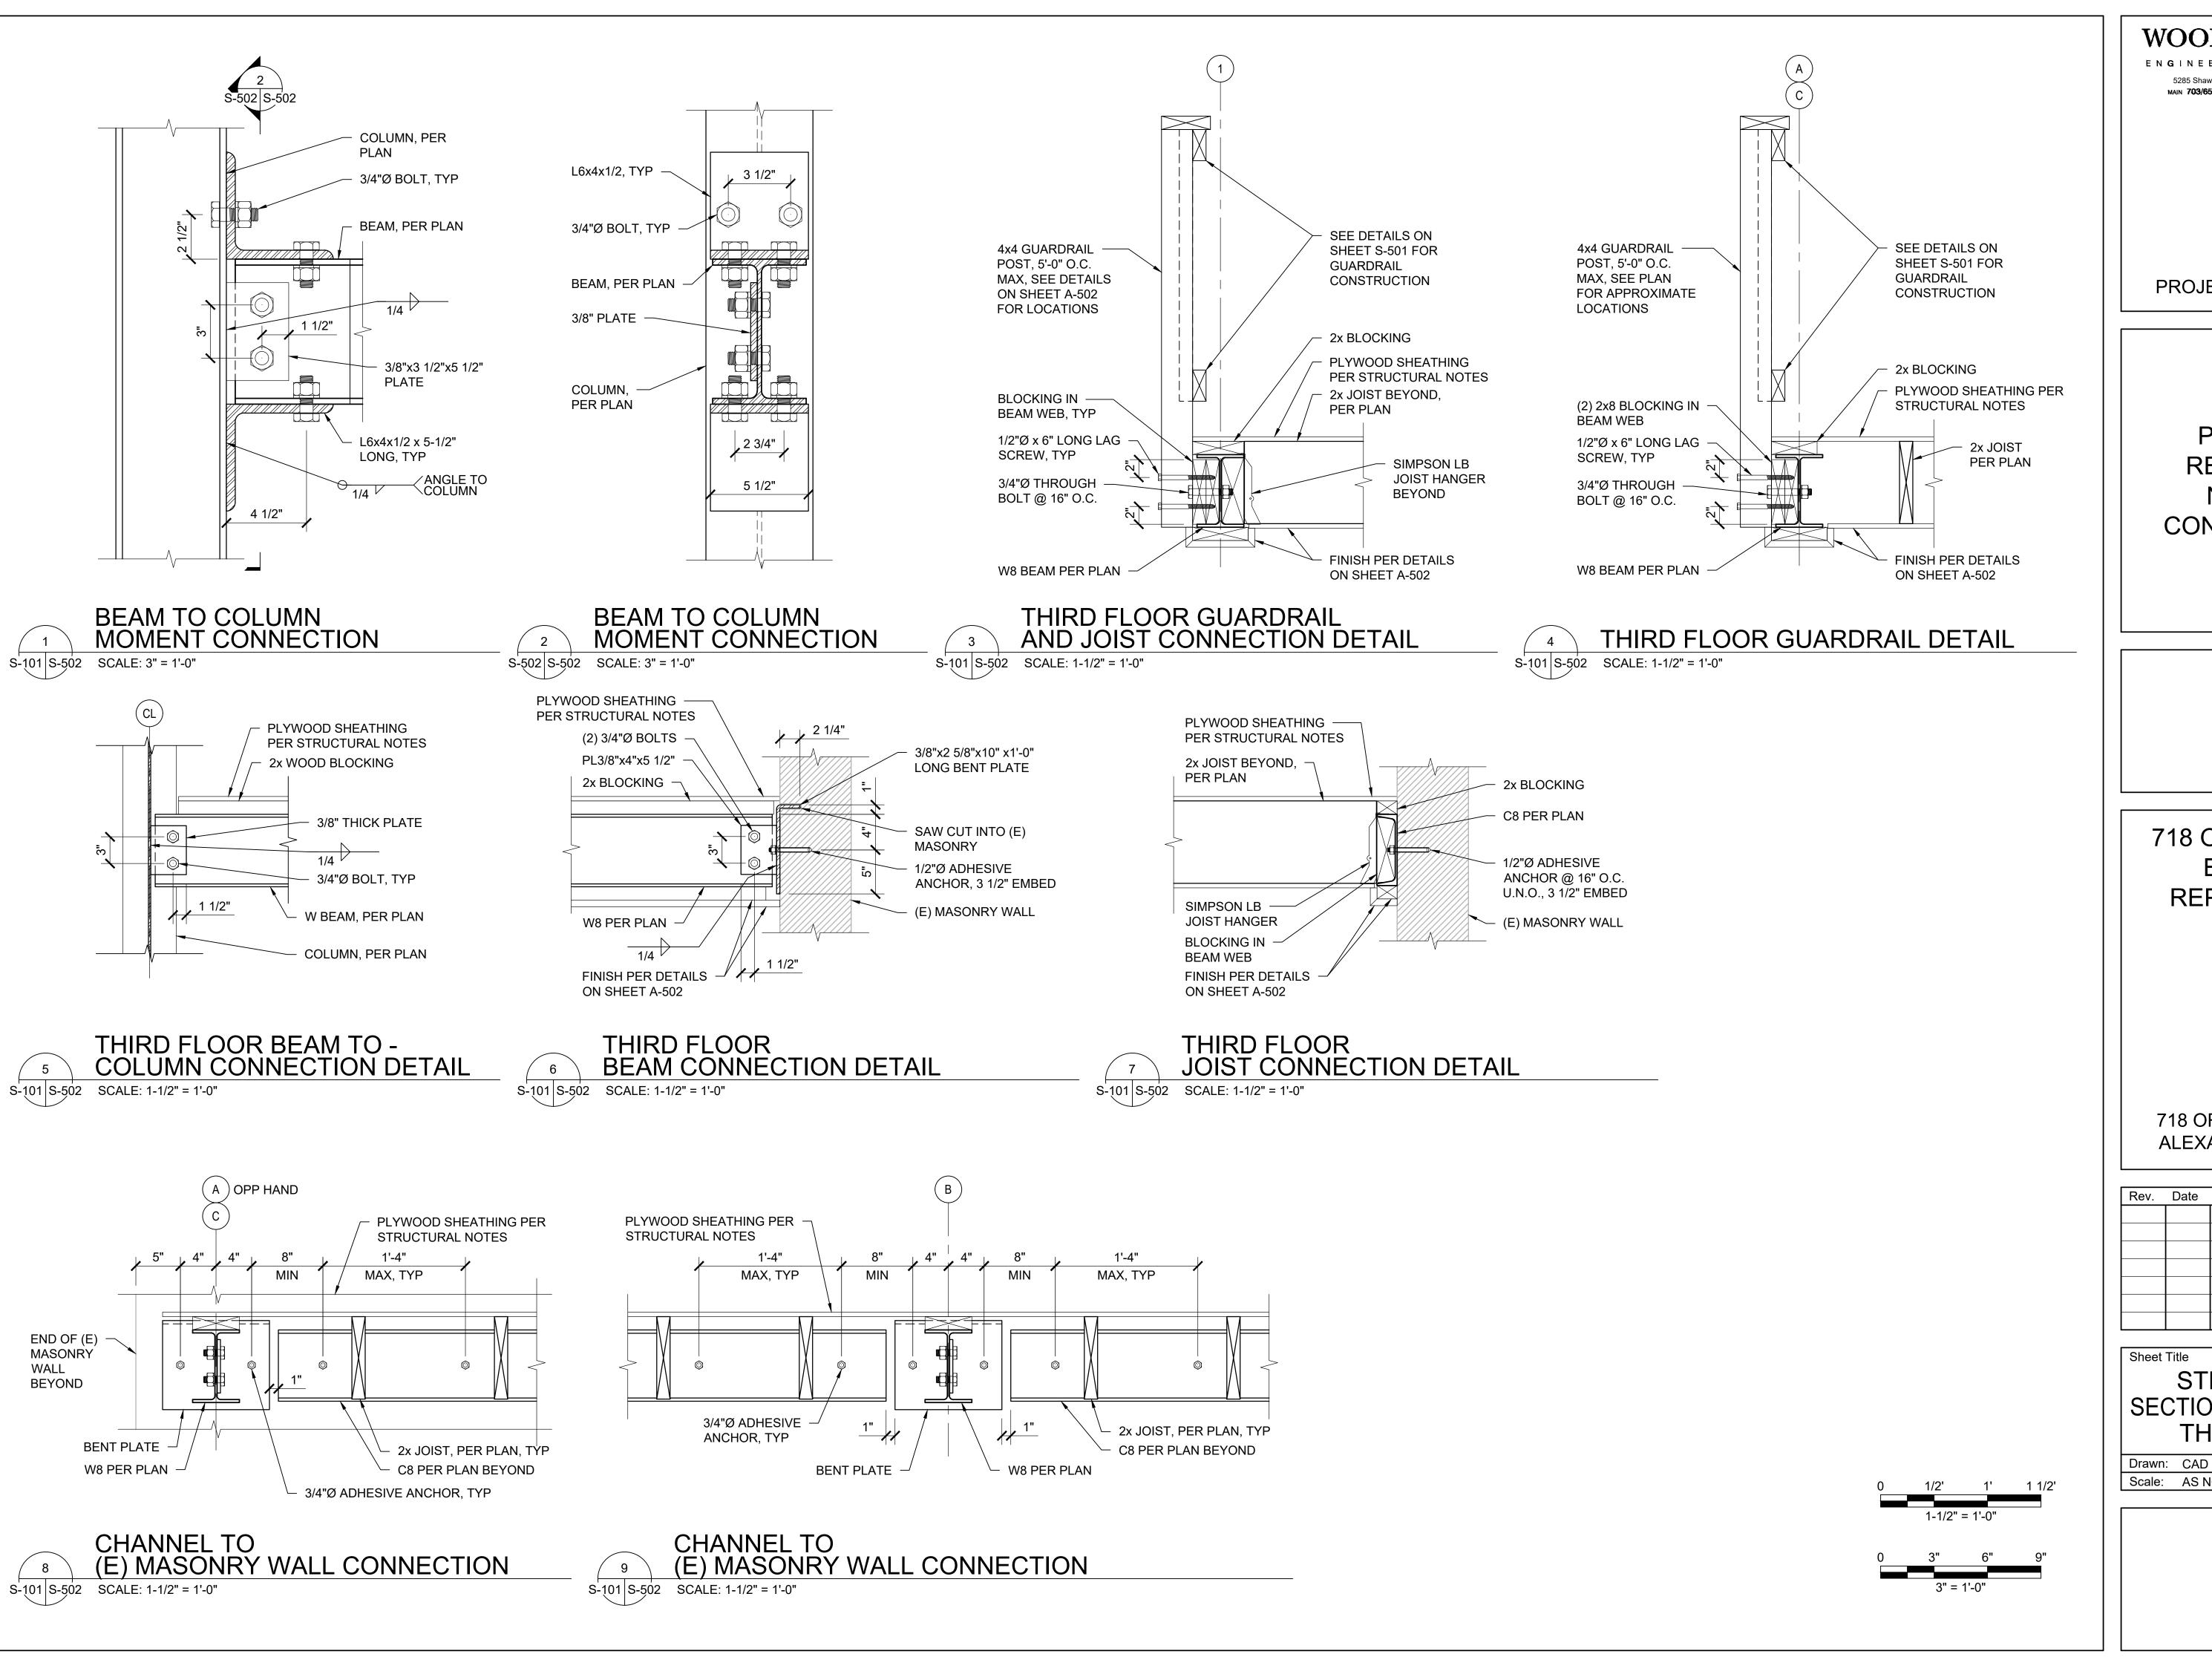
S-501

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- PLYWOOD SHEATHING BLOCKING AND FINISH **BOARD PER DETAILS** ON SHEET A-501, TYP 1/2" THICK BASE PLATE 1/2" NON-SHRINK **GROUT BED** (E) INTERIOR 1/2"Ø ADHESIVE ANCHOR, SOFFIT 3 1/2" EMBED, TYP PORTION OF (E) MASONRY WALL (E) SILL PLATE TÓ REMAIN 1'-0"±

BASE PLATE SECTION

S-501 S-501 SCALE: 3" = 1'-0"



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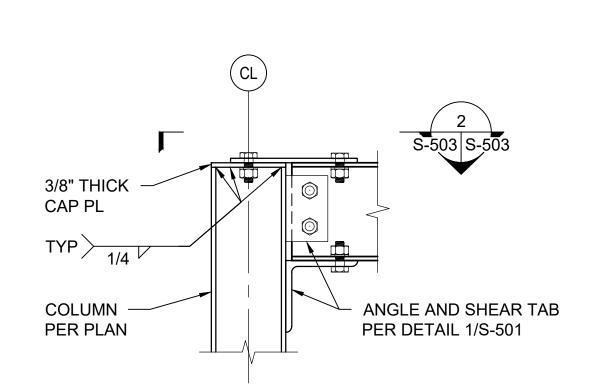
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STRUCTURAL
SECTIONS AND DETAILS
THIRD FLOOR


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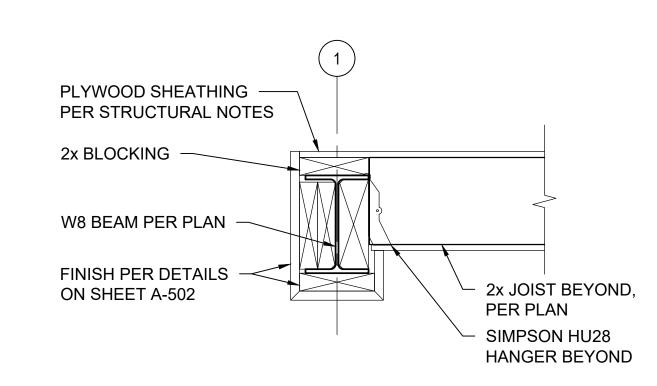
S-502
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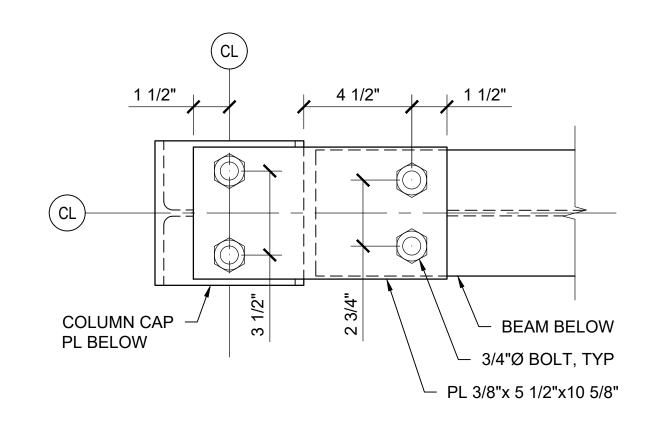





# ROOF BEAM TO - COLUMN CONNECTION DETAIL S-101 S-503 SCALE: 1-1/2" = 1'-0"




S-101 S-503 SCALE: 1-1/2" = 1'-0"

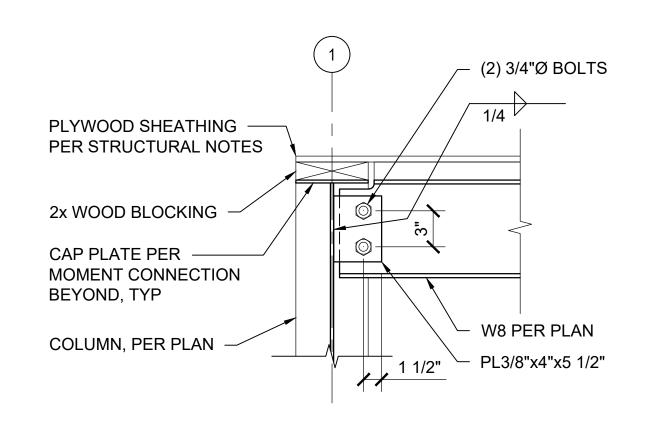

# ROOF LEVEL MOMENT CONNECTION S-503 S-503 SCALE: 3" = 1'-0"

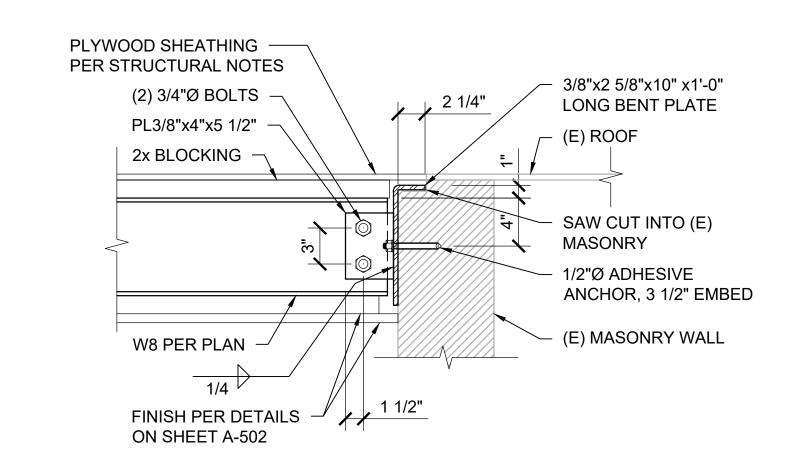

## ROOF BEAM CONNECTION DETAIL S-101 S-503 SCALE: 1-1/2" = 1'-0"

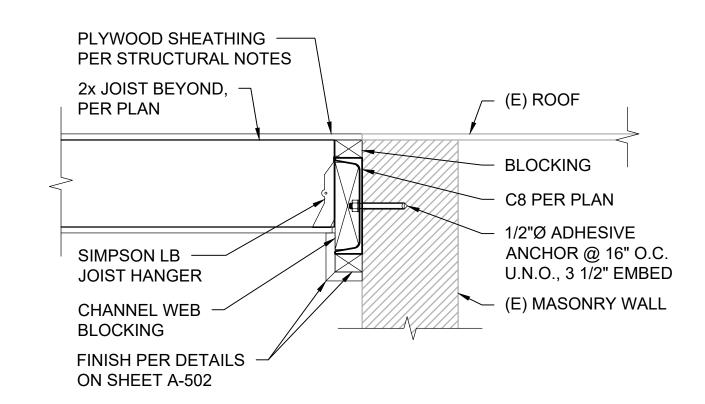

## 6 ROOF JOIST CONNECTION DETAIL S-101 S-503 SCALE: 1-1/2" = 1'-0"

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Sheet Title
STRUCTURAL
SECTIONS AND DETAILS
ROOF


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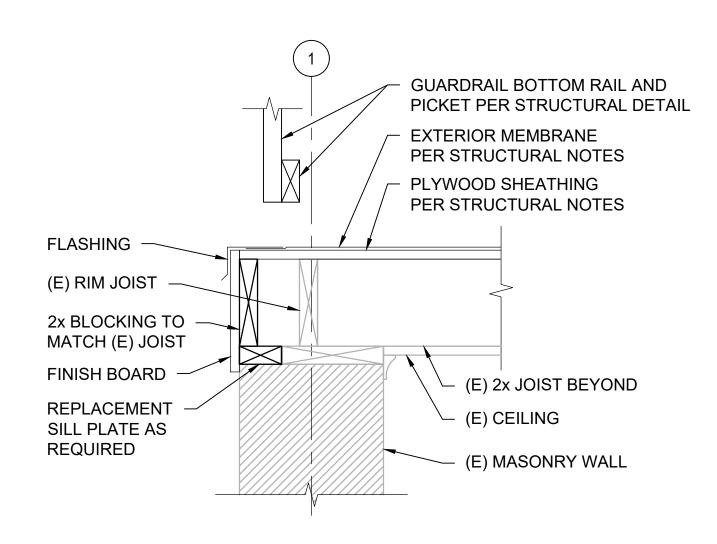
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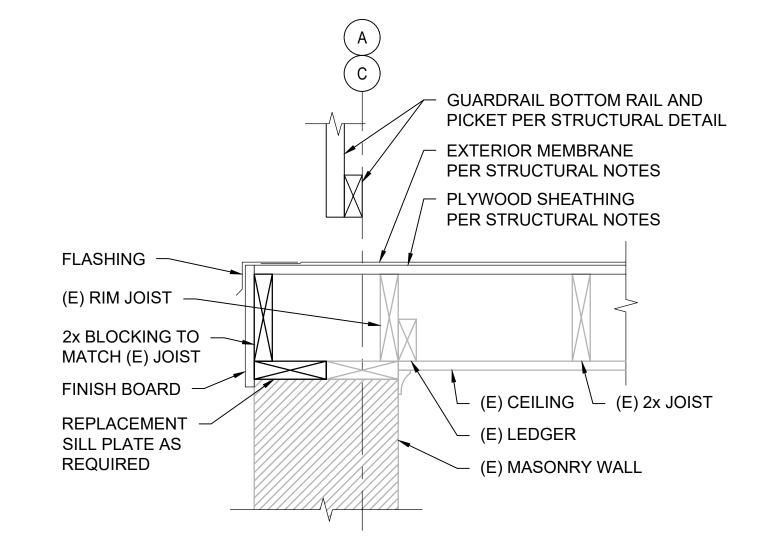
S-503
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0 1/2' 1' 1 1/2'
1-1/2" = 1'-0"

0 3" 6" 9"
3" = 1'-0"





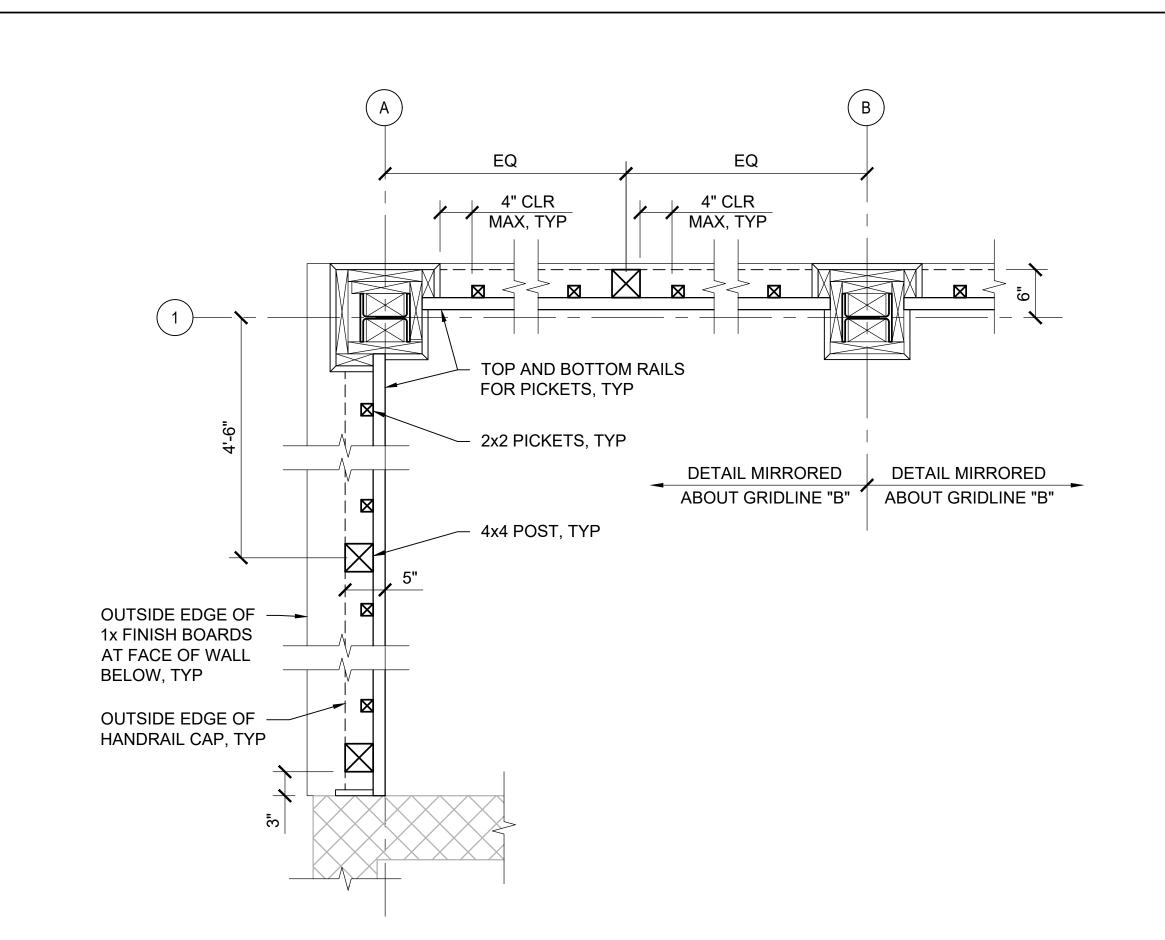

COLUMN ENCLOSURE PLAN DETAIL - SECOND FLOOR

A-501 A-501 SCALE: 1" = 1'-0"



SECOND FLOOR EDGE DETAIL



SECOND FLOOR EDGE DETAIL

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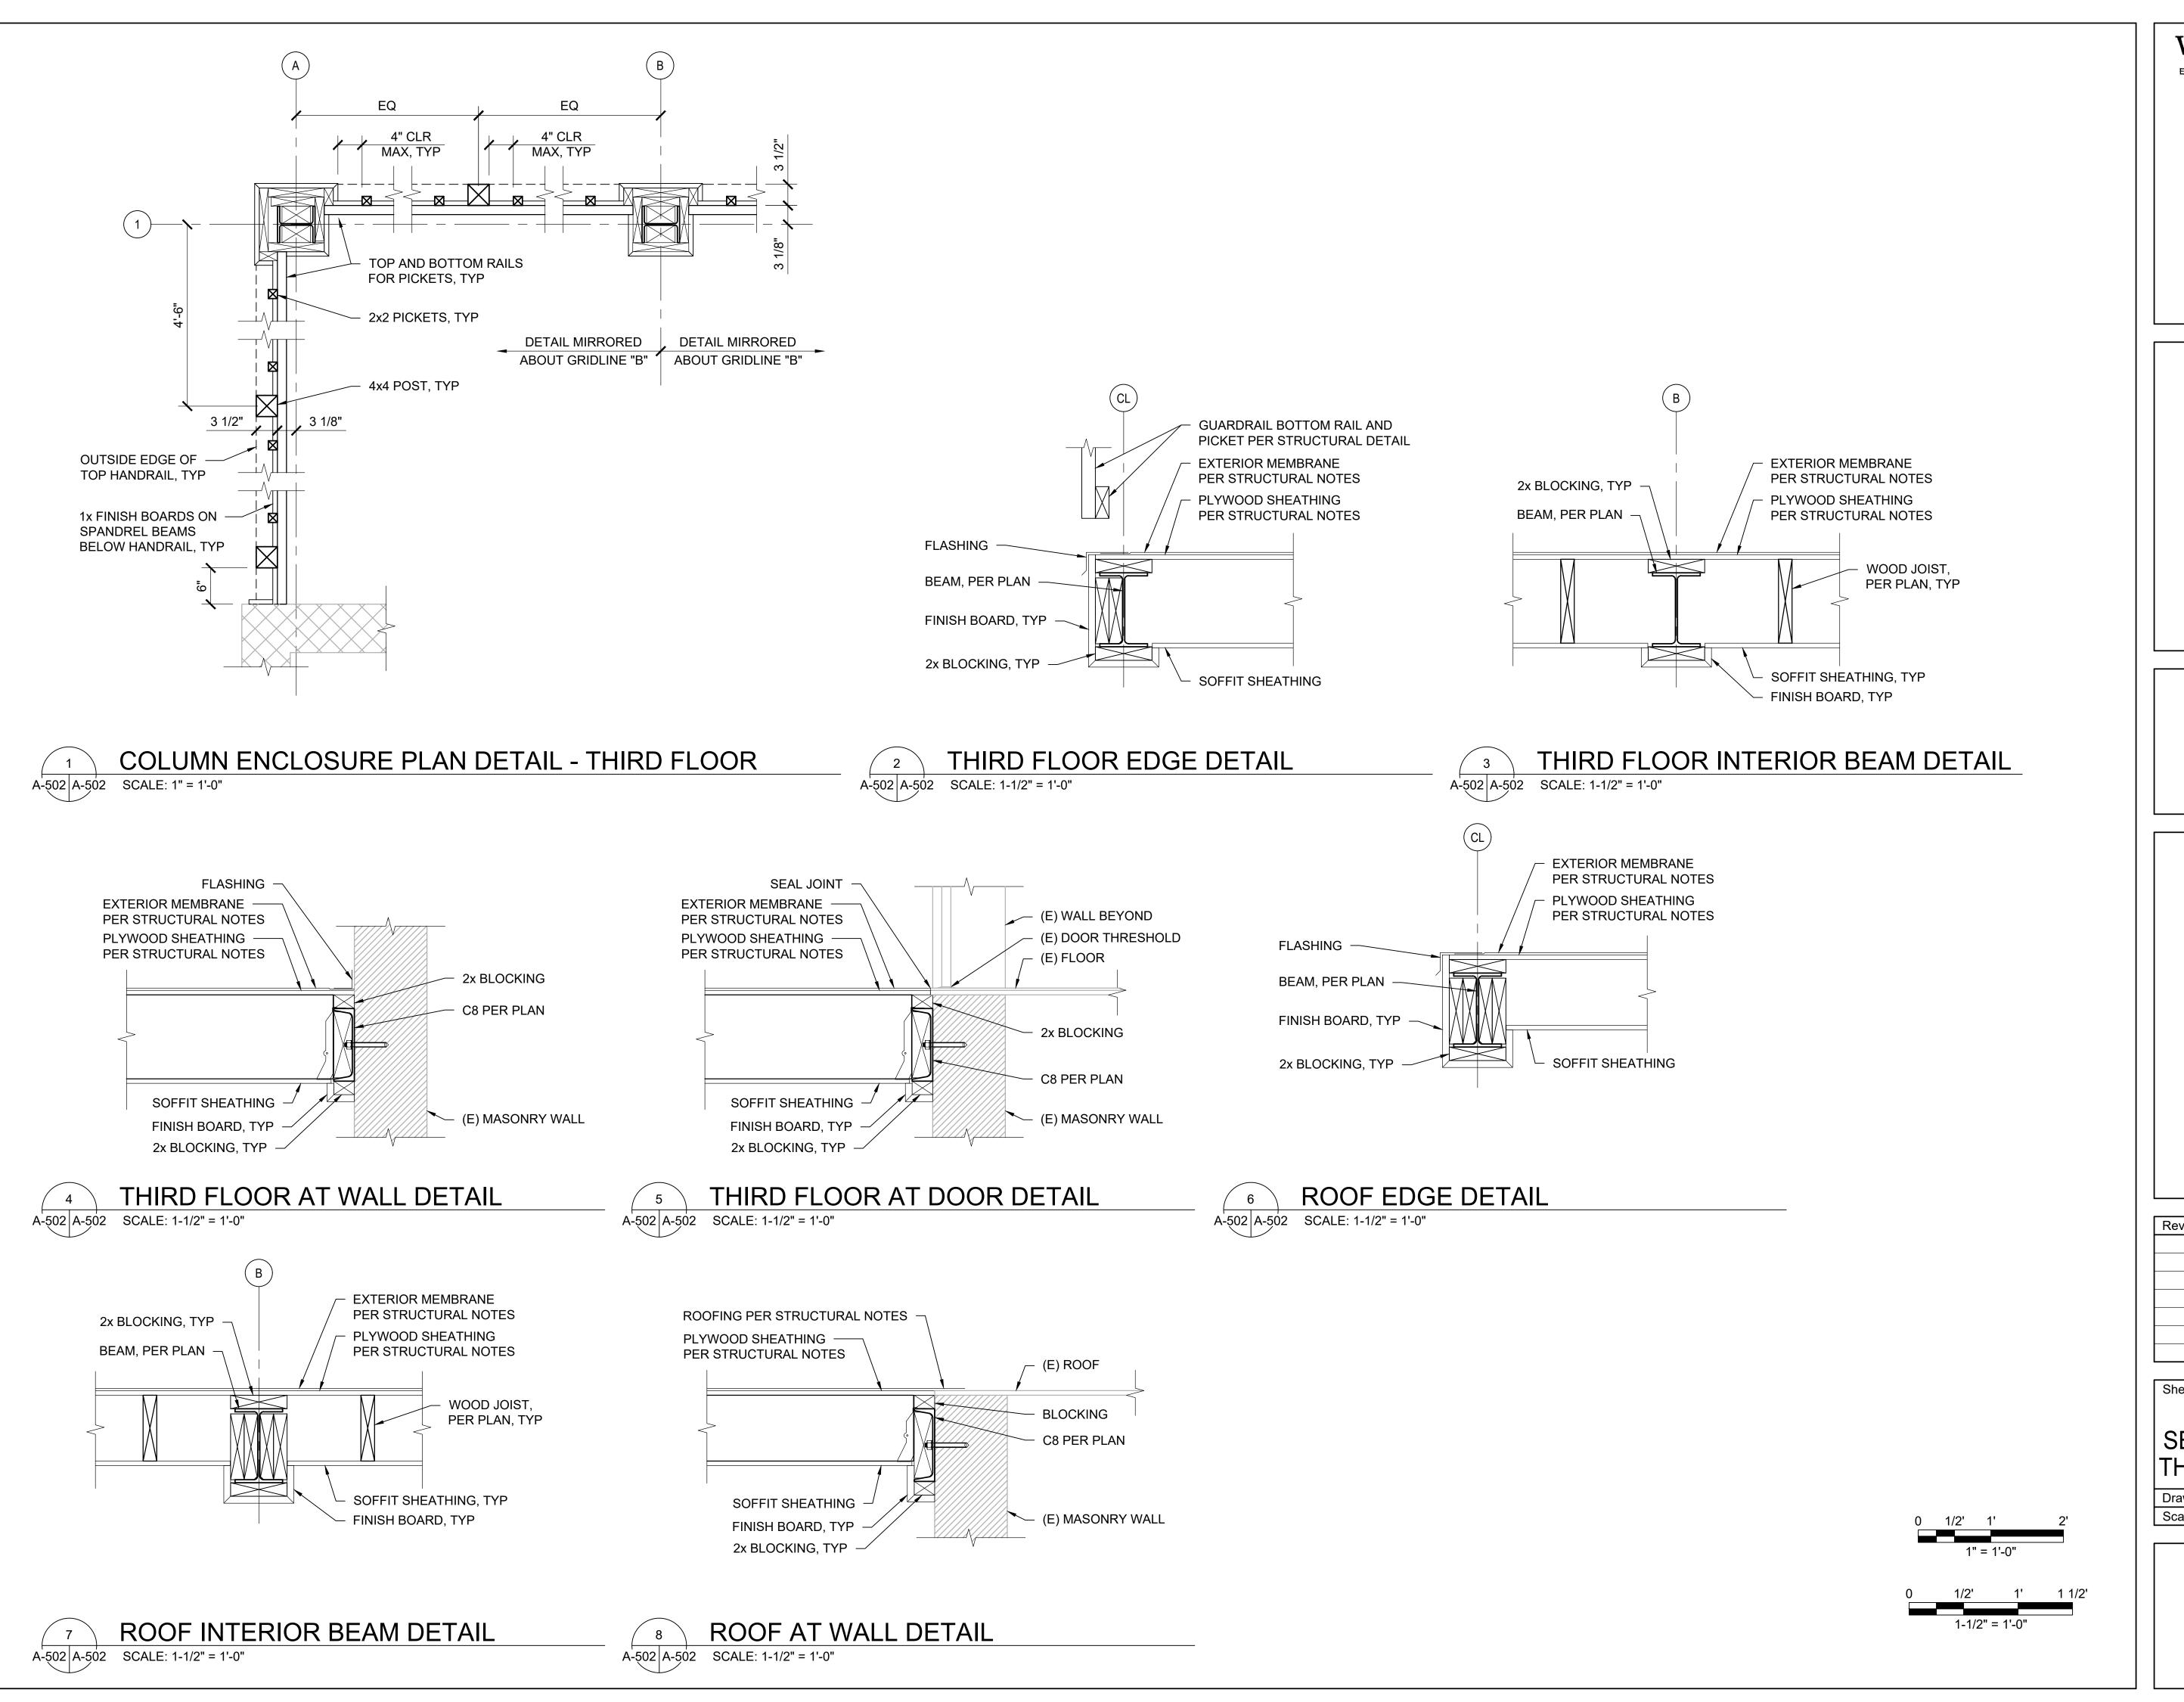
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ARCHITECTURAL SECTIONS AND DETAILS SECOND FLOOR

Approv: TMP Drawn: CAD Scale: AS NOTED Date: 2020-05-22

> Sheet No. A-501 8 of 9

0 1/2' 1' 1 1/2' 1-1/2" = 1'-0"



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ARCHITECTURAL
SECTIONS AND DETAILS
THIRD FLOOR AND ROOF

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9 of 9