City of Alexandria, Virginia

MEMORANDUM

DATE: JANUARY 22, 2020

TO: CHAIR AND MEMBERS OF THE

BOARD OF ARCHITECTURAL REVIEW

FROM: HISTORIC PRESERVATION STAFF

SUBJECT: CONCEPT REVIEW OF 912-920 KING STREET

BAR CASE # 2019-00556

I. <u>SUMMARY</u>

The applicant, Galena Capital Partners, is requesting BAR Concept Review of a four-story mixed-use development with retail frontage on King Street and residential units above on the three lots at 912, 916 and 920 King Street. The concept review for this project is going forward concurrently with the concept review for the redevelopment of the surface parking lot in the 100 block of South Henry Street (BAR Case #2019-00557), which is also owned by the applicant.

Following an unsolicited offer to purchase the City-owned surface parking lots at King and Henry streets in January 2016, the City issued a Request for Proposals (RFP) for the disposition, sale and redevelopment of these properties provided that there would be no net loss of parking spaces (85) between the two properties. The applicant's proposal was selected, in part, because the proposal included phased construction to minimize the disruption of parking, with the Henry Street project and its structured parking garage constructed first. On October 3, 2019, the Planning Commission confirmed that the sale of the City's King and Henry Street properties was consistent with the City's Master Plan (Section 9.06 of City Charter) and the properties have since been sold. The Planning Commission staff report, and associated material can be found linked in the appendix.

The Concept Review Policy was adopted in May 2001 and amended and restated in 2016 (attached). Concept Review is an optional, informal process at the beginning of a Development Special Use Permit (DSUP) application whereby the BAR provides the applicant, staff, the Planning Commission and the City Council with comments relating to the overall appropriateness of a project's height, scale, mass and general architectural character. These comments are not binding on the BAR or the applicant. The Board takes no formal action at the Concept Review stage but will provide comments and may endorse the direction of a project's design by a straw vote. If the Board believes that a building height or mass, or area proposed for construction is not appropriate and would not be supported in the future, the applicant and staff should be advised as soon as possible. This early step in the development review process is intended to minimize future architectural design conflicts between what is shown to the community and City Council during

the DSUP approval and what the Board later finds architecturally appropriate under the criteria in Chapter 10 of the Zoning Ordinance and the BAR's adopted *Design Guidelines*.

Both Development Special Use Permits (DSP2019-0032 and DSP2019-0033) will be heard by Planning Commission and City Council later in 2020.

II. <u>SITE CONTEXT AND HISTORY</u>

Site Context

The project site consists of three vacant lots currently used as a surface parking lot. The alley behind the subject property, Downham Way, is private. The location of the site adjacent to a low two-story building at the corner of King and Patrick streets mean that the sight is highly visible.

The site is primarily surrounded by two- and three-story buildings, mostly historic, containing a variety of retail, personal service and office uses. An addition to the Firehouse Square building rises to four-stories adjacent to the project site. Although the block on which the project is located is zoned commercially (KR, CD and CL), some of the buildings have residential uses, primarily those fronting on Prince Street.



Figure 1: Aerial of project site outlined in red with the associated Henry Street project shown with dashed line.

History

The three parcels at 912-920 King Street were formerly occupied by freestanding masonry buildings that were demolished in the mid-20th century. The site is flanked by a two-story masonry building at the corner of Patrick and King streets (922/924 King) built in phases beginning in 1961 according to building permits, and a three-story Italianate style Victorian townhouse with a corbeled cornice and decorative brickwork to the east. According to Ethelyn Cox in her book *Historic Alexandria Virginia Street By Street*, the building at 910 King was originally two stories with a gable roof probably dating from the early 19th century. The false front and third floor were added between 1891 and 1896, according to the Sanborn Fire Insurance Maps.

East of 910 King is Firehouse Square at 906/908 King Street, a classic three-story Art Deco commercial building constructed sometime between 1921 and 1931 (Sanborn) as a department store with two recessed entrances surrounded by large glass display windows. The limestone facade has certain neo-classical decorative elements, but its fenestration and the building name graphics, are evocative of the Art Deco era. In the late 1980s, a four to five-story addition was constructed at the rear of Firehouse Square and 904 King Street and a portion of that addition is adjacent to the project site, immediately behind 910 King Street. The 2 ½ story red brick semidetached structure across Downham Way to the south at 112/114 South Patrick Street was constructed ca. 1812 and the three-story brick townhouses across King Street to the north were constructed between 1797 and 1802, according to *Historic Alexandria Street By Street*.

III. PROPOSED DEVELOPMENT

The proposed four-story masonry building will occupy the majority of the 100 foot by 99-foot site (9,958 square feet) but will be set back 10 feet from the east property line. This portion of the site will allow for a through connection to the alley and contain the entrance to the residential units located on the upper floors. The second-through-fourth floors of the building will be set back a small amount as the building rises, though the setbacks will be most significant on the north-east and south-east corners. On the King Street elevation, the fourth floor will be set back roughly five feet. While the ground floor programing has not been determined, the King Street frontage will be commercial. The Downham Way alley frontage may be commercial or be used as live/work units.

The building will have aluminum and glass storefront window/door system on the three ground floor elevations with projecting canopies on King Street. The residential floors above will have punched multi-light windows framed by brick corbeling and decorative brickwork in the form of horizontal reveals or drafted joints implying large blocks of stone, with wider spacing between bands as the building rises. Simple horizontal metal railings will be installed at the balconies and around the perimeter of the deck on the roof. Both stair and elevator towers, as well as mechanical screening, will rise above the 50' building height. The west elevation will be devoid of openings. The applicant has provided four different King Street color schemes for the Board's feedback (A200 & A201), with the options ranging from three to four different brick colors on the building.



Figure 2: King Street elevation (color Option 1)



Figure 3: Alley elevation



Figure 4: East (pedestrian alley) elevation



Figure 5: West elevation from South Patrick Street with the existing 924 King shown in grey.

IV. STAFF ANALYSIS

As a reminder, the BAR's purview in this concept review work session is limited to endorsing the project and providing feedback on its height, scale, mass and general architectural character. It is not unusual for projects to return to the BAR for more than one concept review. The applicant will ultimately return to the Board for approval of a Certificate of Appropriateness for architectural details, finishes and colors after City Council approval of the DSUP.

Within the historic districts, the Board utilizes the *Design Guidelines* to determine if a potential new building would be compatible with nearby buildings of historic merit. The *Guidelines* do not mandate the use of historic styles for new construction. However, they do state that where new buildings recall historic building styles, the architectural details used throughout the building should be consistent with that same style noting, however, that the building should not be a slavish replica of any specific building in the district. Additionally, the *Design Guidelines* also note that "new and untried approaches to common design problems are encouraged and should not be rejected out of hand simply because they appear to be outside the common practices outlined in the guidelines."



Figure 6: King Street rendering

Staff believes that the proposed building is a good starting point for an infill building within an existing context consisting of a significant number of modest historic buildings. The site, in the heart of the historic district near the intersection of King Street and Route 1, will be very visible, especially given the significant height, scale and mass of the proposed building, and therefore careful attention should be given to all four elevations. As the applicant's elevations and massing studies demonstrate, this building will have the largest floorplate on the block and will be the tallest building on the block.

The applicant utilized a common approach of setting back upper floors to provide a lower scale on the street level – these setbacks or step-backs help to provide variation and minimize the scale of the building, particularly on the street. They serve less purpose on the south elevation and staff recommends that these be reduced or eliminated and combined with the step-backs on King Street. Notches in the plan of the building at the residential floors occur at the northeast and southeast corners of the building and provide some visual relief in the block-face. The building will be quite visible over the roof of the mid-20th century, two-story commercial building at 924 King. However, the applicant has tried to articulate this wall with color and material changes and it is

likely that this small commercial building will be replaced with a larger structure at some point in the future.

Historic buildings in the vicinity of the project site show the evolution of architecture in the historic district, though there is a higher concentration of art deco influenced buildings in the subject block and the block to the east, which the applicant noted in discussions. While the Board and staff would not support a direct copy of any historic building, the architectural character of the building should be compatible with the nearby historic buildings while still being a background building. The philosophy being that the historic district was created to preserve and feature historic buildings and new, infill construction should be well designed but should not physically or visually overwhelm the buildings that were constructed during the identified period of significance of the district and that are the reason the historic district was created. This is particularly challenging when the building is large.

There are many buildings nearby which may provide some design inspiration, such as the two most prominent buildings on the 900 block of King Street, Firehouse Square and the building at the northwest corner of Alfred and King streets, as well as the recently rehabilitated building at 1004-1008 King Street. Those two buildings, both the largest historic buildings on the block, feature interesting details at the cornice that perhaps could be studied for the third floor on the subject property (Figure 7). The proposed building recalls some Art Deco details, such as the horizontal drafted joints in the masonry walls, the punched window openings and ziggurat step-backs on the walls.

However, the step-backs are very minor and a significantly greater setback on the fourth floor would help to minimize the volume of the building from King Street. In fact, the development guidelines of the King Street Retail Strategy, adopted by City Council in June 2005, recommend a 30-degree control plane from a point 5' above the curb on the far side of King Street which the proposed building does not meet. (Figure 7)

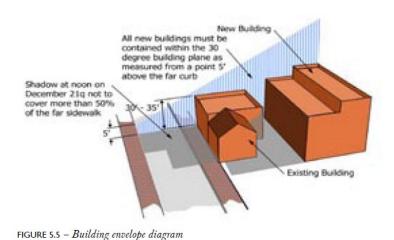


Figure 7: Illustration of the 30 degree building control plane from the King Street Retail Strategy

While staff supports the overall fenestration and the punched window openings, the applicant should also consider a different style of window muntins/mullions for the new building, perhaps with larger panes of glass or non-traditional light configurations so that the glazing reflects its 21st century construction.



Figure 7: Nearby historic buildings

Staff believes that it is premature to seek the Board's comment on the preferred color scheme because modifications to the building may be forthcoming. However, staff notes that there is no support for blue glazed bricks on this site within the heart of the historic district.

V. STAFF RECOMMENDATION

Staff recommends that the BAR endorse the overall height of the project but that the applicant continue study the mass and scale, including increased setbacks at the top floor of the King Street elevation, and to restudy general architectural character of the building relative to its immediate context and to return to the BAR for another concept review prior to seeking approval of the project from the Planning Commission and City Council.

STAFF

Stephanie Sample, Urban Planner, Planning & Zoning Al Cox, FAIA, Historic Preservation Manager, Planning & Zoning

VI. <u>ATTACHMENTS</u>

1 – Application for 912-920 King Street Concept Review

2 – BAR Concept Review Policy (adopted 2001 and amended in 2016)

ADDRESS OF PROJECT:			
DISTRICT: ☐ Old & Historic Alexandria ☐ Parker – Gray ☐ 100 Year Old Building			
TAX MAP AND PARCEL:ZONING:			
APPLICATION FOR: (Please check all that apply)			
☐ CERTIFICATE OF APPROPRIATENESS X CONCEPT REVIEW			
PERMIT TO MOVE, REMOVE, ENCAPSULATE OR DEMOLISH (Required if more than 25 square feet of a structure is to be demolished/impacted)			
WAIVER OF VISION CLEARANCE REQUIREMENT and/or YARD REQUIREMENTS IN A VISION CLEARANCE AREA (Section 7-802, Alexandria 1992 Zoning Ordinance)			
WAIVER OF ROOFTOP HVAC SCREENING REQUIREMENT (Section 6-403(B)(3), Alexandria 1992 Zoning Ordinance)			
Applicant: Property Owner Business (Please provide business name & contact person)			
Name:			
Address:			
City: State: Zip:			
Phone: E-mail :			
Authorized Agent (if applicable): Attorney Architect			
Name: Phone:			
E-mail:			
Legal Property Owner:			
Name:			
Address:			
City: State: Zip:			
Phone: E-mail:			
Yes No Is there an historic preservation easement on this property? Yes No If yes, has the easement holder agreed to the proposed alterations? Yes No Is there a homeowner's association for this property? If yes, has the homeowner's association approved the proposed alterations?			

BAR Case # _____

If you answered yes to any of the above, please attach a copy of the letter approving the project.

NATURE OF PROPOSED WORK: Please check all that apply			
NEW CONSTRUCTION EXTERIOR ALTERATION: Please check all that apply. awning fence, gate or garden wall doors windows lighting pergola/trellis other ADDITION DEMOLITION/ENCAPSULATION SIGNAGE			
DESCRIPTION OF PROPOSED WORK: Please describe the proposed work in detail (Additional pages may			
be attached).			
SUBMITTAL REQUIREMENTS:			
SUBMITTAL REQUIREMENTS: Items listed below comprise the minimum supporting materials for BAR applications. Staff may request additional information during application review. Please refer to the relevant section of the Design Guidelines for further information on appropriate treatments.			
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Items listed below comprise the minimum supporting materials for BAR applications. Staff may request additional information during application review. Please refer to the relevant section of the <i>Design Guidelines</i> for further information on appropriate treatments. Applicants must use the checklist below to ensure the application is complete. Include all information and material that are necessary to thoroughly describe the project. Incomplete applications will delay the docketing of the application for review. Pre-application meetings are required for all proposed additions.			

BAR Case #

Additions & New Construction: Drawings must be to scale and should not exceed 11" x 17" unless approved by staff. Check N/A if an item in this section does not apply to your project.

	N/A	Scaled survey plat showing dimensions of lot and location of existing building and other
		structures on the lot, location of proposed structure or addition, dimensions of existing structure(s), proposed addition or new construction, and all exterior, ground and roof mounted equipment.
		FAR & Open Space calculation form. Clear and labeled photographs of the site, surrounding properties and existing structures, if
П	П	applicable. Existing elevations must be scaled and include dimensions.
		Proposed elevations must be scaled and include dimensions. Include the relationship to adjacent structures in plan and elevations.
		Materials and colors to be used must be specified and delineated on the drawings. Actual
		samples may be provided or required. Manufacturer's specifications for materials to include, but not limited to: roofing, siding, windows, doors, lighting, fencing, HVAC equipment and walls.
		For development site plan projects, a model showing mass relationships to adjacent properties and structures.
illun	ninat	& Awnings: One sign per building under one square foot does not require BAR approval unless ed. All other signs including window signs require BAR approval. Check N/A if an item in this section does y to your project.
	N/A	Linear feet of building: Front:Secondary front (if corner lot): Square feet of existing signs to remain: Photograph of building showing existing conditions. Dimensioned drawings of proposed sign identifying materials, color, lettering style and text. Location of sign (show exact location on building including the height above sidewalk). Means of attachment (drawing or manufacturer's cut sheet of bracket if applicable). Description of lighting (if applicable). Include manufacturer's cut sheet for any new lighting fixtures and information detailing how it will be attached to the building's facade.
Alt	erat	ions: Check N/A if an item in this section does not apply to your project.
	N/A	Clear and labeled photographs of the site, especially the area being impacted by the alterations, all sides of the building and any pertinent details.
		Manufacturer's specifications for materials to include, but not limited to: roofing, siding, windows, doors, lighting, fencing, HVAC equipment and walls.
		Drawings accurately representing the changes to the proposed structure, including materials and overall dimensions. Drawings must be to scale.
		An official survey plat showing the proposed locations of HVAC units, fences, and sheds. Historic elevations or photographs should accompany any request to return a structure to an earlier appearance.

ALL	APPLICATIONS: Please read and check that you have read and understand the following items:
	I have submitted a filing fee with this application. (Checks should be made payable to the City of Alexandria. Please contact staff for assistance in determining the appropriate fee.) (N/A for Concept Review)
х	I understand the notice requirements and will return a copy of the three respective notice forms to BAR staff at least five days prior to the hearing. If I am unsure to whom I should send notice I will contact Planning and Zoning staff for assistance in identifying adjacent parcels.
×	I, the applicant, or an authorized representative will be present at the public hearing.
х	I understand that any revisions to this initial application submission (including applications deferred for restudy) must be accompanied by the BAR Supplemental form and revised materials.
	indersigned hereby attests that all of the information herein provided including the site plan, building tions, prospective drawings of the project, and written descriptive information are true, correct and

BAR Case #

The undersigned hereby attests that all of the information herein provided including the site plan, building elevations, prospective drawings of the project, and written descriptive information are true, correct and accurate. The undersigned further understands that, should such information be found incorrect, any action taken by the Board based on such information may be invalidated. The undersigned also hereby grants the City of Alexandria permission to post placard notice as required by Article XI, Division A, Section 11-301(B) of the 1992 Alexandria City Zoning Ordinance, on the property which is the subject of this application. The undersigned also hereby authorizes the City staff and members of the BAR to inspect this site as necessary in the course of research and evaluating the application. The applicant, if other than the property owner, also attests that he/she has obtained permission from the property owner to make this application.

APPLICANT OF AUTHORIZED AGENT:	
Signature:	
Printed Name: LEEJUNG HONG	
Date: 12/20/2019	

OWNERSHIP AND DISCLOSURE STATEMENT Use additional sheets if necessary

1. Applicant. State the name, address and percent of ownership of any person or entity owning an interest in the applicant, unless the entity is a corporation or partnership, in which case identify each owner of more than three percent. The term ownership interest shall include any legal or equitable interest held at the time of the application in the real property which is the subject of the application.

Name	Address	Percent of Ownership
1. Omar Abdul-Baki	1010 Pendleton Street Alexandria VA 22314	25%
2. Ahmad Abdul-Baki	1010 Pendleton Street Alexandria VA 22314	75%
3.		

2. Property. State the name, address and percent of ownership of any person or entity owning
an interest in the property located at912-920 King Street(address), unless the
entity is a corporation or partnership, in which case identify each owner of more than three
percent. The term ownership interest shall include any legal or equitable interest held at the
time of the application in the real property which is the subject of the application.

Name	Address	Percent of Ownership
1. City of Alexandria	301 King Street Alexandria VA 22314	100%
2.		
3.		

3. Business or Financial Relationships. Each person or entity listed above (1 and 2), with an ownership interest in the applicant or in the subject property is required to disclose **any** business or financial relationship, as defined by Section 11-350 of the Zoning Ordinance, existing at the time of this application, or within the12-month period prior to the submission of this application with any member of the Alexandria City Council, Planning Commission, Board of Zoning Appeals or either Boards of Architectural Review.

Name of person or entity	Relationship as defined by Section 11-350 of the Zoning Ordinance	Member of the Approving Body (i.e. City Council, Planning Commission, etc.)
1. Omar Abdul-Baki	None	None
2. Ahmad Abdul-Baki	None	None
3. City of Alexandria		

NOTE: Business or financial relationships of the type described in Sec. 11-350 that arise after the filing of this application and before each public hearing must be disclosed prior to the public hearings.

As the applicant or the applicant's authorized agent, I I	hereby attest to the best of my ability that
the information provided above is true and correct.	

1/03/2020	Omar Abdul-Baki	Show
Date	Printed Name	Signature


912-920 KING


ALEXANDRIA, VA


WINSTANLEY


ARCHITECTS & PLANNERS


DECEMBER 20, 2019 BAR CONCEPT I

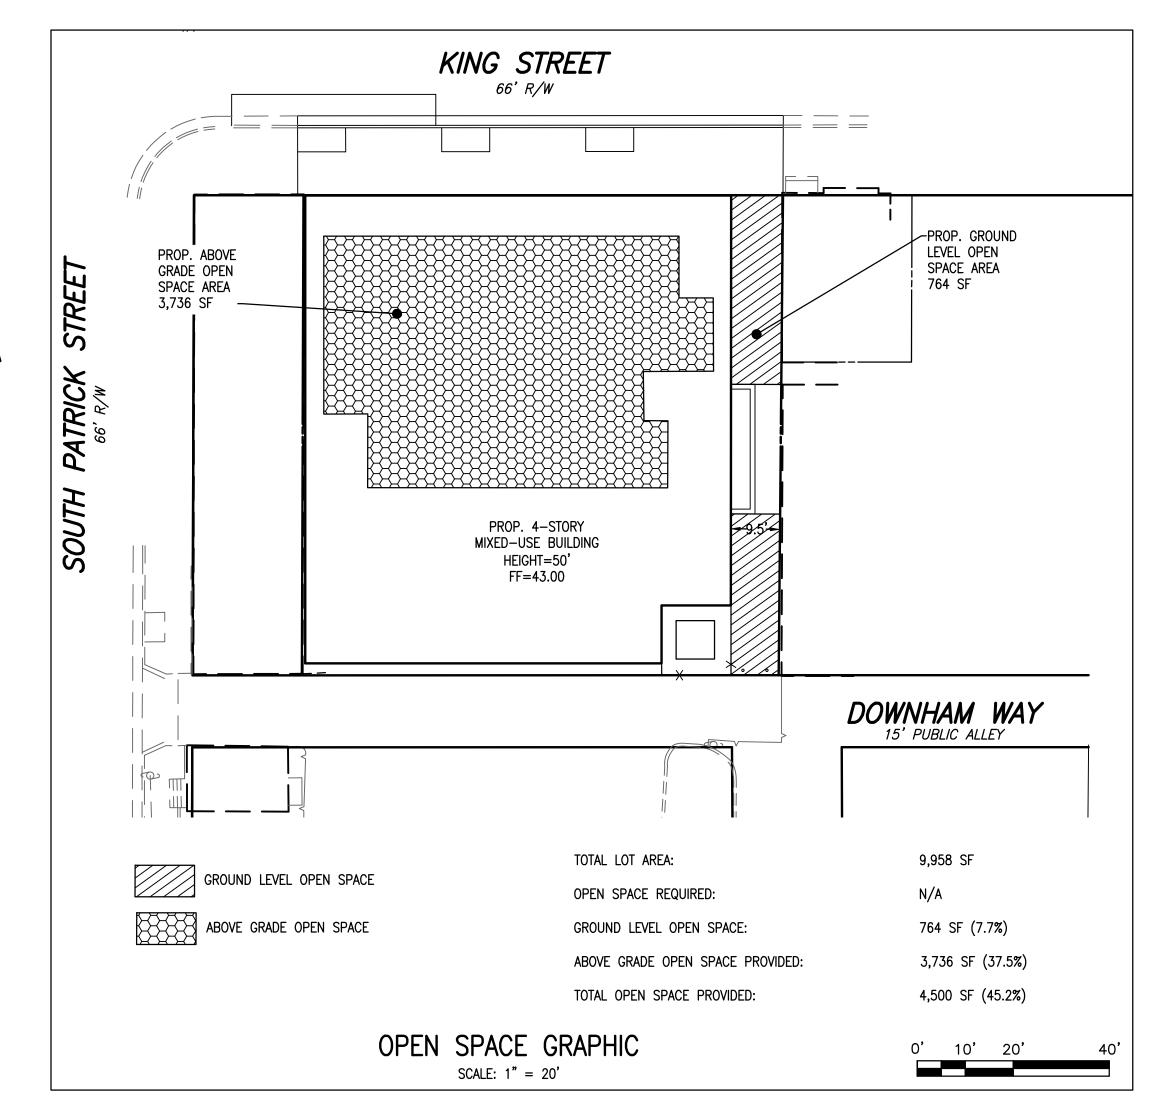

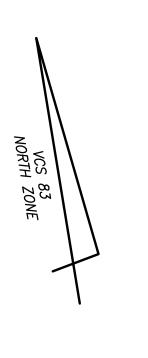

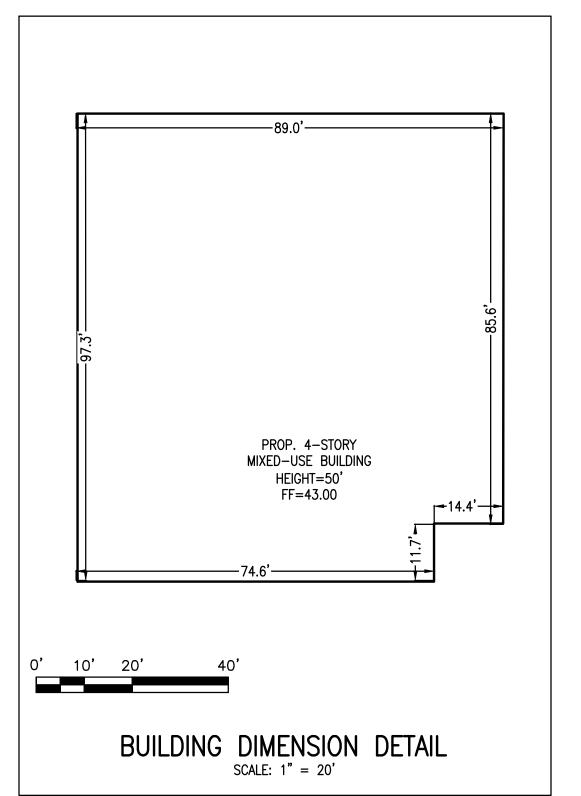

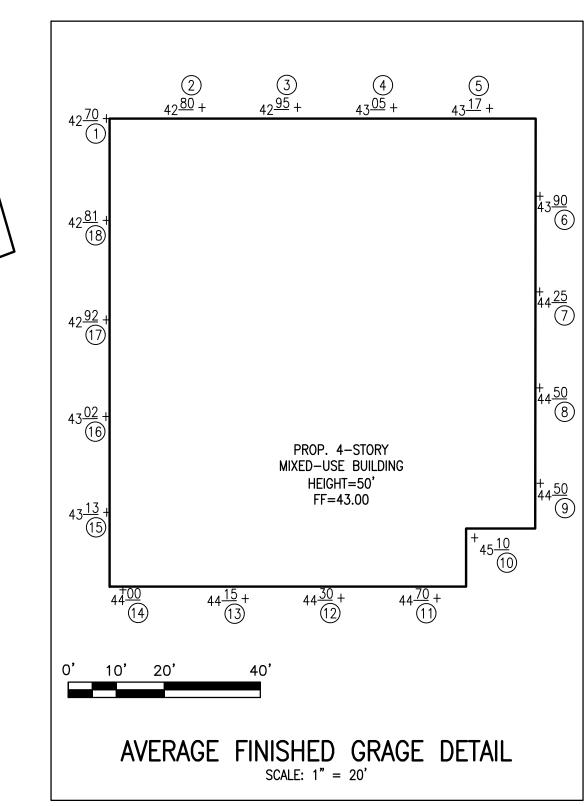

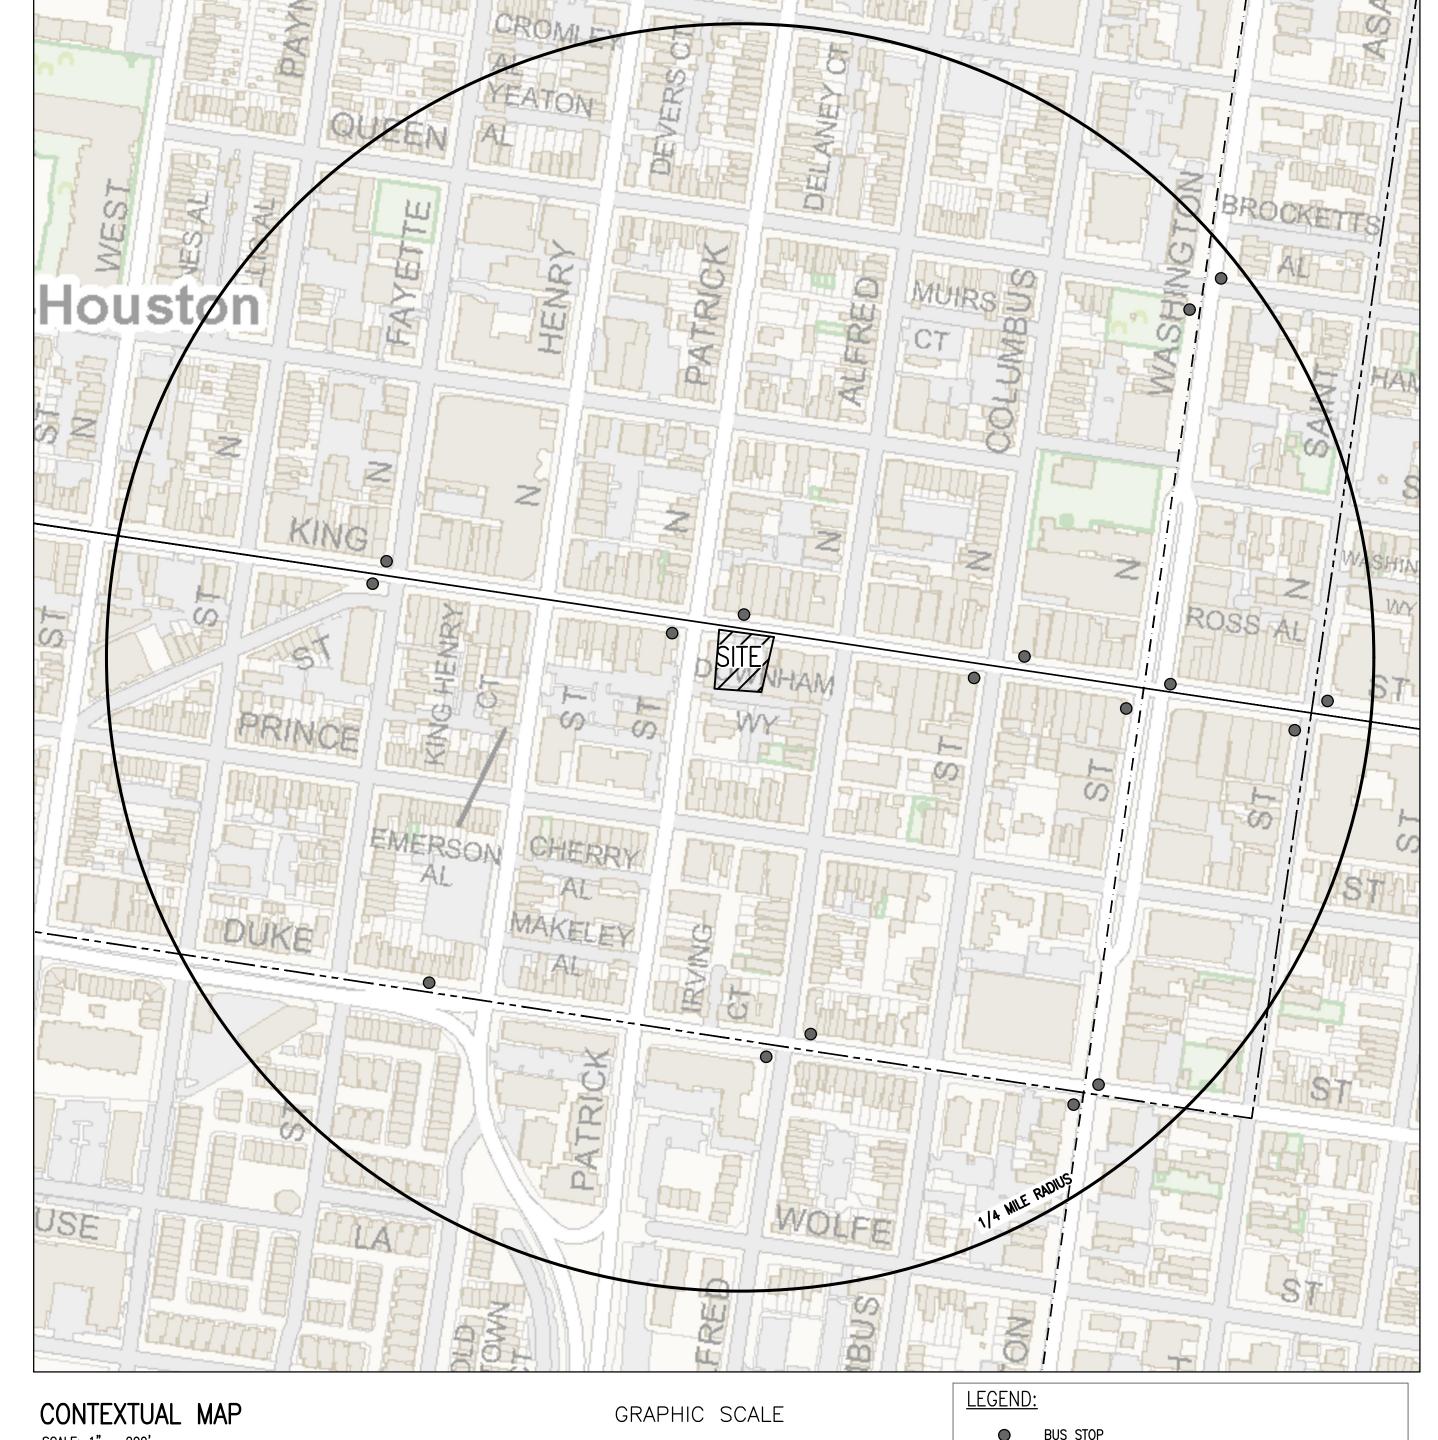

SCALE: 1" = 200'

KING STREET					
SPOT	ELEVATION	SPOT	ELEVATION		
1	42.70	10	45.00		
2	42.80	11	44.70		
3	42.95	12	44.30		
4	43.05	13	44.15		
5	43.17	14	44.00		
6	43.90	15	43.13		
7	44.25	16	43.02		
8	44.50	17	42.92		
9	44.50	18	42.81		
	AFG:		43.7		
	•				


(IN FEET) 1 inch = 200 ft.

BUS STOP — — — WMATA 10A, 10B, 11Y — — — DASH 5 ———— DASH KST, 2, 7, & 8

SECTION 6-403 COMPLIANCE NOTE:

SECTION 6-403 STATES "IN ALL HEIGHT DISTRICTS, THE ALLOWABLE HEIGHT OF A BUILDING AT ANY POINT SHALL NOT EXCEED TWICE THE DISTANCE FROM THE FACE OF THE BUILDING AT THAT POINT TO THE CENTERLINE OF THE STREET FACING SUCH BUILDING." SEE DETAILS BELOW FOR SECTION SHOWING COMPLIANCE.

SECTION 6-403 DETAILS:

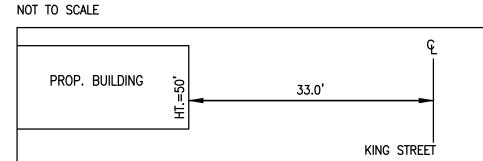

THIS DRAWING IS A SERVICE DOCUMENT OF R.C. FIELDS & ASSOCIATES, INC. AND MAY NOT BE USED OR REPRODUCED WITHOUT THE WRITTEN PERMISSION OF THE ENGINEER AND/OR LAND SURVEYOR.

EXISTING UTILITIES SHOWN ON THIS PLAN TAKEN FROM AVAILABLE RECORDS AND/OR FROM FIELD OBSERVATIONS. FOR EXACT LOCATIONS OF EXISTING UNDERGROUND UTILITIES, NOTIFY "MISS UTILITY" AT 1-800-552-7001, 72 HOURS BEFORE THE START OF ANY EXCAVATION OR CONSTRUCTION.

LOCATION AND DEPTH OF ALL EXISTING UNDERGROUND UTILITIES TO BE VERIFIED BY CONTRACTOR PRIOR TO CONSTRUCTION. INTERFERENCE OR DISRUPTION OF SAME WILL NOT BE THE RESPONSIBILITY OF THIS OFFICE. ALL CONSTRUCTION SHALL CONFORM TO THE CURRENT STANDARDS AND SPECIFICATIONS OF THE CITY OF © 2019 R.C. FIELDS & ASSOCIATES, INC.

APPROVED SPECIAL USE PERMIT NO. 2019-0032 DEPARTMENT OF PLANNING & ZONING

SITE PLAN NO. ____

DEED BOOK NO.

INSTRUMENT NO.

2 OF

DATE REVISION

DESIGN: VMM

CHECKED: ACS

SCALE: AS SHOWN DATE: DEC 20, 2019

CONTEXTUAL

PLAN

15

1. UTILITY INFORMATION, AS SHOWN ON THIS PLAN, IS TAKEN FROM THE RECORDS AND/OR FIELD SURVEY COMPLETED AND CANNOT BE GUARANTEED. FOR EXACT LOCATIONS OF EXISTING UNDERGROUND UTILITIES, NOTIFY "MISS UTILITY" AT 1-800-552-7001, 72 HOURS BEFORE THE START OF ANY EXCAVATION OR

ANDREA SPRUCH Lic. No. 047863 DECEMBER 20, 2019

TOPOGRAPHY NOTE: THIS TOPOGRAPHIC SURVEY WAS COMPLETED UNDER THE DIRECT AND RESPONSIBLE CHARGE OF ROBERTO TORRES, LS FROM AN ACTUAL GROUND SURVEY MADE UNDER MY SUPERVISION; THE IMAGERY AND/OR ORIGINAL DATA WAS OBTAINED ON OCTOBER 28, 2019 AND THIS PLAT, MAP OR DIGITAL GEOSPATIAL DATA INCLUDING METADATA MEETS MINIMUM ACCURACY STANDARDS UNLESS OTHERWISE NOTED.

INV. IN=37.83

CONTRACTOR PRIOR TO CONSTRUCTION. CONTRACTOR/ENGINEER SHOULD DIG TEST PITS

2. LOCATION AND DEPTH OF ALL EXISTING UNDERGROUND UTILITIES TO BE VERIFIED BY

THE "GENERALIZED ALEXANDRIA SOILS MAP" IDENTIFIES THE SOILS FOR THIS SITE AS

KEYPORT SILT LOAM. THE KEYPORT SILT LOAM OCCURS IN THE LOW, SMOOTH

TERRACES ALONG THE POTOMAC RIVER. IT IS GENTLY UNDULATING WITH FAIRLY WELL

10. THIS SITE DOES NOT CONTAIN AREAS PREVIOUSLY MAPPED AS MARINE CLAYS.

BY HAND AT ALL UTILITY CROSSINGS TO VERIFY EXACT LOCATION.

EX. STORM SEWER DETAILS

TAX MAP:

2. ZONE:

OWNER:

ESTABLISHED DRAINAGE.

EXISTING CONDITIONS SURVEY NOTES:

EX. CURB INLET EX. CURB INLET TOP = 42.05TOP = 41.91BOTTOM=39.15 INV. IN=38.96 (NO "OUT" VISIBLE) INV. OUT=38.71 $\langle 4 \rangle$ EX. CURB INLET EX. CURB INLET TOP=41.85 TOP = 41.78

INV. IN=39.80 (A)

INV. IN=38.90 (B)

INV. OUT=38.65

EX. SANITARY SEWER DETAILS

 \bigcirc BENCHMARK #1 BENCHMARK #2 TOP = 41.86

EX. SAN. M.H. TOP = 41.77INV. IN=33.17 INV. OUT=33.12

LOT 509 NORMAN B. JENKINS SUBD. N/F PREVENTION OF BLINDNESS SOCIETY OF METRO WASHINGTON 233 MASSACHUSETTS AVE. NE WASHINGTON, DC 20002 USE: MIXED RETAIL/OFFICE

9

N/F FMA HOLDINGS 915 KING ST. ALEXANDRIA, VA 22314 ZONE: KR

TM #064.03-06-26 USE: MIXED RETAIL/RES. INSTR. #170015053

N/F FMA HOLDINGS 915 KING ST. ALEXANDRIA, VA 22314 TM #064.03-06-27 ZONE: KR USE: MIXED RETAIL/OFFICE

INSTR. #050022875

10

API SPECIAL

INSTRUMENT NO.

DEPARTMENT OF PLANNING & ZONIN SITE PLAN NO. ____

EXISTING CONDITIONS

DEED BOOK NO.

3 OF FILE: 19-153

REVISION

#917 #913 3-STORY 3-STORY 3-STORY 3-STORY 3-STORY 2-STORY BRICK BRICK BRICK BRICK BRICK BRICK BUILDING BUILDING EX. 22.1' BUILDING FX. BUILDING BUILDING BUILDING 12" RCP STM. SEW. @ 3.71% [™] & STEPS 'O" RCP STM.-<u></u> *→TC=42.8* SEW. @ 8.35% ' TRASH EX. 10-" STM. SEW. _ # ₩ † & CONC BASE~ | YELLOW LINE 66' R/W EX."DO NOT S 81°35'00" E ~ 99.87 EX. C&G —PARK" SIGN (16) \$\implies EX. GV EX. BRICK M SIDEWALK EX. STOOP #X. BRICK RACK BIKE EX. WV CK ELEC. EX. BR. BOX WALL EX. BRICK EX. EX. BR. SIDEWALK SIGNA WALL WALL × 43.4 EX. 33.04 3\STORY BRICK BUILDING 45.3 × 45.0 ×44.5 YELLOW **BRICK** *EX.* ≥ \ BUILDING 2-STORY BRICK BUILDING 17C = 44.6SAN. SEW. *⊢EX. CHIM* ×43.8 EX. ELEC. * 43.7 JSEWER LINE ×44.6 DOWNHAM WAY BENCHMARK #2 METER PER MARKOUT ASPHALT *15' PUBLIC ALLEY* PARKING SPACES #107A 4 EX. ×44.2 * 44.8 1-STORY ×44.3 BRICK BUILDING - — W— ×41.6 EXISTING CONDITIONS PLAN VIEW SCALE: 1" = 20'ADJOINER INFORMATION: 2 1

W.S.E.= WATER SURFACE H.C.= HEADER CURB ELEVATION HDCP.= HANDICAP WV= WATER VALVE HDPE= HIGH DENSITY WM= WATER METER POLYETHYLENE W.W.= WINDOW WELL HPS= HIGH PRESSURE SODIUM

CIVIL LEGEND

TEXT LEGEND

'= MINUTES (OR FEET)

ADA = AMERICANS W

APPROX=APPROXIMATE

BC=BOTTOM OF CURB

BF= BASEMENT FLOOR

DISABILITIES ACT

BLDG.= BUILDING

BM= BENCHMARK

BOL.= BOLLARD

CL= CLASS

CATV= CABLE UTILITY

CLEAR= CLEARANCE

C.I.= CURB INLET

C.O.= CLEAN OUT

CONC.= CONCRETE

DB= DEED BOOK

DOM= DOMESTIC

DU= DWELLING UNIT

ESMT.= EASEMENT

FF= FINISH FLOOR

FH= FIRE HYDRANT

GL = GROUND LIGHT

G/V= GAS VALVE

G/M= GAS METER

G.I.= GRATE INLET

EBOX= ELECTRICAL BOX

EP= EDGE OF PAVEMENT EVE= EMERGENCY VEHICLE

FDC= FIRE DEPT. CONNECTION

USE PERMIT

E= EAST

EASEMENT

FT.= FEET

EX=EXISTING

C&G= CURB & GUTTER

DIP= DUCTILE IRON PIPE

DSP= DEVELOPMENT SITE PLAN

DSUP= DEVELOPMENT SPECIAL

CLF= CHAIN LINK FENCE

CMP = CORRUGATED METAL

"= SECONDS (OR INCHES)

IPF= IRON PIPE FOUND

INSTR.= INSTRUMENT

MPH= MILES PER HOUR

MW= MONITORING WELL

OHW= OVERHEAD WIRE

INV.= INVERT

L= LUMENS

LOC.= LOCATION

LP= LIGHT POLE

MAX.= MAXIMUM

MH= MANHOLE

MIN.= MINIMUM

N= NORTH

PN = PANEL

PP= PER PLAN

PROP= PROPOSED

RELOC. = RELOCATED

RESID.= RESIDENTIAL

R/W= RIGHT-OF-WAY

SAN.= SANITARY SEWER

S.F.= SQUARE FEET

SQ.FT.= SQUARE FEET

STM.= STORM SEWER

SUB= SUBDIVISION PLAN

TBR = TO BE REMOVED

TMH= TELEPHONE MANHOLE

TRAF.SIG.= TRAFFIC SIGNAL

VCS= VIRGINIA COORDINATE

VPD= VEHICLES PER DAY

UGE= UNDERGROUND ELECTRIC

TBS = TO BE SAVED

TC= TOP OF CURB

TOW = TOP OF WALL

STR.= STRUCTURE

T.M.= TAX MAP

TYP= TYPICAL

SYSTEM

W= WATT

W= WEST

UP= UTILITY POLE

RET.= RETAINING

PVC= POLYVINYL CHLORIDE

RCP= RE-ENFORCED CONCRETE

PG= PAGE

R= RADIUS

S= SOUTH

PIPE

•= DEGREES

%= PERCENT

#= NUMBER

lbs.= POUNDS

@= AT

A= ARC

AC.= ACRE

EXISTING	PROPOSED
<u>W</u> AL <u>K</u>	WALK
-	- ф-
w w w	w
G G G	G
T T T_	т
	S
x	x
E E E_	——Е—
+ 124.5	+ 124 5
— — —124 — — —	124
∇	▼
P	b
¢	¢
	WALK

N/F OLD TOWN 2 LLC 802 GERVAIS ST. #200 COLUMBIA, SC 29201 TM #074.01-06-01 ZONE: KR

USE: MIXED RETAIL/OFFICE INSTR. #180000335

6

ZONE: KR

N/F NINE TEN KING LLC 910 KING ST. ALEXANDRIA, VA 22314 TM #074.01-06-05 ZONE: KR USE: MIXED RETAIL/OFFICE INSTR. #080011659

LOT 3 RESUB

902-910 KING ST.

N/F SEYED H. SHOJA-MADDAHI N/F OKEEFFE PROPERTIES LLC 3927 CHANTILLY RD. 921 KING ST. ALEXANDRIA, VA 22314 CHANTILLY, VA 20151 TM #064.03-06-23 TM #064.03-06-24 ZONE: KR USE: MIXED RETAIL/RES. USE: MIXED RETAIL/OFFICE INSTR. #160001390 INSTR. #030050159

11

N/F A & H LIMITED LIABILITY CO. LLC 901 KING ST. #102 ALEXANDRIA, VA 22314 TM #064.04-05-43 ZONE: KR USE: RETAIL STORE INSTR. #170013334

CAMP SPRINGS, MD 20748 TM #074.01-06-06 TM #074.01-06-09 ZONE: KR USE: OFFICE ZONE: CD USE: VACANT INSTR. #080011658 INSTR. #160003475 8

N/F 919 KING LLC 5914 EDGEHILL DR. ALEXANDRIA, VA 22303 *TM #064.03-06-25*

3

LOT 2 RESUB

902-910 KING ST.

N/F FIREHOUSE SQUARE LLC

5620 LINDA LA.

ZONE: KR USE: MIXED RETAIL/OFFICE INSTR. #110012059

INSTR. #170015053

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LOCATION AND DEPTH OF ALL EXISTING UNDERGROUND UTILITIES TO BE VERIFIED BY CONTRACTOR PRIOR TO CONSTRUCTION. INTERFERENCE OR DISRUPTION OF SAME WILL NOT BE THE RESPONSIBILITY OF THIS OFFICE. ALL CONSTRUCTION SHALL CONFORM TO THE CURRENT STANDARDS AND SPECIFICATIONS OF THE CITY OF

FOR EXACT LOCATIONS OF EXISTING UNDERGROUND UTILITIES, NOTIFY "MISS UTILITY" AT 1-800-552-7001, 72

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CONCEPT II ENT SPECIAL EXANDRIA 6, & 920 KING & ALEXANDRIA, EX. SAN. M.H. EX. SAN. M.H. TOP = 43.89INV. IN=33.31 (FILLED W/ DEBRIS) INV. OUT=33.26 **4** % 0 WN 5 EX. TREE TABLE (1) 10" OAK (2) 12" OAK N/F ELKINS SOUTH PATRICK LLC (3) 12" PEAR 313 S. WASHINGTON ST. (4) 10" PEAR ALEXANDRIA, VA 22314

4 (5) 12" PEAR TM #074.01-06-27 (6) 14" OAK ZONE: CD (7) 15" OAK DATE

(10) 7" PEAR (11) 10" STUMP (12) 15" PEAR (13) 8" DOGWOOD (14) 14" OAK (15) 8" CHERRY (16) 3" OAK (17) 4" OAK		
PROVED AL USE PERMIT NO. 2019-0032	DESIG CHECI SCALE	KED: ACS

DATE: DEC 20, 2019 CHAIRMAN, PLANNING COMMISSION DATE RECORDED

(8) 6" OAK

(9) 16" OAK

DATE: DEC 20, 2019 CONCEPTUAL

4 OF FILE: 19-153

6 10 9 11 EX. TRAFFIC PROP. 5'x10' SIGNAL POLE TREE WELL (TYP) -PROP. DOMESTIC EX. TREE SERVICE LINE TO REMAIN-PROP. BIKE SHARE AREA-\ 43.4 PROP. CITY STD PROP. FIRE LINE /street lighting (typ) ☆□ MEX. GV 'O" RCP STM. === == TC=42.8 SEW. @ 8.35% × 42.0 -PROP. CURB & GUTTER (TYP) MANHOLE (TYP) GV EX. BRICK PROP. BRICK SIDEWALK +4300 - 15" STM 4315 4320 RETAIL -PROP. STORM *33.04* ' ENTRANCE ENTRANCE ENTRANCE MANHOLE (TYP) PROP. W/M (TYP)-/ PROP. 4-STORY PROP. C.O. (TYP)-MIXED-USE BUILDING **HYDRODYNAMIC** HEIGHT=50' FF=43.00 LOBBY ENTRANCE ¹ FF=44.25 -PROP. PUBLIC ACCESS EASEMENT PROP. PLANTER BOX BMP-PROP. ROOF DRAIN DISCHARGE (TYP)-SOUTH **AMENITIES** ENTRANCE FF=44.50 -PROP. TRANSFORMER ENCLOSURE RESIDENTIAL ∠PROP. SAN FF=44.25 I SPACE N 81°35'00" W ~ 99.29' DOWNHAM WAY *ASPHALT 15' PUBLIC ALLEY* 9 PARKING SPACES PROP. SANITARY MANHOLE (CSMH-1)-LPROP. BOLLARDS PARKING | \$IGN * 45.3_ ×44.3 ×41.6 °(15) <

HATCH LEGEND

CONCEPTUAL PLAN VIEW

BRICK SIDEWALK

SCALE: 1" = 20'

'KING

TEXT LEGEND

IPF= IRON PIPE FOUND

INSTR.= INSTRUMENT

MPH= MILES PER HOUR

MW= MONITORING WELL

OHW= OVERHEAD WIRE

INV.= INVERT

LOC.= LOCATION

LP= LIGHT POLE

MAX.= MAXIMUM

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TYP= TYPICAL

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W= WATT

W= WEST

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PG= PAGE

R= RADIUS

S= SOUTH

MIN.= MINIMUM

L= LUMENS

•= DEGREES '= MINUTES (OR FEET) "= SECONDS (OR INCHES) %= PERCENT #= NUMBER lbs.= POUNDS A= ARC AC.=ACREADA = AMERICANS WDISABILITIES ACT APPROX=APPROXIMATE BC=BOTTOM OF CURB BF= BASEMENT FLOOR BLDG.= BUILDING BM= BENCHMARK

BOL.= BOLLARD CATV= CABLE UTILITY CL= CLASS CLEAR= CLEARANCE CLF= CHAIN LINK FENCE CMP = CORRUGATED METALC.I.= CURB INLET C.O.= CLEAN OUT CONC.= CONCRETE C&G= CURB & GUTTER DB= DEED BOOK DIP= DUCTILE IRON PIPE DOM= DOMESTIC USE PERMIT DU= DWELLING UNIT E= EAST EBOX= ELECTRICAL BOX

DSP= DEVELOPMENT SITE PLAN DSUP= DEVELOPMENT SPECIAL ESMT.= EASEMENT EP= EDGE OF PAVEMENT EVE= EMERGENCY VEHICLE EASEMENT EX=EXISTING FDC= FIRE DEPT. CONNECTION FF= FINISH FLOOR FH= FIRE HYDRANT FT.= FEET

GL = GROUND LIGHTG/V= GAS VALVE G/M= GAS METER G.I.= GRATE INLET H.C.= HEADER CURB HDCP.= HANDICAP HDPE= HIGH DENSITY POLYETHYLENE

LIMITS OF DISTURBANCE

HPS= HIGH PRESSURE SODIUM

CIVIL LEGEND		
ITEM	EXISTING	PROPOSED
CURB & GUTTER		
SIDEWALK	<u> </u>	WALK
FIRE HYDRANT	- Q-	-
STRUCTURES		
WATER MAINS	W W W	
GAS MAINS	G G G	
TELEPHONE LINES	T T T_	——т
STORM SEWER	= = =	
SANITARY SEWER	<u> </u>	S
PAVING		
FENCES	×	x
POWER LINES	E E E_	——Е—
SPOT ELEVATIONS	+ 124.5	+ 124 5
CONTOURS	— — —124 — — — —	1 24
BUILDING ENTRANCES	∇	▼
UTILITY POLE	P	р
LIGHT POLE	\$	\$

GENERAL NOTES:

#074.01-06-(02, 03, & 04)

2. ZONE:

OWNER: CITY OF ALEXANDRIA P.O. BOX 178 ALEXANDRIA, VA 22313 DB. 481 , PG. 94, 135, & 236

- 4. TOPOGRAPHIC SURVEY WAS RUN BY THIS FIRM. VERTICAL DATUM USED = NAVD '88 PER CITY OF ALEXANDRIA MONUMENT #642 ELEVATION 33.53'.
- TITLE REPORT WAS FURNISHED BY INDEPENDENCE TITLE, CLIENT/CASE # MONUMENT, EFFECTIVE DATE 8/9/2018 AND IS RELIED UPON AS ACCURATE BY THE SURVEYOR.
- 6. PLAT SUBJECT TO RESTRICTIONS OF RECORD.
- TOTAL SITE AREA = 9,958 S.F. OR 0.2286 AC.
- THERE ARE NO RESOURCE PROTECTION AREAS (RPA'S), TIDAL WETLANDS, SHORES, TRIBUTARY STREAMS, FLOOD PLAINS, OR BUFFER AREAS FOR SHORES, WETLANDS, CONNECTED TIDAL WETLANDS, ISOLATED WETLANDS OR HIGHLY ERODIBLE/PERMEABLE SOILS LOCATED ON THIS SITE.
- THERE ARE NO KNOWN CONTAMINATED AREAS, CONTAMINATED SOILS OR ENVIRONMENTAL ISSUES ASSOCIATED WITH THIS SITE.
- 10. THE "GENERALIZED ALEXANDRIA SOILS MAP" IDENTIFIES THE SOILS FOR THIS SITE AS KEYPORT SILT LOAM. THE KEYPORT SILT LOAM OCCURS IN THE LOW, SMOOTH TERRACES ALONG THE POTOMAC RIVER. IT IS GENTLY UNDULATING WITH FAIRLY WELL ESTABLISHED
- 11. THIS SITE DOES NOT CONTAIN AREAS PREVIOUSLY MAPPED AS MARINE CLAYS.
- 12. THIS PROJECT IS LOCATED WITHIN THE COMBINED SEWER SHED.

SANITARY SEWER OUTFALL NARRATIVE:

THE EXISTING USE (CITY PARKING LOT) DOES NOT PRODUCE A SANITARY FLOW AS NO STRUCTURE IS LOCATED ON SITE.

THE PROPOSED MIXED USE (RETAIL/MULTIFAMILY RESIDENTIAL) PRODUCES 38,892 GALLONS

$(30 \text{ UNITS } \times 300 \text{ GPD/UNIT } \times 4 \text{ PFF}) = 36,000 \text{ GPD}$

(200 GPD/1,000 SF OF RETAIL X 4 PFF) = [200 X (3,615/1,000)] X 4 = 2,892 GPD

SINCE THE TOTAL FLOW FROM THE THE PROPOSED USE EXCEEDS 10,000 GPD, A DETAILED SANITARY SEWER OUTFALL ANALYSIS IS REQUIRED AND WILL BE PROVIDED IN SUBSEQUENT SUBMISSIONS.

ALEXRENEW NOTES:

CONTRACTOR SHALL ENSURE ALL DISCHARGES ARE IN ACCORDANCE WITH CITY OF ALEXANDRIA CODE TITLE 5, CHAPTER 6, ARTICLE B.

DEWATERING AND OTHER CONSTRUCTION RELATED DISCHARGE LIMITS TO THE SEWER SYSTEM ARE REGULATED BY ALEXRENEW PRETREATMENT. CONTRACTOR IS REQUIRED TO CONTACT ALEXRENEW'S PRETREATMENT COORDINATOR AT 703-549-3381 x2020.

FIRE SERVICE NOTE:

BUILDING FIRE DEPARTMENT CONNECTION (FDC) LOCATIONS TO BE DETERMINED IN CONJUNCTION WITH THE FIRE FLOW ENGINEERING ANALYSIS AND WILL BE INCLUDED WITH SUBSEQUENT SUBMISSIONS. SITE ACCESS WILL BE PROVIDED ALONG THE SITE'S FRONTAGE ALONG KING STREET AND THE DOWNHAM WAY PUBLIC ALLEY IN THE REAR OF THE SITE.

REFUSE TRUCK NOTE:

TRASH WILL BE COLLECTED WITHIN THE BUILDING AND STORED ONSITE. TRASH WILL BE WHEELED OUT TO THE PUBLIC ALLEY FOR PICKUP.

GREEN BUILDING NARRATIVE:

THIS PROJECT WILL COMPLY WITH THE CITY'S GREEN BUILDING POLICY. ADDITIONAL INFORMATION WILL BE PROVIDED WITH SUBSEQUENT SUBMISSIONS.

ARCHAEOLOGY NOTES:

THE APPLICANT/DEVELOPER SHALL CALL ALEXANDRIA ARCHAEOLOGY (703.746.4399) TWO WEEKS BEFORE THE STARTING DATE OF ANY GROUND DISTURBANCE SO THAT A MONITORING AND INSPECTION SCHEDULE FOR THE CITY ARCHAEOLOGIST CAN BE ARRANGED.

THE APPLICANT/DEVELOPER SHALL CALL ALEXANDRIA ARCHAEOLOGY IMMEDIATELY (703-746-4399) IF ANY BURIED STRUCTURAL REMAINS (WALL FOUNDATIONS, WELLS, PRIVIES, CISTERNS, ETC.) OR CONCENTRATIONS OF ARTIFACTS ARE DISCOVERED DURING DEVELOPMENT. WORK MUST CEASE IN THE AREA OF THE DISCOVERY UNTIL A CITY ARCHAEOLOGIST COMES TO THE SITE AND RECORDS THE FINDS.

THE APPLICANT/DEVELOPER SHALL NOT ALLOW ANY METAL DETECTION OR ARTIFACT COLLECTION TO BE CONDUCTED ON THE PROPERTY, UNLESS AUTHORIZED BY ALEXANDRIA ARCHAEOLOGY.

EXISTING STONE CURB NOTE:

ANY STONE CURBS ALONG KING STREET IN THE AREA OF DISTURBANCE SHALL BE RETAINED. REUSE BRICK PAVERS IN THE RIGHT-OF-WAY TO THE EXTENT FEASIBLE.

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EXISTING UTILITIES SHOWN ON THIS PLAN TAKEN FROM AVAILABLE RECORDS AND/OR FROM FIELD OBSERVATIONS. FOR EXACT LOCATIONS OF EXISTING UNDERGROUND UTILITIES, NOTIFY "MISS UTILITY" AT 1-800-552-7001, 7

CONSTRUCTION. INTERFERENCE OR DISRUPTION OF SAME WILL NOT BE THE RESPONSIBILITY OF THIS OFFICE. ALL CONSTRUCTION SHALL CONFORM TO THE CURRENT STANDARDS AND SPECIFICATIONS OF THE CITY OF © 2019 R.C. FIELDS & ASSOCIATES, INC.

HOURS BEFORE THE START OF ANY EXCAVATION OR CONSTRUCTION. LOCATION AND DEPTH OF ALL EXISTING UNDERGROUND UTILITIES TO BE VERIFIED BY CONTRACTOR PRIOR TO

DEPARTMENT OF TRANSPORTATION & ENVIRONMENTAL SERVICES

SITE PLAN NO. ____


INSTRUMENT NO.

APPROVED

DEPARTMENT OF PLANNING & ZONING

CHAIRMAN, PLANNING COMMISSION DATE RECORDED

DEED BOOK NO.

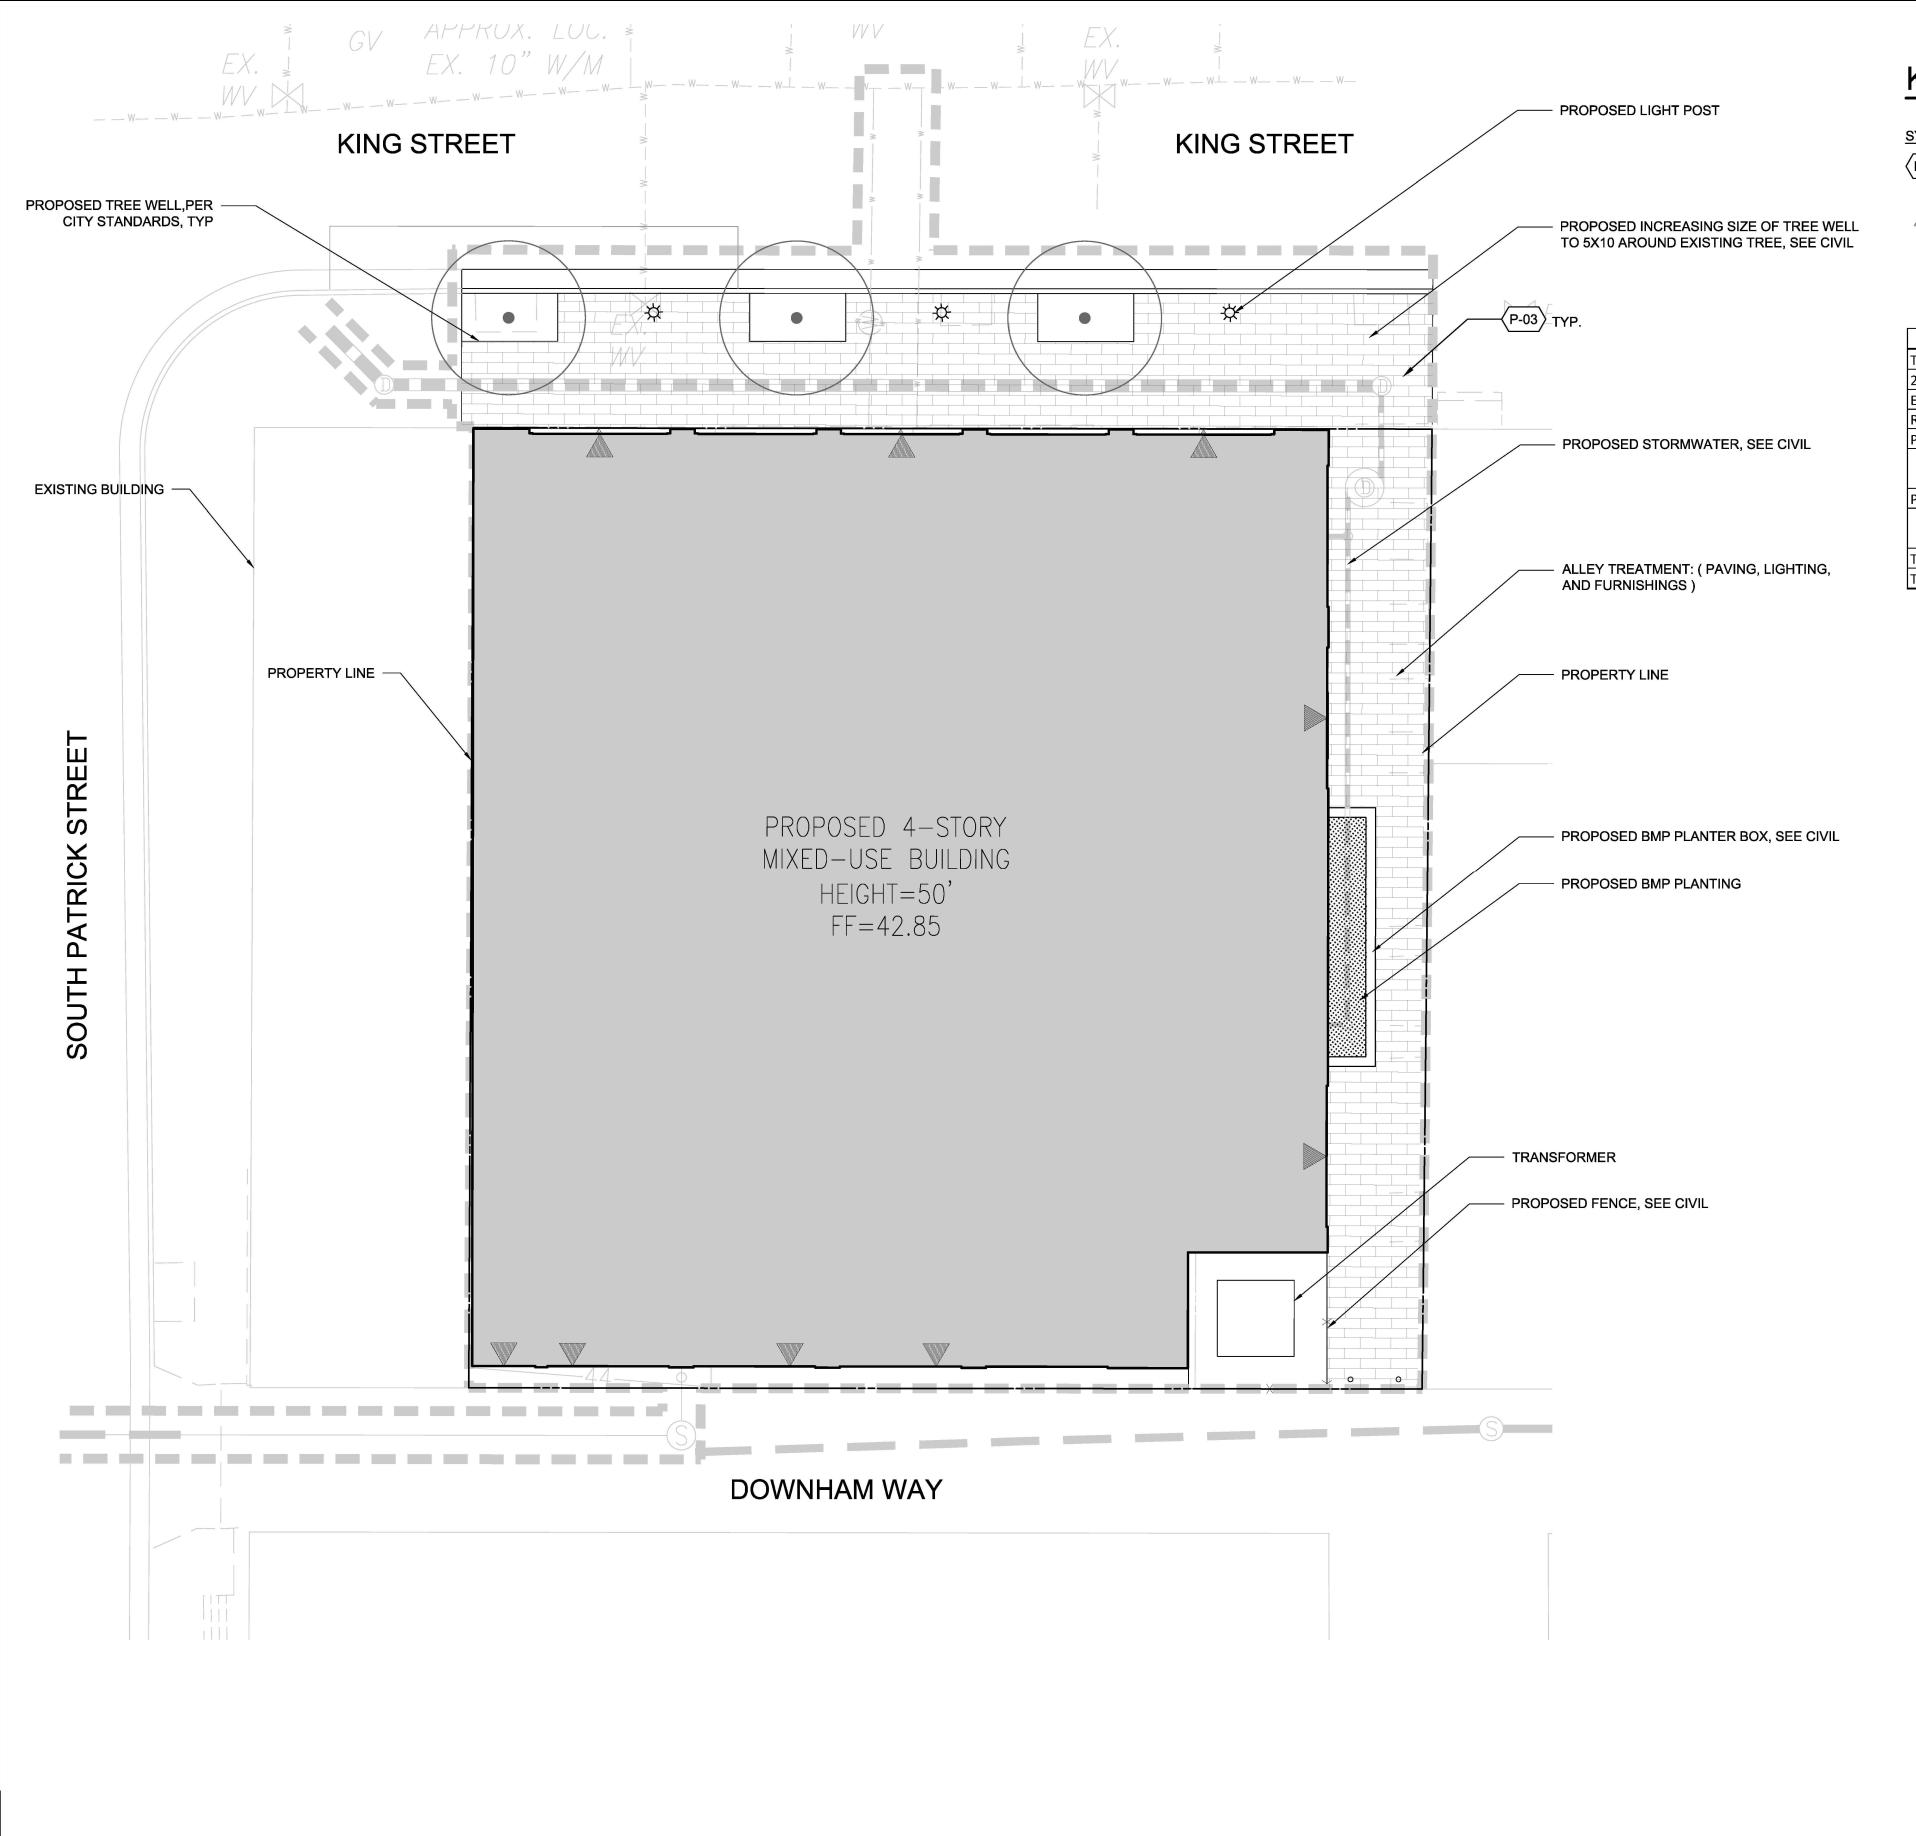

12/19/2019 5:40 PM DAPHNE BRICE Z:\TEMPLATES\SHEETS\CD SHEETS\LA\SHEET-24X36.DWT

KEY REFERENCE

<u>SYMBOL</u> (P-03)

DESCRIPTION DETAIL BRICK PAVING 3/L201



BUILDING ENTRANCE

CROWN COVER TABULATIONS				
TOTAL SITE AREA (SF)	10,302			
25% CROWN COVER REQUIRED (SF)	2,576			
EXISTING CROWN COVER (SF)	0			
REMOVED CROWN COVER (SF)	0			
PRESERVED CROWN COVER (SF)				
Crown Cover from Preserved Trees	0			
Crown Cover from Preserved Shrubs	0			
PROPOSED CROWN COVER (SF)				
Crown Cover from Proposed Trees	0			
Crown Cover from Proposed Shrubs	0			
TOTAL CROWN COVER PROVIDED (%)	0.0%			
TOTAL CROWN COVER PROVIDED (SF)	0			

CITY OF ALEXANDRIA STANDARD NOTES:

- 1. THE PROPERTY OWNER AND/OR APPLICANT, SPECIFIED, CONTRACTOR AND INSTALLER OF PLANT MATERIAL ARE RESPONSIBLE FOR UNDERSTANDING AND ADHERING TO THE STANDARDS SET FORTH IN THE MOST RECENT VERSION OF THE CITY OF ALEXANDRIA LANDSCAPE GUIDELINES AND APPLICABLE CONDITIONS OF APPROVAL. ALL QUESTIONS REGARDING APPLICATION OF, OR ADHERENCE TO, THE STANDARDS AND/OR CONDITIONS OF APPROVAL SHALL BE DIRECTED TO THE CITY PRIOR TO COMMENCEMENT OF DEMOLITION, CONSTRUCTION, OR ANY LAND DISTURBING ACTIVITY.
- 2. THE CITY-APPROVED LANDSCAPE PLAN SUBMISSION, INCLUDING PLANT SCHEDULE, NOTES AND DETAILS SHALL BE THE DOCUMENT USED FOR INSTALLATION PURPOSES AND ALL PROCEDURES SET FORTH IN THE LANDSCAPE GUIDELINES MUST BE FOLLOWED.
- 3. THE CONTRACTOR SHALL NOT INTERFERE WITH ANY TREE PROTECTION MEASURES OR IMPACT ANY EXISTING VEGETATION IDENTIFIED TO BE PRESERVED PER THE APPROVED TREE AND VEGETATION PROTECTION PLAN.
- ANY CHANGES, ALTERATIONS OR MODIFICATIONS TO THE SITE CONDITIONS THAT AFFECT VEGETATION PROTECTION ZONES WILL REQUIRE AN AMENDMENT TO THE APPROVED TREE AND VEGETATION PROTECTION PLAN AND/OR DETAILS.
- 5. INSTALLATION OF PLANT MATERIAL MAY ONLY OCCUR DURING THE PLANTING SEASONS IDENTIFIED IN THE LANDSCAPE GUIDELINES.
- 6. IN LIEU OF MORE STRENUOUS SPECIFICATIONS, ALL LANDSCAPE RELATED WORK SHALL BE INSTALLED AND MAINTAINED IN ACCORDANCE WITH THE CURRENT AND MOST UP-TO-DATE EDITION (AT TIME OF CONSTRUCTION) OF LANDSCAPE SPECIFICATION GUIDELINES AS PRODUCED BY THE LANDSCAPE CONTRACTORS ASSOCIATION OF MARYLAND, DISTRICT OF COLUMBIA AND VIRGINIA; GATHERSBURG, MARYLAND.
- 7. SUBSTITUTIONS TO THE APPROVED PLANT MATERIAL SHALL NOT OCCUR UNTIL WRITTEN APPROVAL IS PROVIDED BY THE CITY.
- MAINTENANCE FOR THIS PROJECT SHALL BE PERFORMED BY THE OWNER, APPLICANT, SUCCESSOR(S) AND/OR ASSIGN(S) IN PERPETUITY AND IN COMPLIANCE WITH CITY OF ALEXANDRIA LANDSCAPE GUIDELINES AND AS CONDITIONED BY PROJECT APPROVAL, AS APPLICABLE.
- 9. THE APPROVED METHOD(S) OF PROTECTION MUST BE IN PLACE FOR ALL VEGETATION TO BE PRESERVED ON-SITE AND ADJACENT TO THE PROJECT SITE PURSUANT TO THE APPROVED TREE AND VEGETATION PROTECTION PLAN AND DETAILS PRIOR TO COMMENCEMENT OF DEMOLITION, CONSTRUCTION, OR ANY LAND DISTURBANCE. THE APPLICANT SHALL NOTIFY THE PLANNING & ZONING (P&Z) PROJECT MANAGER ONCE THE TREE PROTECTION METHODS ARE IN PLACE. NO DEMOLITION, CONSTRUCTION, OR LAND DISTURBANCE MAY OCCUR UNTIL AN INSPECTION IS PERFORMED BY THE CITY AND WRITTEN CONFIRMATION IS PROVIDED BY THE CITY WHICH VERIFIES CORRECT INSTALLATION OF THE TREE PROTECTION MEASURES.
- 10. THE APPLICANT MUST CONTACT THE P&Z PROJECT MANAGER PRIOR TO COMMENCEMENT OF LANDSCAPE INSTALLATION/PLANTING OPERATION TO SCHEDULE A PRE-INSTALLATION MEETING. THE MEETING SHOULD BE HELD BETWEEN THE APPLICANT'S GENERAL CONTRACTOR, LANDSCAPE CONTRACTOR, LANDSCAPE ARCHITECT, THE P&Z PROJECT MANAGER AND THE CITY ARBORIST (AS APPLICABLE) TO REVIEW THE SCOPE OF INSTALLATION PROCEDURES AND PROCESSES DURING AND AFTER INSTALLATION.
- 11. THE FOLLOWING INFORMATION SHALL BE PROVIDED TO THE P&Z PROJECT MANGER AT LEAST FIVE (5) BUSINESS DAYS PRIOR TO THE LANDSCAPE PRE-INSTALLATION MEETING: 1) A LETTER THAT CERTIFIES THAT THE PROJECT LANDSCAPE ARCHITECT PERFORMED PRE-SELECTION TAGGING FOR ALL TREES PROPOSED WITHIN THE PUBLIC RIGHT OF WAY AND ON PUBLIC LAND PRIOR TO INSTALLATION. THIS LETTER MUST BE SIGNED AND SEALED BY THE PROJECT LANDSCAPE ARCHITECT, AND 2) A COPY OF THE SOIL BULK DENSITY TEST REPORT VERIFYING THAT MAXIMUM COMPRESSION RATES ARE MET.
- 12. AS-BUILT DRAWINGS FOR THIS LANDSCAPE AND/OR IRRIGATION/WATER MANAGEMENT SYSTEM WILL BE PROVIDED IN COMPLIANCE WITH CITY OF ALEXANDRIA LANDSCAPE GUIDELINES, THE CITY CODE OF ORDINANCES, AND ALL APPLICABLE PLAN PREPARATION CHECKLISTS. AS-BUILT DRAWINGS SHALL INCLUDE CLEAR IDENTIFICATION OF ALL VARIATION(S) AND CHANGES FROM APPROVED DRAWINGS INCLUDING LOCATION, QUANTITY AND SPECIFICATION OF ALL PROJECT ELEMENTS.

200 S. PEYTON STREET ALEXANDRIA, VA 22314 703.549.7784 WWW.LANDDESIGN.COM

MATTHEW V. CLARK DECEMBER 16, 2019

KING + S HENRY

GALENA CAPITAL PARTNERS 920 KING ST + 100 SOUTH HENRY ALEXANDRIA, VIRGINIA

LANDDESIGN PROJ.#

2019086 REVISION / ISSUANCE

NO. DESCRIPTION CONCEPT II SUBMISSION 12.20.19

> DESIGNED BY: MC/WT DRAWN BY: WT CHECKED BY: MC

920 KING ST DEVELOPMENT

L101

18

ORIGINAL SHEET SIZE: 24" X 36"

DEED BOOK NO. DATE

SPECIAL USE PERMIT NO. _2019-0032

DIRECTOR DATE DEPARTMENT OF TRANSPORTATION & ENVIRONMENTAL SERVICES

CHAIRMAN, PLANNING COMMISSION DATE

DEPARTMENT OF PLANNING & ZONING

SITE PLAN NO.

DATE RECORDED



GALENA CAPITAL PARTNERS

1010 Pendleton Street, Alexandria, VA 22314

912-920 KING STREET


WINSTANLEY ARCHITECTS & PLANNERS


I certify that these documents were prepared or approved by me, and that I am duly licensed architect under the laws of the state of Virginia, license number 0401012577, expiration date 08/31/2020



NO.	DATE	ISSUE DESCRIPTION
	12/20/2019	DSUP CONCEPT II
	12/20/2019	BAR CONCEPT I

A/E PROJECT NO: ## - ##

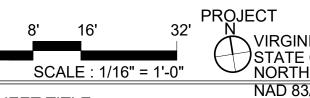

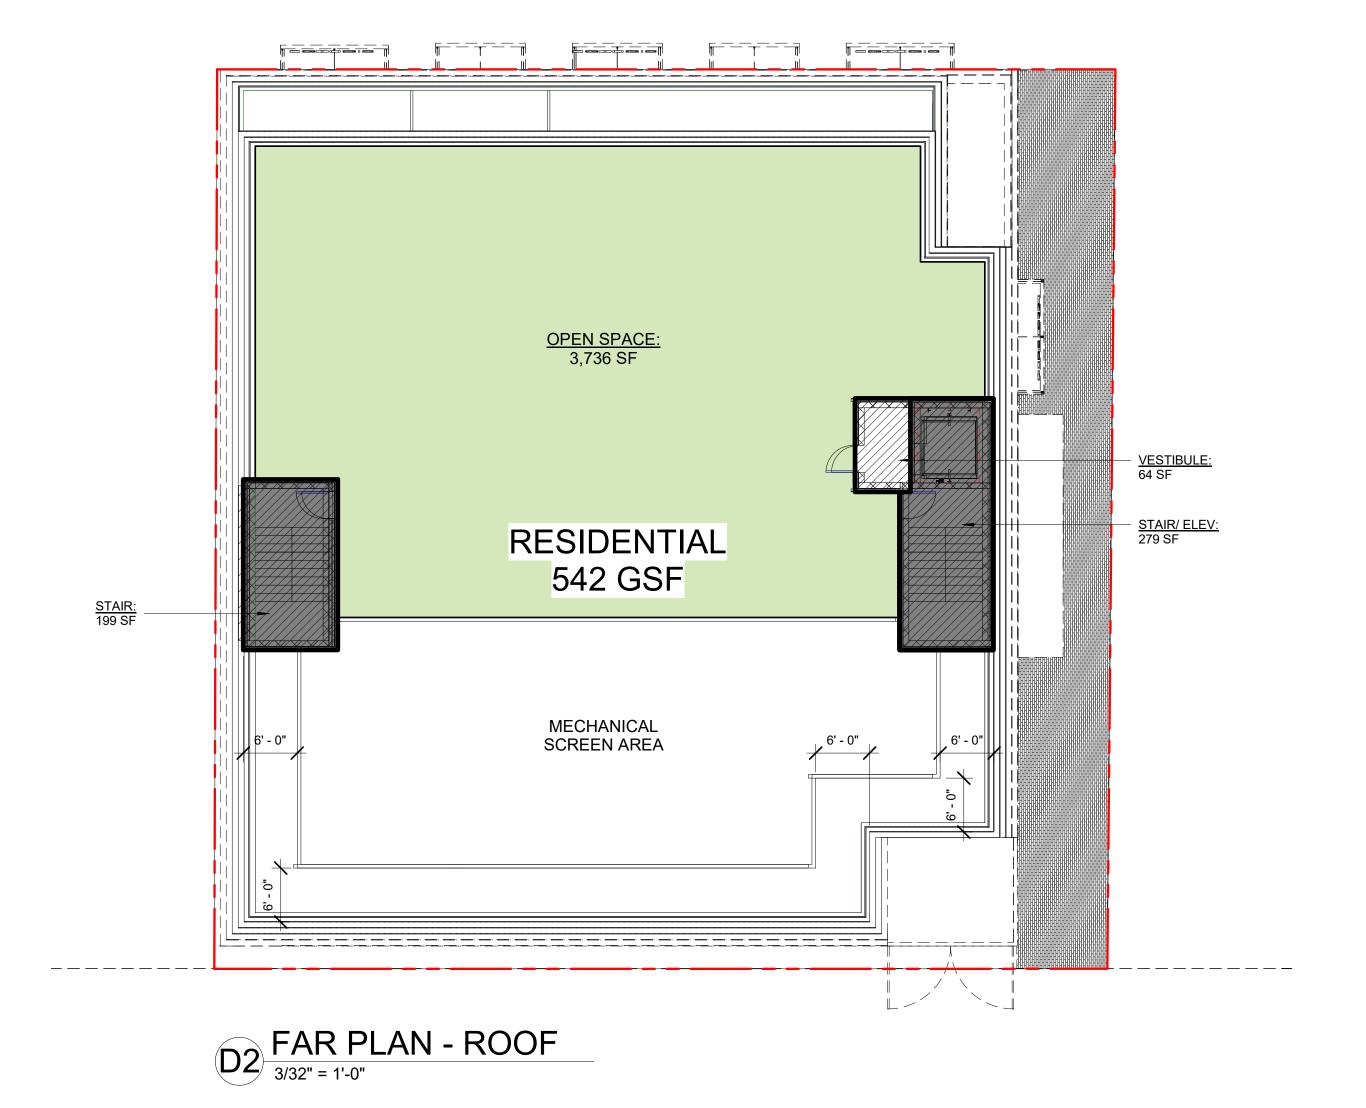

RESIDENTIAL FAR TABULATION

912-920 k	12-920 KING STREET - RESIDENTIAL					
LVL	HEIGHTS	FLOOR	GSF OPENSPACE	FAR DEDUCTIONS	FAR SF	
1st	16'-0"	4,841	764	1,589	3,252.00	
2nd	10'-8"	8,099	0	1,142	6,957.00	
3rd	10'-8"	7,874	0	1,109	6,765.00	
4th	13'-6"	7,288	0	1,083	6,205.00	
Roof	VARIES	542	3,736	478	64.00	
Total	0.00	28644.00	4,500	5,401	23,243.00	

* Not counted towards FAR

MAX. HEIGHT 50'-0" ABOVE AFG - SEE ELEVATION

		FAR DEDUCTIONS			
LVL	STAIRS/ ELEV.	SHAFTS/ UTILITY	MISC	TOTAL	
1st	813	5	771	1,589	
2nd	573	69	500	1,142	
3rd	540	69	500	1,109	
4th	514	69	500	1,083	
Roof	478	0	0	478	
Total	2918	212	2271	5,401	

* Not counted towards FAR

SITE		10,302.00
ALLOWABLE FAR	2.5	25,755.00
PROPOSED FAR	2.3	23,243.00
REMAINING FAR		2,512.00

% Deductions

UNITS	30.00
REQUIRED OPEN SPACE	4,500.00
PROPOSED OPENSPACE	4,500.00

ALLOWABLE HEIGHT ABOVE AFG	50'-0"
PROPOSED HEIGHT ABOVE AFG	50'-0"

NON-RESIDENTIAL FAR TABULATION

912-920 KING STREET - NON RESIDENTIAL					
LVL	HEIGHTS	GSF FLOOR OPENSPACE		FAR DEDUCTIONS	FAR SF
1st	16'-0"	3,615	0	100	3,515.00
2nd	10'-8"	0	0	0	0.00
3rd	10'-8"	0	0	0	0.00
4th	13'-6"	0	0	0	0.00
Roof	VARIES	0	0	0	51.00
Total	0.00	3615.00	0	100	3,566.00
* Not counted towards FAR % Deductions 0.03					

* Not counted towards FAR MAX. HEIGHT 50'-0" ABOVE AFG - SEE ELEVATION

				9
LVL			PARKING /	TOTAL
	STAIRS/ ELEV.	SHAFTS/ UTILITY	LOADING	
1st	0	0	100	100
2nd	0	0	0	0
3rd	0	0	0	0
4th	0	0	0	0
Roof	0	0	0	0
Total	0	0	100	100

* Not counted towards FAR

SITE		10,302.00
ALLOWABLE FAR	2.5	25,755.00
PROPOSED FAR	0.3	3,566.00
REMAINING FAR		22,189.00

GALENA CAPITAL PARTNERS

1010 Pendleton Street, Alexandria, VA 22314

912-920 KING STREET

Alexandria, VA



Professional Certificaton.
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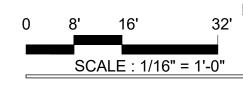


REGISTRATION:

NO.	DATE	ISSUE DESCRIPTION
	12/20/2019	DSUP CONCEPT II
	12/20/2019	BAR CONCEPT I

A/E PROJECT NO: ## - ## CHECKED BY:

APPROVED SPECIAL USE PERMIT NO. 2019-0032 DEPARTMENT OF TRANSPORTATION & ENVIRONMENTAL SERVICES CHAIRMAN, PLANNING COMMISSION DATE DATE RECORDED INSTRUMENT NO. DEED BOOK NO. DATE



SHEET TITLE:
FAR & OPEN SPACE **PLANS & TABULATIONS**

SHEET NUMBER:

GALENA CAPITAL PARTNERS

1010 Pendleton Street, Alexandria, VA 22314

912-920 KING STREET

Alexandria, VA



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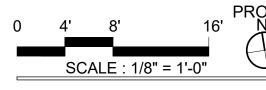


DECISTRATION:

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	12/20/2019	DSUP CONCEPT II
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A/E PROJECT NO: ## - ## CHECKED BY:

APPROVED SPECIAL USE PERMIT NO.	2019-0032
DEPARTMENT OF PLANNING & ZONING	
DIRECTOR DEPARTMENT OF TRANSPORTATION & EN	DATE
SITE PLAN NO.	
DIRECTOR	DATE
CHAIRMAN, PLANNING COMMISSION	DATE
DATE RECORDED	
INSTRUMENT NO DEED BO	DOK NO DATE



SHEET TITLE:


CONSTRUCTION PLAN -**GROUND FLOOR**

SHEET NUMBER:



CONSTRUCTION PLAN - SECOND FLOOR

1/8" = 1'-0"

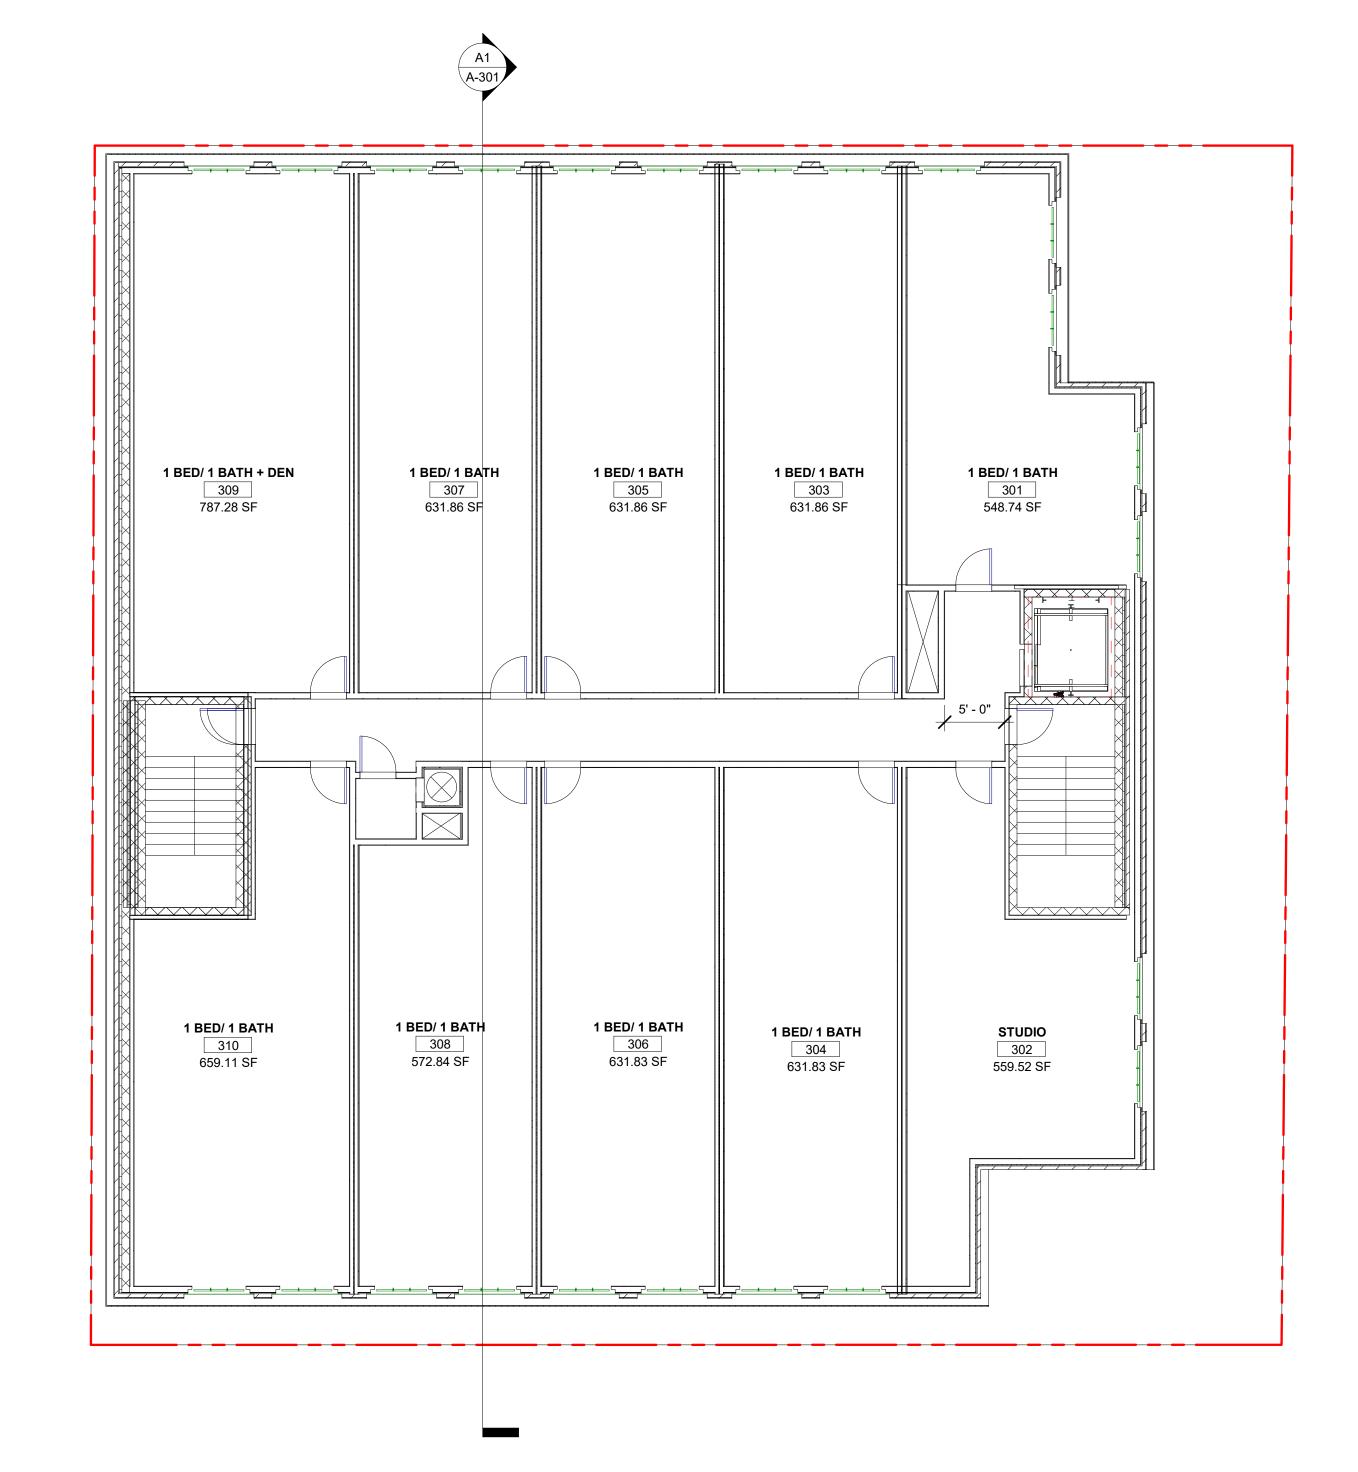

CONSTRUCTION PLAN - THIRD FLOOR

1/8" = 1'-0"

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ARCHITECTS & PLANNERS

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REGI	STRATION:	
NO.	DATE	ISSUE DESCRIPTION
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	12/20/2019	BAR CONCEPT I

A/E PROJECT NO: ## - ##

DRAWN BY: XX

CHECKED BY: XX

APPROVED

SPECIAL USE PERMIT NO. 2019-0032

DEPARTMENT OF PLANNING & ZONING

DIRECTOR DATE

DEPARTMENT OF TRANSPORTATION & ENVIRONMENTAL SERVICES


SITE PLAN NO.

DIRECTOR DATE

CHAIRMAN, PLANNING COMMISSION DATE

DATE RECORDED

INSTRUMENT NO. DEED BOOK NO. DATE

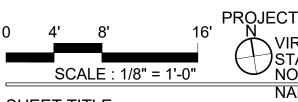

SHEET TITLE:

CONSTRUCTION PLAN - SECOND & THIRD FLOOR

SHEET NUMBER:

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NO.	DATE	ISSUE DESCRIPTIO
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	12/20/2019	BAR CONCEPT I

A/E PROJECT NO: ## - ## CHECKED BY:

APPROVED
special use permit no. 2019-0032 INSTRUMENT NO. DEED BOOK NO. DATE

SHEET TITLE:

CONSTRUCTION PLAN -**FOURTH FLOOR & ROOF**

SHEET NUMBER:

A-112

23

Original drawing is 24" x 36". Scale entities accordingly if reduced.

1 BED/ 1 BATH 1 BED/ 1 BATH 1 BED/ 1 BATH 1 BED/ 1 BATH 407 636.77 SF 406 563.18 SF 405 622.17 SF 404 622.17 SF


CONSTRUCTION PLAN - FOURTH FLOOR

1/8" = 1'-0"

2 BED/ 2 BATH 403 1238.61 SF

3 BED/ 2-1/2 BATH 401 1594.29 SF

STUDIO402
535.22 SF

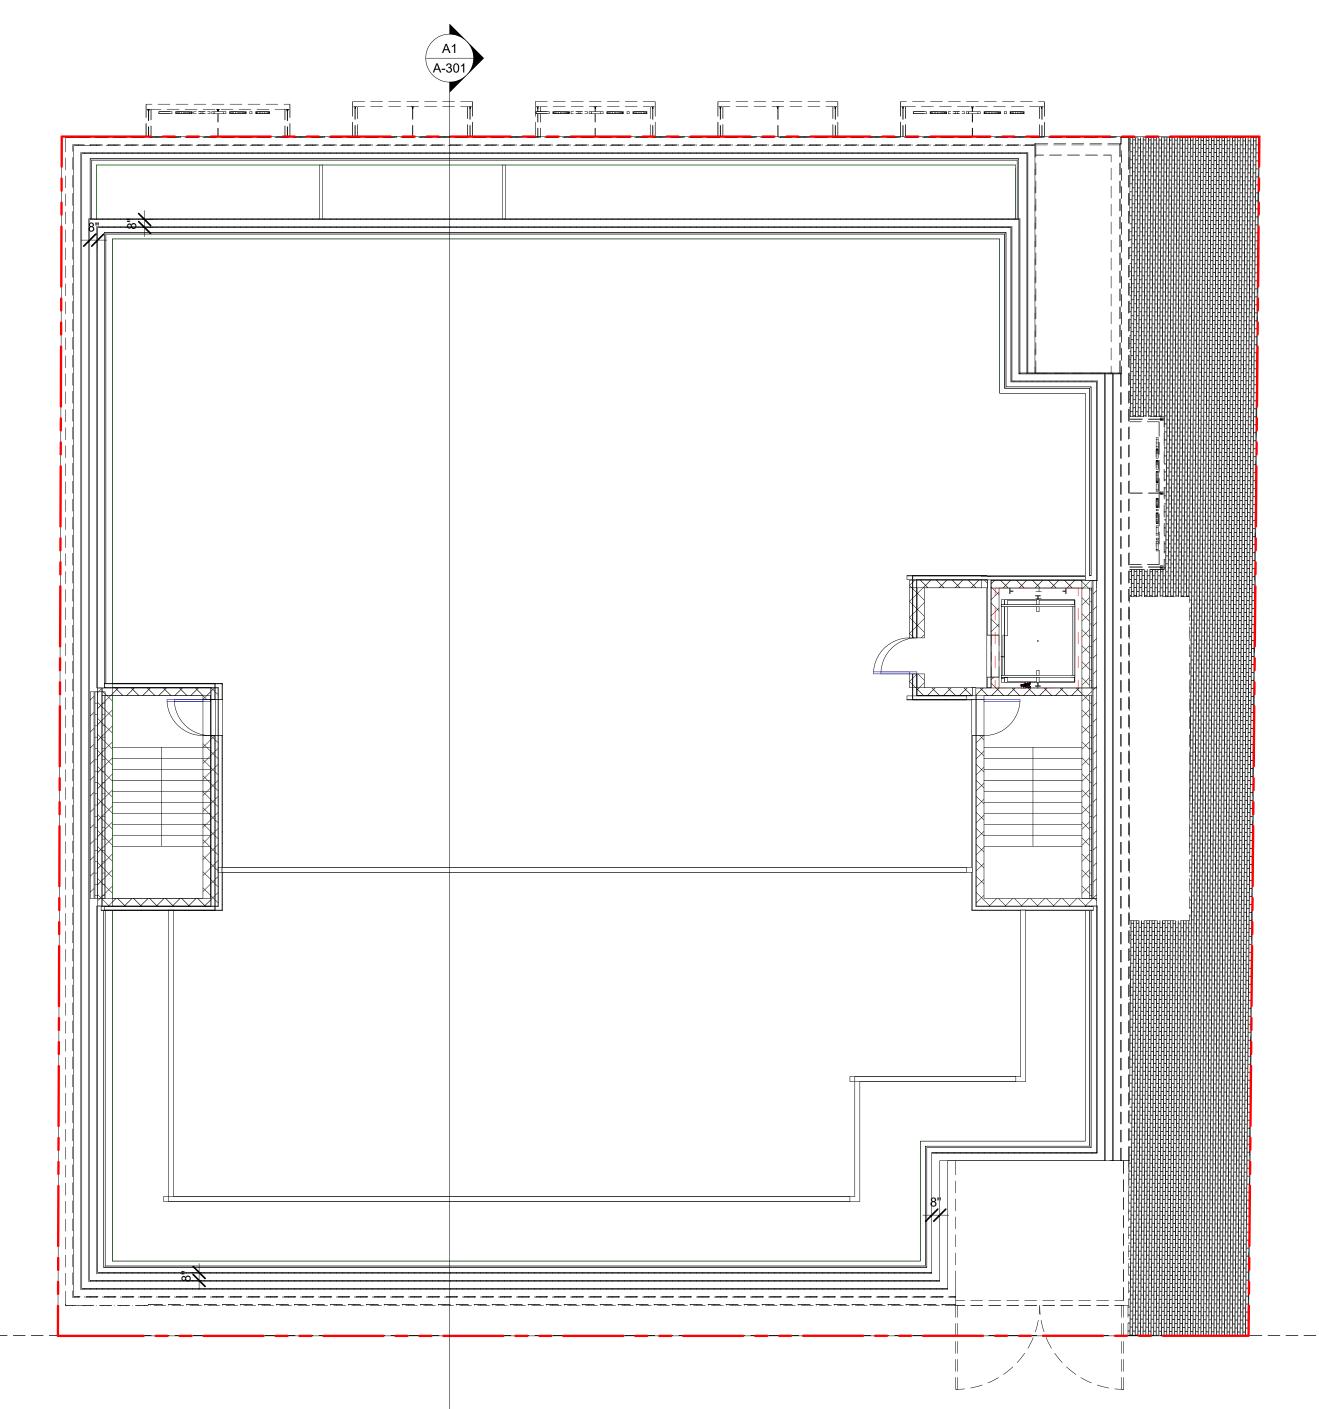

A5 CONSTRUCTION PLAN - ROOF

OPTION 1



OPTION 2



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	12/20/2019	BAR CONCEPT I	

A/E PROJECT NO: ## - ## CHECKED BY: XX

APPROVED
special use permit no. 2019-0032

INSTRUMENT NO. DEED BOOK NO. DATE



SHEET TITLE:
STREET ELEVATION -NORTH (COLOR STUDIES)

SHEET NUMBER:

A-200

Original drawing is 24" x 36". Scale entities accordingly if reduced.

OPTION 3



OPTION 4



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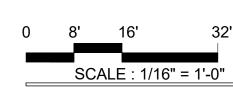
Professional Certificaton.
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NO.	DATE	ISSUE DESCRIP
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DRAWN BY: CHECKED BY:

SPECIAL USE PERMIT NO	2019-0032
DEPARTMENT OF PLANNING & ZONING	
DIRECTOR	DATE
DEPARTMENT OF TRANSPORTATION & ENVIRONM	ENTAL SERVICES
SITE PLAN NO.	
DIRECTOR	DATE



SHEET TITLE:
STREET ELEVATION -NORTH (COLOR STUDIES)

INSTRUMENT NO. DEED BOOK NO. DATE

SHEET NUMBER:



NORTH ELEVATION (KING STREET)

SOUTH ELEVATION (PUBLIC ALLEY)



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DECISTRATION:

NO.	DATE	ISSUE DESCRIPTION
	12/20/2019	DSUP CONCEPT II
	12/20/2019	BAR CONCEPT I

A/E PROJECT NO: ## - ## DRAWN BY: CHECKED BY: XX

APPROVED special use permit no	19-0032
DEPARTMENT OF PLANNING & ZONING	
DIRECTOR	DATE
DEPARTMENT OF TRANSPORTATION & ENVIRONMENT	AL SERVICES
SITE PLAN NO.	
DIRECTOR	DATE
	DATE
CHAIRMAN, PLANNING COMMISSION	DATE
DATE RECORDED	




SHEET TITLE:

EXTERIOR ELEVATION -NORTH & SOUTH

SHEET NUMBER:



EAST ELEVATION (PEDESTRIAN ALLEY)

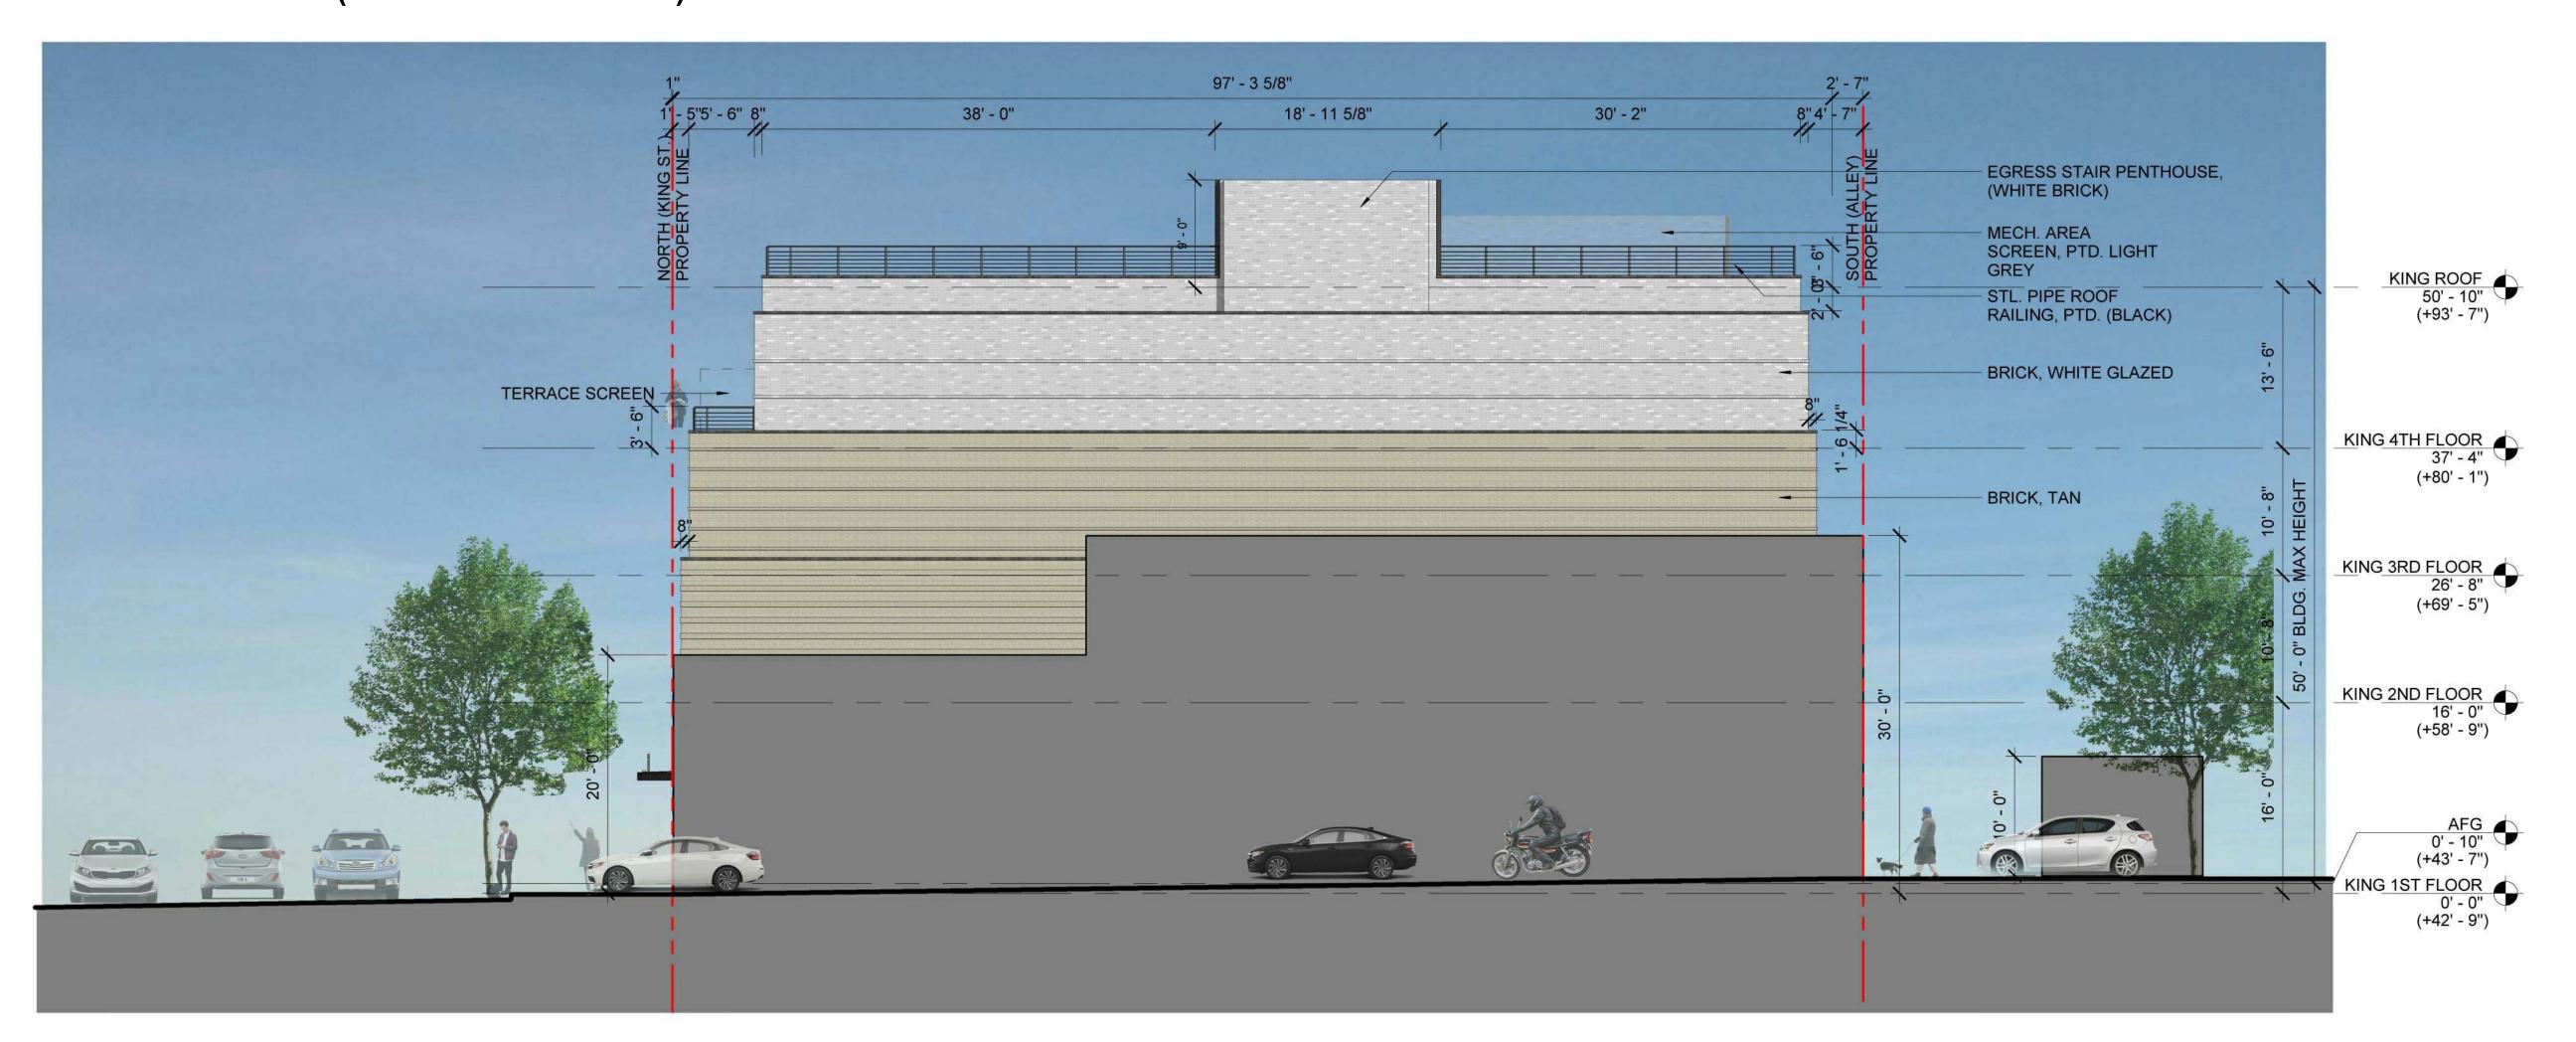

WEST ELEVATION

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912-920 KING STREET Alexandria, VA



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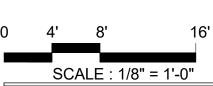


REGISTRATION:

NO.	DATE	ISSUE DESCRIPTION
	12/20/2019	DSUP CONCEPT II
	12/20/2019	BAR CONCEPT I

CHECKED BY:

APPROVED SPECIAL USE PERMIT NO. __2019-0032



SHEET TITLE:
EXTERIOR ELEVATION -**EAST & WEST**

SHEET NUMBER:

A-203

Original drawing is 24" x 36". Scale entities accordingly if reduced

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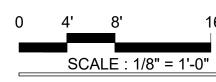
REGISTRATION:

NO.	DATE	ISSUE DESCRIPTION
	12/20/2019	DSUP CONCEPT II
	12/20/2019	BAR CONCEPT I

A/E PROJECT NO: ## - ## CHECKED BY: XX

APPROVED
special use permit no. 2019-0032

INSTRUMENT NO. DEED BOOK NO. DATE



SHEET TITLE:
BUILDING SECTION

SHEET NUMBER:

A-301

97' - 3 5/8"

17' - 11 1/4"

30' - 2"

- EGRESS STAIR PENTHOUSE

MECH. AREA

RESIDENTIAL UNIT

RESIDENTIAL UNIT

RESIDENTIAL UNIT

RESIDENTIAL UNIT

- GUARD RAIL

KING ROOF 50' - 10" (+93' - 7")

KING 4TH FLOOR 37' - 4" (+80' - 1")

KING 3RD FLOOR 26' - 8" (+69' - 5")

KING 2ND FLOOR 16' - 0" (+58' - 9")

KING MEZZ FLOOR 05' -15" (+43' - 7")

9' - 11 7/8"

Original drawing is 24" x 36". Scale entities accordingly if reduced.

BUILDING SECTION - NORTH-SOUTH

1/8" = 1'-0"

NORTH (KING ST.) PROPERTY LINE

6' - 11"

29' - 0 1/2"

ROOF DECK

RESIDENTIAL UNIT


RESIDENTIAL UNIT

RESIDENTIAL UNIT


<u>RETAIL</u>

ELEVATOR PENTHOUSE

ELEVATOR VESTIBULE

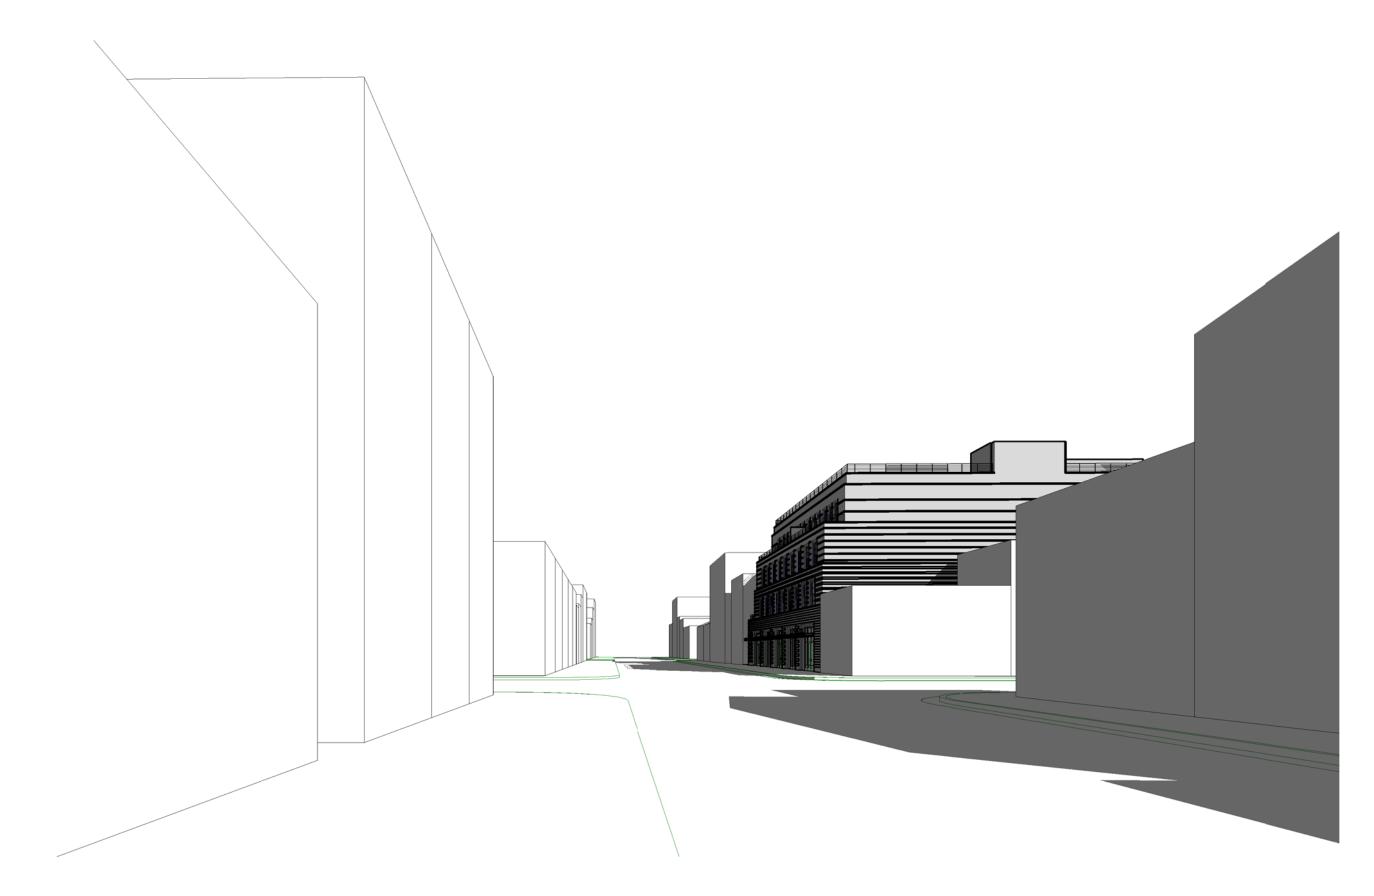

D1 STREET VIEW - FROM KING ST. FACING EAST

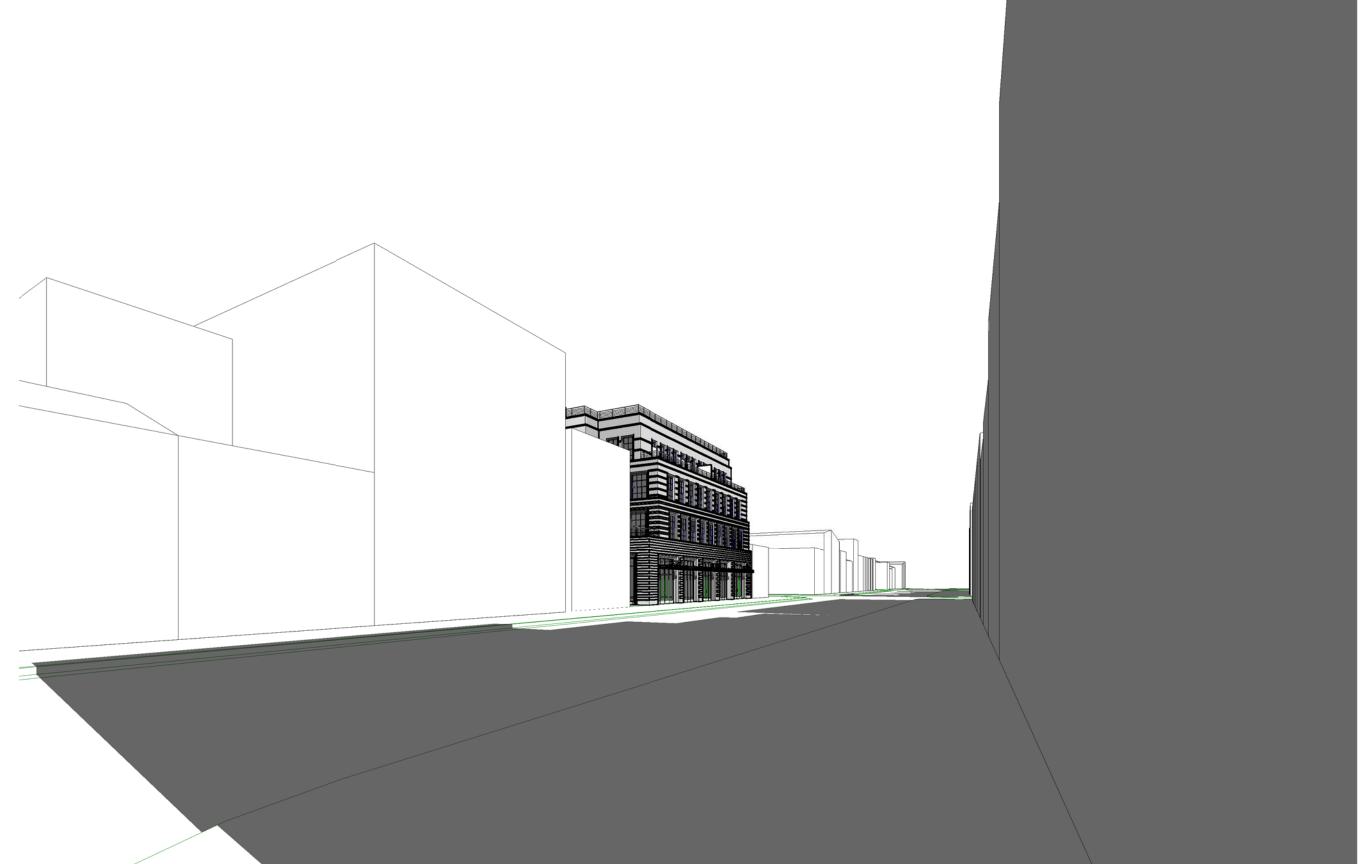

STREET VIEW - FROM N-W CORNER OF KING ST. & N. ALFRED ST. A1 FACING WEST



STREET VIEW - FROM N-W CORNER OF KING ST. & N. WEST ST. D5 FACING EAST



STREET VIEW - FROM KING ST. FACING WEST

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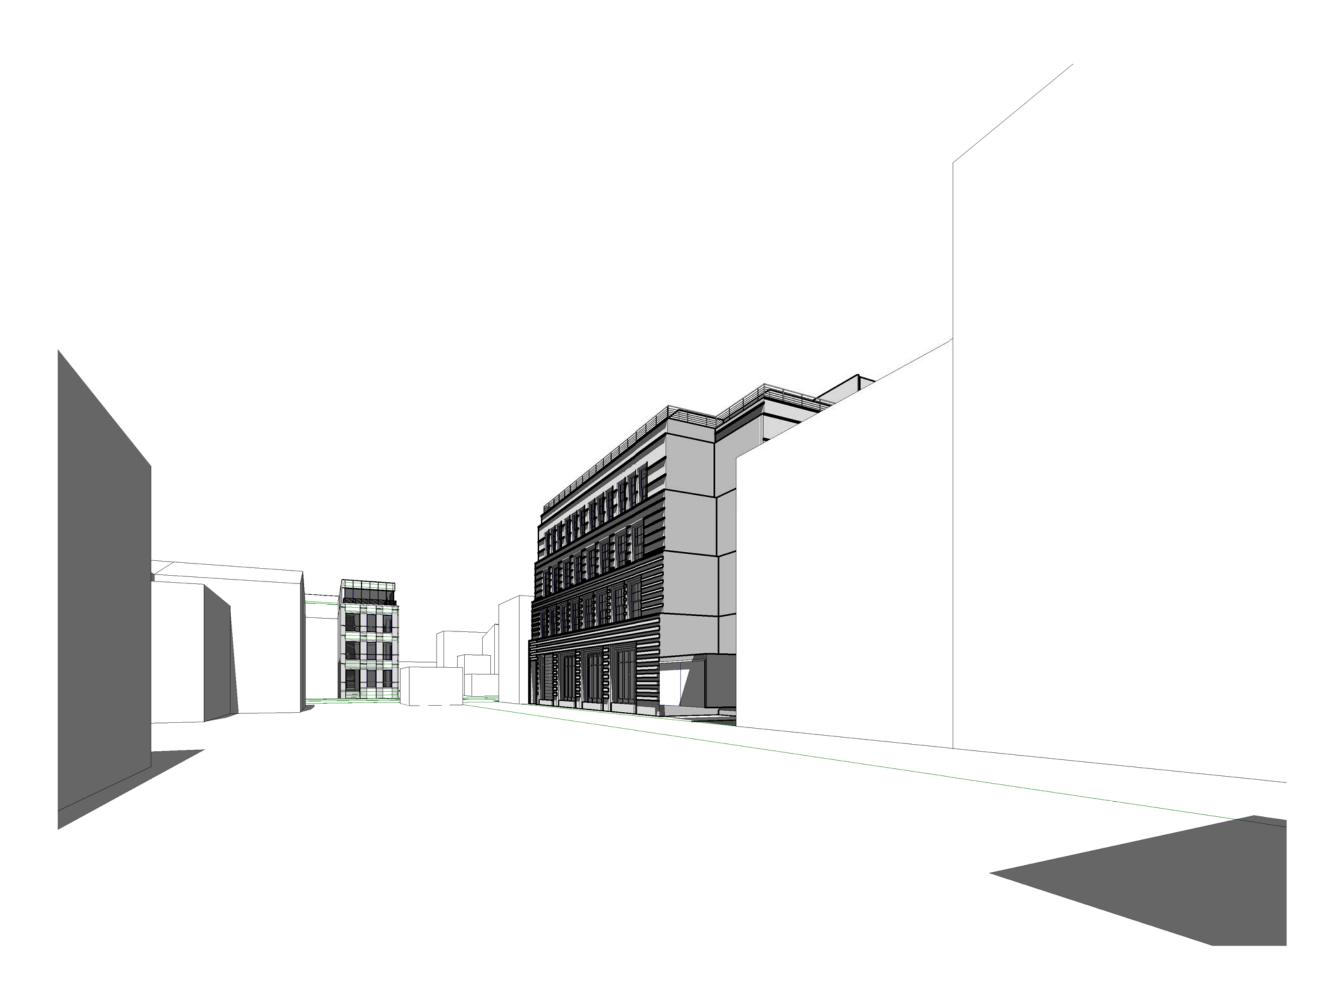
NO.	DATE	ISSUE DESCRIPTION
	12/20/2019	DSUP CONCEPT II
	12/20/2019	BAR CONCEPT I

CHECKED BY:


APPROVED	
SPECIAL USE PERMIT NO	2019-0028
DEPARTMENT OF PLANNING & ZONING	
DIRECTOR	DATE
DEPARTMENT OF TRANSPORTATION & ENVIRO	NMENTAL SERVICES
SITE PLAN NO.	
DIRECTOR	DATE
CHAIRMAN, PLANNING COMMISSION	DATE

SHEET TITLE:
MASSING STUDIES

SHEET NUMBER:




D1 STREET VIEW - FROM PUBLIC ALLEY FACING WEST

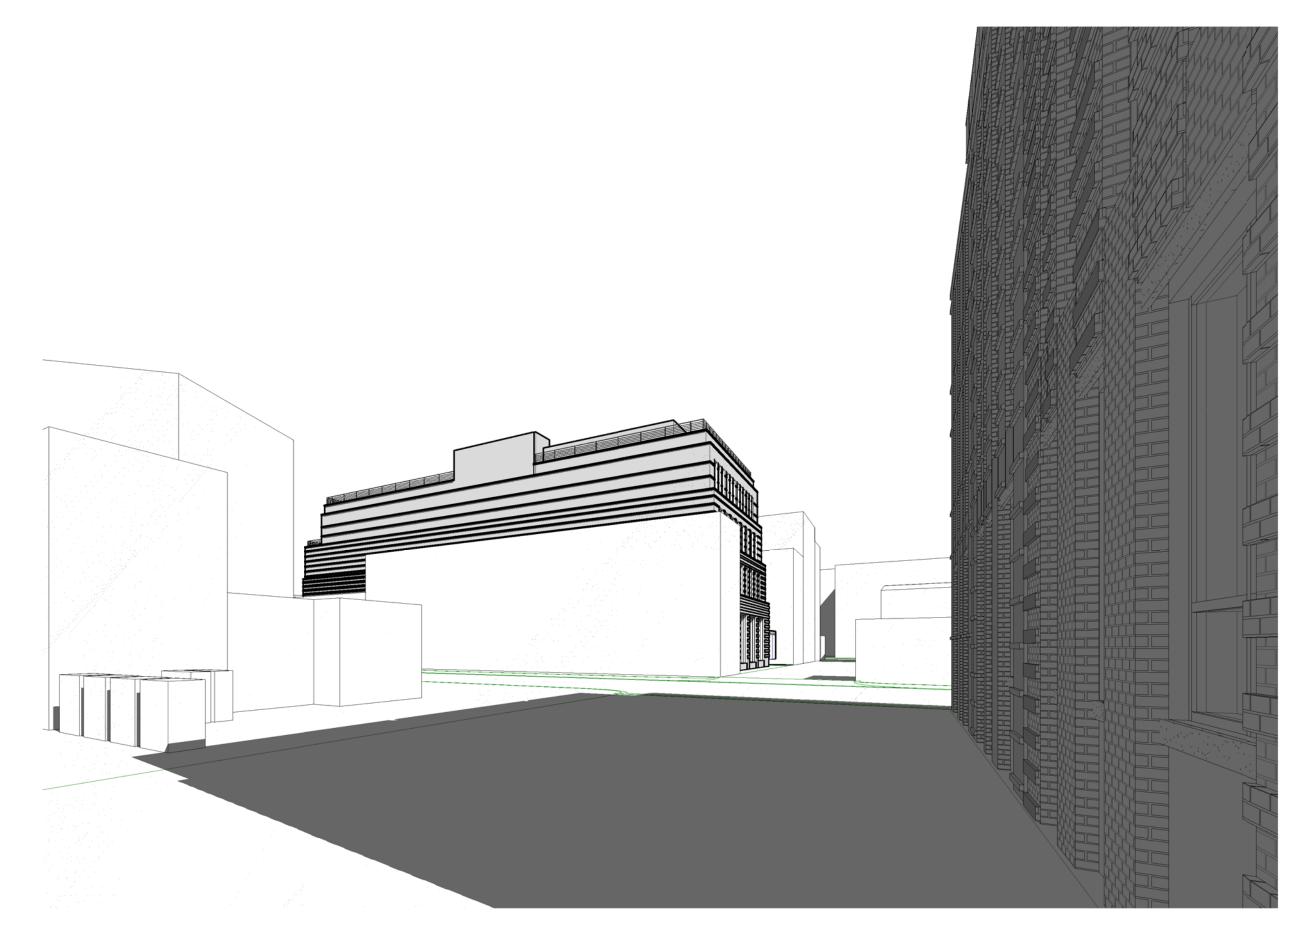

STREET VIEW - FROM DOWNHAM ALLEY FACING EAST



STREET VIEW - FROM PUBLIC ALLEY FACING WEST

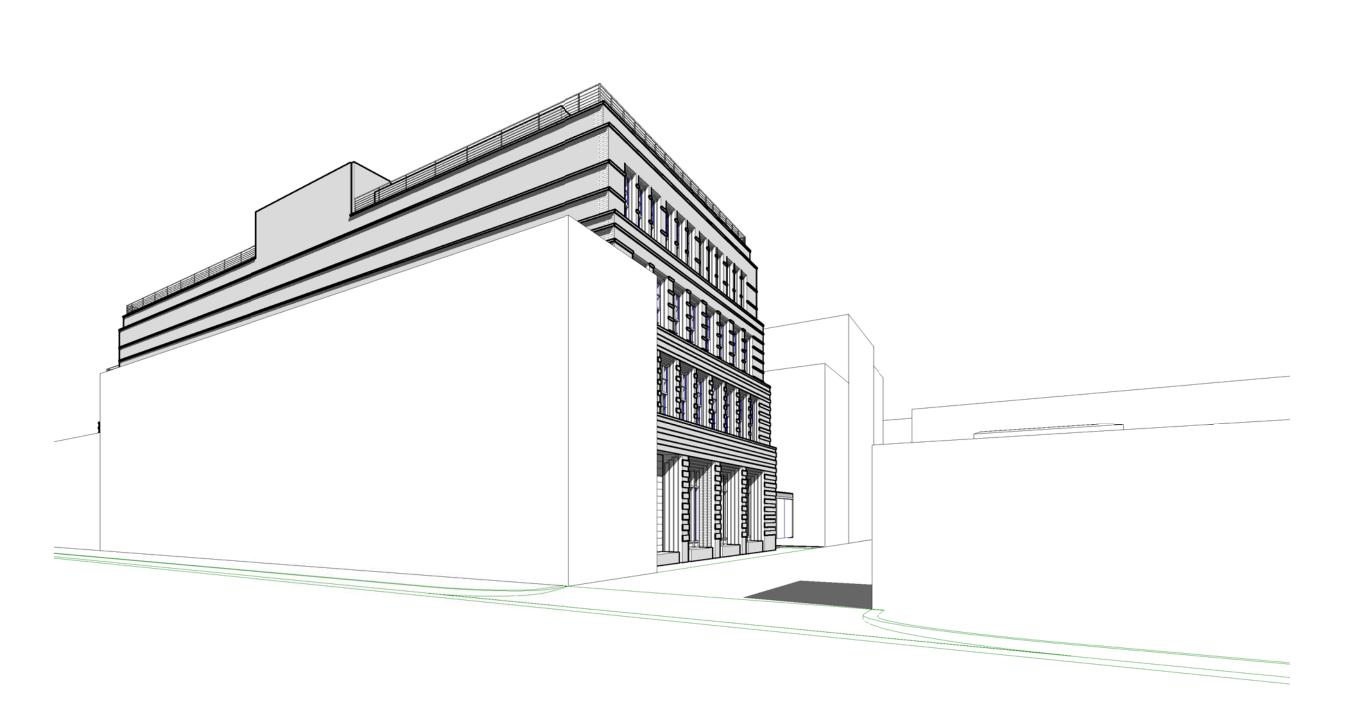

STREET VIEW - FROM CORNER OF S. PATRICK ST. & PUBLIC ALLEY FACING EAST

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REG	ISTRATION	:
NO.	DATE	ISSUE DESCRIPTION
	12/20/2019	DSUP CONCEPT II
	12/20/2019	BAR CONCEPT I

SHEET TITLE:
MASSING STUDIES

SHEET NUMBER:

912-920 KING STREET

Alexandria, VA



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PEGISTRATION:

REG	REGISTRATION:		
NO.	DATE	ISSUE DESCRIPTION	
	12/20/2019	DSUP CONCEPT II	
	12/20/2019	BAR CONCEPT I	

A/E PROJECT NO: ## - ## CHECKED BY:

APPROVED
special use permit no. 2019-0028

CHAIRMAN, PLANNING COMMISSION

DATE RECORDED INSTRUMENT NO. DEED BOOK NO. DATE

SHEET TITLE: ILLUSTRATIVE VIEW

SHEET NUMBER:

A-803

31

Original drawing is 24" x 36". Scale entities accordingly if reduced.



BAR Concept Review Policy

adopted January 2001, amended and restated December 2016

Background & Purpose

In addition to a Certificate of Appropriateness from the appropriate Board of Architectural Review (BAR), applications for development projects of a certain size are required to obtain development approvals (DSP or DSUP) from the Planning Commission and often the City Council. Because the size, footprint or design of a project may be amended during the DSP or DSUP process, a Certificate of Appropriateness is not typically granted until after the DSP or DSUP is approved. Therefore, the Boards of Architectural Review adopted a Concept Review policy in January 2001 as an optional, informal review at the beginning of the development process whereby the BAR provides the applicant, staff, Planning Commission and the City Council, with comments relating to the overall appropriateness of a project's height, mass, scale and general architectural character. The Concept Review is intended to minimize future architectural design conflicts between what is shown to the community, the Planning Commission or City Council during the development approval process and what the BAR later finds architecturally appropriate under the criteria and standards in Chapter 10 of the Zoning Ordinance and the BAR's adopted policies and Design Guidelines. The information provided by the BAR in the Concept Review will be used by the applicant, staff, Planning Commission and City Council to make decisions regarding the DSP or DSUP and as such serves as an important step in an efficient development review process. This document is an update and clarification of the policy adopted in 2001 and will serve as the current policy.

Principles

- 1. The BAR Concept Review process is encouraged but not required for any development project prior to submission of a development application to the Planning Commission and, if required, the City Council in order to ensure that each body has the information they need to make their decisions.
- 2. The Concept Review is not an approval by the BAR. If the application for the development project is approved by the Planning Commission and the City Council, then the applicant must apply for and obtain a Certificate of Appropriateness from the BAR following attainment of the DSP or DSUP.
- 3. The Concept Review will review:
 - a. The appropriateness of height, mass, scale and general architectural character based on criteria set forth in the BAR *Design Guidelines* for the historic districts.
 - b. If a project is located within the boundaries of Washington Street or the Potomac River Vicinity, the BAR will review the additional standards for these areas, to the extent possible without final architectural details.
 - c. The appropriateness of a Permit to Demolish, when one will be required for the project.
- 4. The project is discussed in an informal work session and is open to public comment. The BAR may require several work sessions and additional information before they provide comments and guidance. The BAR will then take a poll of its members on what their guidance is related to the height, mass, scale, and general architectural character of a project. They may also provide general feedback as to what additional information they would like to see when, and if, the project returns for a Certificate of Appropriateness and/or a Permit to Demolish.

- 5. As an informal work session, the applicant is strongly encouraged but not required to give public notice to adjoining property owners. Notice of the work session will be posted on the City's web page and in the BAR's preliminary docket and the property will be placarded by BAR staff as a courtesy.
- 6. The Concept Review by the BAR is advisory to the applicant, staff, the Planning Commission and the City Council, and is not intended to create vested or appealable rights.
- 7. The BAR Concept Review work session comments are shared with the Planning Commission and the City Council and may be used by those bodies for advisory purposes. The final Concept Review drawings shown to the BAR must, therefore, be the same general architectural character as submitted for the Preliminary Site Plan.

Typical Proposals Reviewed in Concept by the BAR

- When the proposal requires a DSP or DSUP for additional density or height;
- When the proposal requires Planning Commission review for a new building; and
- When staff determines that the proposal requires preliminary review because the design would be a principal determining factor in the ultimate approval by other bodies.

Concept Review Submission Materials

Three 11" x 17" hard copies and one digital copy of the following:

- 1. An architectural site plan showing, at a minimum, building footprints on the block on which the project is located and the surrounding block faces
- 2. Schematic architectural drawings which show the proposed height and scale in relation to surrounding properties
- 3. 3D digital and/or physical massing study models
- 4. Building materials, precedent images, etc., as required to explain the concept

Process

- 1. The BAR will only review projects when staff has confirmed through the Development Concept Stage 1 review process that a proposed project complies with zoning requirements or where staff supports any required modifications. When the applicant is notified that they may submit a Development Concept Stage 2 package, the applicant may also apply for BAR Concept Review work session.
- 2. The City will place the Concept Review project on the next available docket and advertise it in the newspaper with the other cases for that hearing and placard the property. Notice by the applicant to abutting property owners is strongly encouraged but is not required.
- 3. BAR staff may prepare a report which will be available on the City's web site the Friday evening prior to the BAR meeting.
- 4. BAR Concept Review requests are docketed for consideration under Other Business at a regular BAR public hearing. Additional work sessions may be requested.
- 5. The applicant is expected to make a presentation at the meeting to explain the concept.
- 6. The public will be invited to speak at the BAR meeting to receive their feedback only on issues related to the BAR's purview.