**ISSUE:** Permit to Demolish/Capsulate (partial) and Certificate of Appropriateness

for alterations

**APPLICANT:** Cambridge Property Group LLC

**LOCATION:** Old and Historic Alexandria District

411 King Street (Tavern Square)

**ZONE:** KR/King Street Retail

\_\_\_\_\_


#### **STAFF RECOMMENDATION**

Staff recommends approval of the Permit to Demolish/Capsulate (partial) and Certificate of Appropriateness with the following conditions:

- 1. The brightness of the lighting at the entrances and breezeways is subject to field inspection by staff to ensure that the lighting levels do not overwhelm the building or its neighbors.
- 2. The final color/temperature of all lighting must be warm (not cool/blue) and no greater than 3000 Kelvin.
- 3. Deferral of the rooftop deck until additional information is provided.

#### GENERAL NOTES TO THE APPLICANT

- 1. ISSUANCE OF CERTIFICATES OF APPROPRIATENESS AND PERMITS TO DEMOLISH: Applicants must obtain a copy of the Certificate of Appropriateness or Permit to Demolish PRIOR to applying for a building permit. Contact BAR Staff, Room 2100, City Hall, 703-746-3833, or preservation@alexandriava.gov for further information.
- 2. APPEAL OF DECISION: In accordance with the Zoning Ordinance, if the Board of Architectural Review denies or approves an application in whole or in part, the applicant or opponent may appeal the Board's decision to City Council on or before 14 days after the decision of the Board.
- 3. COMPLIANCE WITH BAR POLICIES: All materials must comply with the BAR's adopted policies unless otherwise specifically approved.
- 4. BUILDING PERMITS: Most projects approved by the Board of Architectural Review require the issuance of one or more construction permits by Department of Code Administration (<u>including signs</u>). The applicant is responsible for obtaining all necessary construction permits after receiving Board of Architectural Review approval. Contact Code Administration, Room 4200, City Hall, 703-746-4200 for further information.
- 5. EXPIRATION OF APPROVALS NOTE: In accordance with Sections 10-106(B) and 10-206(B) of the Zoning Ordinance, any official Board of Architectural Review approval will expire 12 months from the date of issuance if the work is not commenced and diligently and substantially pursued by the end of that 12-month period.
- 6. HISTORIC PROPERTY TAX CREDITS: Applicants performing extensive, certified rehabilitations of historic properties may separately be eligible for state and/or federal tax credits. Consult with the <u>Virginia Department of Historic Resources (VDHR)</u> prior to initiating any work to determine whether the proposed project may qualify for such credits.

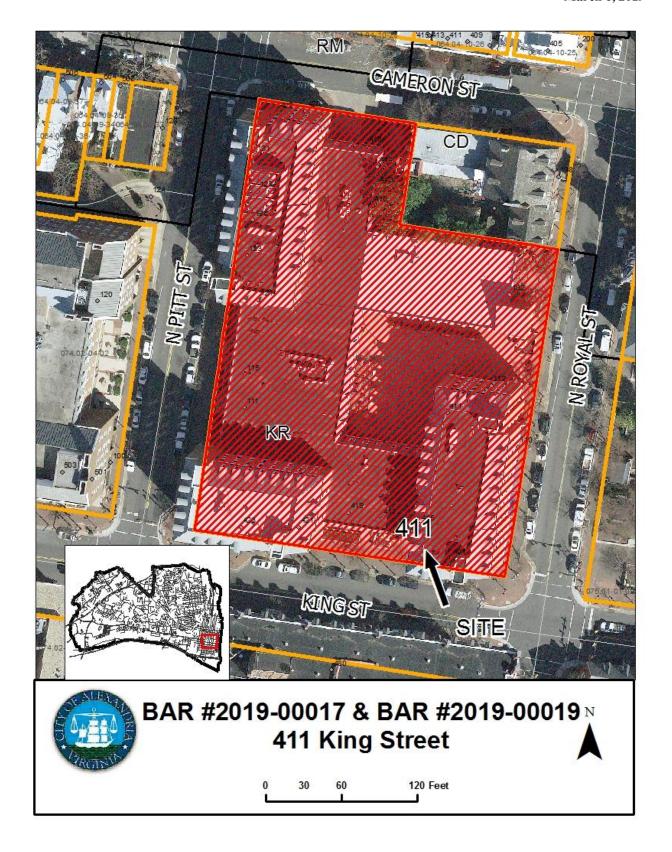

Docket #14 & 15 BAR #2019-00017 & 2019-00019 Old and Historic Alexandria District March 6, 2019

Note: Staff coupled the applications for a Permit to Demolish (BAR #2019-00017) and Certificate of Appropriateness (BAR #2019-00019) for clarity and brevity. The Permit to Demolish requires a roll call vote.

#### I. <u>APPLICANT'S PROPOSAL</u>

The applicant is requesting a Permit to Demolish/Capsulate and Certificate of Appropriateness to alter the three main entrances at Tavern Square. Although the parcel address for Tavern Square is 411 King Street, the entrance improvements will take place at 421 King Street, 123 North Pitt Street and 110 North Royal Street. The request for alterations also includes a rooftop deck on the low roof facing King Street and ceiling lighting at each entrance and each breezeway.

#### Permit to Demolish/Capsulate

Demolition is limited to the removal of three existing entrance canopies and the capsulation of a portion of the masonry wall and columns adjacent to each identified entrance.

#### Certificate of Appropriateness

Tavern Square was recently purchased by a different entity and they have developed a new branding scheme which includes updating the entrances to include new lighting and illuminating the low light breezeways which provide access to the interior courtyard.

#### Entrance improvements

The proposal for each entrance extends the new interior lobby wall panels to the exterior of the building. High pressure laminate (HPL) Trespa Phenolic panels at each entrance will be smooth (white) and graffiti resistant. Each entrance is accented by a color stripe of the same HPL material along with a new identity number graphic. At each entrance two exterior columns and the modified canopy will be capsulated with the identical white and color accented HPL material.

#### Lighting

New LED lighting is proposed for all canopies and existing breezeways. The improved lighting addresses evening safety concerns at the property. Each renovated canopy will incorporate six LED downlights. Each existing breezeway groups numerous 5' square LED illuminated acrylic panels. Final lighting levels can be adjusted on site and field inspected by staff, as typically required by the BAR.

#### Roof deck (terrace)

The proposed roof deck terrace will provide an exterior outdoor space above the King Street hyphen. The terrace is nestled between the existing rooftop mechanical equipment and existing King Street parapet wall. The addition of this exterior space will add a festive refuge from the second-floor office space. Bounded by a glazed perimeter railing and shaded by a wood pergola this new outdoor area is designed to be minimally visible from street level. The roof deck railing

will not be visible due to the existing parapet height, A small portion of the pergola will likely be visible from King Street.

#### II. HISTORY

Tavern Square consists of two-to-five story connected brick buildings built around a central open courtyard that is accessible from all four sides of the block bounded by King Street, North Pitt Street, Cameron Street and North Royal Street. It was constructed in **1967** as part of Phase I of the Gadsby Urban Renewal Project and was designed by the local architectural firm of Vosbeck and Vosbeck. While the overall architectural character of Tavern Square is firmly within the pattern of 1960's urban renewal architecture, it does make use of traditional building materials with brick, standing seam metal roofing, punched window openings, and uses contemporary, if over-scaled, interpretations of various historic Alexandria building forms. Over the years, the Board has approved several alterations at the Tavern Square complex. In addition to multiple sign requests, the BAR has approved the following:

- 1999-2000 Redesign of the courtyard and alterations to retail spaces at former Pat Troy's restaurant on North Pitt Street and Weichert Realtors space on North Royal Street (BAR Case #99-0028, 9/20/00 and 11/1/00 BAR Case #2001-0176, 7/18/01)
- 2001 Storefront alterations at 401 King Street (BAR Case # 2008-0233 & BAR Case #2001-0137, 1/16/02)
- 2002 Storefront alterations at 110 North Royal Street to match adjacent alterations from 2001 (BAR Case #2002-0312, 1/15/02)
- 2005 Replacement of storefronts/entrances located throughout the building (BAR Case #2005-0261, 12/7/05)
- 2008 Replacement of the storefronts/lobby entrances located at 421 King Street, 123 North Pitt Street, and 130/132 North Royal Street to match those approved in 2002.
- 2009 Replacement garage doors on Cameron Street elevation (BAR Case #2009-00030, April 1, 2009)
- 2011 Storefront replacement on North Pitt Street elevation (BAR Case #2011-00150, 7/6/11)
- 2015 Alterations (awnings, storefront, signage for BurgerFi) at 111 North Pitt Street (BAR Case #2015-00299, 10/7/15)
- 2018 Storefront alterations at 417 King Street for Taco Bell (BAR Case #2017-0435 and #2010-0156 4/18/18)

#### III. ANALYSIS

Permit to Demolish/Capsulate

In considering a Permit to Demolish/Capsulate, the Board must consider the following criteria set forth in the Zoning Ordinance, §10-105(B), which relate only to the subject property and not to neighboring properties. The Board has purview of the proposed demolition/capsulation regardless of visibility.

Standard	Description of Standard	Standard Met?
(1)	(1) Is the building or structure of such architectural or historical interest that its moving, removing, capsulating or razing would be to the detriment of the public interest?	
(2)	Is the building or structure of such interest that it could be made into a historic shrine?	No
(3)	Is the building or structure of such old and unusual or uncommon design, texture and material that it could not be reproduced or be reproduced only with great difficulty?	No
(4)	Would retention of the building or structure help preserve the memorial character of the George Washington Memorial Parkway?	N/A
(5)	Would retention of the building or structure help preserve and protect an historic place or area of historic interest in the city?	No

The area of demolition/capsulation is minimal, does not exhibit a high level of design or architectural detail and uses modern materials that could be reproduced easily. In the opinion of Staff, none of the criteria are met and the Permit to Demolish should be granted.

#### **Certificate of Appropriateness**

Staff is supportive of the alterations to the building, noting the need for appropriate lighting temperature/color and intensity levels. Staff has concerns about the visibility of the pergola on the roof deck and will need additional information to be provided. At this time Staff recommends approval of the entrance improvements and breezeway lighting with deferral of the roof deck until the additional requested documentation can be reviewed.

#### Storefront entrance improvements

When the Old and Historic Alexandria District was established in 1946, 20 years before Tavern Square was constructed, it was not created to freeze Old Town Alexandria at a specific point in time, the way Colonial Williamsburg is often described, but to prevent the demolition of identified historic resources and insure that background projects were compatible with nearby buildings of historic merit. Unfortunately, many historic buildings were demolished to construct Tavern Square, and the building was likely designed to recall some of the historic architectural styles in Old Town, albeit at a much exaggerated and enlarged scale. The BAR's Standards and criteria in the zoning ordinance (Section 10-105), as well as the BAR's adopted policies and *Design Guidelines*, recognize that the historic fabric of Old Town may be modified, altered and expanded to accommodate contemporary needs and to allow the historic buildings to continue to be used and cherished. The BAR's adopted *Design Guidelines* note that the "guidelines should not be viewed as a device that dictates a specific design response nor should the guidelines be viewed as

prohibiting a particular design approach." With the exception of retail storefront updates in the 2000's, the original late 1960's era Tavern Square buildings remain largely intact. While it could be argued the urban renewal projects of the late 1960's deserve protection in their own right, no local movement has gained traction to do so. In general, the 60's urban renewal period of architecture is widely considered having done more harm than good to the urban social, architectural and cultural environment. Given this, the Tavern Square development does allow for a wide latitude of design improvements. Staff believes that the entrance improvements will be a modest but welcome addition and update to the King, North Royal and North Pitt Street facades.



Figure 1: King Street entrance



Figure 2: Pitt Street entrance



Figure 3: Royal Street entrance *Lighting* 

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The BAR's general direction to staff in recent years regarding architectural, or building lighting is that the quantity of fixtures, the color of the light, the cumulative number of fixtures and overall brightness should not overwhelm the building or its neighbors on the block and that the brightness of the lighting should not be used as a *sign* for the business.

New lighting is included in both the entrance canopies and the breezeways. The canopy entrance lighting will be like the existing downlighting but updated with modern LED technology. While the proposed breezeway lighting as indicated at night has the potential to overwhelm the covered spaces, staff believes coordination on this issue could easily mitigate any overwhelming lighting issues. Modern LED lighting is dimmable. To achieve this, the on-site lighting levels should be field adjusted as necessary, in consultation with staff.

The issue of the color, or temperature, of LED lights has also been discussed by the BAR in the past few years as these energy efficient bulbs have become more popular and the consensus has been that the color of the LED lighting should be warmer (yellow) rather than cooler (blue) and have a temperature measuring no greater than 4000 Kelvin, with 3000 Kelvin strongly preferred. Based on staff's recent experience with the replacement Gadsby street lights, the warmer light colors are now more widely available than they were several years ago, and all the new City street lights are expected to be 3000K, as requested by the BAR.

#### Roof Deck (Terrace)

The *Design Guidelines* state that "roof decks should be constructed so that they do not interfere with the historic roofline of a building" and "material should not be used on a roof deck that detracts from the historic architecture of a structure". Given that the terrace will be constructed on the King Street hyphen and will be behind a significant parapet, only a portion of the pergola will be visible from King Street. Staff believes that the pergola should not be visible at all from King Street and recommends that the projection of the canopy be reduced so that it is not visible. This can likely be achieved by reducing the projection by approximately 2 feet. To mitigate the loss of projection, staff has no objection to extending the pergola the full width of the roof deck or making the pergola solid – both alterations would help to screen the outdoor space from the unsightly rooftop mechanical units. Along with missing information on the pergola materials and details, the size and type of exit egress and doors required for the terrace is not documented. The *Design Guidelines* state removal of 25 or more square feet of exterior wall area requires a separate Permit to Demolish. Due to insufficient information provided on the terrace staff recommends deferral for the roof deck terrace portion of the submission until more information is provided.

As noted in the zoning comments below, the applicant must seek approval of a Minor Site Plan amendment prior to issuance of a building permit for the proposed roof deck.

Staff generally supports the application, with deferral of the roof deck and the additional conditions noted above.

#### **STAFF**

Stephanie Sample, Historic Preservation Planner, Planning & Zoning Al Cox, FAIA, Historic Preservation Manager, Planning & Zoning

#### IV. <u>CITY DEPARTMENT COMMENTS</u>

Legend: C- code requirement R- recommendation S- suggestion F- finding

#### **Zoning**

- C-1 Proposed alterations will require a minor site plan amendment. (SIT65-0035)
- C-2 Applicant should clarify the exact location of the roof deck and include elevations of roof deck to include overall height from grade. Pergola must be 80% open or it must be included in FAR. Indicate the height of the proposed "wood slat screen".
- C-3 Applicant must submit FAR calculations and existing and proposed drawings to scale to show the dimensions of the existing and proposed covered entry areas. FAR

#### **Code Administration**

C-1 A building permit, plan review and inspections are required prior to the start of construction.

#### **Transportation and Environmental Services**

- R-1 The building permit must be approved and issued prior to the issuance of any permit for demolition, if a separate demolition permit is required. (T&ES)
- R-2 Applicant shall be responsible for repairs to the adjacent city right-of-way if damaged during construction activity. (T&ES)
- R-3 No permanent structure may be constructed over any existing private and/or public utility easements. It is the responsibility of the applicant to identify any and all existing easements on the plan. (T&ES)
- F-1 A minor site plan amendment (SIT65-0035) will be required for the rooftop deck. T&ES)
- C-1 The applicant shall comply with the City of Alexandria's Solid Waste Control, Title 5, Chapter 1, which sets forth the requirements for the recycling of materials (Sec. 5-1-99). (T&ES)
- C-2 The applicant shall comply with the City of Alexandria's Noise Control Code, Title 11, Chapter 5, which sets the maximum permissible noise level as measured at the property line. (T&ES)

- C-3 Roof, surface and sub-surface drains be connected to the public storm sewer system, if available, by continuous underground pipe. Where storm sewer is not available applicant must provide a design to mitigate impact of stormwater drainage onto adjacent properties and to the satisfaction of the Director of Transportation & Environmental Services. (Sec.5-6-224) (T&ES)
- C-4 All secondary utilities serving this site shall be placed underground. (Sec. 5-3-3) (T&ES)
- C-5 Any work within the right-of-way requires a separate permit from T&ES. (Sec. 5-2) (T&ES)
- C-6 All improvements to the city right-of-way such as curbing, sidewalk, driveway aprons, etc. must be city standard design. (Sec. 5-2-1) (T&ES)
- C-7 An encroachment request will be required for projections into the public right of way. (T&ES)
- C-8 The owner shall obtain and maintain a policy of general liability insurance in the amount of \$1,000,000 which will indemnify the owner (and all successors in interest); and the City as an Additional Insured, against claims, demands, suits and related costs, including attorneys' fees, arising from any bodily injury or property damage which may occur as a result of the encroachment. (Sec. 5-29 (h)(1)) (T&ES)

Please submit Insurance Certificate: City of Alexandria T&ES Attn: Heather Diez 301 King Street, Room 4130 Alexandria, VA 22314

#### Alexandria Archaeology

F-1 No archaeological oversight necessary for this project.

#### V. ATTACHMENTS

1 – Supplemental Materials

2 - Application for BAR 2019-00017& 00019: 411 King Street

ADDRESS OF PROJECT: All KING ST.
TAX MAP AND PARCEL: 074.03-05-01 ZONING: KR
APPLICATION FOR: (Please check all that apply)
☑ CERTIFICATE OF APPROPRIATENESS
PERMIT TO MOVE, REMOVE, ENCAPSULATE OR DEMOLISH (Required if more than 25 square feet of a structure is to be demolished/impacted)
WAIVER OF VISION CLEARANCE REQUIREMENT and/or YARD REQUIREMENTS IN A VISION CLEARANCE AREA (Section 7-802, Alexandria 1992 Zoning Ordinance)
WAIVER OF ROOFTOP HVAC SCREENING REQUIREMENT (Section 6-403(B)(3), Alexandria 1992 Zoning Ordinance)
Applicant:  Property Owner Business (Please provide business name & contact person)
Name: CAMBRIGGE PROPERTY GROUP LLC
Address: 8391 OLD COURTHOUSE PD, STEZIO
City: VIENNA State: VA Zip: 22182
Phone: 703.709.8866 E-mail: b.eldridge @ cambridge us.com
Authorized Agent (if applicable): Attorney Architect
Name: GABRIELA FATUSIAK Phone: 571.424.1907
E-mail: Katusake parersbrown.com
Legal Property Owner:
Name: WY TAVERN SOLVANE VENTURE LLC
Address: 8391 OLD COURTHOUSE RD, STE 210
City: VENNA State: VA Zip: 22182
Phone: 703. 709.8866 E-mail: <u>b.eldvidge@com</u> bridgeus.com
Yes No Is there an historic preservation easement on this property?  Yes No If yes, has the easement holder agreed to the proposed alterations?  Is there a homeowner's association for this property?  No If yes, has the homeowner's association approved the proposed alterations?

BAR Case # \_\_\_\_\_\_

If you answered yes to any of the above, please attach a copy of the letter approving the project.

	BAIT Guse ii
NATURE OF PROPOSED WORK: Please check all that apply	
NEW CONSTRUCTION  EXTERIOR ALTERATION: Please check all that apply.  awning fence, gate or garden wall HVAC  doors windows siding  flighting pergola/trellis painting  other faterace carries reconstruction  ADDITION  DEMOLITION/ENCAPSULATION  SIGNAGE	shed ng unpainted masonry
<b>DESCRIPTION OF PROPOSED WORK:</b> Please describe the be attached).	proposed work in detail (Additional pages may
INTERIOR LOBBY RENOVATION MANTAIN	WING EXISTING STOKETPOINT
removal of existing early time	ISHES; RECONFIGURATION
& RECLAPDING OF ENTRANCE SOM	T/CANOPY
REMOVAL OF EXISTING BREEZEWA WITH NEW IMMINATED PANEL	LY MAHILIMY AND BEPLACEMENT
EXTERIOR TEXENCE ADDITION AT ZON	Prook Roof Level
SUBMITTAL REQUIREMENTS:	
Items listed below comprise the <b>minimum supporting materials</b> request additional information during application review. Please Design Guidelines for further information on appropriate treatments	refer to the relevant section of the
Applicants must use the checklist below to ensure the application material that are necessary to thoroughly describe the project. In docketing of the application for review. Pre-application meetings All applicants are encouraged to meet with staff prior to submission	complete applications will delay the are required for all proposed additions.
Electronic copies of submission materials should be submitted wh	nenever possible.
<b>Demolition/Encapsulation :</b> All applicants requesting 25 square must complete this section. Check N/A if an item in this section does not	
N/A Survey plat showing the extent of the proposed demolition Existing elevation drawings clearly showing all elements possible. Clear and labeled photographs of all elevations of the built to be demolished. Description of the reason for demolition/encapsulation. Description of the alternatives to demolition/encapsulation considered feasible.	proposed for demolition/encapsulation.  Iding if the entire structure is proposed

BAR	Case	#	

requested by staff for large-scale development projects or projects fronting Washington Street. Check N/A if an item in this section does not apply to your project. Scaled survey plat showing dimensions of lot and location of existing building and other structures on the lot, location of proposed structure or addition, dimensions of existing structure(s), proposed addition or new construction, and all exterior, ground and roof mounted equipment. FAR & Open Space calculation form. Clear and labeled photographs of the site, surrounding properties and existing structures, if applicable. Existing elevations must be scaled and include dimensions. Proposed elevations must be scaled and include dimensions. Include the relationship to adjacent structures in plan and elevations. Materials and colors to be used must be specified and delineated on the drawings. Actual samples may be provided or required. Manufacturer's specifications for materials to include, but not limited to: roofing, siding, windows, doors, lighting, fencing, HVAC equipment and walls. For development site plan projects, a model showing mass relationships to adjacent properties and structures. Signs & Awnings: One sign per building under one square foot does not require BAR approval unless illuminated. All other signs including window signs require BAR approval. Check N/A if an item in this section does not apply to your project. N/A X Linear feet of building: Front: Secondary front (if corner lot): Square feet of existing signs to remain:

Photograph of building showing existing conditions. Dimensioned drawings of proposed sign identifying materials, color, lettering style and text. Location of sign (show exact location on building including the height above sidewalk).

Means of attachment (drawing or manufacturer's cut sheet of bracket if applicable). Description of lighting (if applicable). Include manufacturer's cut sheet for any new lighting fixtures and information detailing how it will be attached to the building's facade. Alterations: Check N/A if an item in this section does not apply to your project. Clear and labeled photographs of the site, especially the area being impacted by the alterations, all sides of the building and any pertinent details. Manufacturer's specifications for materials to include, but not limited to: roofing, siding, windows, doors, lighting, fencing, HVAC equipment and walls. Drawings accurately representing the changes to the proposed structure, including materials and overall dimensions. Drawings must be to scale. An official survey plat showing the proposed locations of HVAC units, fences, and sheds. Historic elevations or photographs should accompany any request to return a structure to an earlier appearance.

Additions & New Construction: Drawings must be to scale and should not exceed 11" x 17" unless approved by staff. All plans must be folded and collated into 3 complete 8 1/2" x 11" sets. Additional copies may be

BAR Case #
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#### ALL APPLICATIONS: Please read and check that you have read and understand the following items:

X	I have submitted a filing fee with this application. (Checks should be made payable to the City of Alexandria. Please contact staff for assistance in determining the appropriate fee.)
	Alexandria. Please contact staff for assistance in determining the appropriate fee.)

X	I understand the notice requirements and will return a copy of the three respective notice forms to
′	BAR staff at least five days prior to the hearing. If I am unsure to whom I should send notice I wil
	contact Planning and Zoning staff for assistance in identifying adjacent parcels.

$\boxtimes$	I, the applicant,	or an authorized	representative will be	present at the	public hearing
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I understand that any revisions to this initial application submission (including applications deferred
for restudy) must be accompanied by the BAR Supplemental form and 3 sets of revised materials.

The undersigned hereby attests that all of the information herein provided including the site plan, building elevations, prospective drawings of the project, and written descriptive information are true, correct and accurate. The undersigned further understands that, should such information be found incorrect, any action taken by the Board based on such information may be invalidated. The undersigned also hereby grants the City of Alexandria permission to post placard notice as required by Article XI, Division A, Section 11-301(B) of the 1992 Alexandria City Zoning Ordinance, on the property which is the subject of this application. The undersigned also hereby authorizes the City staff and members of the BAR to inspect this site as necessary in the course of research and evaluating the application. The applicant, if other than the property owner, also attests that he/she has obtained permission from the property owner to make this application.

#### **APPLICANT OR AUTHORIZED AGENT:**

Signature: <u>Salniela Katusak</u>

Printed Name: Gabriela Katusak

Date: 01/22/19

## OWNERSHIP AND DISCLOSURE STATEMENT Use additional sheets if necessary

1. Applicant. State the name, address and percent of ownership of any person or entity owning an interest in the applicant, unless the entity is a corporation or partnership, in which case identify each owner of more than ten percent. The term ownership interest shall include any legal or equitable interest held at the time of the application in the real property which is the subject of the application.

Name	_Address	Percent of Ownership
1. TODORED Alexandria	257 Riverside Aug #2, Westport, CT about	90%
2 Galaxy Tavern	0391 OLD COURTHOUSE RD, SUF 210 Vienna, VA	20%
3.	22,82	

2. <u>Property.</u> State the name, address and percent of ownership of any person or entity owning an interest in the property located at <u>ASCE VEVO</u> (address), unless the entity is a corporation or partnership, in which case identify each owner of more than ten percent. The term ownership interest shall include any legal or equitable interest held at the time of the application in the real property which is the subject of the application.

Name	Address	Percent of Ownership
1. Alexandria Tavern 80 vare UC.	257 RIVERSIDE AVE #3 WESTOWN, CT 06880	පිර%
2-Galaxy Tavem sover uc	8391 Old Courthouse Pd., suite 210. Vionna, VA	20°L
3.	22/82	

3. Business or Financial Relationships. Each person or entity listed above (1 and 2), with an ownership interest in the applicant or in the subject property is required to disclose **any** business or financial relationship, as defined by Section 11-350 of the Zoning Ordinance, existing at the time of this application, or within the12-month period prior to the submission of this application with any member of the Alexandria City Council, Planning Commission, Board of Zoning Appeals or either Boards of Architectural Review.

Name of person or entity	Relationship as defined by Section 11-350 of the Zoning Ordinance	Member of the Approving Body (i.e. City Council, Planning Commission, etc.)
1. Alexandria Tavern Sovare UC.	257 RIVERSIDE AVE #3, WESTOUR, (I OLOBBO	n/n
2. Galaxy Tavers	8391 Old Courthouse Rd suite 210. Vionna, VA	n/n
3.	22/82	•

NOTE: Business or financial relationships of the type described in Sec. 11-350 that arise after the filing of this application and before each public hearing must be disclosed prior to the public hearings.

As the applicant or the applicant's authorized agent, I hereby attest to the best of my ability that the information provided above is true and correct.

Date Printed Name Signature

\* 123 N Pitt Street \* 421 King Street \* 110 N ROYAL STREET



# Department of Planning and Zoning Floor Area Ratio and Open Space Calculations

A.	Property Info	rmation						
<b>A</b> 1.	411 King Street, A Street Address	Alexandria, VA					CL Zon	e
A2.	79,713.00 Total Lot Area		x	2.50 Floor Area Ratio A	llowed by Zone	=		282.50 imum Allowable Floor Area
В.	S. Existing Gross Floor Area <u>Existing Gross Area</u>			Allowable Exclu	sions**			
	Basement	71,450.00		Basement**	71,450.00		B1.	212,418.00 Sq. Ft.
	First Floor	58,176.00		Stairways**	6,055.00			Existing Gross Floor Area*
	Second Floor	56,762.00		Mechanical**	226.00		B2.	
	Third Floor	26,030.00		Attic less than 7'**				Allowable Floor Exclusions**  131,736.00
	Attic	0.00		Porches**			B3.	Sq. Ft. Existing Floor Area Minus Exclusions
	Porches	0.00		Balcony/Deck**				(subtract B2 from B1)
	Balcony/Deck	0.00		Lavatory***	2,951.00		Cor	nments for Existing Gross Floor Area
	Lavatory***			Other**				
	Other**			Other**				
B1.	Total Gross	212,418.00	B2.	Total Exclusions	80,682.00			
C.	Proposed Gross Proposed Gross Basement First Floor Second Floor Third Floor Attic Porches Balcony/Deck Lavatory***	0.00 0.00 0.00 690.00		Allowable Exclusion Basement** Stairways** Mechanical** Attic less than 7'** Porches** Balcony/Deck** Lavatory*** Other**			C1. C2.	769.00 Sq. Ft. Proposed Gross Floor Area*  0.00 Sq. Ft. Allowable Floor Exclusions**  769.00 Sq. Ft. Proposed Floor Area Minus Exclusions (subtract C2 from C1)
	Other	79.00		Other**				Notes
C1.	Total Gross	769.00	C2.	Total Exclusions	0.00			*Gross floor area is the sum of <u>all areas</u> <u>under roof of a lot</u> , measured from the face
D.	D. Total Floor Area			E. Open Spa	ce			of exterior walls, including basements, garages, sheds, gazebos, guest buildings and other accessory buildings.
D1.	D1. 132,505.00 Sq. Ft. Total Floor Area (add B3 and C3)			E1. 21,537.00 Existing Ope	Sq. Space	Ft.		** Refer to the Zoning Ordinance (Section 2-145(B)) and consult with Zoning Staff for information regarding allowable exclusions.  Sections may also be required for some
D2.	199,282.50	Sq. Ft.		E2.	Sq.	Ft.		exclusions.
	Total Floor Area by Zone (A2)	Allowed		Required Op E3. 690.00 Proposed O	Sq.	Ft.		***Lavatories may be excluded up to a maximum of 50 square feet, per lavatory.  The maximum total of excludable area for lavatories shall be no greater than 10% of gross floor area.

The undersigned hereby certifies and attests that, to the best of his/her knowledge, the above computations are true and correct. 16



DESCRIPTION OF THE REASON FOR DEMOLITION:

FINISH UPGRADES ON EXTERIOR EXTRANCE, INCLUDING CANOPY AND ASSOCIATED LIGHTING. THE ADDRESS DOWN THE FACADE OF BUILDING AND COLOR BAND WILL HELP ESTABLISH A VISUAL ENTRY INTO BUILDING AND IMPROVE WAYFINDING FROM THE PARKING GARAGE. MATERIALS ARE GRAFFITI RESISTANT. NEW ENTRY LIGHITING WILL PROVIDE SAFETY.



PROPOSED RENDERINGS - MAIN ENTRANCE



PROJECT TITLE

powers

brown

archit

ecture

Tavern Square - Lobby

421 King Street Alexandria, VA 22314

150 S. Washington St., Suite 300

703.962.6643 703.962.6644 fax

Falls Church, VA 22046

www.powersbrown.com


A PROJECT FOR


Cambridge Property Group

GENERAL NOTES

NEW CANOPY: 236 SF

AMOUNT OF ADDITIONAL COVERAGE 225 SF - 199 SF = 26 SF

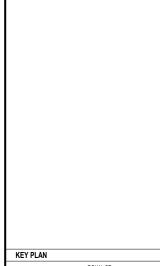

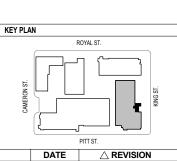

201-01-21	ISSUE FOR BOARD REVIEW

PROJECT NO: 182032 DRAWN BY: GK CHECKED BY: ES

SHEET TITLE


ARCHITECTURAL **REVIEW** 


SHEET NUMBER A001






**EXISTING PHOTOGRAPHS - SITE** 

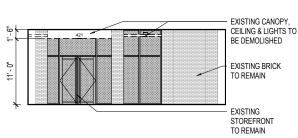

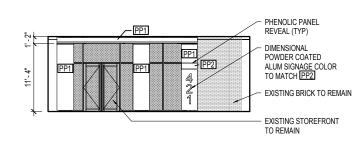


(B1) EXISTING ELEVATION - ELEMENTS PROPOSED FOR DEMO (B2) ELEVATION - PROPOSED CONSTRUCTION SCALE: 1/16" = 1'-0"

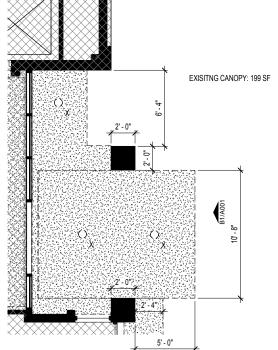

DEMOLITION REFLECTED CEILING PLAN - EXTERIOR LOBBY

# TRESPA PHENOLIC INSTALL

TRESPA PHENOLIC COLORS

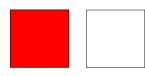


MATERIALS AND COLORS

## **EXTERIOR FINISH SCHEDULE**

1	CODE	MATERIAL	MANUFACTURER	DESCRIPTION	COLOR	DEALER	REP NAME	CONTACT NO	REMARKS
+					•	'			
1	PP1	WALL PANEL	TRESPA	METEON LUMEN PENOLIC WALL PANELS IN SPECULAR FINISH; L05.0.0	ATHENS WHITE	TRESPA	CHRISTIAN COLE	919.356.7082	
	PP2	WALL PANEL	TRESPA	METEON EXTERIOR PENOLIC PANELS IN SPECULAR FINISH; A12.1.8/ST	PASSION RED	TRESPA	CHRISTIAN COLE	919.356.7082	ACCENT BAND

### LIGHT FIXTURE SCHEDULE

CODE	TYPE	MANUFACTURER	SPECIFICATION	REMARKS
K	SQUARE LED DOWNLIGHT	PATHWAY LIGHTING	MODEL: 504KE2LDANF-SCL	PROVIDE WET RATED VERSION FOR ALL EXTERIOR FIXTURES
L	LINEAR RECESSED		MODEL: OPRS GB LOP CANT SEE PLAN 90CRI 40K 800LMF DARK ZT 277 SCT C041 CFG	PROVIDE WET RATED VERSION FOR ALL EXTERIOR FIXTURES
М	LED STRIP	FILIX	MODEL: LI 20 CONTINUOUS L 40RGB 120 24 DIM	SPACE EVERY 10" O.C. TO PROVIDE CONTINUOUS PATTERN OF LIGHT

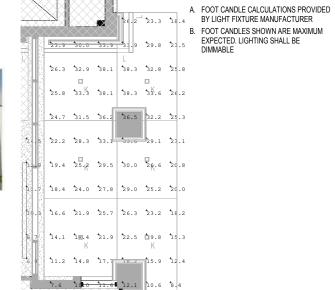


REFLECTED CEILING PLAN - EXTÉRIOR LOBBY

11'-4"

17

**REFLECTED CEILING PLAN - PHOTOMETRICS** 

С

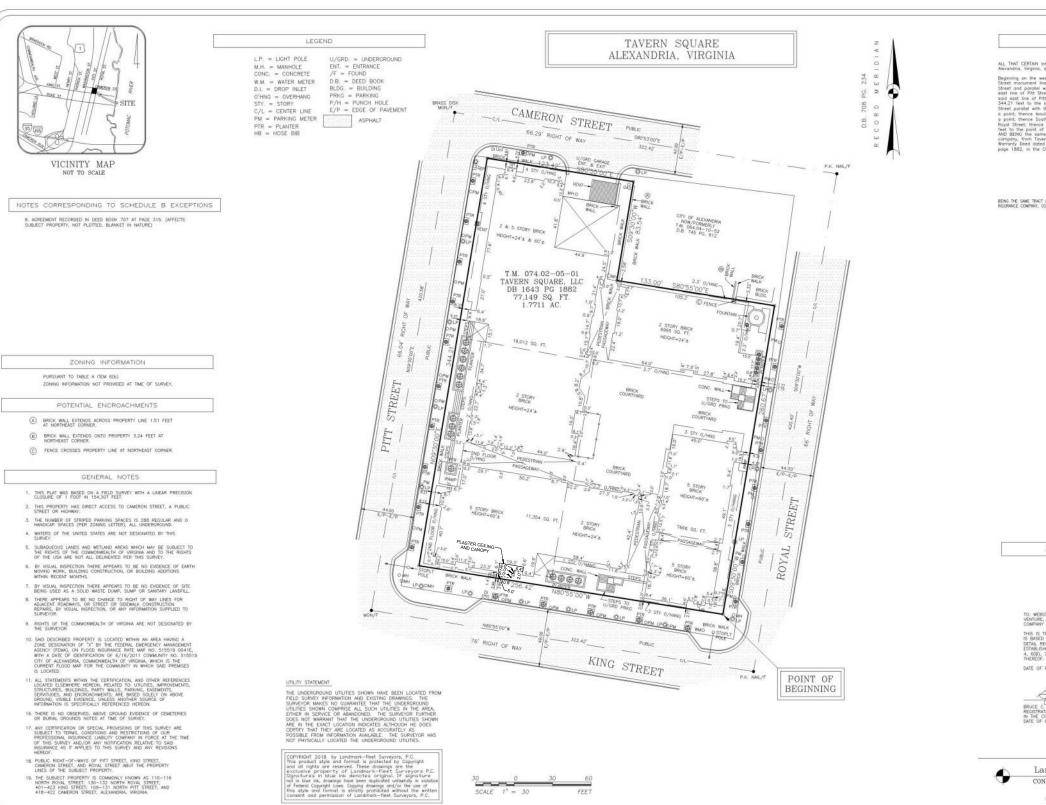

LEGAL DESCRIPTION

BEING THE SAME TRACT OF LAND DESCRIBED IN A TITLE REPORT PREPARED BY FIDELITY NATIONAL TITLE INSURANCE COMPANY, COMMITMENT NO. 192903435, DATED MAY 1, 2018 AT 8:00 A.M.

ALTA / NSPS LAND TITLE SURVEY

TAVERN SQUARE

SURVEYOR'S CERTIFICATION

TO: WEBSTER BANK, NATIONAL ASSOCIATE, AS LENDER, WG TAYERN SOLIARE VENTURE, LLC, AS BORROWER, AND FIDELITY NATIONAL TITLE INSURANCE COMPANY, AS TITLE COMPANY.

THIS IS TO CERTIFY THAT THIS MAP OF PLAT AND THE SUPPLY ON MINICH IT IS SECTO WISE MORE IN ACCORDANCE WITH THE COTO MINIMUM STANDARD DETAL REQUIREMENTS FOR ALTA/MOPS LAND THILE SUMMYNS, JOHNTY ESTABLENCO MO ADOPTICE BY ALTA AND MOPS, AND SOLUCES THEM 2, 3, 4, 6(8), 7(a), 7(c), 8, 9, 13, 14, 16, 17, 18, AND 2010 OF TABLE A THEREOT. THE PLOT WORK MAS COMPLETED IN APPL. 30, 2018.

DATE OF PLAT OR MAP: MAY 9, 2018



Landmark-fleet Surveyors, P.C. CONSULTING • LAND SURVEYORS • PLANNERS
8014 Midlothian Turngible Suite 103
Richmond, Verginia 23235
Phone (804)327-0333 Fax (804)330-5558

JOB NO. 24126 (REF 22222) SHEET 1 of 3

ARCHITECTURAL **REVIEW** 

PROJECT NO: 182032

DRAWN BY: GK

CHECKED BY: ES SHEET TITLE

DATE

201-01-21 ISSUE FOR BOARD REVIEW

SEAL SHEET NUMBER

A002

18

421 King Street Alexandria, VA 22314

powers

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archit

ecture

PROJECT TITLE

A PROJECT FOR Cambridge Property Group

Tavern Square - Lobby


150 S. Washington St.,

Suite 300 Falls Church, VA 22046

703 962 6643

703.962.6644 fax www.powersbrown.com

GENERAL NOTES

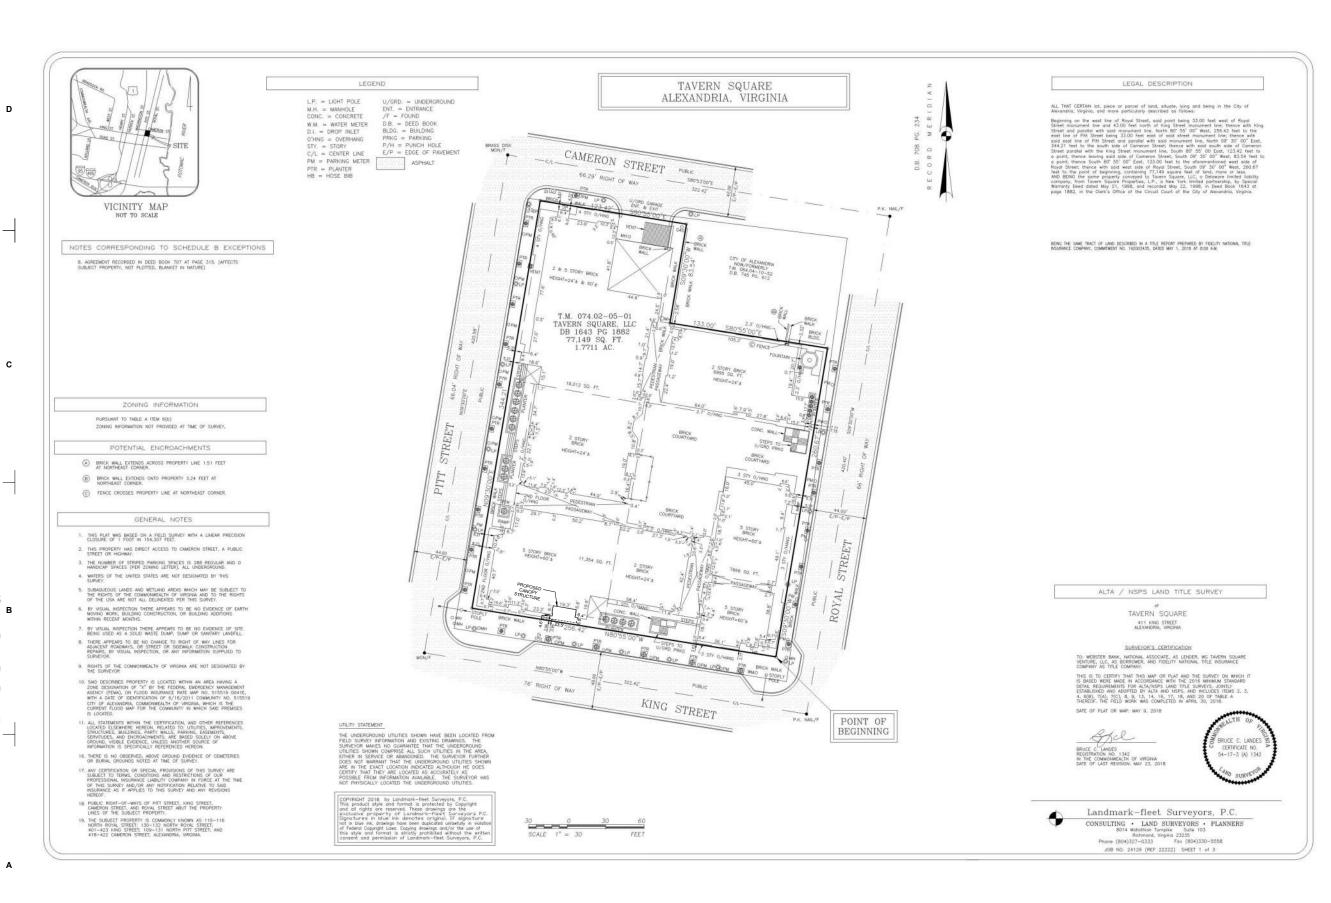

archit ecture

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150 S. Washington St., Suite 300 Falls Church, VA 22046 703.962.6643 703.962.6644 fax www.powersbrown.com

#### PROJECT TITLE

Tavern Square - Lobby

421 King Street Alexandria, VA 22314

A PROJECT FOR

Cambridge Property Group

GENERAL NOTES

DATE 201-01-21 ISSUE FOR BOARD REVIEW

PROJECT NO: 182032 DRAWN BY: GK CHECKED BY: ES

SHEET TITLE

ARCHITECTURAL **REVIEW** 

SEAL

A003

SHEET NUMBER

19

SURVEY PLAT - NEW CONSTRUTION

powers brown archit ecture 2100 Travis St., Suite 501 Houston, Texas 77002 713.224.0456 713.224.0457 fax www.powersbrown.com

#### PROJECT TITLE

#### Tavern Square - Lobby

110 N Royal Street Alexandria, VA 22314

A PROJECT FOR

Cambridge Property Group

ROYAL ST.

 $\triangle$  REVISION

2019-01-21 ISSUE FOR BOARD REVIEW

DATE

PROJECT NO: 182033 DRAWN BY: GK CHECKED BY: ES SHEET TITLE

GENERAL NOTES

KEY PLAN











## DEMOLITION REFLECTED CEILING PLAN - EXTERIOR LOBBY

- EXISTING RAILING BELOW

PROPOSED RENDERING - MAIN ENTRANCE

3

DESCRIPTION OF THE REASON FOR

FINISH UPGRADES ON EXTERIOR EXTRANCE,

INCLUDING CANOPY AND ASSOCIATED THE ADDRESS DOWN

THE FACADE OF BUILDING AND COLOR BAND WILL HELP ESTABLISH A VISUAL

ENTRY INTO BUILDING AND IMPROVE

WAYFINDING FROM

RESISTANT. NEW ENTRY LIGHITING WILL PROVIDE

PHENOLIC PANEL

POWDER COATED ALUM SIGNAGE COLOR TO MATCH PP3

TO MATCH EXISTING

- EXISTING STOREFRONT


EXISTING BRICK TO REMAIN NEW METAL RAILING

DIMENSIONAL

SAFETY.

THE PARKING GARAGE. MATERIALS ARE GRAFFITI

DEMOLITION:

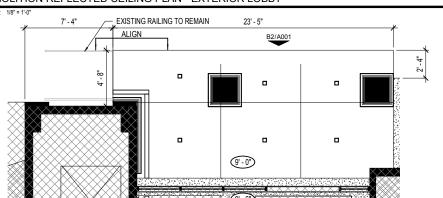

NEW CANOPY: 234 SF AMOUNT OF ADDITIONAL COVERAGE:

EXISTING CANOPY: 191 SF

(B1) EXISTING ELEVATION - ELEMENTS PROPOSED FOR DEMO (B2) ELEVATION - PROPOSED CONSTUCTION SCALE: 1/16" = 1-0"

#### LIGHT FIXTURE SCHEDULE

**EXISTING PHOTOGRAPHS - SITE** 

	CODE	TYPE	MANUFACTURER	SPECIFICATION	REMARKS
	K	SQUARE DOWNLIGHT	PATHWAY LIGHTING	MODEL: 504KE2LDANF-SCL	PROVIDE WET RATED VERSION FOR ALL EXTERIOR FIXTURES
	L	LINEAR RECESSED		MODEL: OPRS GB LOP CANT SEE PLAN 90CRI 40K 800LMF DARK ZT 277 SCT C041 CFG	PROVIDE WET RATED VERSION FOR ALL EXTERIOR FIXTURES
4	M	LED STRIP	FILIX	MODEL: LI 20 CONTINUOUS L 40RGB 120 24 DIM	SPACE EVERY 10" O.C. TO PROVIDE CONTINUOUS PATTERN OF LIGHT

EXISTING CANOPY

CEILING & LIGHTS

TO BE DEMOLISHED

EXISTING RAILING

TO BE DEMOLISHED

EXISTING STOREFRONT TO REMAIN EXISTING BRICK

#### **EXTERIOR FINISH SCHEDULE**

CODE	MATERIAL	MANUFACTURER	DESCRIPTION	COLOR	DEALER	REP NAME	CONTACT NO	REMARKS
PP1	WALL PANEL	TRESPA	METEON LUMEN PENOLIC WALL PANELS IN SPECULAR FINISH; L05.0.0	ATHENS WHITE	TRESPA	CHRISTIAN COLE	919.356.7082	
PP3	WALL PANEL	TRESPA	METEON EXTERIOR PENOLIC WALL PANELS IN SPECULAR FINISH; A12.1.8/ST	ROYAL BLUE	TRESPA	CHRISTIAN COLE	919.356.7082	ACCENT BAND

#### TRESPA PHENOLIC INSTALL



TRESPA PHENOLIC

REFLECTED CEILING PLAN - EXTERIOR LOBBY

20

LIGHTING SHALL BE DIMMABLE

B. FOOT CANDLES SHOWN ARE MAXIMUM EXPECTED.

A. FOOT CANDLE CALCULATIONS PROVIDED BY LIGHT FIXTURE MANUFACTURER

SEAL SHEET NUMBER

A001

ARCHITECTURAL


**REVIEW** 

#### **REFLECTED CEILING PLAN - PHOTOMETRICS** SCALE: 1/8" = 1'-0

D

С

SURVEY PLAT - EXISTING

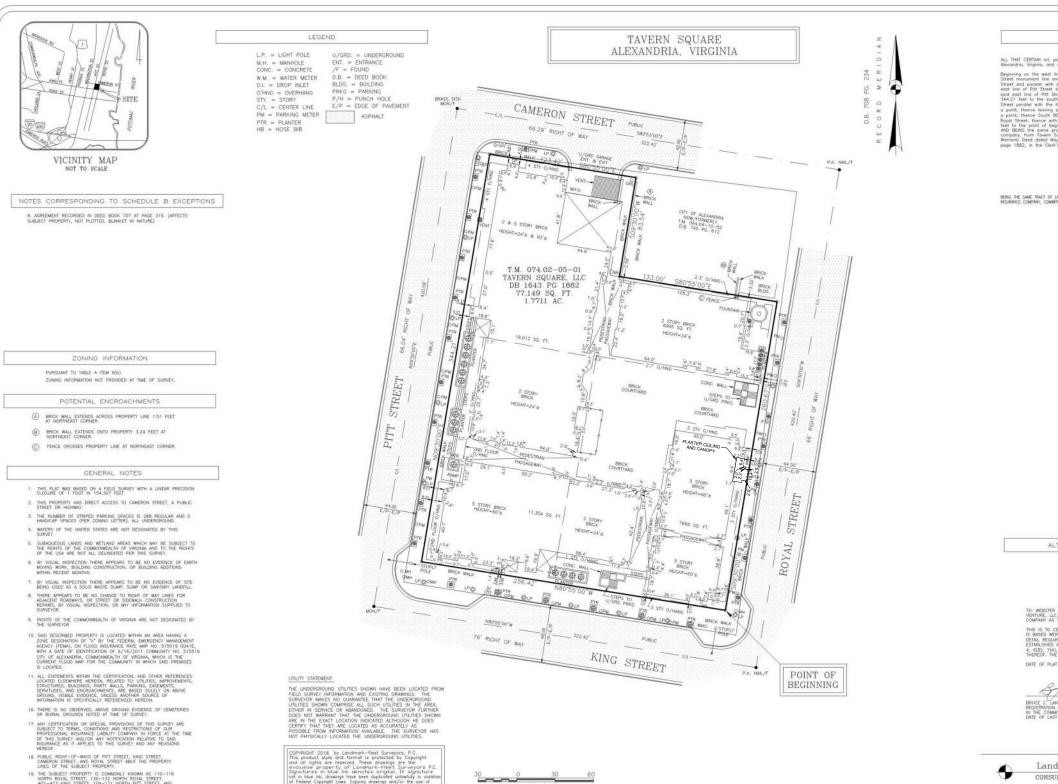

LEGAL DESCRIPTION

BEING THE SAME TRACT OF LAND DESCRIBED IN A TITLE REPORT PREPARED BY FIDELITY NATIONAL TITLE INSURANCE COMPANY, COMMITMENT NO. 1920/3435, DATED MAY 1, 2018 AF 8:00 AM.

ALTA / NSPS LAND TITLE SURVEY

TAVERN SQUARE

411 KING STREET
ALEXANDRIA, VIRGINIA

SURVEYOR'S CERTIFICATION TO: WEBSTER BANK, NATIONAL ASSOCIATE, AS LENDER, WG TAYERN SQUARK VENTURE, LLC, AS BORROWER, AND FIDELITY NATIONAL TITLE INSURANCE COMPANY AS TITLE COMPANY.

DATE OF PLAT OR MAP: MAY 9, 2018



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**REVIEW** SHEET NUMBER

ARCHITECTURAL

PROJECT NO: 182033

DRAWN BY: GK CHECKED BY: ES SHEET TITLE

DATE

2019-01-21 ISSUE FOR BOARD REVIEW

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PROJECT TITLE

GENERAL NOTES

150 S. Washington St.,

Suite 300 Falls Church, VA 22046

Tavern Square - Lobby

110 N Royal Street

Alexandria, VA 22314

A PROJECT FOR

Cambridge Property Group

703 962 6643

703.962.6644 fax www.powersbrown.com

SEAL

A002

21

LEGEND

L.P. = LIGHT POLE

M.H. = MANHOLE CONC. = CONCRETE

PTR = PLANTER HB = HOSE BIB

KING STREET

TAVERN SQUARE

LEGAL DESCRIPTION

BEING THE SAME TRACT OF LAND DESCRIBED IN A TITLE REPORT PREPARED BY FIDELITY INVIIONAL TITLE INSURANCE COMPANY, COMMITMENT NO. 192003435, DATED MAY 1, 2018 AT 8:00 A.M.

ALTA / NSPS LAND TITLE SURVEY

TAVERN SQUARE 411 KING STREET ALEXANDRIA, VIRGINIA

SURVEYOR'S CERTIFICATION

TO: WEBSTER BANK, NATIONAL ASSOCIATE, AS LENDER, WG TAVERN SOLIARE VENTURE, LLC, AS BORROWER, AND FIDELITY NATIONAL TITLE INSURANCE COMPANY. AS TITLE COMPANY.

DATE OF PLAT OR MAP: MAY 9, 2018





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JOB NO. 24126 (REF 22222) SHEET 1 of 3

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150 S. Washington St., Suite 300 Falls Church, VA 22046 703 962 6643 703.962.6644 fax www.powersbrown.com

PROJECT TITLE

Tavern Square - Lobby

110 N Royal Street Alexandria, VA 22314

A PROJECT FOR

Cambridge Property Group

GENERAL NOTES

DATE  $\triangle$  REVISION 2019-01-21 ISSUE FOR BOARD REVIEW

PROJECT NO: 182033 DRAWN BY: GK CHECKED BY: ES SHEET TITLE

> ARCHITECTURAL **REVIEW**

SEAL SHEET NUMBER A003

22

POINT OF BEGINNING

76' RIGHT OF WAY

SURVEY PLAT - NEW CONSTRUCTION

SCALE: 3/4" = 1'-0"

Ö

С

В



#### DESCRIPTION OF THE REASON FOR DEMOLITION:

FINISH UPGRADES ON EXTERIOR EXTRANCE, INCLUDING CANOPY AND ASSOCIATED LIGHTING. THE ADDRESS DOWN THE FACADE OF BUILDING AND COLOR BAND WILL HELP ESTABLISH A VISUAL ENTRY INTO BUILDING AND IMPROVE WAYFINDING FROM THE PARKING GARAGE. MATERIALS ARE GRAFFITI RESISTANT. NEW ENTRY LIGHITING WILL PROVIDE SAFETY.

DEMOLITION REFLECTED CEILING PLAN - EXTERIOR LOBBY

11'-4")

23' - 2"

## PROPOSED RENDERINGS - MAIN ENTRANCE

Tavern Square - Lobby

Revised 2.15.2019

150 S. Washington St., Suite 300

703.962.6643 703.962.6644 fax

Falls Church, VA 22046

www.powersbrown.com

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PROJECT TITLE

123 N Pitt Street Alexandria, VA 22314

A PROJECT FOR

Cambridge Property Group

GENERAL NOTES

KEY PLAN

ROYAL ST.

DAIL	△ KEVISION
2019-01-21	ISSUE FOR BOARD REVIEW

PROJECT NO: 182034 DRAWN BY: GK CHECKED BY: ES

SHEET TITLE

ARCHITECTURAL **REVIEW** 


SEAL SHEET NUMBER A001

**EXISTING PHOTOGRAPHS - MAIN ENTRANCE** 





**EXISTING PHOTOGRAPHS - SITE** 

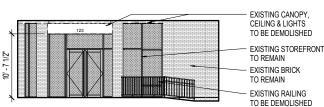

PHENOLIC PANEL REVEAL (TYP) DIMENSIONAL POWDER COATED ALUM SIGNAGE COLOR TO MATCH PP4 EXISTING BRICK TO REMAIN NEW METAL RAILING TO MATCH EXISTING EXISTING STOREFRONT

B B1 EXISTING ELEVATION - ELEMENTS PROPOSED FOR DEMO

(B2) ELEVATION - PROPOSED CONSTRUCTION SCALE: 1/16" = 1'-0"

## LIGHT FIXTURE SCHEDULE

	CODE	TYPE	MANUFACTURER	SPECIFICATION	REMARKS
	K	SQUARE DOWNLIGHT	PATHWAY LIGHTING	MODEL: 504KE2LDANF-SCL	PROVIDE WET RATED VERSION FOR ALL EXTERIOR FIXTURES
	L	LINEAR RECESSED		MODEL: OPRS GB LOP CANT SEE PLAN 90CRI 40K 800LMF DARK ZT 277 SCT C041 CFG	PROVIDE WET RATED VERSION FOR ALL EXTERIOR FIXTURES
4	М	LED STRIP	FILIX	MODEL: LI 20 CONTINUOUS L 40RGB 120 24 DIM	SPACE EVERY 10" O.C. TO PROVIDE CONTINUOUS PATTERN OF LIGHT

#### **EXTERIOR FINISH SCHEDULE**

CODE	MATERIAL	MANUFACTURER	DESCRIPTION	COLOR	DEALER	REP NAME	CONTACT NO	REMARKS
PP1	WALL PANEL	TRESPA	METEON LUMEN PENOLIC WALL PANELS IN SPECULAR FINISH; L05.0.0	ATHENS WHITE	TRESPA	CHRISTIAN COLE	919.356.7082	
PP4	WALL PANEL	TRESPA	METEON EXTERIOR PENOLIC WALL PANELS IN SPECULAR FINISH; A12.1.8/ST	LIME GREEN	TRESPA	CHRISTIAN COLE	919.356.7082	ACCENT BAND

#### TRESPA PHENOLIC INSTALL



MATERIALS AND COLORS

REFLECTED CEILING PLAN - PHOTOMETRICS

SCALE: 1/8" = 1'-0"

REFLECTED CEILING PLAN - EXTERIOR LOBBY

EXISTING RAILING BELOW

EXISTING RAILING


A. FOOT CANDLE CALCULATIONS PROVIDED BY LIGHT FIXTURE MANUFACTURER

EXISTING CANOPY: 181 SF

NEW CANOPY: 218 SF

AMOUNT OF ADDITIONAL COVERAGE: 218 SF - 181 SF = 37 SF

B. FOOT CANDLES SHOWN ARE MAXIMUM EXPECTED. LIGHTING SHALL BE DIMMABLE

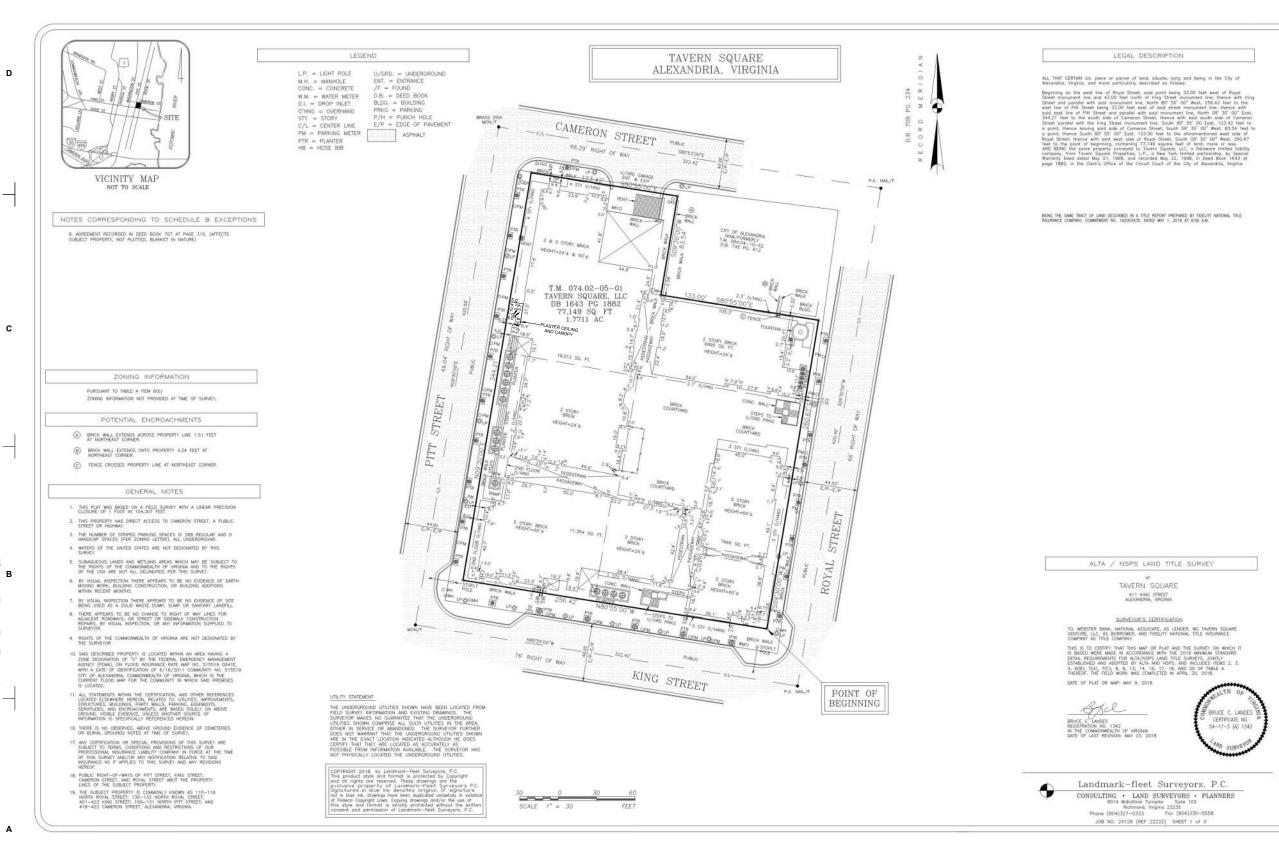

Tavern Square - Lobby

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PROJECT TITLE

123 N Pitt Street Alexandria, VA 22314

150 S. Washington St., Suite 300

703.962.6643

703.962.6644 fax www.powersbrown.com

Falls Church, VA 22046

A PROJECT FOR

Cambridge Property Group

GENERAL NOTES

DATE 2019-01-21 ISSUE FOR BOARD REVIEW

PROJECT NO: 182034 DRAWN BY: GK CHECKED BY: ES SHEET TITLE


ARCHITECTURAL **REVIEW** 

SHEET NUMBER

A002

SEAL

С

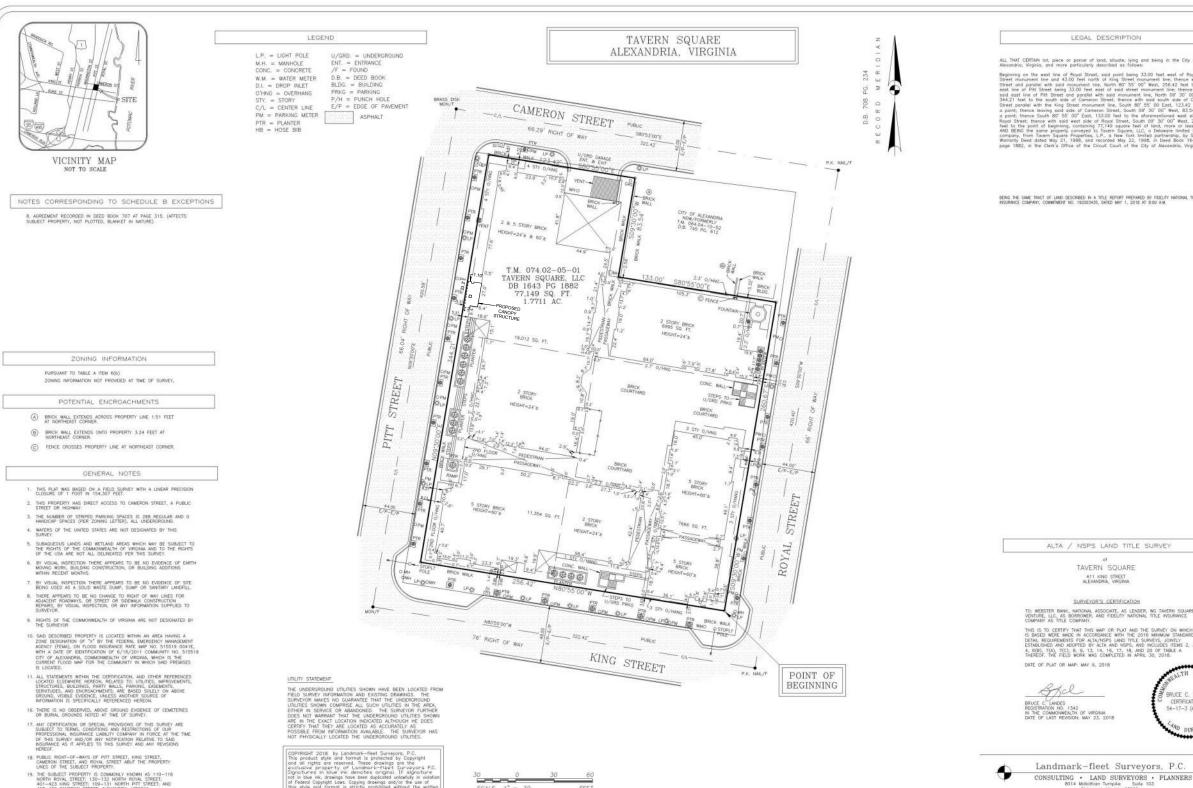

ALL THAT CERTAIN lot, piece or parcel of land, situate, lying and being in the City of Alexandria, Virginia, and more particularly described as follows:

BEING THE SAME TRACT OF LAND DESCRIBED IN A TITLE REPORT PREPARED BY FOELITY NATIONAL TITLE INSURANCE COMPANY, COMMITMENT NO. 1920/3435, DATED MAY 1, 2018 AT 8:00 A.M.

ALTA / NSPS LAND TITLE SURVEY



CONSULTING • LAND SURVEYORS • PLANNERS 8014 Midothian Turnpike Suite 103 Richmond, Verpina 23235 Phone (804)327–0333 Fax (804)330–5556 JOB NO. 24126 (REF 22222) SHEET 1 of 3

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150 S. Washington St., Suite 300 Falls Church, VA 22046 703.962.6643 703.962.6644 fax www.powersbrown.com

PROJECT TITLE

Tavern Square - Lobby

123 N Pitt Street Alexandria, VA 22314

A PROJECT FOR

Cambridge Property Group

GENERAL NOTES

DATE 2019-01-21 ISSUE FOR BOARD REVIEW

PROJECT NO: 182034 DRAWN BY: GK CHECKED BY: ES SHEET TITLE


ARCHITECTURAL **REVIEW** 


SEAL SHEET NUMBER

A003






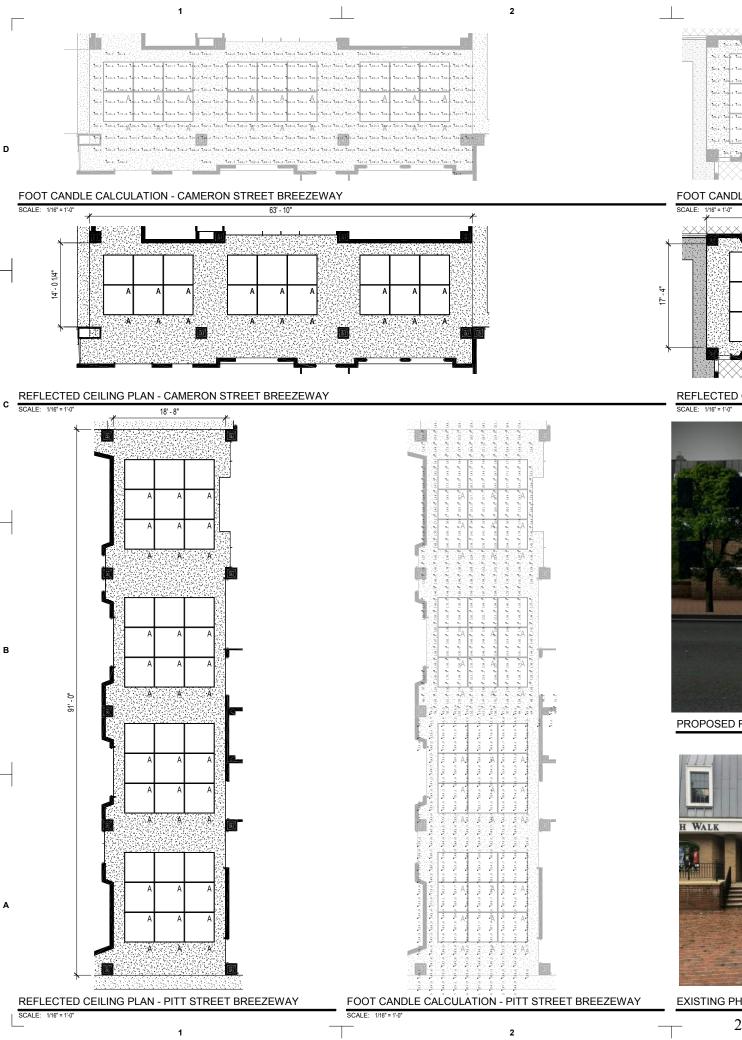

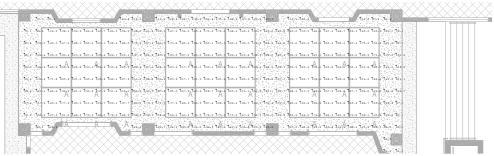

#### FOOT CANDLE CALCULATION - KING STREET BREEZEWAY

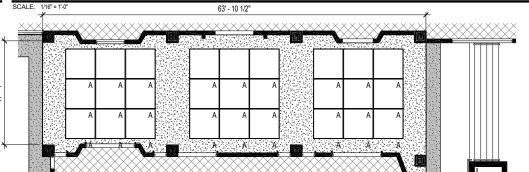

#### REFLECTED CEILING PLAN - KING STREET BREEZEWAY



# LIGHT FIXTURE SCHEDULE ILLUMINATED ACRYLIC PANELS

TYPE

MANUFACTURER

SPECIFICATION

LAMP: 360 LUMENS PER LINEAR FOOT (5 WATT/FOOT)

MOUNTING: PENDANT CABLE FINISH: STNDR ACRYLIC PANEL W/

MODEL: ARTISTIC LIGHT PANEL

SERIES (CUSTOM)

COLOR TEMP: 4000K

PROPOSED RENDERING - BREEZEWAY



EXISTING PHOTOGRAPHS - BREEZEWAYS @ KING, PITT & CAMERON STREET

powers brown archit ecture

150 S. Washington St., Suite 300 Falls Church, VA 22046 703.962.6643 703.962.6644 fax www.powersbrown.com

#### PROJECT TITLE

#### Tavern Square - King Street Breezeway

421 King Street Alexandria, VA 22314

A PROJECT FOR

Cambridge Property Group

#### GENERAL NOTES


- A. FOOT CANDLE CALCULATIONS PROVIDED BY LIGHT FIXTURE MANUFACTURER
- B. FOOT CANDLES SHOWN ARE MAXIMUM EXPECTED. LIGHTING SHALL BE DIMMABLE

#### DESCRIPTION OF THE REASON FOR WORK:

REPLACEMENT OF EXISTING BREEZEWAY LIGHTING WITH AN ILLUMINATED PANEL SYSTEM TO PROVIDE ADDITIONAL LIGHTING. THE ILLUMINATED PANEL APPROACH WOULD PROVIDE A CONTINUOUS EVEN LEVEL OF LIGHTING. THE PLANE ILLUMINATION DESIGN AIMS TO COMPENSATE FOR THE DARK TUNNEL EFFECT CREATED BY THE LENGTH AND LOW CEILING CONDITION OF THE BREEZEWAY. THIS WILL CREATE A SAFER SPACE FOR PEDESTRIANS TRAVERSING THE BUILDINGS AS WELL AS CREATING AN INVITING OPENING TO ENCOURAGE THE USE OF THE PLAZA AS A PUBLIC SPACE.

#### KEY PLAN

REMARKS

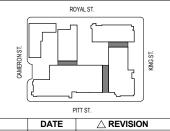

	ISSUE FOR BOARD REVIEW

PROJECT NO: 182023.01 DRAWN BY: GK CHECKED BY: ES

#### SHEET TITLE

**ARCHITECTURAL REVIEW** 

AL.	SHEET NUMBER
Partie Control of the	A001



## Open Recessed LED

OPRS | LED | Direct | Recessed

Type:

Project:



#### **HIGHLIGHTS**

• 5-year limited warranty by Acuity Brands covering all components and construction



- 2', 3', 4', 5, 6' and 8' sections
- Up to 91 lm/W
- Two outputs available



 Seam eraser technology provides continuous illumination for long runs


eldoLED

· Flicker-free dimming to dark powered by eldoLED® driver



- Integrated nLight® module for system networking (optional)
- Modular light engine to allow for easy upgrades and replacement

#### **DIMENSIONS**

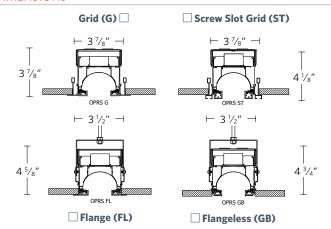


#### **LUMEN PACKAGES**

Direct LED Ouput	500LMF	800LMF
Delivered Lumens Per Foot	503	736
Input Watts Per Foot	5.5	8.5
Lumens Per Watt	91	87

#### STANDARD DISTRIBUTION

100% Down

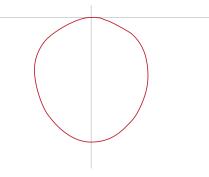

## **OPTIONS**





#### COMPANION LUMINAIRE(S)

■ Inside Corner







#### **CUSTOMIZATION**

Ask us about the following possibilities: alternate section lengths, additional CCTs for LED boards, custom colors and other modifications.



## Open Recessed LED OPRS | LED | Direct | Recessed

#### **SPECIFICATIONS**

#### Housing

Extruded aluminum housing.

#### **Luminaire Length**

2', 3', 4', 5', 6' and 8' lengths in a single section. Longer rows are comprised of starter, joiner and ender sections.

#### Source

Two LED lumen packages and three available color temperature options (3000K, 3500K and 4000K) in 80+ CRI and 90+ CRI options — all within 2.5 MacAdam ellipses.

#### **Optics**

Optical system consists of high performance film.

#### **Dimming Driver**

eldoLED® driver (see page 3) provides "natural dimming" with smooth, continuous and flicker-free dimming to dark. Syncing for controls: 2mA max. THD: < 20%. Insignificant inrush current at 120 and 277VAC. FCC Class A tested for EMI and RFI. When Control Input of 0-10V is specified driver will be set for linear dimming curve, if NLIGHT is specified driver will be set for logarithmic dimming curve. For 0-10V and DALI details go to: PeerlessLighting.com/SOLOdrive

#### **Controls and System Networking Options**

For wired networking via Cat-5e, choose an integrated nLight® module.

One control module per 4' section or 40' maximum row.

#### **Electrical**

LED light engine — consisting of modular LED boards and eldoLED® dimming driver — is rated for 60,000 hours (L<sub>90</sub>) at 25° C ambient temperature. Specify 120V, 277V or 347V.

#### Environment

Ambient operating temperature between 0° C and 25° C. Suitable for dry and damp locations.

#### Validation

cCSAus listed. LM-79 tested. Individual sections meet FCC Part 15 requirements.

#### **Packaging**

Recycled cardboard box and inserts. Biodegradable, protective luminaire bag. Recycled kraft paper tape.

#### Warranty

5-year limited warranty. Complete warranty terms located at www.acuitybrands.com/CustomerResources/Terms\_and\_conditions.aspx

Note: Actual performance may differ as a result of end-user environment and application.
All values are design or typical values, measured under laboratory conditions at 25°C.


#### A+ Capable Luminaire

This item is an A+ capable luminaire, which has been designed and tested to provide consistent color appearance and out-of-the-box control compatibility with simple commissioning.

- All configurations of this luminaire meet the Acuity Brands' specification for chromatic consistency
- This luminaire is part of an A+ Certified solution for nLight® control networks when ordered with drivers marked by a shaded background\*
- This luminaire is part of an A+ Certified solution for nLight control networks, providing advanced control functionality at the luminaire level, when selection includes driver and control options marked by a shaded background\*

To learn more about A+, visit www.acuitybrands.com/aplus.

\*See ordering tree for details

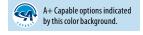


MODEL NUMBER Example: OPRS G LOP 10FT 80CRI 35K 500LMF DARK ZT 120 SCT C041

Luminair OPRS	G T-Gri ST Screv FL Flang	id w Slot Grid ge (hard ceiling) geless (hard	Linear Len LOP Line optii	_	-	Total Run LengthFT Indicate luminaire row length in 2' increments Ex: 10FT	80CRI 90CRI	olor Rendering 80+ CRI 90+ CRI	<b>30K</b> 39 <b>35K</b> 3	r Temperature 000K 500K 000K	Direct LE 500LMF 800LMF	D Output  500 nominal direct lumens per foot 800 nominal direct lumens per foot
Minimur Dimming		Control Input		Voltage		Wiring Option	Emergency	/ Options	Color		Options	
MIN1	Constant current, dimming to < 1% Constant current, dimming to 1%		I enabled the enabled	120 120 277 27 347* 34	7V	SCT Single circuit	(Blank) 1EC 2ECEC RE10W**  Emergency 4' of lumino	None (1) Emergency circuit module (2) Emergency circuit moduleEmergency circuit modules 10-watt emergency pack (900 lumens) type is installed in lastire sections.	C099	White white (low gloss) Custom color	CP*** GLR GMF HCF CFG**** *Not availa mounting ty **RE10W is mounting ty ***Available only.	Manufactured to Canadian Standards Chicago Plenum Fast blow Slow blow Healthcare facility cove Corner configurations ble with nlight nor ypes FL and GB. In the available with ypes FL nor GB. In with individual fixture to factory for details.


Type:

Project:


#### **PHOTOMETRICS**

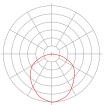


G 500LMF 80CRI 35K 91 lm/W 2029 delivered lumens per 4' section 100% down

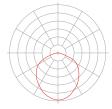

**ST 500LMF 80CRI 35K** 90 lm/W 2020 delivered lumens per 4' section 100% down

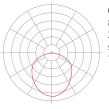

G 800LMF 80CRI 35K 87 lm/W 2943 delivered lumens per 4' section 100% down

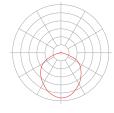

ST 800LMF 80CRI 35K 86 lm/W 2930 delivered lumens per 4'section 100% down

#### COMPATIBLE nLIGHT COMPONENTS WITH INTEGRATED CONTROLS



SensorSwitch.com/DataSheets/nPODM.pdf



nPODM 2LWH

SensorSwitch.com/DataSheets/nPODM-xL.pdf



SensorSwitch.com/DataSheets/nPOD-GFX.pdf

eldoLED COMPATIBILITY Additional control options with eldoLED 0-10V driver(s).

PeerlessLighting.com/eldoLED-compatibility

## T SQ - TYPE K 504KE2LDANF - SCL

#### **APPLICATION**

Square-aperture, high-lumen medium distribution downlight is suitable for commercial, retail and institutional applications that require an energy saving, long life LED lamp source, high lumen output, excellent color rendering characteristics and a flush mount micro flange.

#### **PRODUCT DATA**

**REFLECTOR:** Dual-optic system includes upper cone which determines the beam distribution and lower reflector to finish the ceiling without glare. Narrow (1/8") trim flange is flush with ceiling line for a clean appearance and smooth transition between the ceiling and fixture aperture. Standard finish is soft clear Alzak. Optional finishes available.

**MECHANICAL:** The housing is fabricated heavy-gauge steel with galvanized finish and ventilated for heat dissipation. Integral plaster ring allows drywall compound to be applied up to edge of aperture. Trim flange rests in a flush mount position with drywall compound. Housing can be mechanically fastened to drywall to prevent movement and eliminate cracking or chipping. Universal mounting brackets adjust vertically and accept a variety of hanger bars. Ballast is accessible through aperture.

**HOUSING:** Heavy-gauge galvanized steel housing provides a secure mounting platform for the electrical components and protects the optical assembly. Standard plaster flange allows up to one-inch ceiling thickness. LED module is accessible from below.

**MOUNTING:** Universal mounting brackets adjust vertically and accept L-BAR interlocking, expandable c-channel hanger bars which are supplied standard. L-BARS are suitable for T-bar, wood joist and metal joist ceiling styles. Additional features on last page.

**ELECTRICAL:** 120 or 277 VAC, 50-60 Hz.

**JUNCTION BOX:** Heavy-gauge galvanized junction box pre-wired with grounding pigtail. Easy access covers. Multiple conduit knockouts listed for through branch circuit wiring.

**LED MODULE:** Bridgelux LED module. CRI = 80. Available in 90 CRI.

**HEAT MANAGEMENT:** Engineered heat sink provides passive cooling for optimum heat management of the LED engine.

**DIMMING:** Standard product is compatible with 0-10 volt dimming controls. Additional options available.

 Expected lamp life to be 50,000 hours with 70% lumen maintenance when ambient temperatures do not exceed 45°C. Lower ambient temperatures yield longer lamp life.





## **SERIES 4SQLBV-NF Lensed**


774-9378 Lumen Bridglux LED – Recessed Downlight



5 Year Warranty

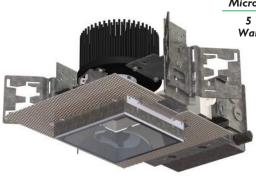

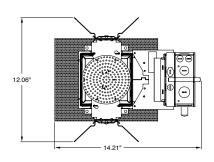

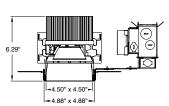

Rough Opening 5.13" x 5.13"

#### Catalog #:

4SQLBV Example: 4SQLBV404KE1M40DANF

Fixture Series	Delivered Lumens	Color Temp.	Input Voltage	Beam Dist.	Dimming
4SQLBV	10= (774L - 897L, 9W) 20= (1852L - 2145L, 21W) 30= (2533L - 2935L, 29W) 40= (3480L - 4032L, 42W) 50= (4080L - 4727L, 50W) 60= (4926L - 5707L, 64W) 70= (5585L - 6470L, 75W) 80= (5985L - 6934L, 83W) 90= (7418L - 8594L, 84W) 100 = (8095L - 9378L, 93W)  C9 = 90 CRI See next page for details on delivered lumens.	5K = 5000K 4K = 4000K 35K = 3500K 3K = 3000K 27K = 2700K	E1 120 Volt E2 277 Volt E3 347 Volt**	L = Primary reflector for lensed trim	DA = Xitanium 1% 0-10V (linear) is standard.  More options on next page.

<sup>\*\* 347</sup>V limited to 10-60 lumen designations and DS dimming option.



For Damp Location

Fixture:	Type:
Project:	

#### 4SQLBV

Example: 4SQLBVHAZ

Trim	Trim Finish
L3 - L5 - L6 - L7 -	<ul> <li>Open Downlight Reflector</li> <li>C73 Prismatic Glass Lens</li> <li>Frosted Glass Lens</li> <li>Frosted Acrylic Lens Option</li> <li>Solite Micro-Prismatic Glass Lens</li> <li>Clear Poly Carbonate Lens Option</li> <li>Clear Tempered Glass Lens Option</li> </ul>
For oth	SCL – Soft Specular Clear Alzak HAZ – Haze Alzak NF – Flush Mount Flange  eer finishes, consult reflector section.

#### **Options**

■ EM<sup>\*</sup>= Emergency Power Pack

■ **NF** = Flush Mount Flange

^ DMX and Pathwave options are not compatible with emergency battery options.

Manufactured and tested to UL#1598, UL#8750 and CSA standards. Note: Suitable for damp location.

Fixtures are not designed for direct contact with insulation.

All Pathway® products meet or exceed requirements as established by the National Electrical Code. Specifications subject to change without notice.





#### **Dimming Options:**

Specify option by suffix (shown in bold-face type)

Our White Paper regarding Linear vs. Logarithmic Operating Characteristics is available in our 'Downloads' section of our website, or you may request one my emailing Sales@PathwayLighting.com

#### **0-10V Dimming Options**

#### DA = Xitanium 1% 0-10V (linear)

**DB**= Xitanium 1% 0-10V (logarithmic)

DC = EldoLED 0-10V 0% (logarithmic)\*

**DD** = EldoLED 0-10V 1% (logarithmic)\*

DE = EldoLED 0-10V 0% (linear)\*

**DF** = EldoLED 0-10V 1% (linear)\*

**DN** = Lumastream 0-10V .3% (log.) lumen designation 100 only

DR = ERP 01-10V 1% (linear) lumen designation 100 only

**DS** = Sage 0-10V 1% (linear) 347V only, max lumen designation 50

#### **Lutron Dimming Options**

#### Max Lumen Designation of 40

**DG** = Lutron Eco 1% (linear)

**DH** = Lutron 3 wire 1% (linear)

DJ = Lutron 2 wire 1% (linear)

#### **DALI Dimming Options**

#### Max Lumen Designation of 50

**DK** = EldoLED DALI 0% (logarithmic)

**DL** = EldoLED DALI 1% (logarithmic)

#### **DMX Dimming Options**

## Max Lumen Designation of 40 RDM COMPLIANT

**XG** = DMX EldoLED 0% (logarithmic)

**XH** = DMX EldoLED 0% (linear)

#### Misc. Dimming Options

**DM** = 2-Wire Forward/Reverse Phase (120V, max lumen designation 30)

**DP** = ERP 2-Wire Forward/Reverse Phase (120V, lumen designation 100 only)

## DMX^ Dimming Options (interfaced through 0-10V driver)

#### XA = DMX Xitanium 1% (linear) ^

XB = DMX Xitanium 1% (logarithmic) ^

XC = DMX EldoLED 0% (logarithmic) \* ^

**XD** = DMX EldoLED 1% (logarithmic)\*^

XE = DMX EldoLED 0% (linear)\*^

XF = DMX EldoLED 1% (linear) \*^

XN = DMX/LumaStream .3% (logarithmic) lumen desig. 100 only ^

## PathWave^ Wireless Dimming Options (interfaced through 0-10V driver)

PA = PathWave/Xitanium 1% 0-10V (linear) ^

**PB** = PathWave/Xitanium 1% 0-10V (logarithmic) ^

PC = PathWave/EldoLED 0% (logarithmic) \*^

PD = Pathwave/EldoLED 1% (logarithmic) \*^

PE = PathWave/EldoLED 0% (linear) \*^

PF = PathWave/EldoLED 1% (linear) \*^

PN = PathWave/LumaStream .3% (logarithmic) 8000L & 10,000L only ^

#### Delivered Lumen Data (3500K Color Temperature) - Clear Tempered Glass

FIXTURE	TRIM	WATTAGE	RATED LUMENS	DELIVERED Lumens	BEAM Distribution	LPW
4SQLBV1035KLNF	4SQLBVL3SCLNF	9	1000	850	60°	94.40
4SQLBV2035KLNF	4SQLBVL3SCLNF	21	2000	2032	60°	96.77
4SQLBV3035KLNF	4SQLBVL3SCLNF	29	3000	2780	60°	95.87
4SQLBV4035KLNF	4SQLBVL3SCLNF	42	4000	3820	60°	90.94
4SQLBV5035KLNF	4SQLBVL3SCLNF	50	5000	4478	60°	89.57
4SQLBV6035KLNF	4SQLBVL3SCLNF	64	6000	5406	60°	84.47
4SQLBV7035KLNF	4SQLBVL3SCLNF	75	7000	6130	60°	81.73
4SQLBV8035KLNF	4SQLBVL3SCLNF	83	8000	6569	60°	79.15
4SQLBV9035KLNF	4SQLBVL3SCLNF	84	9000	8141	60°	96.92
4SQLBV10035KLNF	4SQLBVL3SCLNF	93	10000	8885	60°	95.54

Above Values reflect 3500K color temperatures.

Scaling factors for other temperatures: 2700K = .92; 3000K = .97; 4000K = 1.01; 5000K = 1.04

90 CRI = .83



<sup>\*</sup> EldoLED options are only available on models with lumen designations 10-50.

<sup>^</sup> DMX and Pathwave options are not compatible with emergency battery options.



#### Delivered Lumen Data (3500K Color Temperature) - Frosted Glass

FIXTURE	TRIM	WATTAGE	RATED LUMENS	DELIVERED Lumens	BEAM Distribution	LPW
4SQLBV1035KLNF	4SQLBVL5SCLNF	9	1000	774	60°	86.01
4SQLBV2035KLNF	4SQLBVL5SCLNF	21	2000	1852	60°	88.17
4SQLBV3035KLNF	4SQLBVL5SCLNF	29	3000	2533	60°	87.34
4SQLBV4035KLNF	4SQLBVL5SCLNF	42	4000	3480	60°	82.86
4SQLBV5035KLNF	4SQLBVL5SCLNF	50	5000	4080	60°	81.61
4SQLBV6035KLNF	4SQLBVL5SCLNF	64	6000	4926	60°	76.96
4SQLBV7035KLNF	4SQLBVL5SCLNF	75	7000	5585	60°	74.47
4SQLBV8035KLNF	4SQLBVL5SCLNF	83	8000	5985	60°	72.11
4SQLBV9035KLNF	4SQLBVL5SCLNF	84	9000	7418	60°	88.31
4SQLBV10035KLNF	4SQLBVL5SCLNF	93	10000	8095	60°	87.04

Above Values reflect 3500K color temperatures.

Scaling factors for other temperatures: 2700K = .92; 3000K = .97; 4000K = 1.01; 5000K = 1.04

90 CRI = .83

#### Delivered Lumen Data (3500K Color Temperature) - Frosted Acrylic

FIXTURE	TRIM	WATTAGE	RATED LUMENS	DELIVERED Lumens	BEAM Distribution	LPW
4SQLBV1035KLNF	4SQLBVL6SCLNF	9	1000	821	65°	91.25
4SQLBV2035KLNF	4SQLBVL6SCLNF	21	2000	1964	65°	93.55
4SQLBV3035KLNF	4SQLBVL6SCLNF	29	3000	2687	65°	92.67
4SQLBV4035KLNF	4SQLBVL6SCLNF	42	4000	3692	65°	87.91
4SQLBV5035KLNF	4SQLBVL6SCLNF	50	5000	4329	65°	86.58
4SQLBV6035KLNF	4SQLBVL6SCLNF	64	6000	5226	65°	81.66
4SQLBV7035KLNF	4SQLBVL6SCLNF	75	7000	5926	65°	79.01
4SQLBV8035KLNF	4SQLBVL6SCLNF	83	8000	6350	65°	76.51
4SQLBV9035KLNF	4SQLBVL6SCLNF	84	9000	7870	65°	93.69
4SQLBV10035KLNF	4SQLBVL6SCLNF	93	10000	8589	65°	92.35

Above Values reflect 3500K color temperatures.

Scaling factors for other temperatures: 2700K = .92; 3000K = .97; 4000K = 1.01; 5000K = 1.04

90 CRI = .83





#### Delivered Lumen Data (3500K Color Temperature) - Solite Micro-Prismatic Glass

FIXTURE	TRIM	WATTAGE	RATED LUMENS	DELIVERED Lumens	BEAM Distribution	LPW
4SQLBV1035KLNF	4SQLBVL7SCLNF	9	1000	878	55°	97.55
4SQLBV2035KLNF	4SQLBVL7SCLNF	21	2000	2100	55°	100.00
4SQLBV3035KLNF	4SQLBVL7SCLNF	29	3000	2873	55°	99.06
4SQLBV4035KLNF	4SQLBVL7SCLNF	42	4000	3947	55°	93.97
4SQLBV5035KLNF	4SQLBVL7SCLNF	50	5000	4628	55°	92.55
4SQLBV6035KLNF	4SQLBVL7SCLNF	64	6000	5587	55°	87.29
4SQLBV7035KLNF	4SQLBVL7SCLNF	75	7000	6334	55°	84.46
4SQLBV8035KLNF	4SQLBVL7SCLNF	83	8000	6788	55°	81.78
4SQLBV9035KLNF	4SQLBVL7SCLNF	84	9000	8413	55°	100.15
4SQLBV10035KLNF	4SQLBVL7SCLNF	93	10000	9181	55°	98.72

Above Values reflect 3500K color temperatures.

Scaling factors for other temperatures: 2700K = .92; 3000K = .97; 4000K = 1.01; 5000K = 1.04 90 CRI = .83

#### Delivered Lumen Data (3500K Color Temperature) - Clear Poly Carbonate Glass

FIXTURE	TRIM	WATTAGE	RATED LUMENS	DELIVERED LUMENS	BEAM Distribution	LPW
4SQLBV1035KLNF	4SQLBVL8SCLNF	9	1000	887	55°	98.60
4SQLBV2035KLNF	4SQLBVL8SCLNF	21	2000	2123	55°	101.07
4SQLBV3035KLNF	4SQLBVL8SCLNF	29	3000	2904	55°	100.13
4SQLBV4035KLNF	4SQLBVL8SCLNF	42	4000	3989	55°	94.98
4SQLBV5035KLNF	4SQLBVL8SCLNF	50	5000	4677	55°	93.55
4SQLBV6035KLNF	4SQLBVL8SCLNF	64	6000	5647	55°	88.23
4SQLBV7035KLNF	4SQLBVL8SCLNF	75	7000	6402	55°	85.36
4SQLBV8035KLNF	4SQLBVL8SCLNF	83	8000	6861	55°	82.66
4SQLBV9035KLNF	4SQLBVL8SCLNF	84	9000	8503	55°	101.23
4SQLBV10035KLNF	4SQLBVL8SCLNF	93	10000	9280	55°	99.78

Above Values reflect 3500K color temperatures.

Scaling factors for other temperatures: 2700K = .92; 3000K = .97; 4000K = 1.01; 5000K = 1.0490 CRI = .83





#### Delivered Lumen Data (3500K Color Temperature) - Clear Tempered Glass

FIXTURE	TRIM	WATTAGE	RATED LUMENS	DELIVERED Lumens	BEAM Distribution	LPW
4SQLBV1035KLNF	4SQLBVL9SCLNF	9	1000	897	55°	99.64
4SQLBV2035KLNF	4SQLBVL9SCLNF	21	2000	2145	55°	102.15
4SQLBV3035KLNF	4SQLBVL9SCLNF	29	3000	2935	55°	101.19
4SQLBV4035KLNF	4SQLBVL9SCLNF	42	4000	4032	55°	96.00
4SQLBV5035KLNF	4SQLBVL9SCLNF	50	5000	4727	55°	94.54
4SQLBV6035KLNF	4SQLBVL9SCLNF	64	6000	5707	55°	89.17
4SQLBV7035KLNF	4SQLBVL9SCLNF	75	7000	6470	55°	86.27
4SQLBV8035KLNF	4SQLBVL9SCLNF	83	8000	6934	55°	83.54
4SQLBV9035KLNF	4SQLBVL9SCLNF	84	9000	8594	55°	102.31
4SQLBV10035KLNF	4SQLBVL9SCLNF	93	10000	9378	55°	100.84

Above Values reflect 3500K color temperatures.

Scaling factors for other temperatures: 2700K = .92; 3000K = .97; 4000K = 1.01; 5000K = 1.04  $90 \ CRI = .83$ 





## **OPTIONS & ACCESSORIES**

## **Available Reflector Finishes**



Clear Soft Specular "**SCL**"



Pewter Diffused "**EPW**" Soft Specular "**SPW**"



Haze Diffused "**HAZ**"



Straw
Diffused "EST"
Soft Specular "SST"



Bronze
Diffused "EBZ"
Soft Specular "SBZ"




Wheat
Diffused "EWT"
Soft Specular "SWT"

Our standard reflector finish is soft specular clear Alzak (SCL). Additional hues are noted to left. Several of these are offered in both a soft specular and a diffused/matte finish. For colors not shown, contact our sales department for advice on custom anodized finishes.

Specified suffix of desired finish.

Example: 4VLEDSCL

## **Standard Hanger Bars**

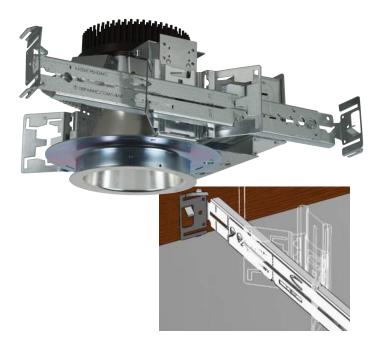

Interlocking L-Bar hanger bars are now standard with all recessed Coventry Architectural lighting fixtures. Installer friendly features include:


- L-Bars are fabricated from identical L-shaped cross sections that form a sturdy ½" by 1-1/2" C-channel profile for superior rigidity.
- Pre-marked with spacing locations for 24" T-bar; 16" and 24" joist ceilings (wood and metal).
- Extension locks with an easy-to-use integral twist tab. No separate fastener.
- Interlocking and expandable to 24". Can be increased to 36" or 48" with the use of one additional bars.
- Allows for offset mounting.
- Integral and barbed nail spike for wood joist ceilings.
- Fits into the c-channel notches on our butterfly mounting bracket.
- Complete details including video demonstration is available at www.pathwaylighting.com.

To increase the included L-Bar set to a 36" length, order two model #015-954 and use one per side. To increase to a 48" length, order one #LBAR which is a complete set of four bars and use two per side.






# Artistic Light Panels Figments of your Illumination

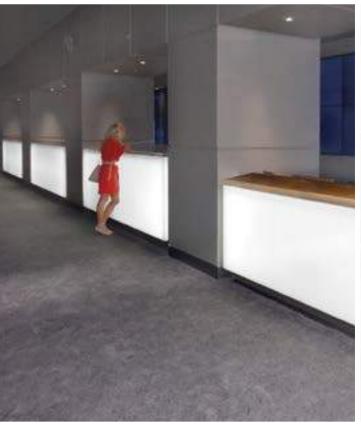




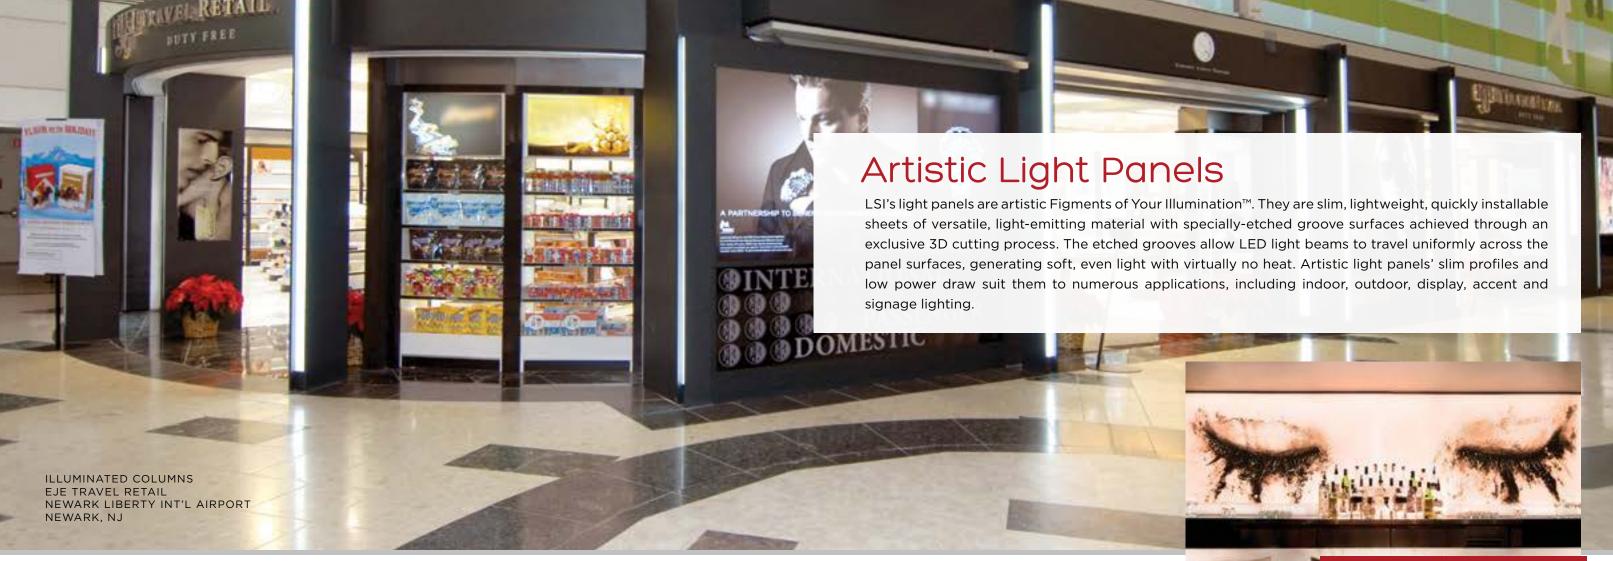

## Leadership. Strength. Innovation.

Those were the key values upon which LSI Industries Inc. was established in 1976. Today, LSI continues to demonstrate these values through its dedication to integrated technology and design across all aspects of its manufacturing business. LSI is committed to advancing solid-state LED technology to produce affordable, high-performance, energy-efficient, IMAGE-enhancing lighting & graphic products that bring value to its customers. LSI has made significant investments in R&D and automation to ensure highest quality based on stringent requirements. LSI's vast offering of innovative solutions can serve virtually any lighting or graphics application. In addition, LSI can provide sophisticated lighting and energy management control solutions to help customers manage their energy performance. LSI's expertise also extends to design support, engineering, installation and project management for custom graphic installations in today's ever-changing retail environment.

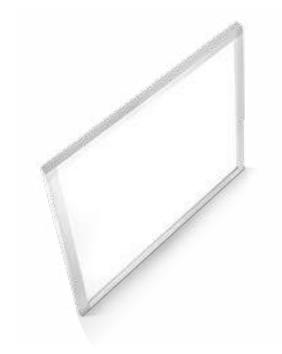

## TABLE OF CONTENTS

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Artistic Light Panel: Specifications	3-4
Artistic Light Panel: High Output	5-6
Artistic Light Panel: Very High Output	7-8
Artistic Light Panel:  RGB + Color Tuning	9-10









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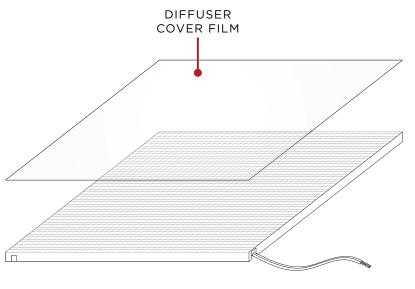
## **General Specifications**


FOR ALL FIXTURE APPLICATIONS

- Optical grade acrylic 93% light transmission
- Glass polished edges
- **LightWeb™** algorithmic 3D etched groove patterns for even light distribution (+/- 5% lux variance corner to center regardless of panel size)
- Maximum size: 120" x 78" or 157" x 65"
- Minimum size: 2" x 1"
- Shapes available: Flat panel 2D shapes (circles, ovals, triangles, channel letters), plus some custom 3D curved shapes (upon request)
- Thickness: 3/16" to 1/2", depending upon sheet size and frame choice
- ANSI binned LEDS from tier 1 suppliers
- **CRI:** >80
- CRT available: 2700, 4400 and 5300K
- Industrial Mil Pearlescent Heat-Bonded **Reflective Backing Material**
- Moisture-Resistant Foil Backed **Framing Tape**
- Input Voltage: 100V to 480V (Plug-In or Hardwire)
- Output Voltage: 12V or 24V, depending upon sheet size and power selection (with Concealable Low Voltage Wiring)
- Dimmable (hardwired MLV, 0-10V, or remote control plug in)
- UL Recognized
- Hospital and MRI Safe
- Field Serviceable
- Damp Location Rated when driven with a **Class 2 Power Supply**



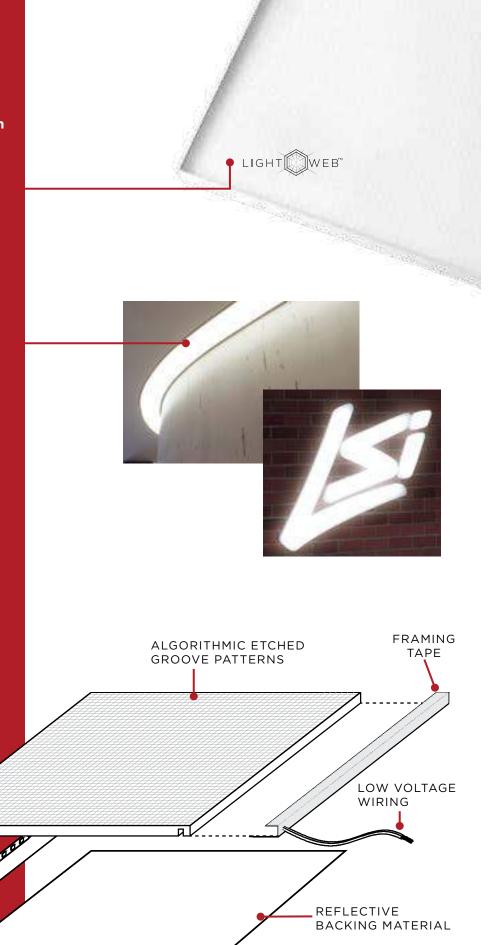

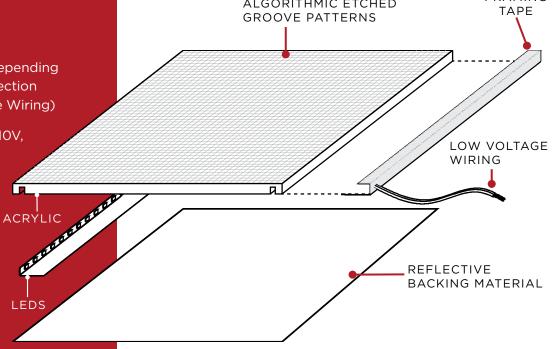

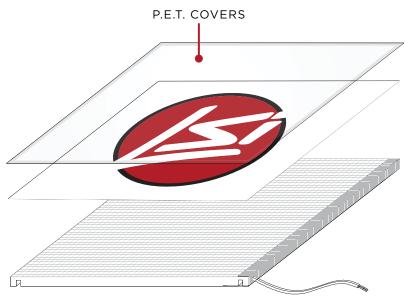




40

## **Optional Specifications**

FOR ALL FIXTURE APPLICATIONS

- High Output for maximum panel size of 10 ft. x 5 ft.: 5W/linear ft., 360 lumens/ft.
- Very High Output for all panels over 10 ft. x 5 ft.: 10W/linear ft., 720 lumens/ft.
- RGB Color Changing: red, green, blue through DMX
- Color Tuning: 2700K to 5300K
- Single or Dual Sided Illumination
- Special Purpose Frames & Enclosures
- a. Aluminum Protective Finish Frames
- b. Aluminum Snap Frames removable for changing media material
- c. Full Panel Acrylic Overlay Frames
- d. Full Panel Glass Cover with Magnetic Removal Frame
- Special Media Overlays
- a. P.E.T. covers for media protection in Snap Frames
- b. Diffuser Cover Film for reduction of optical glare and groove concealment (max. size 157" x 60")
- Multiple Panel Mounting Options
- a. Z Clips
- b. Stand Offs
- c. Pre-Drilled (all are drillable on site)
- d. Key-Hole Frames
- e. Mirror Clips
- f. Pendant Cable Mounts
- USB 5V Power System available (max panel size 40" x 40")
- Low Voltage Wire Color: Black (standard) or White

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## Thin. Versatile. Seamless.

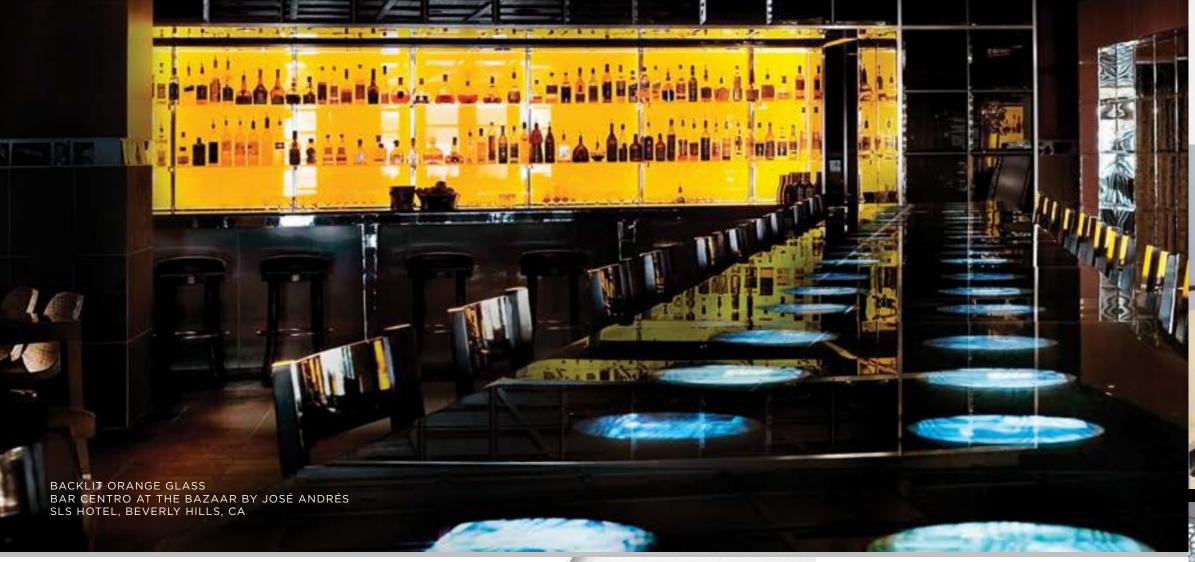Built for seamless design integration at 1/4" thick, the frameless **High Output light panel system** becomes a tasteful, thin sheet of light. By integrating our highest grade 5W per linear foot LEDs into the optical grade acrylic etched with computer calculated groove patterns, we have delivered a light source that generates a soft & even background of light with virtually no heat. Suggested maximum fixture size for the level of lighting is 10 feet x 5 feet.

This design makes the system usable in many applications including indoor and outdoor display lighting, accents, signage, residential and commercial applications. See General Specifications on pages 4-5 for maximum/minimum size, power, color and controllability for this offering.

## **Specifications**

MAXIMUM SIZE 10 ft x 5 ft

LIGHT OUTPUT 5W/Linear ft

360 Lumens/ft

APPLICATIONS Hospitality

Healthcare

Commercial Interior

Residential



## HIGH OUTPUT





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**Very High Output. Virtually Limitless.** 

The Very High Output light panel system employs

double the LED output, at 10W per linear foot, compared with the High Output light panel system. It is aimed at large

applications of greater than 10 feet x 5 feet, including retail

signage and high visibility areas. It is essential for backlighting

dense media materials such as fabrics, stone, logos - or any

size panel where you want to push light to the limit. Look to the

General Specifications on pages 4-5 for maximum/minimum

size, power, color and controllability for this offering.

## VERY HIGH OUTPUT



INTERNALLY LIT STONE SURFACE

PRIVATE RESIDENCE

LOS ANGELES, CA

## **Specifications**

MAXIMUM SIZE 120" x 78" or 157" x 65"

LIGHT OUTPUT 10W/Linear ft

720 Lumens/ft

APPLICATIONS Logos / Branding

Signage

Custom Fixtures

Retail



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# RGB & COLOR-TUNING



## Rich. Vibrant. Dynamic.

With Red, Green & Blue LEDs on the same chip you can design away. Our system of construction remains the same as in other panels, while the size and shape is left to your imagination. Colors come to play in this panel system: you can select from a spectrum of 16.4 million available colors, and adjust color transitions from 1/10 of a second to 3.4 seconds.

With Color-Tuning controllable panels, you have a color range of 2700K-5300K that spans day to evening, and warm to cool. You can adjust that range to suit your needs with either an automatic programmable DMX controller or a simple hand held device — both of which also control power and dimmability. With color-tuning ability, the opportunities for color customization in any environment are virtually limitless. See General and Optional Specifications on pages 4-5 for more details.

## **Specifications**

MAXIMUM SIZE  $120" \times 78"$  or

157" x 65"

POWER CONSUMPTION 5W/Linear ft

APPLICATIONS

Hospitality Healthcare

Retail

Commercial Interior

Residential





RGB COLOR CHANGING PANELS

PRIVATE VODKA BAR

BEVERLY HILLS, CA

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LSI Industries is a leading visual image company providing comprehensive lighting, graphic and technology solutions for commercial/industrial, petroleum/convenience store, multisite retail, sports and entertainment markets.

Leveraging technology, design, manufacturing and program implementation capabilities, LSI advances customers brands with energy-efficient interior and exterior lighting fixtures and lighting controls, custom graphic elements and décor programs, integrated digital signage solutions and advanced retail technology.

LSI trades on the NASDAQ exchange under the symbol LYTS.

#### www.lsi-industries.com

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#### LSI WARRANTY

LSI warrants its products to be free of defects in material or workmanship for three years from the date of shipment. Such warranty is in lieu of all other warranties including, without limitation any implied warranties of merchantability or fitness for a particular purpose. LSI will repair or replace any products that fail to meet this warranty, limited to three years. No back-charge, or charge for labor or material, that does not have LSI prior written approval will be honored, accepted or paid by LSI.

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