# PRELIMINARY DEVELOPMENT SPECIAL USE PERMIT 1800 MOUNT VERNON AVENUE

CITY OF ALEXANDRIA, VIRGINIA

# **AREA TABULATIONS**

TOTAL S	SITE AREA =	0.6151		_ AC		26,79	3	_ SF	
TOTAL A	AREA OF TAX	PARCELS = _	0.6151	AC _	26,79	3	SF		
TOTAL I	EXISTING IMP	ERVIOUS AREA	=	0.5971		AC _	26,	010	SF
TOTAL I	PROPOSED IN	MPERVIOUS AREA	A =	0.5240		_ AC	22,	825	;
TOTAL I	DISTURBED A	REA =	0.7250		AC		31,583		SF

# **ENVIRONMENTAL SITE ASSESSMENT**

- NO RESOURCE PROTECTION AREAS (RPA'S), TIDAL WETLANDS, SHORES, TRIBUTARY STREAMS, FLOOD PLAINS, OR BUFFER AREAS FOR SHORES WETLANDS, CONNECTED TIDAL WETLANDS, ISOLATED WETLANDS OR HIGHLY ERODIBLE/PERMEABLE SOILS LOCATED ON THIS SITE. THERE ARE NO WETLAND PERMITS REQUIRED FOR THE DEVELOPMENT ON THIS PROPERTY
- ALEXANDRIA DEPARTMENT OF TRANSPORTATION AND ENVIRONMENTAL SERVICES, DIVISION OF ENVIRONMENTAL QUALITY MUST BE NOTIFIED UNANTICIPATED CONTAMINATION OR UNDERGROUND STORAGE TANKS, DRUMS AND CONTAINERS ARE ENCOUNTERED AT THE SITE. IF THERE IS ANY DOUBT ABOUT PUBLIC SAFETY OR A RELEASE TO THE ENVIRONMENT, THE ALEXANDRIA FIRE DEPARTMENT MUST BE CONTACTED IMMEDIATELY BY CALLING 911. THE TANK OR CONTAINER'S REMOVAL, ITS CONTENTS, ANY SOIL CONTAMINATION AND RELEASE TO THE ENVIRONMENT WILL BE HANDLED IN ACCORDANCE WITH FEDERAL, STATE, AND CITY REGULATIONS.
- ALL WELLS TO BE DEMOLISHED ON THIS PROJECT, INCLUDING MONITORING WELLS, MUST BE CLOSED IN ACCORDANCE WITH STATE WELL REGULATION. CONTACT THE ALEXANDRIA HEALTH DEPARTMENT AT 703-746-4866.
- 4. THERE ARE NO KNOWN CONTAMINATED AREAS, CONTAMINATED SOILS OR ENVIRONMENTAL ISSUES ASSOCIATED WITH THIS SITE.

# **ENVIRONMENTAL PERMITS NOTES**

ALL REQUIRED PERMITS FROM VIRGINIA DEPARTMENT OF ENVIRONMENTAL QUALITY, ENVIRONMENTAL PROTECTION AGENCY, ARMY CORPS OF ENGINEERS, VIRGINIA

THIS PROJECT PROPOSES CONSTRUCTION ACTIVITIES THAT DISTURB AN AREA LESS THAN 1 ACRE, THEREFORE A VPDES PERMIT IS NOT REQUIRED.

# ARCHAEOLOGY NOTES

CALL ALEXANDRIA ARCHAEOLOGY IMMEDIATELY (703-746-4399) IF ANY BURIED STRUCTURAL REMAINS (WALL FOUNDATIONS, WELLS, PRIVIES, CISTERNS, ETC.) OR CONCENTRATIONS OF ARTIFACTS ARE DISCOVERED DURING DEVELOPMENT. WORK MUST CEASE IN THE AREA OF THE DISCOVERY UNTIL A CITY ARCHAEOLÓGIST COMES TO THE SITE AND RECORDS THE FINDS.

THE APPLICANT SHALL NOT ALLOW ANY METAL DETECTION AND/OR ARTIFACT COLLECTION TO BE CONDUCTED ON THE PROPERTY. UNLESS AUTHORIZED BY ALEXANDRIA ARCHAEOLOGY. FAILURE TO COMPLY SHALL RESULT IN PROJECT DELAYS.

ALL REQUIRED ARCHAEOLOGICAL PRESERVATION MEASURES SHALL BE COMPLETED IN COMPLIANCE WITH SECTION 11-411 OF THE ZONING ORDINANCE.

# **GENERAL NOTES**

- PRIOR TO THE APPLICATION FOR NEW CERTIFICATE OF OCCUPANCY. THE APPLICANT SHALL SUBMIT A BUILDING PERMIT FOR A CHANGE OF USE. DRAWINGS PREPARED BY A LICENSED ARCHITECT OR PROFESSIONAL ENGINEER SHALL ACCOMPANY THE PERMIT APPLICATION. THE PLANS SHALL SHOW PROPOSED CONDITIONS AND PROVIDE DATA BY THE DESIGN PROFESSIONAL WHICH DETAILS HOW THE PROPOSED USE WILL COMPLY WITH THE CURRENT EDITION OF THE VIRGINIA UNIFORM STATEWIDE BUILDING CODE FOR THE NEW USE IN THE AREA OF STRUCTURAL STRENGTH, MEANS OF EGRESS, PASSIVE AND ACTIVE FIRE PROTECTION, HEATING AND VENTILATING SYSTEMS, HANDICAPPED ACCESSIBILITY AND PLUMBING FACILITIES.
- NEW CONSTRUCTION MUST COMPLY WITH THE CURRENT EDITION OF THE UNIFORM STATEWIDE BUILDING CODE (USBC).
- BEFORE A BUILDING PERMIT CAN BE ISSUED ON ANY PROPOSED FUTURE ALTERATIONS, A CERTIFICATION IS REQUIRED FROM THE OWNER OR OWNER'S AGENT THAT THE BUILDING HAS BEEN INSPECTED BY A LICENSED ASBESTOS INSPECTOR FOR THE PRESENCE OF ASBESTOS.
- 4. A CERTIFICATE OF OCCUPANCY SHALL BE OBTAINED PRIOR TO ANY OCCUPANCY OF THE BUILDING OR PORTION THEREOF.
- 5. REQUIRED EXITS, PARKING, AND ACCESSIBILITY WITHIN THE BUILDING FOR PERSONS WITH DISABILITIES MUST COMPLY WITH USBC CHAPTER 11. HANDICAPPED ACCESSIBLE BATHROOMS SHALL ALSO BE PROVIDED.
- 6. TOILET FACILITIES FOR PERSONS WITH DISABILITIES: LARGER, DETAILED, DIMENSIONED DRAWINGS ARE REQUIRED TO CLARIFY SPACE LAYOUT AND MOUNTING HEIGHTS OF AFFECTED ACCESSORIES. INFORMATION ON DOOR HARDWARE FOR THE TOILET STALL IS REQUIRED (USBC 1109.2.2).
- IF APPLICABLE, ENCLOSED PARKING GARAGES MUST BE VENTILATED IN ACCORDANCE WITH USBC 406.4.2. THE REQUIRED MECHANICAL VENTILATION RATE FOR AIR IS 0.75 CFM PER SQUARE FOOT OF THE FLOOR AREA (USBC 2801.1). IN AREAS WHERE MOTOR VEHICLES OPERATE FOR A PERIOD OF TIME EXCEEDING 10 SECONDS, THE VENTILATION RETURN AIR MUST BE EXHAUSTED. AN EXHAUST SYSTEM MUST BE PROVIDED TO CONNECT DIRECTLY TO THE MOTOR VEHICLE EXHAUST (USBC 2801.1).
- 8. ELECTRICAL WIRING METHODS AND OTHER ELECTRICAL REQUIREMENTS MUST COMPLY WITH NFPA 70, 2008.
- 9. IF APPLICABLE, THE PUBLIC PARKING GARAGE FLOOR MUST COMPLY WITH USBC 406.2.6 AND DRAIN THROUGH OIL SEPARATORS OR TRAPS TO AVOID ACCUMULATION OF EXPLOSIVE VAPORS IN BUILDING DRAINS OR SEWERS AS PROVIDED FOR IN THE PLUMBING CODE (USBC 2901). THIS PARKING GARAGE IS CLASSIFIED AS AN S-2, GROUP 2, PUBLIC GARAGE.
- 10. THIS PROJECT IS NOT LOCATED IN A COMBINED SEWER AREA.
- 11. THIS SITE DOES NOT CONTAIN ANY AREAS PREVIOUSLY MAPPED AS MARINE CLAYS.

# COMPLETE STREETS INFORMATION:

	NEW	UPGRADED
CROSSWALKS (NUMBER)	N/A	N/A
STANDARD	N/A	N/A
HIGH VISIBILITY	N/A	N/A
CURB RAMPS	N/A	N/A
SIDEWALKS (LF)	N/A	100
BICYCLE PARKING (NUMBER SPACES)	15	N/A
PUBLIC/VISITOR	N/A	N/A
PRIVATE/GARAGE	15	N/A
BICYCLE PATHS (LF)	N/A	N/A
PEDESTRIAN SIGNALS	N/A	N/A

# DITILDING CODE ANALYSIS.

BUILDING COL	DE ANALYSIS:
USE:	MIXED USE (PARKING GARAGE,
	MERCANTILE, RESIDENTIAL)
USE GROUP:	M, S-2, R-2
TYPE OF CONSTRUCTION:	VB OVER IA
NUMBER OF STORIES:	4
FLOOR AREA (GROSS):	54,476 SF
FLOOR AREA (NET):	51,072 SF
BUILDING FOOT PRINT AREA:	17,870 SF
BUILDING HEIGHT:	45 FT
FIRE SUPRESSION/DETECTION:	FULLY SPRINKLERED, NFPA 13

# **VICINITY MAP** SCALE: 1"=200' TAX PARCEL NUMBERS: #034.04-14-10 (#1800) #034.04-14-18 (#1800R)

# PROJECT DESCRIPTION NARRATIVE

THIS PROJECT PROPOSES THE REDEVELOPMENT OF THE SUBJECT SITE CURRENTLY OCCUPIED BY A 1-STORY COMMERCIAL BUILDING AND SURFACE PARKING LOT. THE PROPOSED DEVELOPMENT INCLUDES A 4-STORY, MIXED-USE RETAIL/RESIDENTIAL BUILDING AND 1-LEVEL UNDERGROUND PARKING GARAGE. THIS PROJECT IS LOCATED IN THE MOUNT VERNON AVENUE URBAN OVERLAY ZONE AND WILL CONFORM TO THE MOUNT VERNON AVENUE DESIGN GUIDELINES AND MOUNT VERNON AVENUE BUSINESS AREA PLAN.

# SPECIAL USE PERMITS/ZONING MODIFICATIONS:

DEVELOPMENT SPECIAL USE PERMIT (DSUP) REQUESTS:

- A FORM-BASED SUP TO WAIVE CL ZONE RULES PER SECTION 6-606(A)
- A PARKING REDUCTION PER 8-200B FROM 70 TO 55 SPACES A WAIVER OF LOADING SPACE REQUIREMENTS FOR THE RETAIL USE.
- A MODIFICATION FOR THE ZONE TRANSITION LINE SETBACK FOR A PORTION OF THE NORTH PROPERTY LINE
- A TIER 1 TRANSPORTATION MANAGEMENT PLAN SPECIAL USE PERMIT

MOUNT VERNON AVENUE OVERLAY DISTRICT DEVIATION REQUESTS: AN INCREASE IN LOT OCCUPANCY FROM 60% TO 67%

ZONING MODIFICATION REQUESTS:

• A REDUCTION OF THE REQUIRED FRONT YARD SETBACK FROM 10.0' TO 8.7' (PER SECT 7-1006(A))

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# **ZONING TABULATIONS**

EXISTING COMMERCIAL

(PER THE MOUNT VERNON AVENUE URBAN OVERLAY ZONE) 1. ZONE OF SITE: #1800 CL/COMMERCIAL LOW ZONE (MOUNT VERNON AVENUE URBAN OVERLAY ZONE)

PROPOSED MIXED USE RETAIL/RESIDENTIAL

GARAGE

51,072 SQ. FT. 20,036 SQ. FT.

3. LOT AREA: <u>26,793 SF OR 0.6151 AC</u> MINIMUM LOT AREA: \_\_\_\_\_\_N/A 4. NUMBER OF DWELLING UNITS: 2-BEDROOM 1-BEDROOM TOTAL 49 5. UNITS PER ACRE: ALLOWED: N/A PROPOSED: 80 6. FLOOR AREA: NET FLOOR AREA 48,8<u>03 SQ. FT.</u> 52,009 SQ. FT. 2,467 SQ. FT. 2,269 SQ. FT.

54,476 SQ. FT.

21,384 SQ. FT.

7. FLOOR AREA RATIO: PERMITTED N/A PROPOSED 1.91 (51,072 SQ.FT.)

GARAGE

\*8. LOT OCCUPANCY: ALLOWED 60% (16,075 SF BUILDING FOOTPRINT) PROPOSED 67% (17,870 SF BUILDING FOOTPRINT)

9. OPEN SPACE (SEE DETAIL ON SHEET 2): 6,698.25 SQ. FT. (25.0%) PROPOSED 8,350 SQ. FT. (31.2%, GROUND LEVEL) 6,100 SQ. FT. (22.8%, ABOVE GRADE) 14,450 SQ. FT. (53.9%)

10. AVERAGE FINISHED GRADE: 45.68 \*11. HEIGHT: PERMITTED: 40.0'

PROVIDED: <u>45.0'</u> (SEE SHEETS A400 & A401)

\*12. YARDS (SEE SHEETS 5, A700, & A701):

10' (PER SECTION 7-1006(A)) SIDE (NORTH) 1:1 HEIGHT RATIO (45.0')(PER SECT 7-902(A)) SIDE (SOUTH) 0.0' 1:1 HEIGHT RATIO (45.0')(PER SECT 7-902(A)) 13. FRONTAGE:

14. TRIP GENERATION: EXISTING 317 VPD PEAK AM 31 AVG VEH TRIP ENDS PEAK PM 47 AVG VEH TRIP ENDS

\*15. PARKING TABULATION (SEE SHEET 6):

PARKING REQUIRED: RESIDENTIAL 1 SPACE / 1BR UNIT =  $1 \times 38 =$ 2 SPACES / 2BR UNIT = 2 x 11 = 5% REDUCTION FOR FOUR OR MORE BUS STOPS WITHIN 1/4 MILE OF ENTRANCE= -3TOTAL RESIDENTIAL PARKING REQUIRED = 57

RETAIL SPACES, DISTRICT 2 1.1 SPACES/210 SQ.FT. FLOOR AREA = 12.9 OR 13

TOTAL REQUIRED PARKING SPACES = PARKING PROVIDED: RETAIL (ABOVE GRADE): STANDARD SPACES COMPACT SPACES ACCESSIBLE SPACES RESIDENTIAL (BELOW GRADE): STANDARD SPACES COMPACT SPACES ACCESSIBLE SPACES

55 \*16. LOADING SPACES: REQUIRED \_\_\_1\_\_\_ PROPOSED \_\_\_0\_

17. MOUNT VERNON AVENUE DESIGN GUIDELINES COMPLIANCE REFERENCES: -UPPER FLOORS FOR RESIDENTIAL USE: SHEETS A200, A201 -GROUND FLOOR RETAIL USE: SHEET A200

-"STEPPING" DOWN OF BUILDING HEIGHT FROM ADJACENT RESIDENTIAL PROPERTIES: SHEETS A700, A701 -BUFFERS FOR ADJOINING RESIDENCES: SHEET L1.01 -PROTECTION OF ADJACENT RESIDENTIAL NEIGHBORHOODS: SHEET L1.01

-ENHANCED STREETSCAPE AND PEDESTRIAN AMENITIES: SHEETS 5, L1.01 -PROTECTION AND ENHANCEMENT OF MVA UNIQUE CHARACTER: SHEETS L1.01, A104

SEE SPECIAL USE PERMITS/ZONING MODIFICATIONS NOTE FOR DETAILED INFORMATION.

ATTORNEY:

524 KING STREET

# OWNER/DEVELOPER

BREVIC DEVELOPMENT LLC 1800 AND 1800R MT VERNON AVE ALEXANDRIA. VA 22301 INSTRUMENT #140000076

DEVELOPER: BREVIC DEVELOPMENT LLC 6007 MAYFAIR LANE ALEXANDRIA, VA 22310 (571) 233-8585 CONTACT: VICTOR BONOMI


PLAN PREPARED BY: R.C. FIELDS & ASSOCIATES, INC. 730 S. WASHINGTON STREET ALEXANDRIA, VA 22314 (703) 549-6422 CONTACT: ANDREA SPRUCH

ALEXANDRIA, VA 22314 (703) 836-1000 CONTACT: DUNCAN BLAIR ARCHITECT: HEFFNER ARCHITECTS, PC **604 MONTGOMERY STREET** ALEXANDRIA, VA 22314

LAND CARROLL AND BLAIR, P.C.

(703) 549-7766 CONTACT: SHAWN GLERUM tudua Joshah ANDREA SPRUCH Lic. No. 047863


APPROVED 2014-0019 SPECIAL USE PERMIT NO. DEPARTMENT OF PLANNING & ZONING DATE RECORDED DEED BOOK NO. DATE

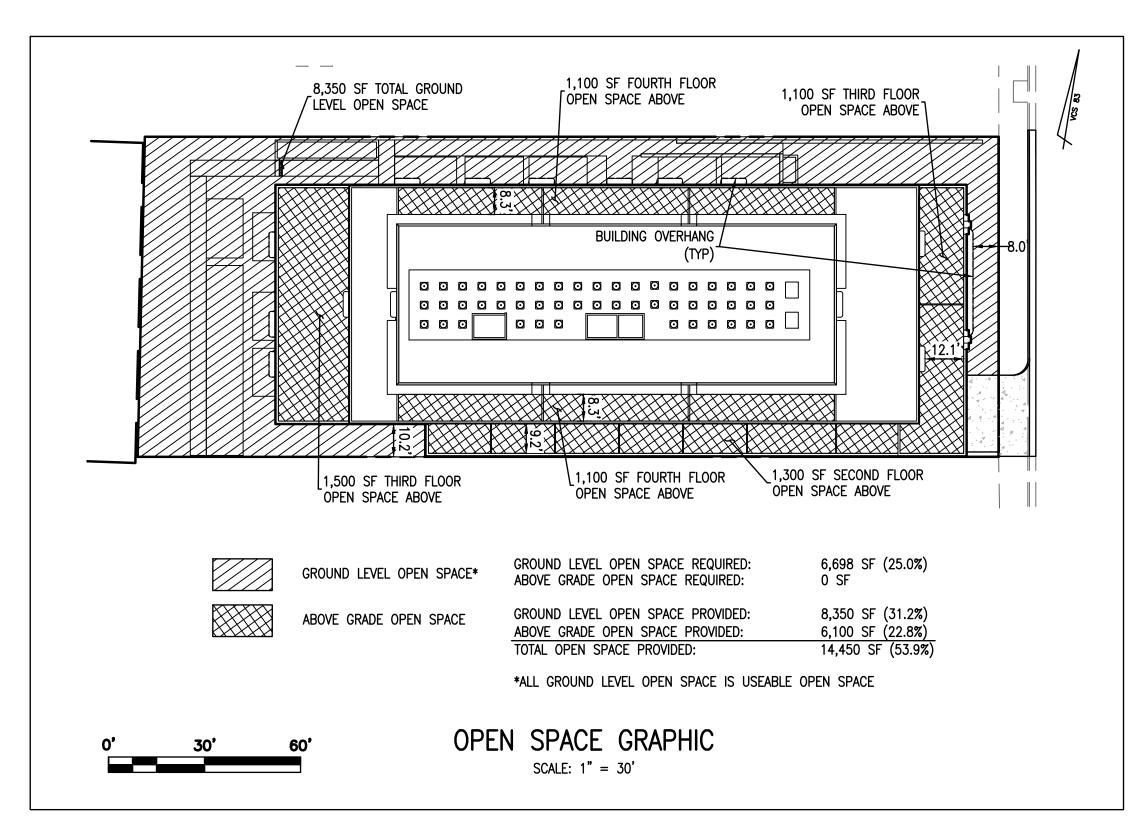


# SECTION 6-403 COMPLIANCE NOTE:

SECTION 6-403 STATES "IN ALL HEIGHT DISTRICTS, THE ALLOWABLE HEIGHT OF A BUILDING AT ANY POINT SHALL NOT EXCEED TWICE THE DISTANCE FROM THE FACE OF THE BUILDING AT THAT POINT TO THE CENTERLINE OF THE STREET FACING SUCH BUILDING." SEE DETAIL BELOW FOR SECTION SHOWING COMPLIANCE.

SECTION 6-403 DETAIL:

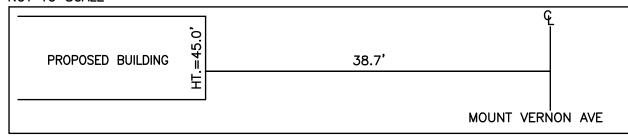



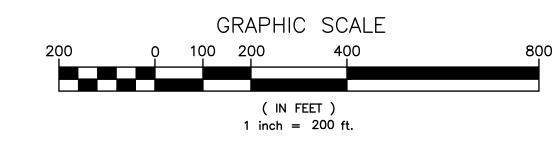

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EXISTING UTILITIES SHOWN ON THIS PLAN TAKEN FROM AVAILABLE RECORDS AND/OR FROM FIELD OBSERVATIONS. FOR EXACT LOCATIONS OF EXISTING UNDERGROUND UTILITIES, NOTIFY "MISS UTILITY" AT 1-800-552-7001, 72 HOURS BEFORE THE START OF ANY EXCAVATION OR CONSTRUCTION.

LOCATION AND DEPTH OF ALL EXISTING UNDERGROUND UTILITIES TO BE VERIFIED BY CONTRACTOR PRIOR TO CONSTRUCTION. INTERFERENCE OR DISRUPTION OF SAME WILL NOT BE THE RESPONSIBILITY OF THIS OFFICE.

ALL CONSTRUCTION SHALL CONFORM TO THE CURRENT STANDARDS AND SPECIFICATION OF THE CITY OF ALEXANDRIA, VIRGINIA.

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APPROVED SPECIAL USE PERMIT NO. 20	014-0019								
DEPARTMENT OF PLANNING & ZONING									
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SITE PLAN NO.  DIRECTOR  CHAIRMAN, PLANNING COMMISSION	DATE								

INSTRUMENT NO. DEED BOOK NO. DATE

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ANDREA SPRUCH Lic. No. 047863

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DEVELOPMENT

AUGUST 18, 2015

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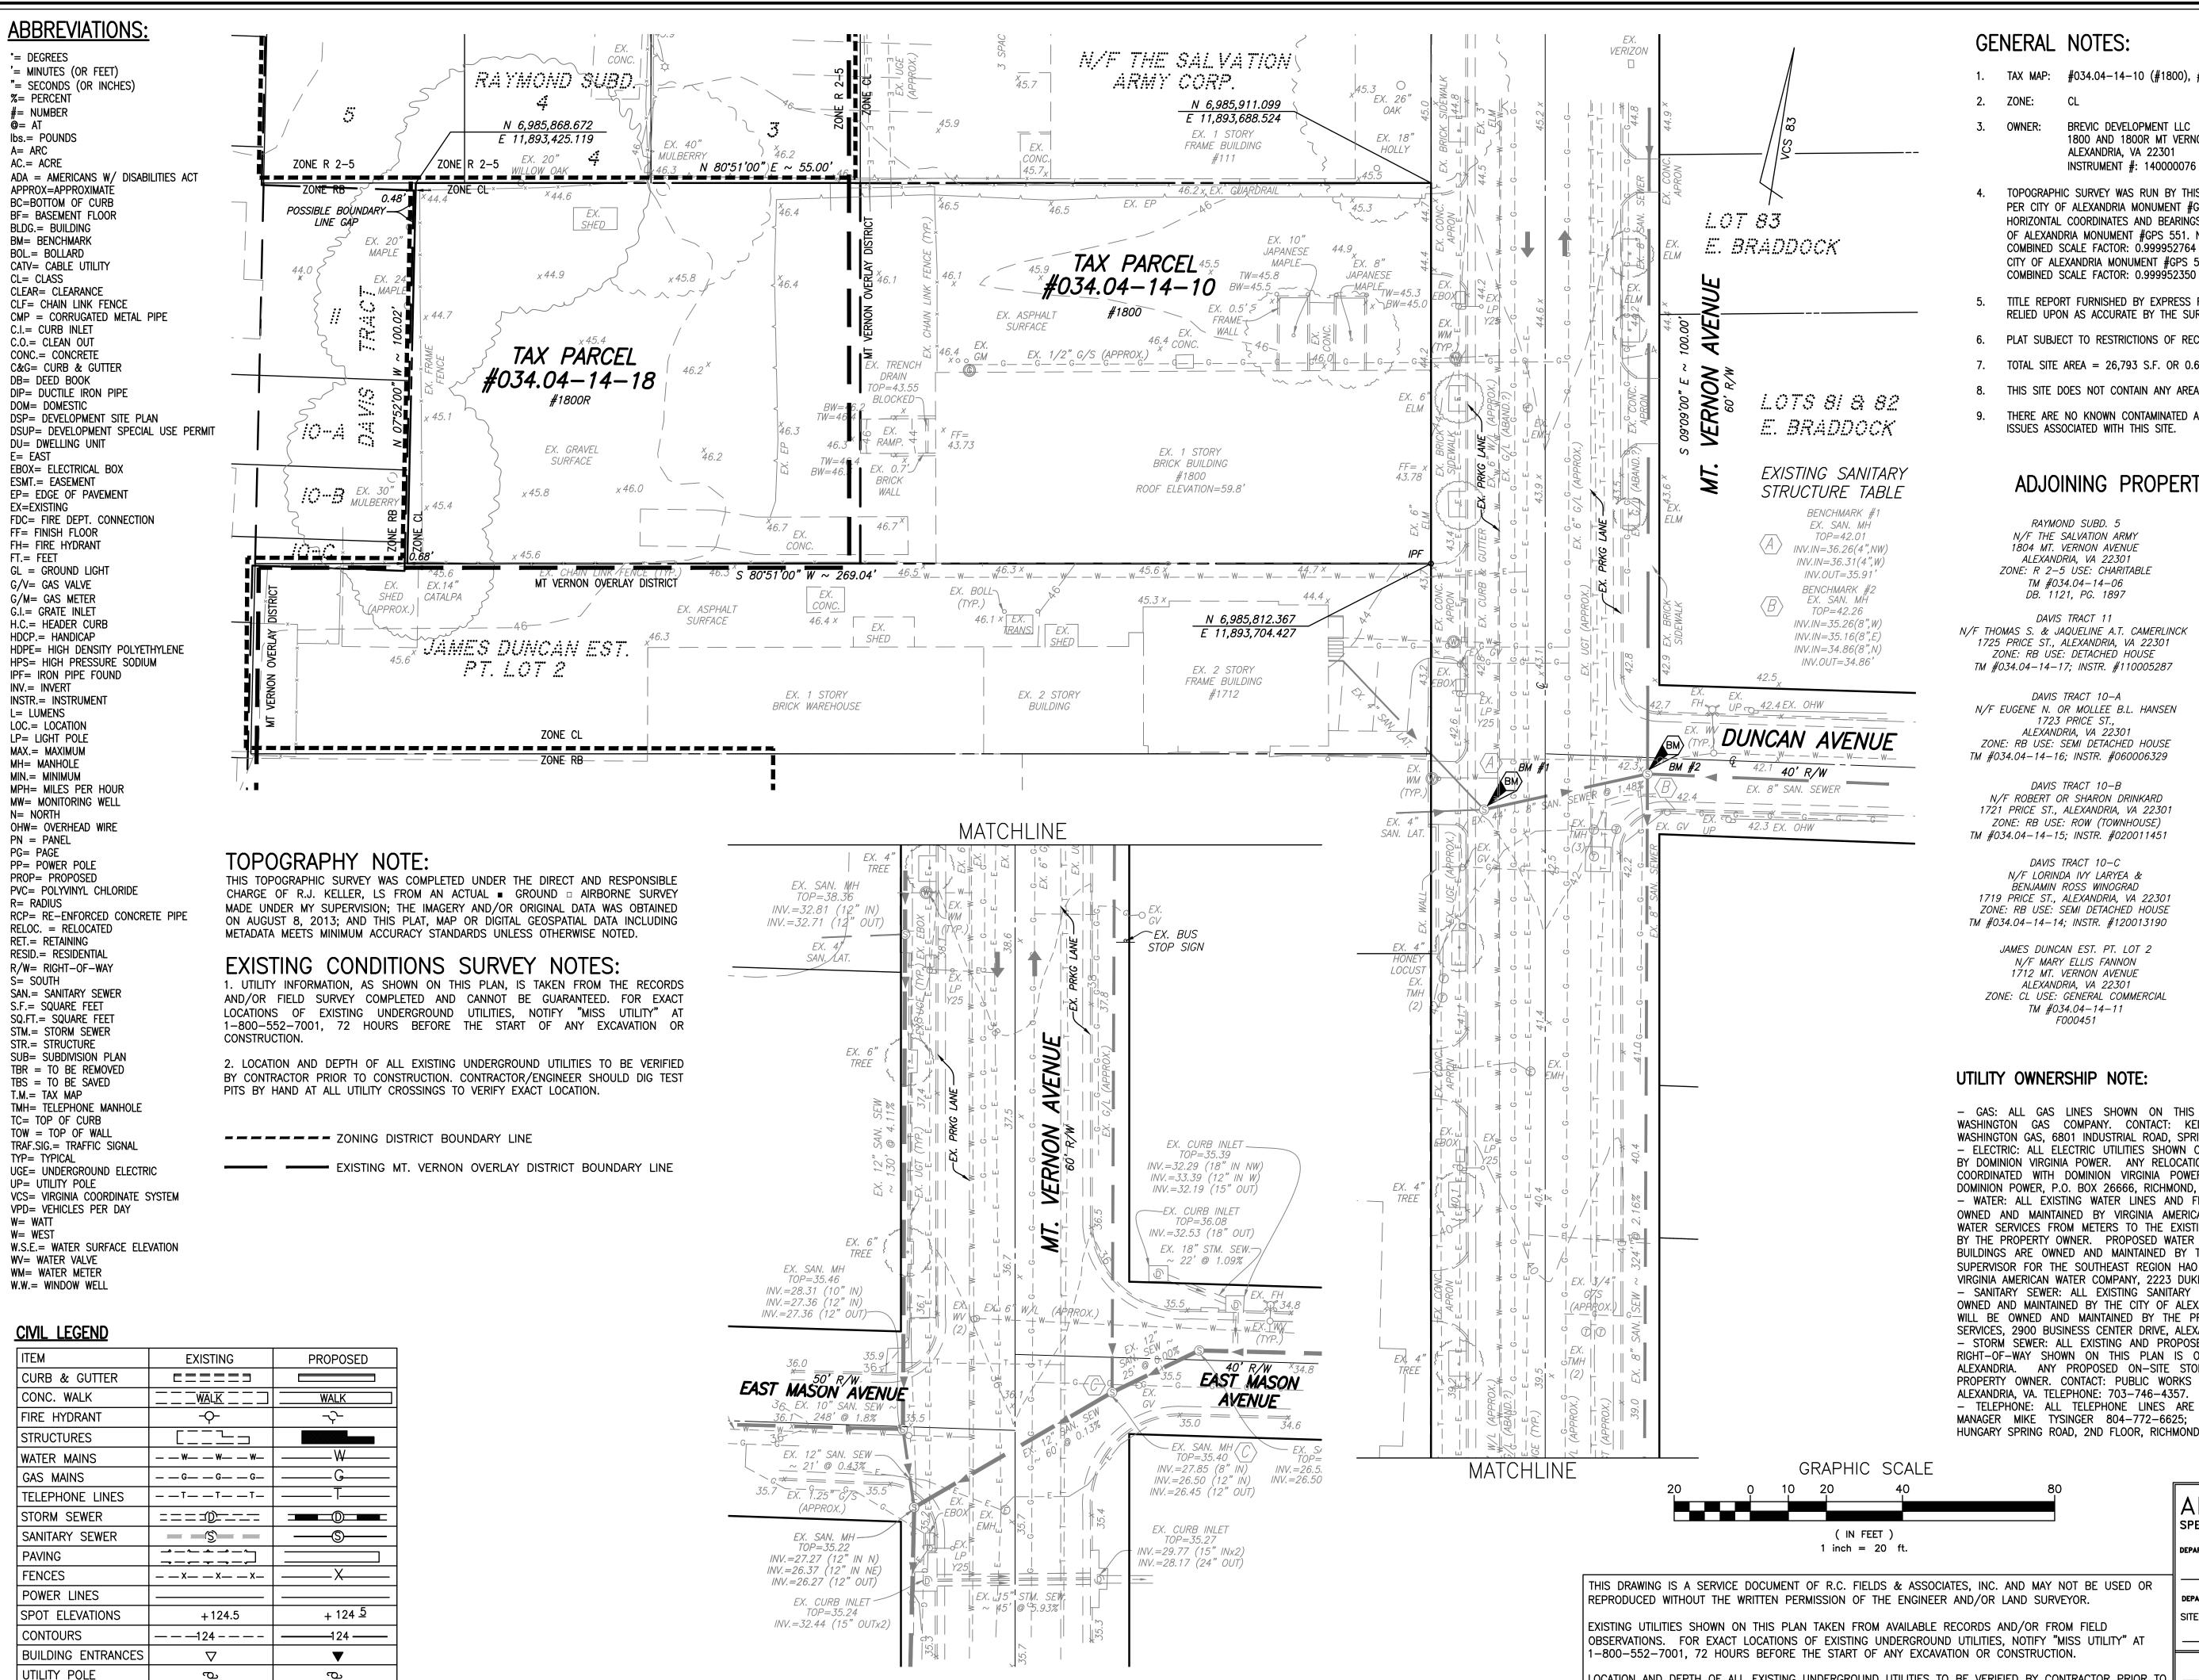
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SHEET 2 OF 11

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PROPOSED BUILDING # H



**GENERAL NOTES:** 

1. TAX MAP: #034.04-14-10 (#1800), #034.04-10-18 (#1800R)

BREVIC DEVELOPMENT LLC 1800 AND 1800R MT VERNON AVE ALEXANDRIA, VA 22301 INSTRUMENT #: 140000076

TOPOGRAPHIC SURVEY WAS RUN BY THIS FIRM. VERTICAL DATUM USED = NAVD '88 PER CITY OF ALEXANDRIA MONUMENT #GPS 551. ELEVATION = 44.65' HORIZONTAL COORDINATES AND BEARINGS REFERENCED TO VCS '83 DATUM PER CITY OF ALEXANDRIA MONUMENT #GPS 551. N6,986,581.62 E11,893,630.43 COMBINED SCALE FACTOR: 0.999952764 CITY OF ALEXANDRIA MONUMENT #GPS 552. N6,984,170.11 E11,893,975.88

TITLE REPORT FURNISHED BY EXPRESS RECORDING & TITLE, DATED 7/1/2013 AND IS RELIED UPON AS ACCURATE BY THE SURVEYOR.

6. PLAT SUBJECT TO RESTRICTIONS OF RECORD.

TOTAL SITE AREA = 26,793 S.F. OR 0.6151 AC.

THIS SITE DOES NOT CONTAIN ANY AREAS PREVIOUSLY MAPPED AS MARINE CLAYS.

THERE ARE NO KNOWN CONTAMINATED AREAS, CONTAMINATED SOILS OR ENVIRONMENTAL ISSUES ASSOCIATED WITH THIS SITE.

# ADJOINING PROPERTY INFORMATION:

RAYMOND SUBD. 5 N/F THE SAIVATION ARMY 1804 MT. VERNON AVENUE ALEXANDRIA. VA 22301 ZONE: R 2-5 USE: CHARITABLE TM #034.04-14-06 DB. 1121, PG. 1897

DAVIS TRACT 11 N/F THOMAS S. & JAQUELINE A.T. CAMERLINCK 1725 PRICE ST., ALEXANDRIA, VA 22301 ZONE: RB USE: DETACHED HOUSE TM #034.04-14-17; INSTR. #110005287

DAVIS TRACT 10-A N/F EUGENE N. OR MOLLEE B.L. HANSEN 1723 PRICE ST., ALEXANDRIA, VA 22301 ZONE: RB USE: SEMI DETACHED HOUSE TM #034.04-14-16; INSTR. #060006329

DAVIS TRACT 10-B N/F ROBERT OR SHARON DRINKARD 1721 PRICE ST., ALEXANDRIA, VA 22301 ZONE: RB USE: ROW (TOWNHOUSE) TM #034.04-14-15; INSTR. #020011451

DAVIS TRACT 10-C N/F LORINDA IVY LARYEA & BENJAMIN ROSS WINOGRAD 1719 PRICE ST., ALEXANDRIA, VA 22301 ZONE: RB USE: SEMI DETACHED HOUSE TM #034.04-14-14; INSTR. #120013190

JAMES DUNCAN EST. PT. LOT 2 N/F MARY ELLIS FANNON 1712 MT. VERNON AVENUE ALEXANDRIA, VA 22301 ZONE: CL USE: GENERAL COMMERCIAL TM #034.04-14-11 F000451

RAYMOND SUBD. 4 N/F THE SALVATION ARMY 1804 MT. VERNON AVENUE ALEXANDRIA, VA 22301 ZONE: R 2-5 USE: CHARITABLE TM #034.04-14-07 DB. 693, PG. 425

RAYMOND SUBD. 3 N/F SALVATION ARMY CORP. 1804 MT. VERNON AVENUE ALEXANDRIA, VA 22301 ZONE: R 2-5 USE: CHARITABLE TM #034.04-14-08 DB. 619, PG. 50

N/F THE SALVATION ARMY CORP 1804 MT. VERNON AVENUE ALEXANDRIA, VA 22301 ZONE: CL USE: CHARITABLE TM #034.04-14-09 DB. 649, PG. 218

FOUR MILE RUN ASSOCIATES 1707 MT VERNON AVE ALEXANDRIA, VA 22301 ZONE: CL USE: AUTO DEALERSHIP TM #034.04-13-19; INSTR. #13350000

LOTS 81 & 82 E. BRADDOCK

LOT 83 E. BRADDOCK N/F SALVATION ARMY CORP. 1804 MT. VERNON AVENUE ALEXANDRIA, VA 22301 ZONE: CL USE: CHARITABLE TM #034.04-13-20; INSTR #13340000

# **UTILITY OWNERSHIP NOTE:**


- GAS: ALL GAS LINES SHOWN ON THIS PLAN ARE OWNED AND MAINTAINED BY WASHINGTON GAS COMPANY. CONTACT: KEN McCONKEY 703-750-4756; ADDRESS: WASHINGTON GAS, 6801 INDUSTRIAL ROAD, SPRINGFIELD, VA 22151.

- ELECTRIC: ALL ELECTRIC UTILITIES SHOWN ON THIS PLAN ARE OWNED AND MAINTAINED BY DOMINION VIRGINIA POWER. ANY RELOCATION OF EXISTING POLES AND LINES WILL BE COORDINATED WITH DOMINION VIRGINIA POWER. CONTACT: 1-866-366-4357; ADDRESS: DOMINION POWER, P.O. BOX 26666, RICHMOND, VA 23261

- WATER: ALL EXISTING WATER LINES AND FIRE HYDRANTS SHOWN ON THIS PLAN ARE OWNED AND MAINTAINED BY VIRGINIA AMERICAN WATER COMPANY (V.A.W.C.). EXISTING WATER SERVICES FROM METERS TO THE EXISTING BUILDINGS ARE OWNED AND MAINTAINED BY THE PROPERTY OWNER. PROPOSED WATER SERVICES FROM METERS TO THE PROPOSED BUILDINGS ARE OWNED AND MAINTAINED BY THE PROPERTY OWNER. CONTACT: NETWORK SUPERVISOR FOR THE SOUTHEAST REGION HAO (STEVEN) CHEN 703-706-3889; ADDRESS: VIRGINIA AMERICAN WATER COMPANY, 2223 DUKE STREET, ALEXANDRIA, VA 22314.

 SANITARY SEWER: ALL EXISTING SANITARY SEWER LINES SHOWN ON THIS PLAN ARE OWNED AND MAINTAINED BY THE CITY OF ALEXANDRIA. THE PROPOSED SANITARY LATERAL WILL BE OWNED AND MAINTAINED BY THE PROPERTY OWNER. CONTACT: PUBLIC WORKS SERVICES, 2900 BUSINESS CENTER DRIVE, ALEXANDRIA, VA. TELEPHONE: 703-746-4357. - STORM SEWER: ALL EXISTING AND PROPOSED STORM SEWER LOCATED IN THE PUBLIC RIGHT-OF-WAY SHOWN ON THIS PLAN IS OWNED AND MAINTAINED BY THE CITY OF ALEXANDRIA. ANY PROPOSED ON-SITE STORM SEWER WILL BE MAINTAINED BY THE PROPERTY OWNER. CONTACT: PUBLIC WORKS SERVICES, 2900 BUSINESS CENTER DRIVE, ALEXANDRIA, VA. TELEPHONE: 703-746-4357.

- TELEPHONE: ALL TELEPHONE LINES ARE OWNED BY VERIZON. CONTACT: SECTION MANAGER MIKE TYSINGER 804-772-6625; ADDRESS: VERIZON VIRGINIA, INC., 3011 HUNGARY SPRING ROAD, 2ND FLOOR, RICHMOND, VA 23228.

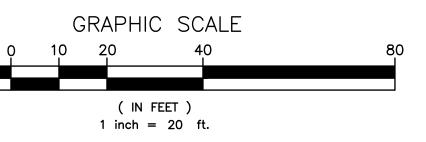

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LOCATION AND DEPTH OF ALL EXISTING UNDERGROUND UTILITIES TO BE VERIFIED BY CONTRACTOR PRIOR TO

CONSTRUCTION. INTERFERENCE OR DISRUPTION OF SAME WILL NOT BE THE RESPONSIBILITY OF THIS OFFICE. ALL CONSTRUCTION SHALL CONFORM TO THE CURRENT STANDARDS AND SPECIFICATION OF THE CITY OF ALEXANDRIA, VIRGINIA. © 2015 R.C. FIELDS & ASSOCIATES, INC.

**APPROVED** SPECIAL USE PERMIT NO. 2014-0019

DEED BOOK NO.

DATE

DEPARTMENT OF PLANNING & ZONING

DEPARTMENT OF TRANSPORTATION & ENVIRONMENTAL SERVICES

DATE RECORDED

INSTRUMENT NO.

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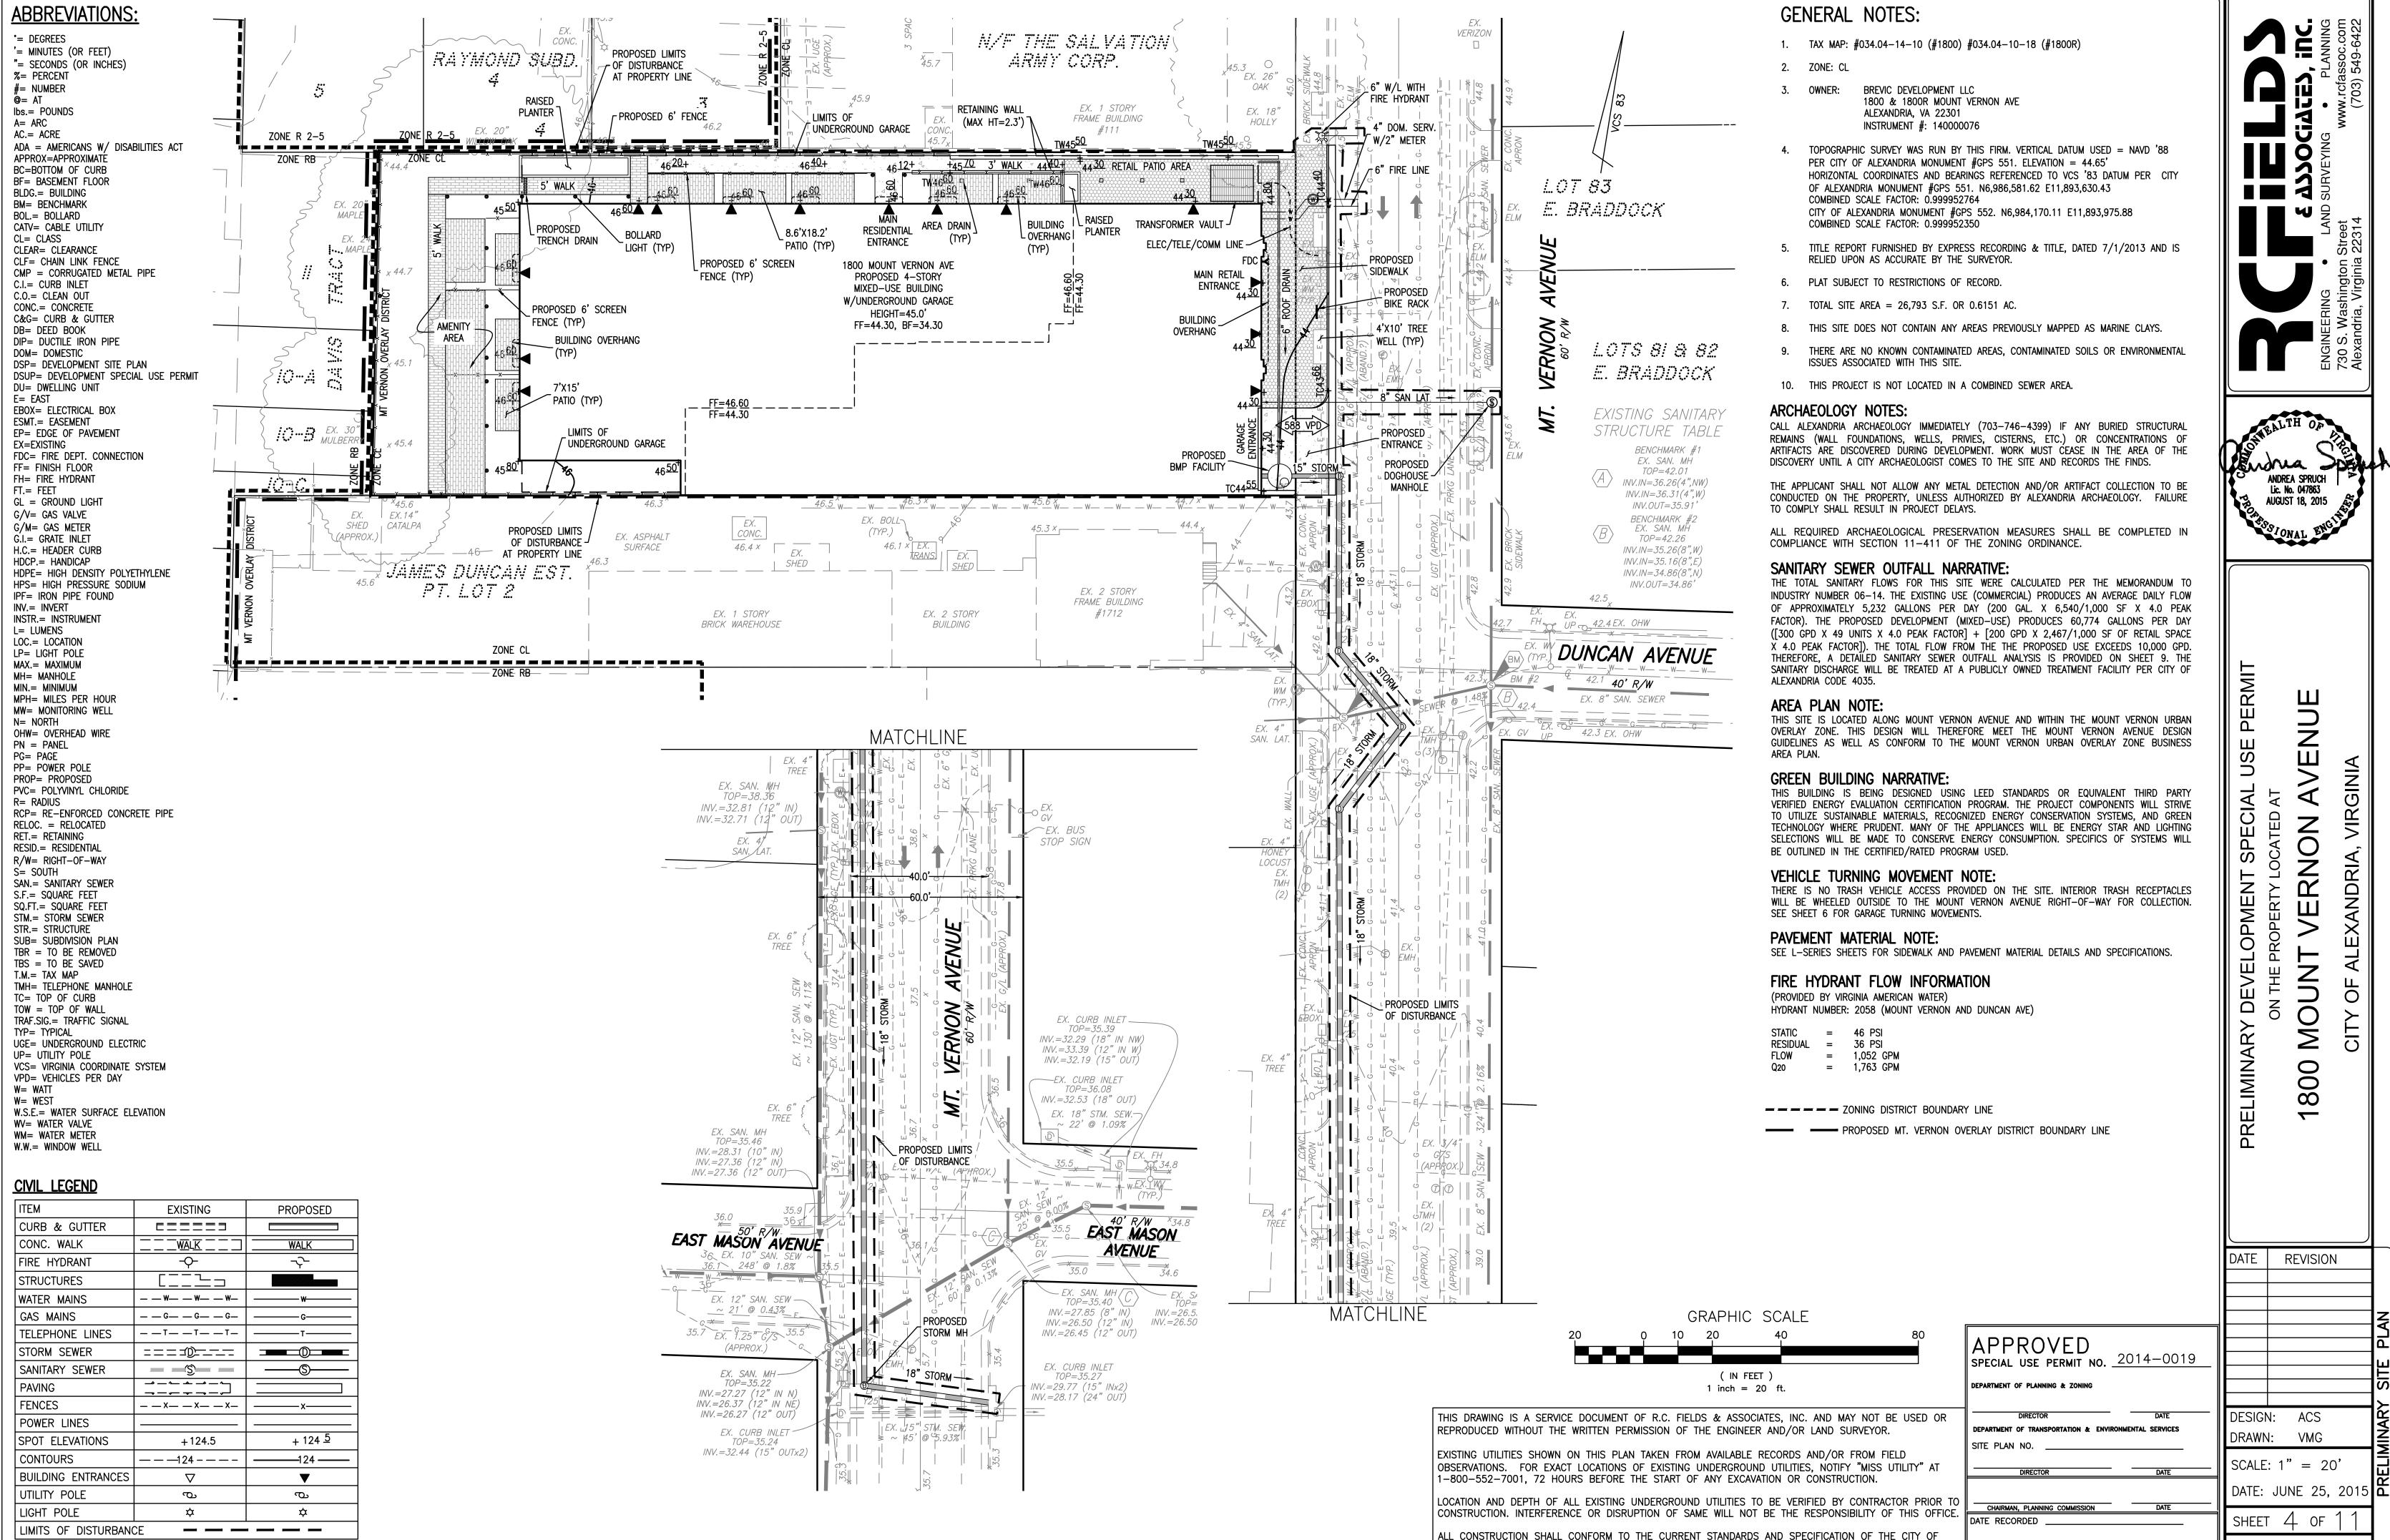
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ALEXANDRIA, VIRGINIA.

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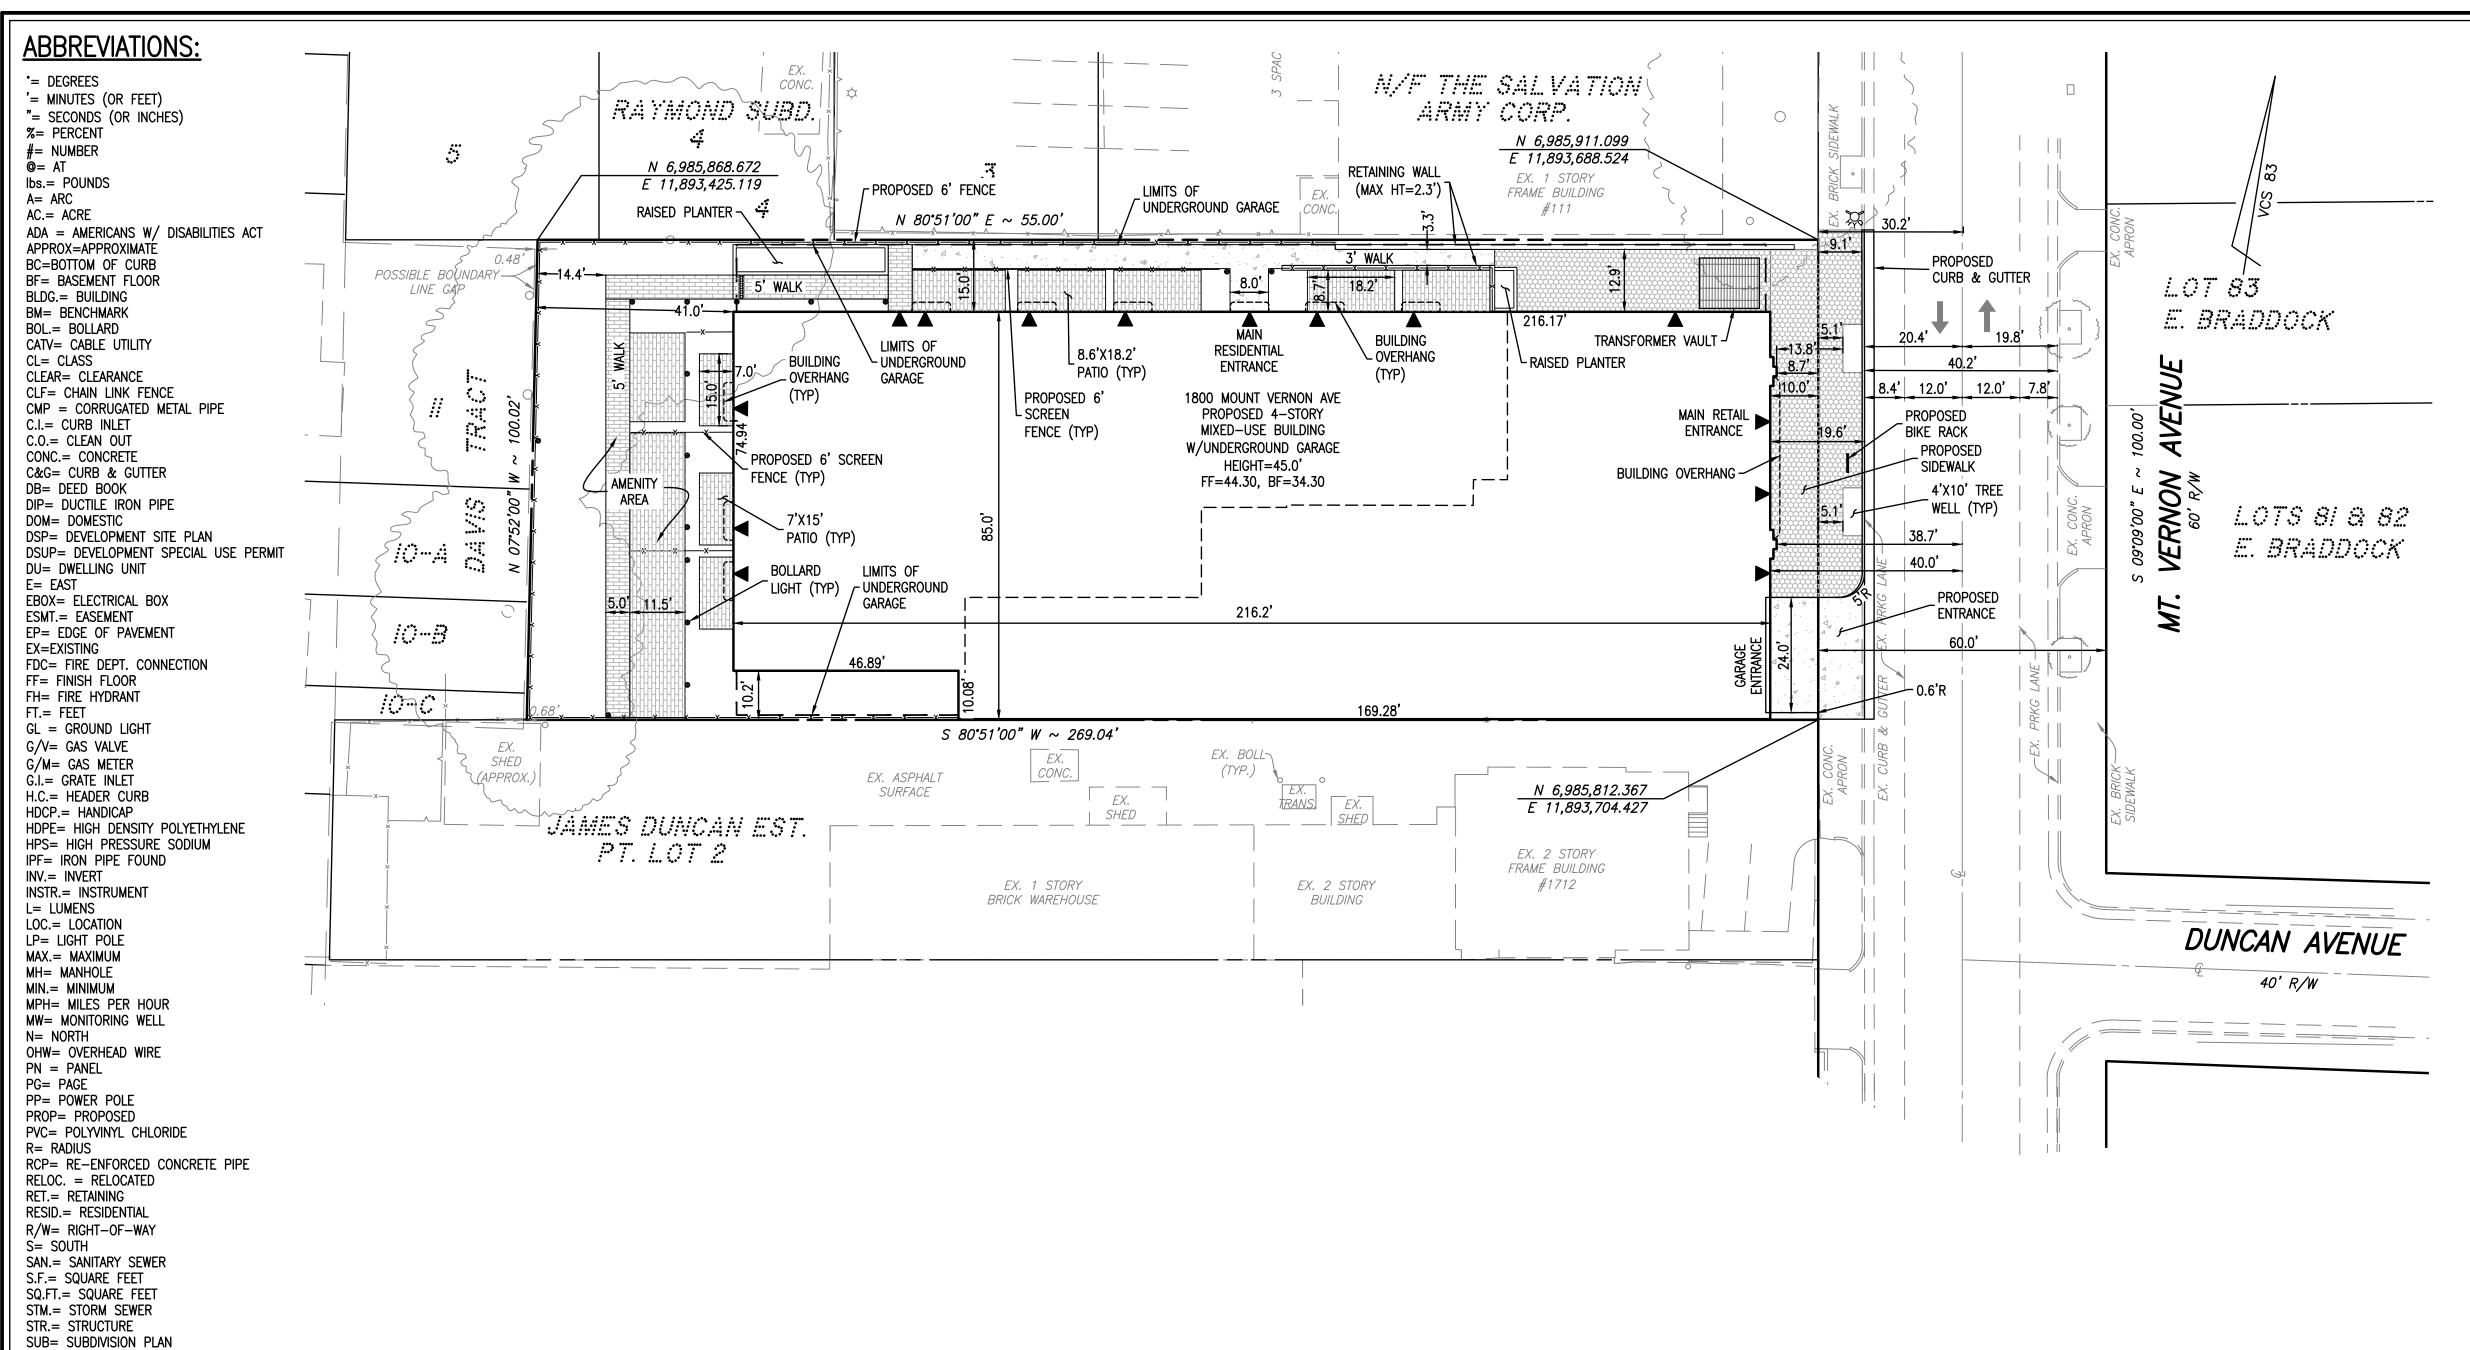
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REVISION



# **GENERAL NOTES:**

- 1. TAX MAP: #034.04-14-10 (#1800) #034.04-10-18 (#1800R)
- 2. ZONE: CL
  - BREVIC DEVELOPMENT LLC 1800 & 1800R MOUNT VERNON AVE ALEXANDRIA, VA 22301 INSTRUMENT #: 140000076
- TOPOGRAPHIC SURVEY WAS RUN BY THIS FIRM. VERTICAL DATUM USED = NAVD '88 PER CITY OF ALEXANDRIA MONUMENT #GPS 551. ELEVATION = 44.65' HORIZONTAL COORDINATES AND BEARINGS REFERENCED TO VCS '83 DATUM PER CITY OF ALEXANDRIA MONUMENT #GPS 551. N6,986,581.62 E11,893,630.43 COMBINED SCALE FACTOR: 0.999952764 CITY OF ALEXANDRIA MONUMENT #GPS 552. N6,984,170.11 E11,893,975.88 COMBINED SCALE FACTOR: 0.999952350
- TITLE REPORT FURNISHED BY EXPRESS RECORDING & TITLE, DATED 7/1/2013 AND IS RELIED UPON AS ACCURATE BY THE SURVEYOR.
- 6. PLAT SUBJECT TO RESTRICTIONS OF RECORD.
- 7. TOTAL SITE AREA = 26,793 S.F. OR 0.6151 AC.
- THIS SITE DOES NOT CONTAIN ANY AREAS PREVIOUSLY MAPPED AS MARINE CLAYS.
- THERE ARE NO KNOWN CONTAMINATED AREAS, CONTAMINATED SOILS OR ENVIRONMENTAL ISSUES ASSOCIATED WITH THIS SITE.
- 10. THIS PROJECT IS NOT LOCATED IN A COMBINED SEWER AREA.

## ARCHAEOLOGY NOTES:

CALL ALEXANDRIA ARCHAEOLOGY IMMEDIATELY (703-746-4399) IF ANY BURIED STRUCTURAL REMAINS (WALL FOUNDATIONS, WELLS, PRIVIES, CISTERNS, ETC.) OR CONCENTRATIONS OF ARTIFACTS ARE DISCOVERED DURING DEVELOPMENT. WORK MUST CEASE IN THE AREA OF THE DISCOVERY UNTIL A CITY ARCHAEOLOGIST COMES TO THE SITE AND RECORDS THE FINDS.

THE APPLICANT SHALL NOT ALLOW ANY METAL DETECTION AND/OR ARTIFACT COLLECTION TO BE CONDUCTED ON THE PROPERTY, UNLESS AUTHORIZED BY ALEXANDRIA ARCHAEOLOGY. FAILURE TO COMPLY SHALL RESULT IN PROJECT DELAYS.

ALL REQUIRED ARCHAEOLOGICAL PRESERVATION MEASURES SHALL BE COMPLETED IN COMPLIANCE WITH SECTION 11-411 OF THE ZONING ORDINANCE.

udua Dringh ANDREA SPRUCH Lic. No. 047863 AUGUST 18, 2015

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REVISION

SPECIAL USE PERMIT NO. 2014-0019

DEPARTMENT OF TRANSPORTATION & ENVIRONMENTAL SERVICES

INSTRUMENT NO. DEED BOOK NO. DATE

DEPARTMENT OF PLANNING & ZONING

DATE RECORDED

DESIGN:

DRAWN: SCALE: 1" = 20'DATE: JUNE 25, 2015 0

5 OF

GRAPHIC SCALE ( IN FEET ) 1 inch = 20 ft.

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PLAN.dwg
DIMENSIONS
SITE
Plan\05
J:\2013\1388\DWG\DELIV\Preliminary Plan\05 SITE DIMENSIONS PLAN.dw; Tue, Aug 18 2015 — 8:33:58am

TBR = TO BE REMOVEDTBS = TO BE SAVEDT.M.= TAX MAP

TC= TOP OF CURB

TOW = TOP OF WALLTRAF.SIG.= TRAFFIC SIGNAL

TYP= TYPICAL

W = WATT

W= WEST

UP= UTILITY POLE

WV= WATER VALVE WM= WATER METER W.W.= WINDOW WELL

<u>CIVIL LEGEND</u>

CURB & GUTTER

BUILDING ENTRANCES

LIMITS OF DISTURBANCE

UTILITY POLE

LIGHT POLE

CONC. WALK

FIRE HYDRANT

TMH= TELEPHONE MANHOLE

UGE= UNDERGROUND ELECTRIC

VPD= VEHICLES PER DAY

VCS= VIRGINIA COORDINATE SYSTEM

W.S.E.= WATER SURFACE ELEVATION

TINE THE WAY	Υ	Υ
STRUCTURES		
WATER MAINS	w w w	w
GAS MAINS	G G G	G
TELEPHONE LINES	TTT_	т——т
STORM SEWER	====0	
SANITARY SEWER	5	S
PAVING		
FENCES	xxx_	x
POWER LINES		
SPOT ELEVATIONS	+124.5	+ 124 <del>5</del>

**EXISTING** 

\_\_\_<u>WALK</u> \_\_ \_

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PROPOSED

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CONTOURS — — — 124 — — — — 124 <del>— — —</del> 124 <del>— — —</del>

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APPROVED SPECIAL USE PERMIT NO. 2014-0019 DESIGN: ACS

FILE:


DEPARTMENT OF PLANNING & ZONING

INSTRUMENT NO. DEED BOOK NO. DATE

SCALE: 1" = 20' DATE: JUNE 25, 2015 SHEET 6 OF 1

6.0<del>' | - - |</del> STANDARD DRIVE AISLE RAMP DOWN

FIRST FLOOR PARKING PLAN (RETAIL PARKING)

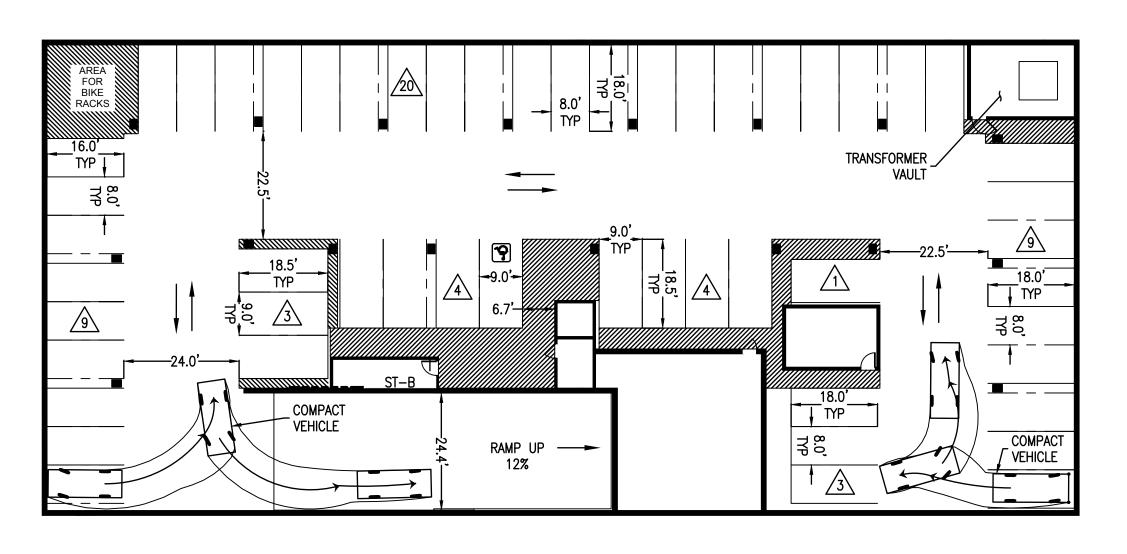

BASEMENT FLOOR PARKING PLAN (RESIDENTIAL PARKING)


# PARKING LEGEND

NUMBER OF SPACES IN ROW


ACCESSIBLE PARKING SPACE

# PARKING TABULATION:

RETAIL:
STANDARD SPACES
COMPACT SPACES
ACCESSIBLE SPACES RESIDENTIAL:
STANDARD SPACES
COMPACT SPACES
ACCESSIBLE SPACES

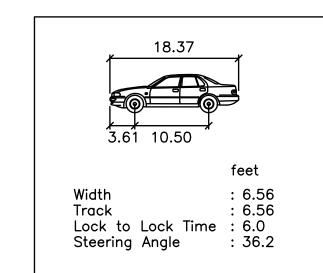

STANDARD VEHICLE
NOT TO SCALE

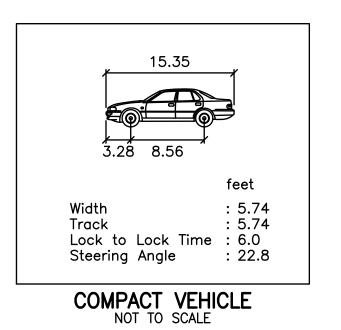

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LOCATION AND DEPTH OF ALL EXISTING UNDERGROUND UTILITIES TO BE VERIFIED BY CONTRACTOR PRIOR TO LOCATION AND DEPTH OF ALL EXISTING UNDERGROUND UTILITIES TO BE VEIGHTED BY CONTRUCTION. INTERFERENCE OR DISRUPTION OF SAME WILL NOT BE THE RESPONSIBILITY OF THIS OFFICE. DATE RECORDED

DRAINAGE AREA	IMPERVIOUS	PERVIOUS	TOTAL
PROJECT AREA	0.5240	0.0911	0.6151
ON-SITE TREATED	0.4600	0.0250	0.4850
OFF-SITE TREATED	0.0000	0.0000	0.0000
TOTAL TREATED	0.4600	0.0250	0.4850
ON-SITE IMPERVIOUS AREAS	N/A		
DISCONNECTED BY A VEGETATIVE BUFFER	1177		
TOTAL TREATED OR DISCONNECTED			0.4850

# WATER QUALITY VOLUME DEFAULT:

TOTAL WQV TREATED: NO

PROPOSED IMPERVIOUS: 0.5240 AC TREATMENT OF FIRST HALF INCH OF RUNOFF: 1,815 X 0.5240 = 951 CU. FT. WQV REQUIRED

WATER TREATMENT ON-SITE									
BMP TYPE	AREA TREATED BY BMP (ACRES)	IMPERVIOUS AREA TREATED BY BMP (ACRES)	BMP EFFICIENCY (%)						
HYDRO-DYNAMIC	0.4850	0.4600	20%						

WATER QUALITY VOLUME REQUIRED = 951 CU. FT. WATER QUALITY VOLUME TREATED = 1.609 CU. FT. PERCENT OF WATER QUALITY VOLUME TREATED = 169% DETENTION ON SITE: NO (PROPOSED DECREASE IN IMPERVIOUS AREA) PROJECT IS WITHIN WHICH WATERSHED? TIMBER BRANCH PROJECT DISCHARGES TO WHICH BODY OF WATER? HOOFFS RUN

RUNOFF FROM THE PROPOSED BUILDING AND AREAS NORTH OF THE BUILDING WILL BE COLLECTED AND PIPED TO A PROPOSED HYDRO-DYNAMIC BEST MANAGEMENT PRACTICE (BMP). THE TREATED RUNOFF WILL OUTFALL TO THE PROPOSED STORM SEWER SYSTEM WITHIN THE MOUNT VERNON AVENUE RIGHT-OF-WAY. THE REMAINDER OF THE SITE WILL SURFACE FLOW NORTHWEST TO THE PRICE STREET RIGHT-OF-WAY.

POST-DEVELOPMENT CONDITIONS REDUCE THE OVERALL IMPERVIOUS AREA WITHIN THE PROJECT SITE (SEE STORMWATER RUNOFF COMPUTATIONS THIS SHEET) WHICH GENERATES AN OVERALL DECREASE OF RUNOFF. GIVEN THE REDUCTION OF SITE RUNOFF AS A RESULT OF THE PROPOSED SITE IMPROVEMENTS, ONSITE STORMWATER DETENTION IS NOT REQUIRED.

A HYDRO-DYNAMIC BMP IS PROPOSED TO TREAT THE MAJORITY OF RUNOFF FROM PROPOSED IMPERVIOUS AREA OF THE SITE. A CONTRIBUTION TO THE ALEXANDRIA WATER QUALITY IMPROVEMENT FUND WILL BE MADE FOR THE PORTION OF THE WATER QUALITY VOLUME THAT IS NOT TREATED BY THE PROPOSED BMP. COMPUTATIONS DEMONSTRATING COMPLIANCE WITH THE STORM WATER QUALITY MANAGEMENT PERFORMANCE REQUIREMENTS PER CITY CODE SECTION 13-109E ARE PROVIDED ON THIS SHEET.

## Drainage Area A Drainage Area A Land Cover (acres) B Soils C Soils D Soils Land Cover Rv Forest/Open Space (acres) -- undisturbed, protected forest/open 0.00 space or reforested land 0.00 Managed Turf (acres) -- disturbed, graded for yards or other turf to be 0.25 mowed/managed 0.00 0.00 0.46 0.46 0.95 Impervious Cover (acres) 0.49 Post Development Treatment Volume (cf)

Apply Practices that Remove Pollutants but Do Not Reduce Runoff Volume (excluding Untreated areas treated by Runoff from Remaining Load from Phosphorus |Phosphorus |Remaining Upstream RR Runoff Phosphorus Upstream RR Load to Removed By Phosphorus | Practices (cf) | Reduction (cf) | Volume (cf) | Efficiency (%) | Practices (lbs.) | Practice (lbs.) Description of Credit practices) Practice 14. Manufactured BMP impervious acres draining to 0% runoff volume reduction turf acres draining to device | 0% runoff volume reduction 14. Hydro-dynamic BMP Facility

**Phosphorous** TOTAL PHOSPHOROUS LOAD REDUCTION REQUIRED (LB/YEAR) **RUNOFF REDUCTION (cf)** PHOSPHOROUS LOAD REDUCTION ACHIEVED (LB/YR) ADJUSTED POST-DEVELOPMENT PHOSPHOROUS LOAD (TP) (lb/yr) REMAINING PHOSPHOROUS LOAD REDUCTION (LB/YR) NEEDED CONGRATULATIONS!! YOU EXCEEDED THE TARGET REDUCTION BY 0.2 LB/YEAR

# STORM WATER QUALITY NARRATIVE: (CITY CODE SECTION 13-109E COMPLIANCE)

THE PROPOSED REDEVELOPMENT (APPROXIMATELY 0.73 ACRES OF DISTURBANCE) GENERATES A NET DECREASE OF IMPERVIOUS AREA FROM PRE-DEVELOPMENT CONDITIONS. PER CITY CODE SECTION 13-109E-(4)(a), DEVELOPMENT OF PRIOR DEVELOPED LANDS DISTURBING LESS THAN 1 ACRE AND RESULTING IN NO NET INCREASE IN IMPERVIOUS AREA MUST RESULT IN A 10% DECREASE IN PHOSPHORUS LOADING BELOW THE PRE-DEVELOPMENT TOTAL PHOSPHORUS LOAD.

THE VIRGINIA RUNOFF REDUCTION METHOD WAS UTILIZED TO DETERMINE THE STORM WATER QUALITY MANAGEMENT PERFORMANCE REQUIREMENTS FOR THIS PROJECT. COMPUTATIONS PROVIDED ON THIS SHEET DEMONSTRATE A NET DECREASE OF IMPERVIOUS AREA. THIS WILL RESULT IN A 7.7% ([(1.30-1.19)/1.30]\*100=8.5%) REDUCTION OF PHOSPHOROUS LOAD FROM THE SITE. FURTHÉRMORE, A HYDRODYNAMIC BMP IS PROPOSED FOR THIS SITE, RESULTING IN AN ADDITIONAL PHOSPHOROUS LOAD REDUCTION. THE PROJECT WILL RESULT IN AN OVERALL PHOSPHOROUS LOAD REDUCTION OF 23.1% ([1-(0.99/1.30)]\*100% = 23.8%). THIS TREATMENT AMOUNT IS GREATER THAN THE REQUIRED 10% REMOVAL (SEE SPREADSHEET ON THIS SHEET). THEREFORE THE WATER QUALITY MANAGEMENT PERFORMANCE REQUIREMENTS FOR THE PROPOSED DEVELOPMENT PER CITY CODE SECTION 13-109E-(4)(a) HAVE BEEN

# STORMWATER RUNOFF COMPUTATIONS:

VIRGINIA RUNOFF REDUCTION METHOD (PER TR-20, TYPE II, 24-HOUR STORM):

I. PROJECT AREA = 26,793 SQ.FT. OR 0.6151 ACRES

EXISTING IMPERVIOUS AREA = 26,010 SQ.FT. OR 0.5971 ACRES PROPOSED IMPERVIOUS AREA = 22,825 SQ.FT. OR 0.5240 ACRES

II. WEIGHTED CURVE NUMBER (CN) CALCULATIONS:

CN PRE-DEVELOPMENT = [(0.5971\*98)+(0.0180\*80)]/0.6151 = 97CN POST-DEVELOPMENT = [(0.5240\*98)+(0.0911\*80)]/0.6151 = 95

III. PRE-DEVELOPMENT PEAK DISCHARGES: (Tc = 5 MINS.)


PEAK Q2 PRE-DEVELOPMENT = 2.77 cfs PEAK Q10 PRE-DEVELOPMENT = 4.58 cfs


IV. POST-DEVELOPMENT PEAK DISCHARGES (Tc = 5 MINS.)

PEAK Q2 POST-DEVELOPMENT = 2.67 cfs PEAK Q10 POST-DEVELOPMENT = 4.50 cfs

V. POST-DEVELOPMENT DECREASES

Q2 = 0.10 cfsQ10 = 0.08 cfs BMP SIZING CHART

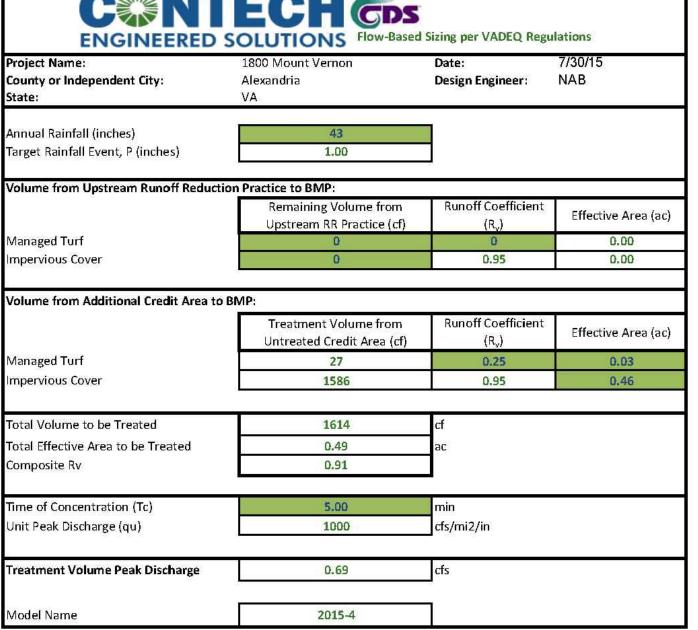

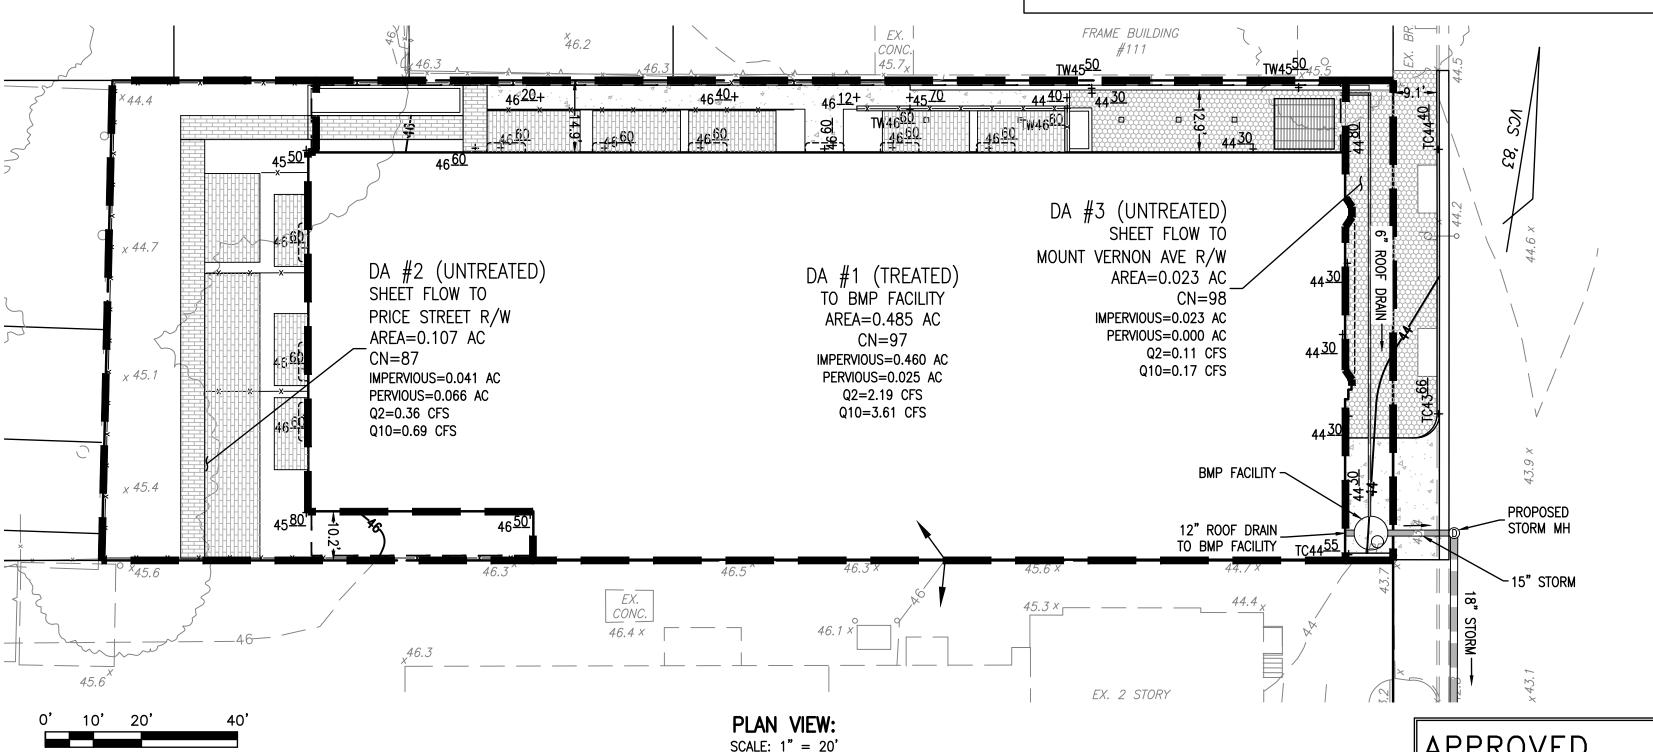

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APPROVED SPECIAL USE PERMIT NO. 2014-0019

DEPARTMENT OF PLANNING & ZONING DEPARTMENT OF TRANSPORTATION & ENVIRONMENTAL SERVICES SITE PLAN NO.

LOCATION AND DEPTH OF ALL EXISTING UNDERGROUND UTILITIES TO BE VERIFIED BY CONTRACTOR PRIOR TO DATE RECORDED NSTRUMENT NO. DEED BOOK NO. DATE

Lic. No. 047863 **AUGUST 18, 2015** 

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PRE-DEVELOPMENT CONDITIONS:

THE 0.62 ACRE SITE IS LOCATED IN THE POTOMAC RIVER WATERSHED. IN EXISTING CONDITIONS, THE SITE CONSISTS OF A RETAIL BUILDING AND ASPHALT/GRAVEL PARKING AREAS. THERE IS NO VEGETATED OPEN SPACE.

APPROXIMATELY TWO-THIRDS OF THE PROJECT SITE DRAINS TO THE MOUNT VERNON AVENUE RIGHT-OF-WAY. RUNOFF DRAINS SOUTH VIA THE MOUNT VERNON AVENUE CURB AND GUTTER THEN ENTERS A CURB INLET APPROXIMATELY 425' SOUTH OF THE SITE AT THE SOUTHWEST CORNER OF THE INTERSECTION OF EAST MASON AVENUE AND MOUNT VERNON AVENUE. DRAINAGE IS THEN CONVEYED SOUTH VIA THE CITY MAINTAINED STORM SEWER SYSTEM, EVENTUALLY OUTFALLING TO HOOFF'S RUN. THE REMAINDER OF THE PROJECT SITES SHEET FLOWS NORTHWEST TOWARDS PRICE STREET. RUNOFF THEN ENTERS A CURB INLET AT THE INTERSECTION OF PRICE STREET AND BELLEFONTE AVENUE WHERE IT IS CONVEYED WEST, THEN SOUTH VIA THE CITY MAINTAINED STORM SYSTEM. THIS SYSTEM EVENTUALLY OUTFALLS TO HOOFF'S RUN.

POST-DEVELOPMENT CONDITIONS:

THE REDEVELOPMENT OF THE PROJECT SITE PROPOSES THE CONSTRUCTION OF A 4-STORY MIXED-USE BUILDING WITH RETAIL SPACE AND 49 DWELLING UNITS. OVERALL IMPERVIOUS AREA WILL DECREASE WITH THE PROPOSED CONSTRUCTION.

RUNOFF FROM THE PROPOSED BUILDING AND THE MAJORITY OF THE PATIO PAVEMENT AREAS WILL BE COLLECTED AND PIPED TO A PROPOSED STORM SEWER SYSTEM IN MOUNT VERNON AVENUE. THE PROPOSED SYSTEM WILL TIE INTO THE EXISTING CITY MAINTAINED STORM SEWER AT THE CURB INLET AT THE SOUTHEAST CORNER OF THE INTERSECTION OF MOUNT VERNON AVENUE AND EAST MASON AVENUE. DRAINAGE IS THEN CONVEYED SOUTH VIA THE CITY MAINTAINED STORM SEWER SYSTEM, EVENTUALLY OUTFALLING TO HOOFF'S RUN AS IN PRE-DEVELOPMENT CONDITIONS. A SMALL PORTION OF SITE RUNOFF WILL CONTINUE TO SHEET FLOW NORTHWEST TO THE CURB INLET ON THE CORNER OF PRICE STREET AND BELLEFONTE AVENUE. ONCE WITHIN THE CITY MAINTAINED STORM SEWER SYSTEM, THIS RUNOFF WILL BE CONVEYED SOUTH, OUTFALLING TO HOOFF'S RUN AS IN PRE-DEVELOPMENT CONDITIONS.

POST-DEVELOPMENT CONDITIONS REDUCE THE OVERALL IMPERVIOUS AREA WITHIN THE PROJECT SITE (SEE STORMWATER RUNOFF COMPUTATIONS, SHEET 7). THE REDUCED IMPERVIOUS AREA WILL NOT CAUSE THE PRE-DEVELOPMENT PEAK RUNOFF RATE FROM THE 10-YEAR, 24-HOUR STORM TO INCREASE (OUTFALL AND HYDRAULIC GRADE LINE COMPUTATIONS TO BE PROVIDED WITH SUBSEQUENT SUBMISSIONS). THEREFORE, THE PROPOSED DEVELOPMENT WILL NOT ADVERSELY IMPACT THE EXISTING DOWNSTREAM STORM SEWER SYSTEM AND COMPLIES WITH VIRGINIA EROSION AND SEDIMENT CONTROL REGULATION 4 VAC 50-30-40.19(C)(3).

DETAILED LIMITS OF ANALYSIS AND OUTFALL COMPUTATIONS PER CITY CODE SECTION 13-109F WILL BE PROVIDED WITH SUBSEQUENT SUBMISSIONS. HOWEVER, DUE TO THE REDUCED POST-DEVELOPMENT RUNOFF RATE FOR THE 10-YEAR, 24-HOUR STORM, THE PROJECT POST-DEVELOPMENT RUNOFF WILL NOT EXACERBATE ANY EXISTING DOWNSTREAM CAPACITY CONDITIONS AND NO OFFSITE IMPROVEMENTS TO THE SYSTEM ARE REQUIRED.


# STORMWATER MANAGEMENT NARRATIVE: (CITY CODE SECTION 13-109F COMPLIANCE)


THIS PROJECT PROPOSES AN OVERALL DECREASE OF SITE IMPERVIOUS AREA. SITE RUNOFF IS COLLECTED IN A SERIES OF ROOF DRAIN PIPES AND AREA DRAINS THAT OUTFALL TO A PROPOSED STORM SEWER SYSTEM LOCATED IN MOUNT VERNON AVENUE. THIS PROPOSED SYSTEM CONNECTS TO AN EXISTING UNDERGROUND STORM SEWER SYSTEM LOCATED APPROXIMATELY 425' SOUTH OF THE SITE. THERE ARE NO CHANNEL CONVEYANCE SYSTEMS LOCATED WITHIN THE LIMITS OF ANALYSIS FOR THE DEVELOPMENT. PER CITY CODE SECTION 13-109F-2, COMPUTATIONS FOR THE EXISTING SYSTEM (TO BE PROVIDED WITH THE FINAL SITE PLAN SUBMISSION) DEMONSTRATE THAT THE EXISTING UNDERGROUND STORM SEWER SYSTEM DOES NOT CONTAIN THÉ PRE-DEVELOPMENT PEAK FLOW RATE FOR THE 10-YEAR, 24-HOUR STORM PER NRCS TR-20 HYDRAULIC METHODOLOGY (SEE PEAK FLOW RATE CALCULATIONS PROVIDED ON THIS SHEET). THEREFORE, STORMWATER REQUIREMENTS FOR THIS SITE FALL UNDER CITY CODE SECTION 13-109F-2(b) CRITERIA DUE TO SITE DRAINAGE OUTFALLING TO A STORMWATER CONVEYANCE SYSTEM THAT CURRENTLY EXPERIENCES LOCALIZED FLOODING DURING THE 10-YEAR 24-HOUR STORM EVENT.

DUE TO AN OVERALL DECREASE OF SITE IMPERVIOUS AREA, THE SITE RELEASES A POST-DEVELOPMENT PEAK RATE FOR THE 10-YEAR 24-HOUR STORM EVENT THAT IS LESS THAN THE PRE-DEVELOPMENT PEAK FLOW RATE FROM THE 10-YEAR 24-HOUR STORM EVENT (PER CITY CODE SECTION 13-109F-2(b)(ii), SEE COMPUTATIONS PROVIDED ON SHEET 7). THERE IS NO RUNOFF VOLUME INCREASE IN THE FORM OF SHEET FLOW RESULTING FROM PERVIOUS AREAS, DISCONNECTED IMPERVIOUS AREAS OR FROM PHYSICAL SPREADING OF CONCENTRATED FLOW ASSOCIATED WITH THE REDEVELOPMENT OF THIS SITE. THEREFORE, THE SMALL PORTION OF THE RUNOFF THAT EXITS THE SITE IN THE FORM OF SHEET FLOW WILL HAVE NO ADVERSE IMPACTS ON DOWN-GRADIENT PROPERTIES OR RESOURCES. ALL PERVIOUS AREAS ON THE SITE WERE ASSUMED TO BE IN GOOD HYDROLOGIC CONDITION FOR PURPOSES OF COMPUTING PRE-DEVELOPMENT RUNOFF.

PER SECTION 13-109F-2(d)(i), A DRAINAGE SHED BOUNDARY ANALYSIS OF THE SITE OUTFALL HAS BEEN PROVIDED TO A POINT THAT IS 150' DOWNSTREAM OF A POINT WHERE THE RECEIVING PIPE IS JOINED BY ANOTHER THAT HAS A DRAINAGE AREA THAT IS AT LEAST 90 PERCENT OF THE SIZE OF THE FIRST DRAINAGE AREA AT THE POINT OF CONFLUENCE (SEE OUTFALL MAP ON THIS SHEET). THIS WILL CONSTITUTE THE LIMITS OF ANALYSIS FOR THE PROJECT. OUTFALL COMPUTATIONS FOR THE EXISTING UNDERGROUND STORM SEWER SYSTEM WILL BE PROVIDED WITH THE FINAL SITE PLAN SUBMISSION.

BASED ON THE ABOVE MENTIONED JUSTIFICATIONS, THE STORMWATER MANAGEMENT CRITERIA FOR THE PROPOSED DEVELOPMENT COMPLIES WITH THE CHANNEL PROTECTION (NOT APPLICABLE TO THIS APPLICATION) AND FLOOD PROTECTION REQUIREMENTS PER CITY CODE SECTION 13-109F.

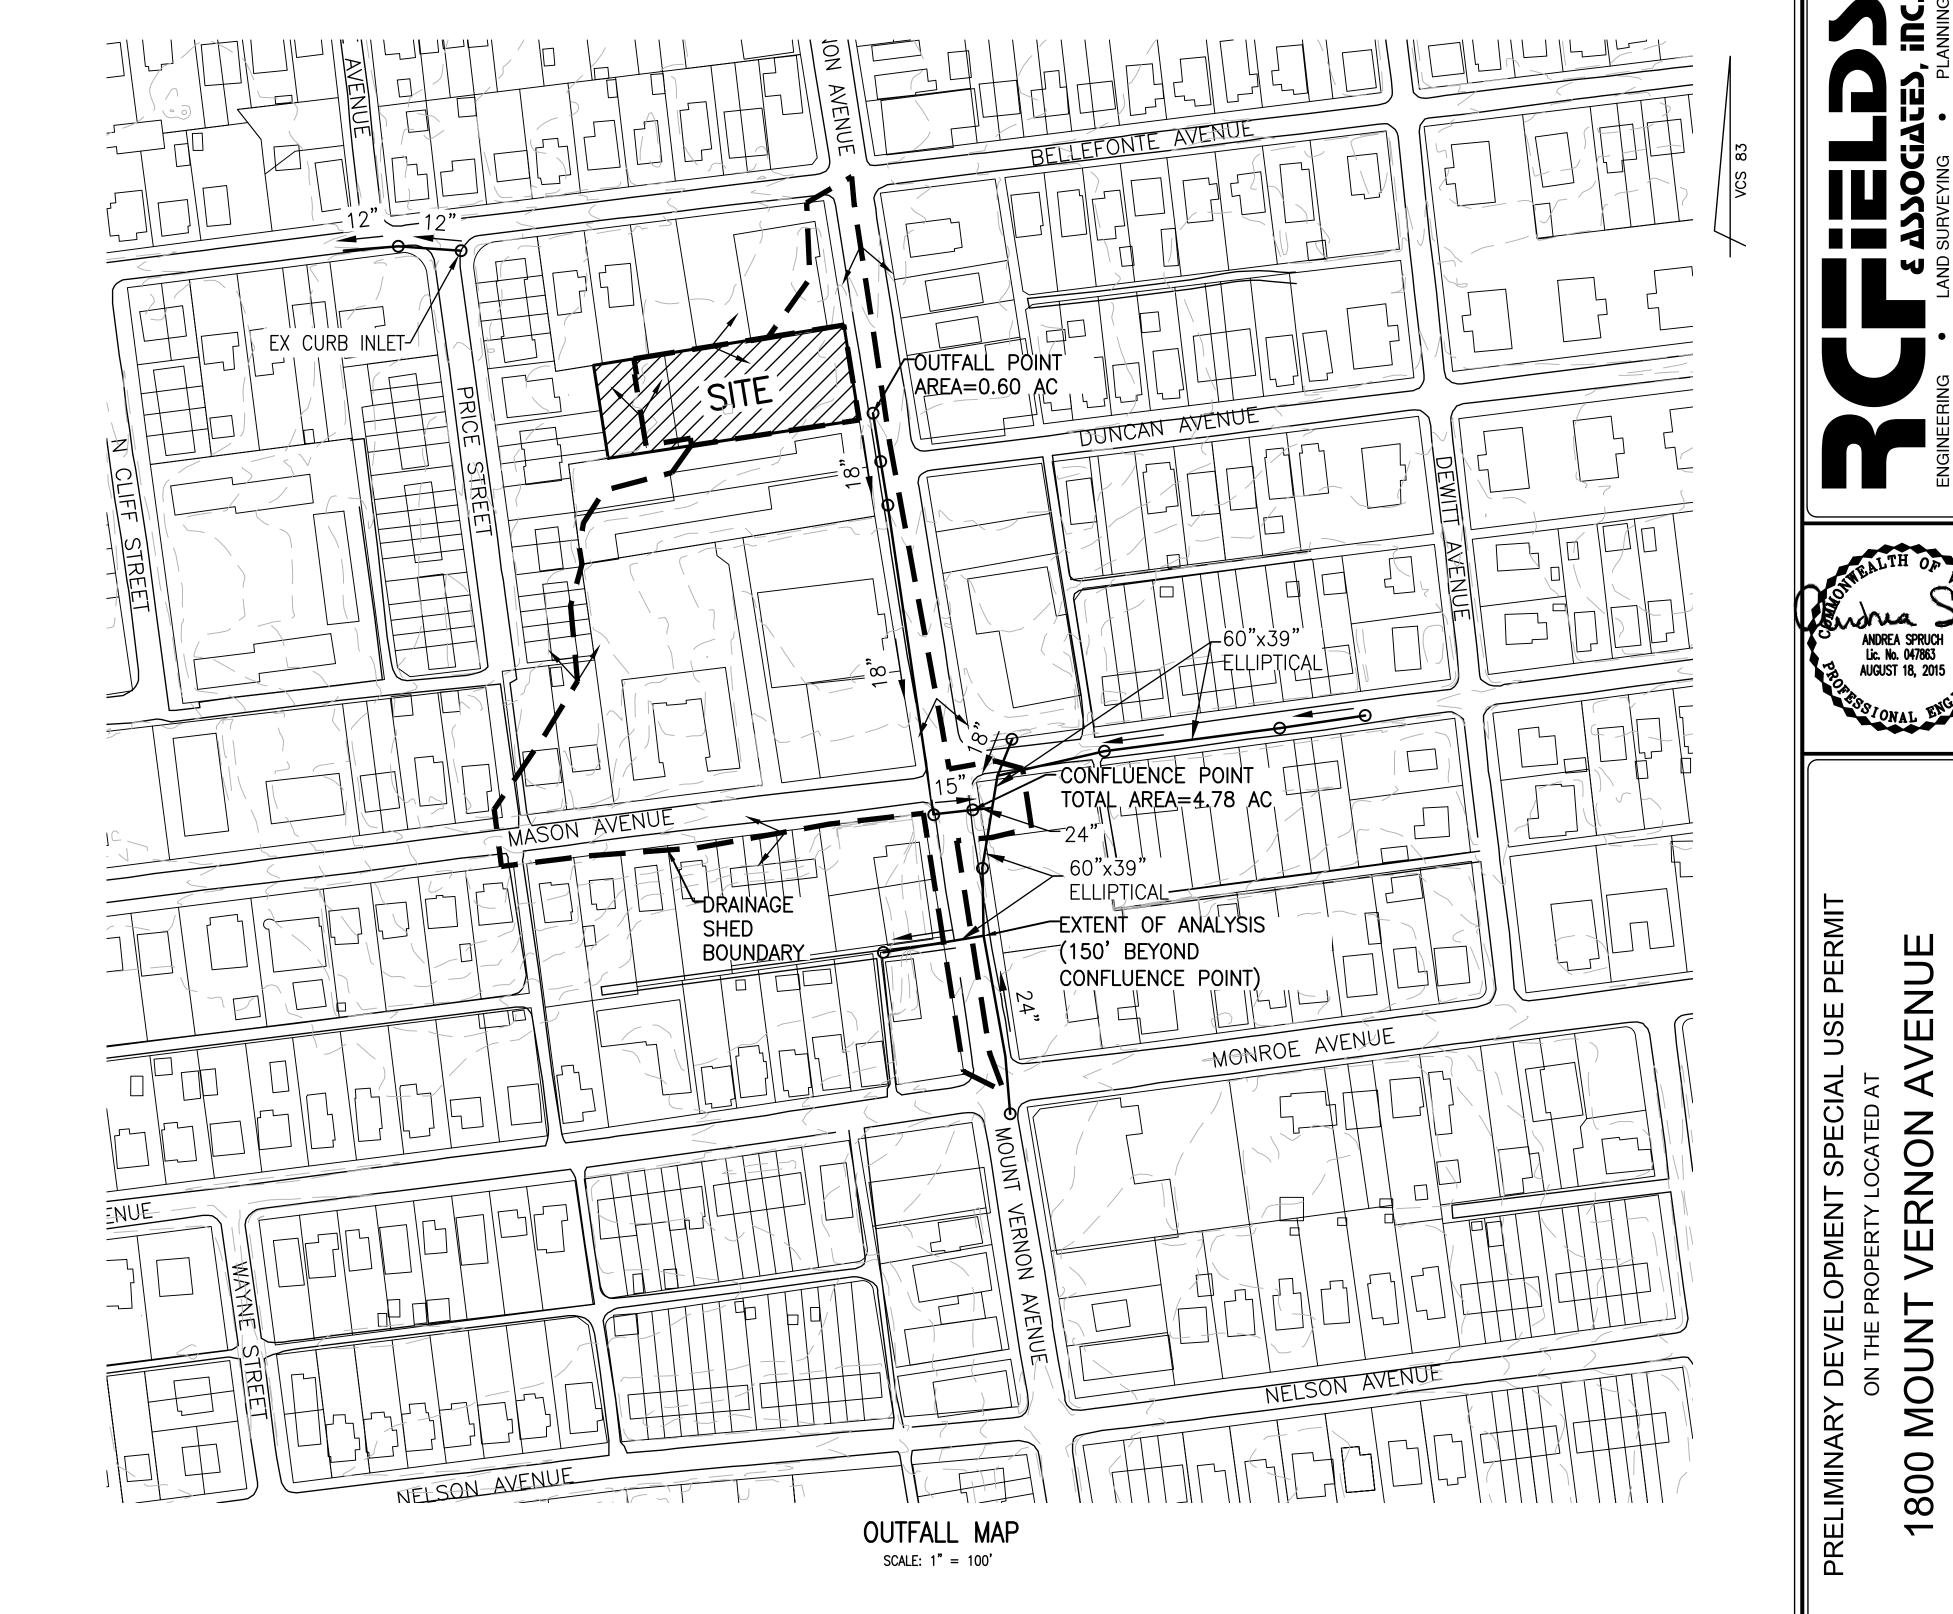

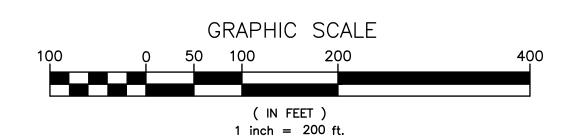

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APPROVED SPECIAL USE PERMIT NO. 2014-0019 DEPARTMENT OF PLANNING & ZONING DEPARTMENT OF TRANSPORTATION & ENVIRONMENTAL SERVICES DATE RECORDED DEED BOOK NO. DATE INSTRUMENT NO.

REVISION DESIGN: DRAWN: SCALE: 1" = 100'DATE: JUNE 25, 201

SHEET 8 OF

ANDREA SPRUCH Lic. No. 047863

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SANITAR	RY SEWER FLOW CO	MPUTATIONS							
BLD#	USE	DESIGN FLOW	UNIT	SIZE	GAL/DAY	GAL/HR	CFS	PEAK CFS (x4)	FLOWS TO
SITE	Multi-family	300	unit	49	14,700	613	0.0227	0.0910	S1
SITE	Retail	200	1000 SF	2,467	493	21	0.0008	0.0031	S1
1	Multi-family	300	unit	5	1,500	63	0.0023	0.0093	S1
2	Multi-family	300	unit	2	600	25	0.0009	0.0037	S1
3	Office/Retail	200	1000 SF	7,010	1,402	58	0.0022	0.0087	В
4	Single Family	350	unit	1	350	15	0.0005	0.0022	В
5	Single Family	351	unit	1	351	15	0.0005	0.0022	В
6	Office/Retail	200	1000 SF	13,582	2,716	113	0.0042	0.0168	В
7	Single Family	350	unit	1	350	15	0.0005	0.0022	В
8	Office/Retail	200	1000 SF	9,870	1,974	82	0.0031	0.0122	С
9-19	Single Family/Townhouse	350	unit	11	3,850	160	0.0060	0.0238	С
20-29	Multi-family	300	unit	68	20,400	850	0.0316	0.1262	С
30-55	Townhouse	350	unit	26	9,100	379	0.0141	0.0563	С
56-75	Townhouse	350	unit	20	7,000	292	0.0108	0.0433	С
76-79	Single Family	350	unit	4	1,400	58	0.0022	0.0087	С
80-85	Single Family	350	unit	6	2,100	88	0.0032	0.0130	С
86-89	Single Family	350	unit	4	1,400	58	0.0022	0.0087	С
90-95	Single Family	350	unit	6	2,100	88	0.0032	0.0130	С
96	Office/Retail	200	1000 SF	33,429	6,686	279	0.0103	0.0414	С
98	Office/Retail	200	1000 SF	15,380	3,076	128	0.0048	0.0190	D
99	Multi-family	300	unit	38	11,400	475	0.0176	0.0705	D
97	Office/Retail	200	1000 SF	9,190	1,838	77	0.0028	0.0114	E
106-114	Single Family/Townhouse	350	unit	9	3,150	131	0.0049	0.0195	F
100-105	Single Family	350	unit	6	2,100	88	0.0032	0.0130	G
115-120	Single Family	350	unit	6	2,100	88	0.0032	0.0130	G
121-125	Single Family	350	unit	7	2,450	102	0.0038	0.0152	K
204-208	Single Family/Townhouse	350	unit	5	1,750	73	0.0027	0.0108	Q
126-128	Single Family	350	unit	3	1,050	44	0.0016	0.0065	Т
129-135	Single Family	350	unit	7	2,450	102	0.0038	0.0152	Т
136	Multi-family	300	unit	12	3,600	150	0.0056	0.0223	Т
137-139	Multi-family	300	unit	44	13,200	550	0.0204	0.0817	Т
140-150	Single Family/Townhouse	350	unit	11	3,850	160	0.0060	0.0238	Т
151-180	Townhouse	350	unit	30	10,500	438	0.0162	0.0650	Т
181	Multi-family	300	unit	9	2,700	113	0.0042	0.0167	Т
182	Multi-family	300	unit	12	3,600	150	0.0056	0.0223	Т
183	Multi-family	300	unit	25	7,500	313	0.0116	0.0464	Т
184	Multi-family	300	unit	21	6,300	263	0.0097	0.0390	Т
185-200	Townhouse	350	unit	16	5,600	233	0.0087	0.0347	Т
201	Multi-family	300	unit	100	30,000	1,250	0.0464	0.1857	Т
	0.00	222	1000		4.40				

200 1000 SF

300 unit

# SANITARY SEWER HYDRAULIC GRADE LINE COMPUTATIONS

											.1111	NCTION LO	288								SURCHARGE		FREE
INLETID	OUTLET	D <sub>O</sub> (in)	Q <sub>o</sub>	Lo	Sfo	H <sub>f</sub>					<u> </u>	TO HOR EX		•	l H <sub>t</sub>	1.3	0.5	FINAL H	INLET	PIPE	OVER PIPE	RIM	BOARD
INCLINE	WSE	Do (III)	G(O		010	'''	<b>V</b> o	Ho	Qi	Vi	Q <sub>i</sub> *V <sub>i</sub>	Hi	ANGLE	Н∆	""	Ht	Ht	(FT)	WSE	CROWN	CROWN	ELEV	(FT)
00	18.20	18	2.552	272.41	0.0040	1.08	3.14	0.038	2.552	3.14	8.01	0.054	22	0.046	0.138		0.07	1.15	19.35	20.05		29.13	9.78
NN	19.35	18	2.507	94.36	0.0028	0.26	2.76	0.030	2.507	2.76	6.92	0.041	36	0.051	0.122		0.06	0.33	19.68	20.36		29.30	9.62
MM	19.68	15	1.875	177.70	0.0016	0.29	2.63	0.027	1.875	2.63	4.93	0.038		0.000	0.064		0.03	0.32	20.00	20.67		30.07	10.07
LL	20.00	15	1.848	159.62	0.0018	0.29	2.14	0.018	1.848	2.14	3.95	0.025		0.000	0.043		0.02	0.31	20.31	20.90		29.12	8.81
KK	20.31	15	1.821	145.90	0.0020	0.29	2.23	0.019	1.821	2.23	4.06	0.027		0.000	0.046		0.02	0.31	20.63	21.34		29.73	9.10
JJ	20.63	15	1.790	174.90	0.0022	0.38	2.31	0.021	1.790	2.31	4.13	0.029		0.000	0.050		0.02	0.41	21.03	21.73		29.25	8.22
II	21.03	15	1.696	157.84	0.0020	0.32	2.20	0.019	1.696	2.20	3.73	0.026		0.000	0.045		0.02	0.34	21.37	22.08		30.80	9.43
HH	21.37	15	1.685	28.65	0.0024	0.07	2.35	0.021	1.685	2.35	3.96	0.030		0.000	0.051		0.03	0.09	21.47	22.16		30.73	9.26
GG	21.47	15	1.674	121.85	0.0014	0.17	2.39	0.022	1.674	2.39	4.00	0.031	64	0.054	0.107		0.05	0.22	21.69	22.44		31.59	9.90
FF	21.69	15	1.647	51.17	0.0028	0.14	3.11	0.038	1.647	3.11	5.12	0.053	26	0.053	0.143		0.07	0.21	21.90	22.75		31.14	9.24
EE	21.90	15	1.645	57.16	0.0007	0.04	0.51	0.001	1.645	0.51	0.84	0.001		0.000	0.002		0.00	0.04	21.94	22.85		30.67	8.73
DD	21.94	15	1.641	6.41	0.0016	0.01	2.00	0.016	1.641	2.00	3.28	0.022		0.000	0.037		0.02	0.03	21.97	22.87		30.64	8.67
CC	21.97	15	1.641	25.48	0.0044	0.11	2.91	0.033	1.641	2.91	4.77	0.046		0.000	0.079		0.04	0.15	22.12	23.00		30.49	8.37
BB	22.12	12	1.614	148.99	0.0024	0.36	1.69	0.011	1.614	1.69	2.73	0.016		0.000	0.027		0.01	0.37	22.50	23.02		32.32	9.82
AA	22.50	12	1.614	212.08	0.0024	0.51	2.09	0.017	1.614	2.09	3.37	0.024	51	0.034	0.075		0.04	0.55	23.05	23.55		32.86	9.81
Z	23.05	12	1.534	84.14	0.0022	0.18	1.63	0.010	1.534	1.63	2.50	0.014	38	0.018	0.042		0.02	0.20	23.25	23.70		32.34	9.09
Υ	23.25	12	1.507	62.08	0.0021	0.13	0.75	0.002	1.507	0.75	1.13	0.003	22	0.003	0.008		0.00	0.13	23.39	23.72		30.22	6.83
Х	23.39	12	1.480	6.73	0.0108	0.07	3.96	0.061	1.480	3.96	5.86	0.085		0.000	0.146		0.07	0.15	23.53	23.89		30.30	6.77
W	23.53	12	1.326	31.15	0.0013	0.04	1.87	0.014	1.326	1.87	2.48	0.019	21	0.016	0.049		0.02	0.07	23.60	23.98		30.25	6.65
V	23.60	12	1.257	72.64	0.0022	0.16	2.39	0.022	1.257	2.39	3.00	0.031		0.000	0.053		0.03	0.19	23.79	24.25		31.15	7.36
U	23.79	12	1.257	67.04	0.0028	0.19	2.58	0.026	1.257	2.58	3.24	0.036		0.000	0.062		0.03	0.22	24.01	24.48		31.29	7.28
Т	24.01	12	1.257	11.60	0.0034	0.04	2.18	0.018	1.257	2.18	2.74	0.026	67	0.045	0.089		0.04	0.08	24.09	24.51		31.02	6.93
S	24.09	10	0.658	26.97	0.0010	0.03	0.39	0.001	0.658	0.39	0.26	0.001	25	0.001	0.002		0.00	0.03	24.12	24.73		29.88	5.76
R	24.12	10	0.658	53.57	0.0032	0.17	1.80	0.013	0.658	1.80	1.18	0.018		0.000	0.030		0.02	0.19	24.30	24.91		29.33	5.03
Q	24.30	10	0.658	30.27	0.0050	0.15	2.10	0.017	0.658	2.10	1.38	0.024		0.000	0.041		0.02	0.17	24.48	24.96		29.64	5.16
Р	24.48	10	0.647	70.60	0.0048	0.34	2.15	0.018	0.647	2.15	1.39	0.025		0.000	0.043		0.02	0.36	24.83	25.13		29.86	5.03
0	24.83	10	0.647	41.28	0.0010	0.04	0.39	0.001	0.647	0.39	0.25	0.001		0.000	0.001		0.00	0.04	24.88	25.14		29.54	4.66
N	24.88	10	0.647	55.78	0.0010	0.06	1.02	0.004	0.647	1.02	0.66	0.006		0.000	0.010		0.00	0.06	24.94	25.22		29.39	4.45
M	24.94	10	0.647	44.30	0.0010	0.04	0.39	0.001	0.647	0.39	0.25	0.001		0.000	0.001		0.00	0.05	24.98	25.27		29.44	4.46
L	24.98	10	0.647	41.66	0.0018	0.08	1.45	0.008	0.647	1.45	0.94	0.011		0.000	0.020		0.01	0.09	25.07	25.34		29.49	4.42
K	25.07	10	0.647	96.43	0.0013	0.13	1.25	0.006	0.647	1.25	0.81	0.008		0.000	0.015		0.01	0.13	25.20	25.48		29.90	4.70
J	25.20	10	0.632	18.33	0.0008	0.01	1.30	0.007	0.632	1.30	0.82	0.009		0.000	0.016		0.01	0.02	25.23	25.58		29.90	4.67
I	25.23	10	0.632	23.49	0.0018	0.04	1.40	0.008	0.632	1.40	0.88	0.011		0.000	0.018		0.01	0.05	25.28	25.61		30.12	4.84
Н	25.28	10	0.632	21.85	0.0019	0.04	1.44	0.008	0.632	1.44	0.91	0.011		0.000	0.019		0.01	0.05	25.33	25.67		30.16	4.83
G	25.33	10	0.632	292.08	0.0013	0.37	1.56	0.009	0.632	1.56	0.99	0.013		0.000	0.023		0.01	0.38	25.70	26.19		32.48	6.78
F	25.70	10	0.606	342.03	0.0011	0.37	1.47	0.008	0.606	1.47	0.89	0.012		0.000	0.020		0.01	0.38	26.08	26.72		30.39	4.31
E	26.08	12	0.587	90.33	0.0030	0.27	1.67	0.011	0.587	1.67	0.98	0.015	90	0.030	0.056		0.03	0.30	26.38	27.10		36.41	10.03
D	26.38	12	0.575	130.35	0.0011	0.14	1.28	0.006	0.575	1.28	0.74	0.009	40	0.011	0.026		0.01	0.15	26.53	27.27		35.22	8.69
С	26.53	12	0.486	56.40	0.0015	0.08	1.40	0.008	0.486	1.40	0.68	0.011	60	0.017	0.035		0.02	0.10	26.63	27.45		35.40	8.77
В	27.99	8	0.139	325.44	0.0231	7.52	2.79	0.030	0.139	2.79	0.39	0.042		0.000	0.073		0.04	7.55	35.54	35.53	0.01	42.26	6.72
S1	35.54	8	0.107	78.45	0.0140	1.10	1.93	0.014	0.107	1.93	0.21	0.020		0.000	0.035		0.02	1.11	36.66	36.31	0.35	43.50	6.84

NOTE: PER DIRECTION FROM CITY STAFF, HYDRAULIC GRADE LINE ANALYSIS UTILIZES 0.01% PIPE SLOPES FOR SEGMENTS M TO N, O TO P, AND S TO T. SEE PROFILE FOR ACTUAL SLOPES.

## SANITARY SEWER OUTFALL CALCULATIONS:

THE AVERAGE DAY AND PEAK HOUR WASTEWATER DISCHARGE FLOW CALCULATIONS WERE COMPUTED USING THE METHOD PROVIDED BY THE CITY OF ALEXANDRIA IN MEMORANDUM TO INDUSTRY NO. 06-14. THE PROPOSED USE FOR THIS PROJECT WILL BE 49 MULT-FAMILY UNITS AND 2,467 SF OF RETAIL SPACE. THE AVERAGE DAILY FLOW IS DESCRIBED BELOW:

 $\frac{300 \text{ GPD}}{\text{UNIT}}$  X 49 UNITS = 14,700 GPD OR 0.0227 CFS

 $\frac{200 \text{ GPD}}{1.000 \text{ SF}}$  X 2,467 SF = 493 GPD OR 0.0008 CFS

TOTAL AVERAGE DAILY FLOW = 15,193 GPD OR 0.0235 CFS

TO ACCOUNT FOR THE DAILY PEAK PERIOD, THE ABOVE FLOW IS MULTIPLIED BY A FACTOR OF 4:

15,193 GPD X 4 = 60,774 GPD0.0232 CFS X 4 = 0.0940 CFS

TOTAL PEAK FLOW = 60,774 GPD OR 0.0940 CFS

# SANITARY SEWER OUTFALL NARRATIVE:

THE TOTAL SANITARY FLOWS FOR THIS SITE WERE CALCULATED PER THE MEMORANDUM TO INDUSTRY NUMBER 06-14. THE EXISTING USE (COMMERCIAL) PRODUCES AN AVERAGE DAILY FLOW OF APPROXIMATELY 5,232 GALLONS PER DAY (200 GAL. X 6,540/1,000 SF X 4.0 PEAK FACTOR). THE PROPOSED DEVELOPMENT (MIXED-USE) PRODUCES 60,774 GALLONS PER DAY ([300 GPD X 49 UNITS X 4.0 PEAK FACTOR] + [200 GPD X 2,467/1,000 SF OF RETAIL SPACE X 4.0 PEAK FACTOR]). THE TOTAL FLOW FROM THE THE PROPOSED USE EXCEEDS 10,000 GPD. THEREFORE, A DETAILED SANITARY SEWER OUTFALL ANALYSIS IS PROVIDED ON THIS SHEET. THE SANITARY DISCHARGE WILL BE TREATED AT A PUBLICLY OWNED TREATMENT FACILITY PER CITY OF ALEXANDRIA CODE 4035.

THIS PROJECT SHALL CONNECT TO THE 8" SANITARY SEWER IN MOUNT VERNON AVENUE. THIS SEWER IS A CITY OF ALEXANDRIA MAINTAINED SANITARY SEWER. THE SANITARY SEWER FLOWS SOUTHWEST TOWARDS BRADDOCK ROAD FOR APPROXIMATELY 3000' WHERE IT JOINS A 33" SANITARY TRUNK SEWER LOCATED IN COMMONWEALTH AVENUE.

# ANDREA SPRUCH Lic. No. 047863 AUGUST 18, 2015

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REVISION

SANITARY SEWER OUTFALL COMPLITATIONS

TOTAL

202 Office/Retail

203 Multi-family

STRUC	CTURE	FACIL	ITY ID		"Q"	()				3)	<b>}</b>	(FT)				<sub>&gt;</sub>	(FT)		ik.	JS
FROM	10	FROM	ТО	INCREMENTAL "Q' (CFS)	ACCUMULATED "C (CFS)	PIPE DIAMETER (IN)	SLOPE (%)	MATERIAL	"n"	MAXIMUM "Q" (CFS)	MAXIMUM VELOCITY (FPS)	LENGTH OF RUN (F	UPPER INVERT	LOWER INVERT	FALL (FT)	NORMAL VELOCITY (FPS)	NORMAL DEPTH (F	FLOW AREA (SF)	WETTED PERIMETER (FT)	HYDRAULIC RADIUS (FT)
S1	В		007282SSMH	0.1070	0.107	8	1.00%	RCP	0.015	1.09	3.01	78.45	35.64	34.86	0.78	1.93	0.14	0.0500	0.6400	0.078
В	С	007282SSMH	007348SSMH	0.0320	0.139	8	2.15%	RCP	0.015	1.60	4.42	325.44	34.86	27.85	7.01	2.79	0.14	0.0500	0.6300	0.079
С	D	007348SSMH	007270SSMH	0.3466	0.486	12	0.14%	RCP	0.015	1.21	1.48	56.40	26.45	26.37	0.08	1.40	0.44	0.3400	1.4600	0.232
D	E	007270SSMH	007195SSMH	0.0896	0.575	12	0.08%	VCP	0.013	1.08	1.32	130.35	26.27	26.16	0.11	1.28	0.50	0.3900	1.5700	0.248
E	F	007195SSMH	007194SSMH	0.0114	0.587	12	0.22%	RCP	0.015	1.52	1.85	90.33	26.10	25.90	0.20	1.67	0.40	0.3000	1.3800	0.217
F	G	007194SSMH	007266SSMH	0.0195	0.606	10	0.15%	CIPP- RCP	0.011	1.05	1.86	342.03	25.89	25.37	0.52	1.47	0.53	0.3600	1.5300	0.235
G	H	007266SSMH	006779SSMH	0.0260	0.632	10	0.17%	CIPP- RCP	0.011	1.11	1.95	292.08	25.36	24.87	0.49	1.56	0.52	0.3500	1.5100	0.231
<u>H</u>		006779SSMH	006778SSMH	0.0000	0.632	10	0.14%	RCP	0.015	0.73	1.29	21.85	24.84	24.81	0.03	1.44	0.55	0.3800	1.5800	0.240
<u> </u>	J	006778SSMH	006777SSMH	0.0000	0.632	10	0.13%	RCP	0.015	0.71	1.25	23.49	24.78	24.75	0.03	1.40	0.56	0.3900	1.6100	0.242
J	K	006777SSMH	007232SSMH	0.0000	0.632	10	0.11%	CIPP- RCP	0.011	0.89	1.57	18.33	24.75	24.73	0.02	1.30	0.60	0.4200	1.6900	0.248
K	L	007232SSMH	006776SSMH	0.0152	0.647	10	0.10%	RCP	0.015	0.64	1.12	96.43	24.65	24.55	0.10	1.25	0.64	0.4500	1.7800	0.252
L	IVI	006776SSMH	006775SSMH	0.0000	0.647	10	0.14%	RCP	0.015	0.75	1.32	41.66	24.51	24.45	0.06	1.45	0.56	0.3900	1.5900	0.245
M	N	006775SSMH	006774SSMH	0.0000	0.647	10	0.01%	RCP	0.015	0.21	0.37	44.30	24.44	24.43	0.00	0.39	0.78	0.5300	2.2000	0.240
N	0	006774SSMH	006773SSMH	0.0000	0.647 0.647	10	0.07%	RCP RCP	0.015	0.53 0.22	0.93	55.78 41.28	24.39	24.35	0.04	1.02	0.78 0.78	0.5300	2.2000	0.240
<u> </u>	ı	006773SSMH 006772SSMH	006772SSMH 006770SSMH	0.0000	0.647	10 10	0.01%	RCP	0.015 0.015	1.23	2.16	70.60	24.31 24.30	24.31 24.03	0.00	0.39 2.15	0.76	0.5300 0.2700	2.2000 1.3000	0.240
Q Q	Q R	006772SSWIH	006769SSMH	0.0000	0.658	10	0.36%	RCP	0.015	1.19	2.10	30.27	24.30	24.03	0.27	2.10	0.41	0.2700	1.3100	0.207
R	S	00077033WIT	006768SSMH	0.0000	0.658	10	0.36 %	RCP	0.015	0.98	1.72	53.57	24.13	23.95	0.11	1.80	0.42	0.2700	1.4300	0.200
S	T	00070933WIT	006766SSMH	0.0000	0.658	10	0.24%	RCP	0.015	0.30	1.72	26.97	23.90	23.90	0.13	0.39	0.48	0.5200	2.2000	0.240
	11	006766SSMH	006765SSMH	0.5990	1.257	12	0.26%	RCP	0.015	1.64	2.00	11.60	23.51	23.48	0.00	2.18	0.70	0.5300	1.8200	0.240
<u>'</u>	V	006765SSMH	006767SSMH	0.0000	1.257	12	0.40%	CIPP- RCP	0.013	2.79	3.41	67.04	23.48	23.21	0.03	2.58	0.54	0.4300	1.6500	0.260
	W	006767SSMH	006739SSMH	0.0000	1.257	12	0.33%	CIPP- RCP	0.011	2.53	3.09	72.64	23.25	23.01	0.24	2.39	0.54	0.4700	1.7200	0.273
W	X	006739SSMH	006738SSMH		1.326	12	0.33%	VCP	0.013	1.33	1.63	31.15	22.98	22.94	0.04	1.87	0.85	0.7100	2.3400	0.303
X	Y	006738SSMH	006737SSMH		1.480	12	1.04%	RCP	0.015	3.29	4.02	6.73	22.89	22.82	0.07	3.96	0.48	0.3700	1.5300	0.241
Y	Z	006737SSMH	007217SSMH		1.507	12	0.03%	RCP	0.015	0.58	0.71	62.08	22.72	22.70	0.02	0.75	0.94	0.7600	2.6400	0.287
	AA	007217SSMH	007216SSMH		1.534	12	0.14%	RCP	0.015	1.22	1.49	84.14	22.70	22.58	0.12	1.63	0.94	0.7600	2.6400	0.287
AA	BB	007216SSMH	007219SSMH		1.614	12	0.23%	RCP	0.015	1.53	1.88	212.08	22.55	22.07	0.48	2.09	0.94	0.7600	2.6400	0.287
BB	CC	007219SSMH	007240SSMH		1.614	12	0.15%	RCP	0.015	1.27	1.55	148.99	22.02	21.79	0.23	1.69	0.94	0.7600	2.6400	0.287
CC	DD	007240SSMH	007242SSMH		1.641	15	0.43%	RCP	0.015	3.84	3.01	25.48	21.75	21.64	0.11	2.91	0.58	0.5600	1.8800	0.297
DD	EE	007242SSMH	007243SSMH		1.641	15	0.16%	RCP	0.015	2.31	1.81	6.41	21.62	21.61	0.01	2.00	0.79	0.8200	2.3000	0.356
EE	FF	007243SSMH	007244SSMH		1.645	15	0.10%	RCP	0.015	1.89	1.48	57.16	21.60	21.54	0.06	0.51	1.17	1.2000	3.3000	0.363
FF	GG	007244SSMH	007245SSMH		1.647	15	0.51%	CIPP- RCP	0.011	5.68	4.45	51.17	21.50	21.24	0.26	3.11	0.56	0.5300	1.8300	0.289
GG	HH	007245SSMH	007259SSMH		1.674	15	0.25%	CIPP- RCP	0.011	4.02	3.15	121.85	21.19	20.88	0.31	2.39	0.70	0.7000	2.1000	0.333
HH	II	007259SSMH	007260SSMH		1.685	15	0.24%	RCP	0.015	2.89	2.26	28.65	20.91	20.84	0.07	2.35	0.71	0.7200	2.1300	0.338
II.	JJ	007260SSMH	007262SSMH		1.696	15	0.20%	RCP	0.015	2.63	2.06	157.84	20.83	20.51	0.32	2.20	0.75	0.7700	2.2200	0.346
JJ	KK	007262SSMH	007287SSMH		1.790	15	0.22%	RCP	0.015	2.72	2.13	174.90	20.48	20.10	0.38	2.31	0.76	0.7800	2.2300	0.349
KK	LL	007287SSMH	007288SSMH		1.821	15	0.20%	RCP	0.015	2.60	2.04	145.90	20.09	19.80	0.29	2.23	0.79	0.8200	2.3000	0.356
LL	MM	007288SSMH	007289SSMH		1.848	15	0.18%	RCP	0.015	2.45	1.92	159.62	19.65	19.37	0.28	2.14	0.83	0.8600	2.3700	0.362
MM	NN	007289SSMH	006927SSMH		1.875	15	0.30%	CIPP- RCP	0.011	4.35	3.41	177.70	19.42	18.89	0.53	2.63	0.71	0.7100	2.1200	0.334
NN	00	006927SSMH	006931SSMH		2.507	18	0.28%	RCP	0.015	4.99	2.71	94.36	18.86	18.60	0.26	2.76	0.77	0.9100	2.3900	0.380
00	PP	006931SSMH	006969SSMH		2.552	18	0.39%	RCP	0.015	5.90	3.21	272.41	18.55	17.50	1.05	3.14	0.70	0.8100	2.2600	0.358

263 0.0097

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6,300


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PEAK FLOW NOTE: PEAK FLOWS FROM STRUCTURES W TO PP PROVIDED BY THE CITY OF ALEXANDRIA'S T&ES/STORMWATER AND SANITARY INFRASTRUCTURE DEPARTMENT. THE ABOVE SANITARY SEWER OUTFALL COMPUTATIONS DO NOT INCLUDE THE PEAK FLOW FROM THE EXISTING ONSITE COMMERCIAL BUILDING. SEE SANITARY SEWER OUTFALL NARRATIVE ON THIS SHEET FOR EXISTING BUILDING FLOW CALCULATIONS.



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LOCATION AND DEPTH OF ALL EXISTING UNDERGROUND UTILITIES TO BE VERIFIED BY CONTRACTOR PRIOR TO CONSTRUCTION. INTERFERENCE OR DISRUPTION OF SAME WILL NOT BE THE RESPONSIBILITY OF THIS OFFICE. ALL CONSTRUCTION SHALL CONFORM TO THE CURRENT STANDARDS AND SPECIFICATION OF THE CITY OF ALEXANDRIA, VIRGINIA. © 2015 R.C. FIELDS & ASSOCIATES, INC.

INSTRUMENT NO. DEED BOOK NO. DATE


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DATE: JUNE 25, 2015 9 of

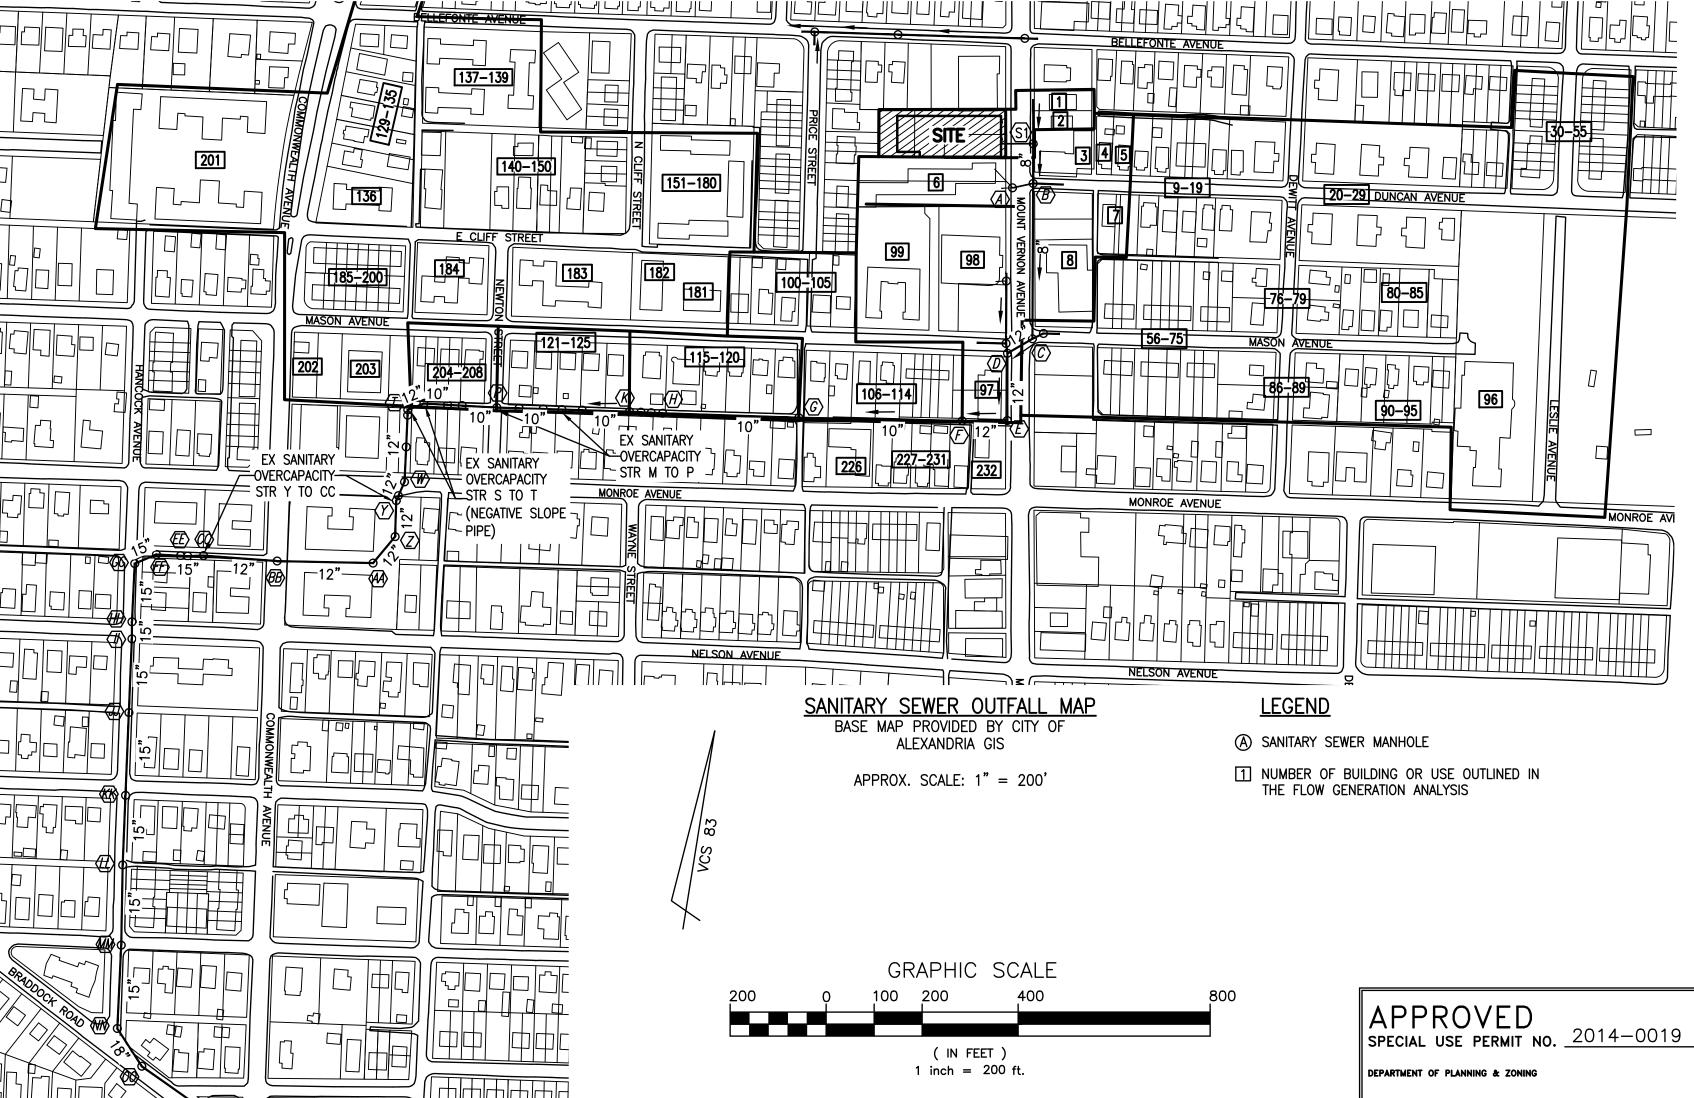SURVEY NOTE: STRUCTURE INFORMATION FOR STRUCTURES A TO X AND BB TO HH OBTAINED FROM FIELD SURVEY. ALL OTHER STRUCTURE INFORMATION OBTAIN FROM ALEXANDRIA GIS.

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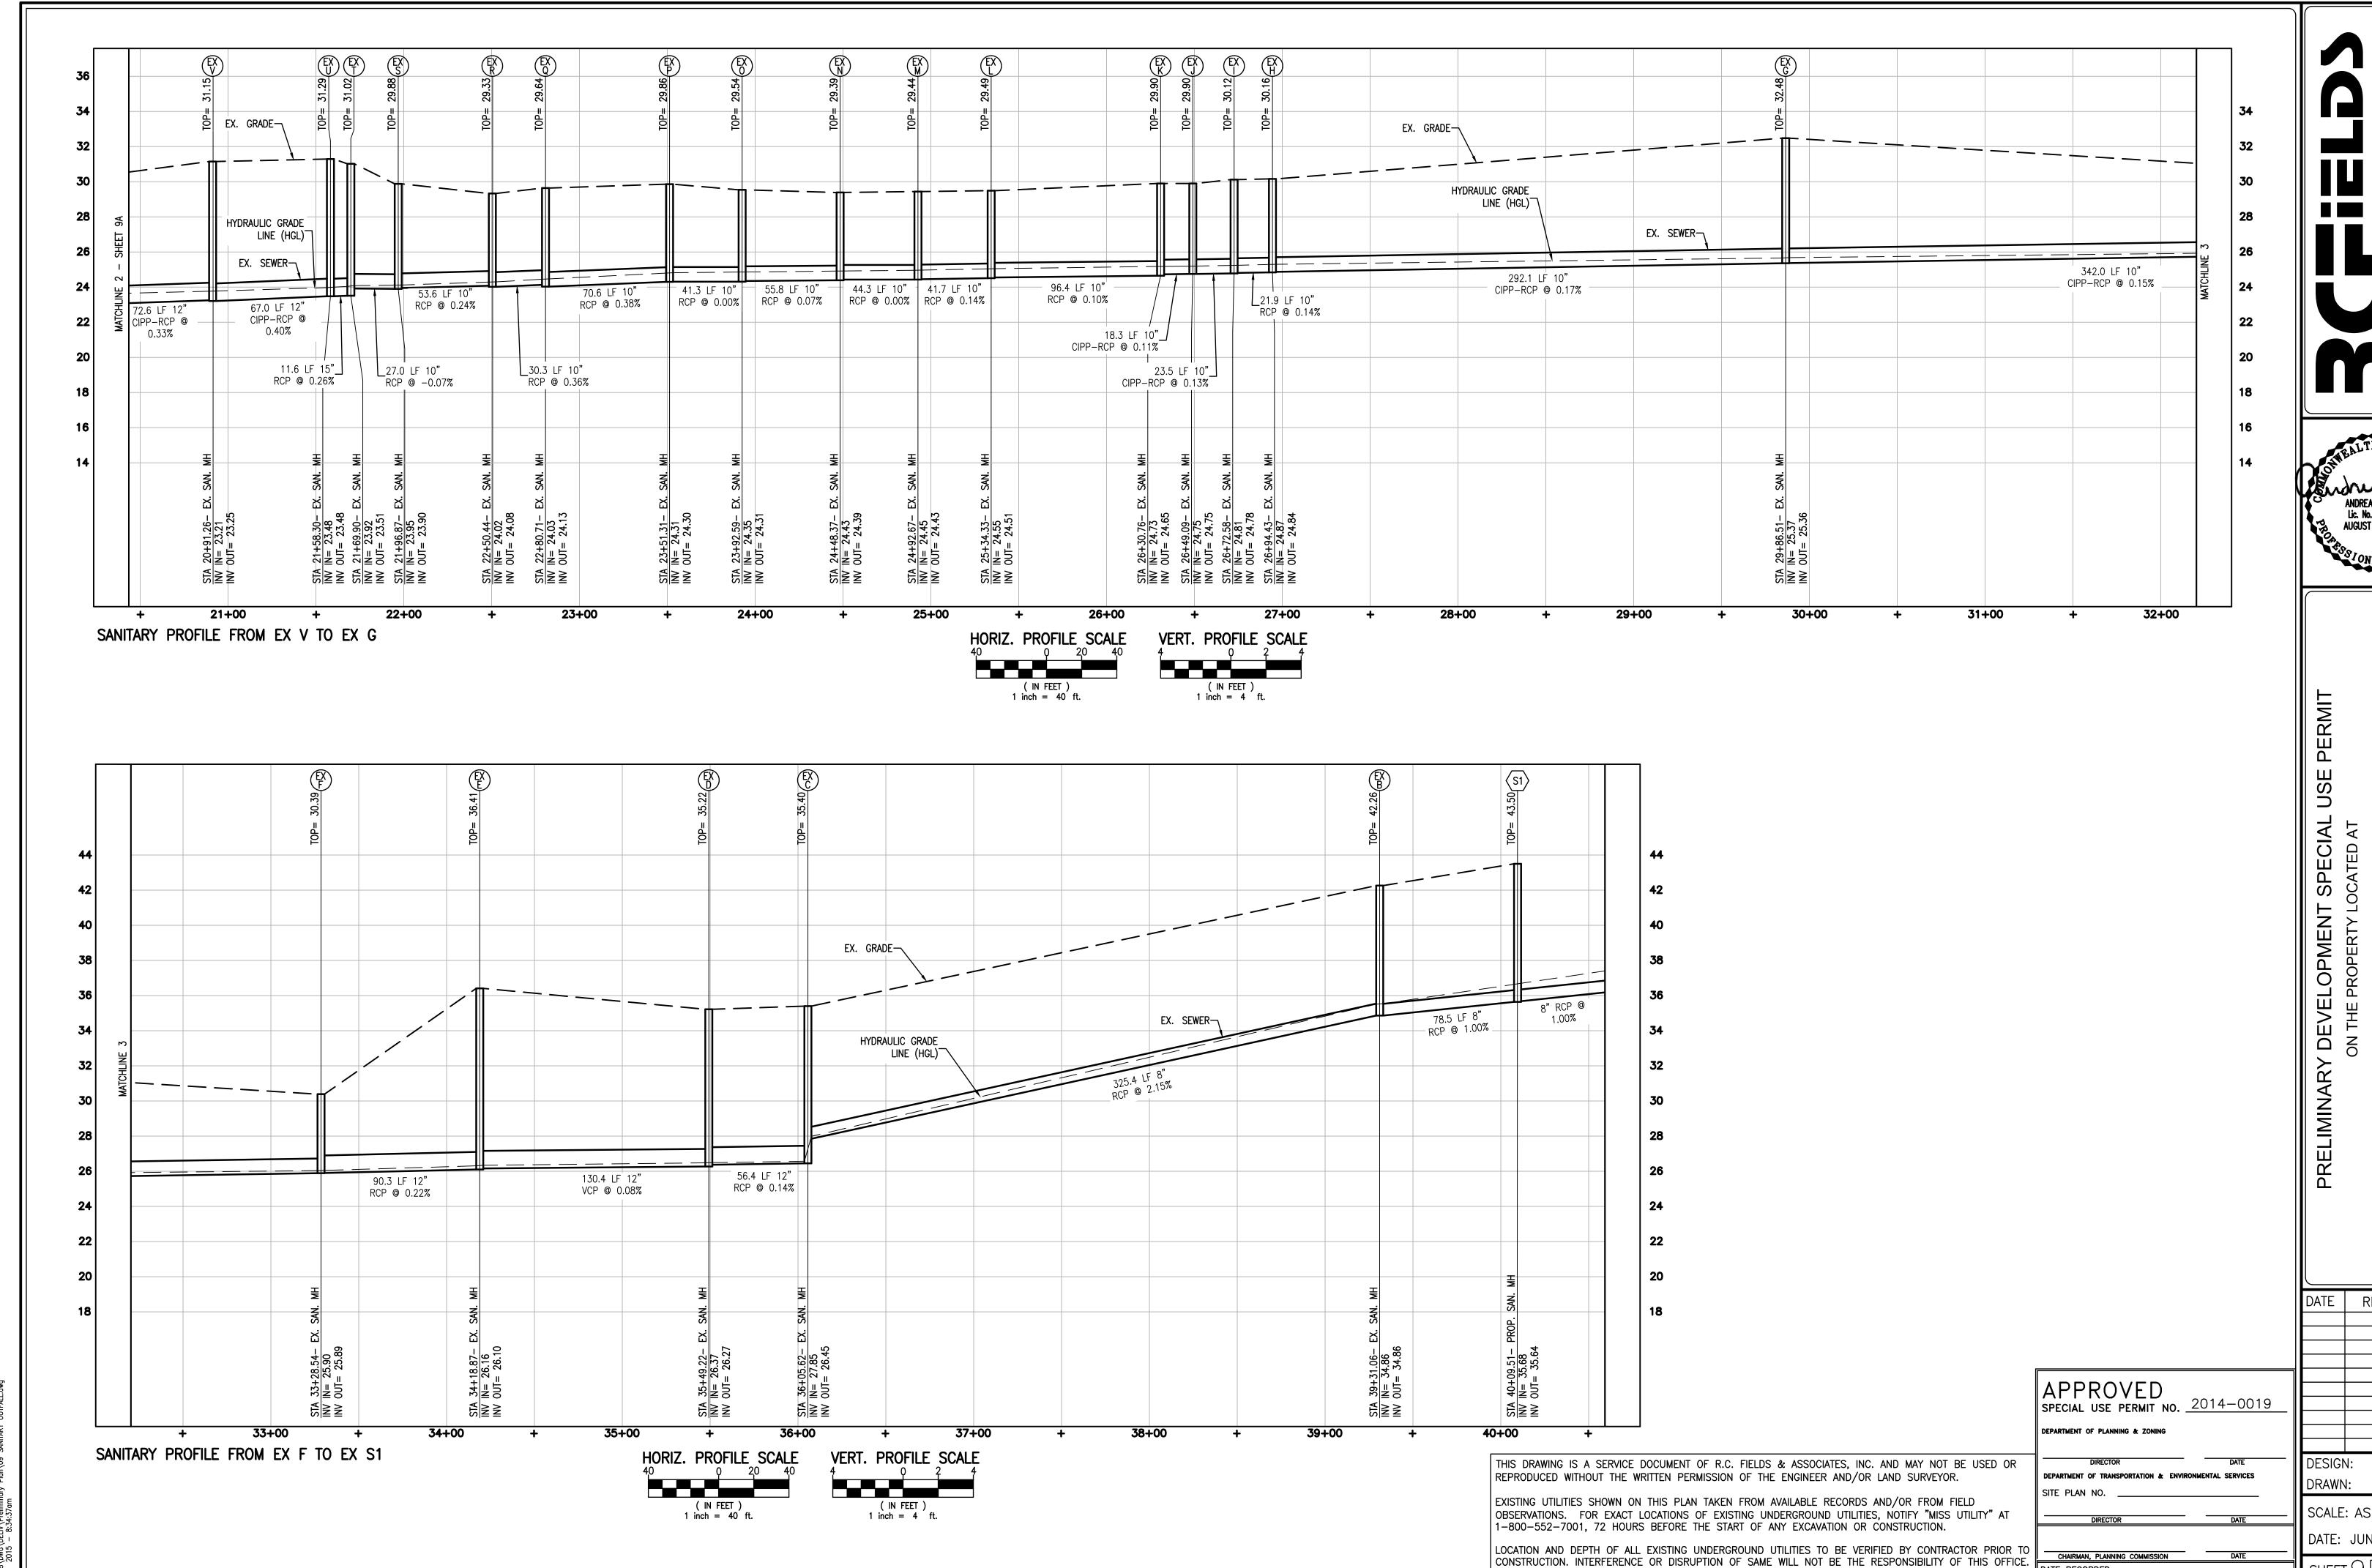



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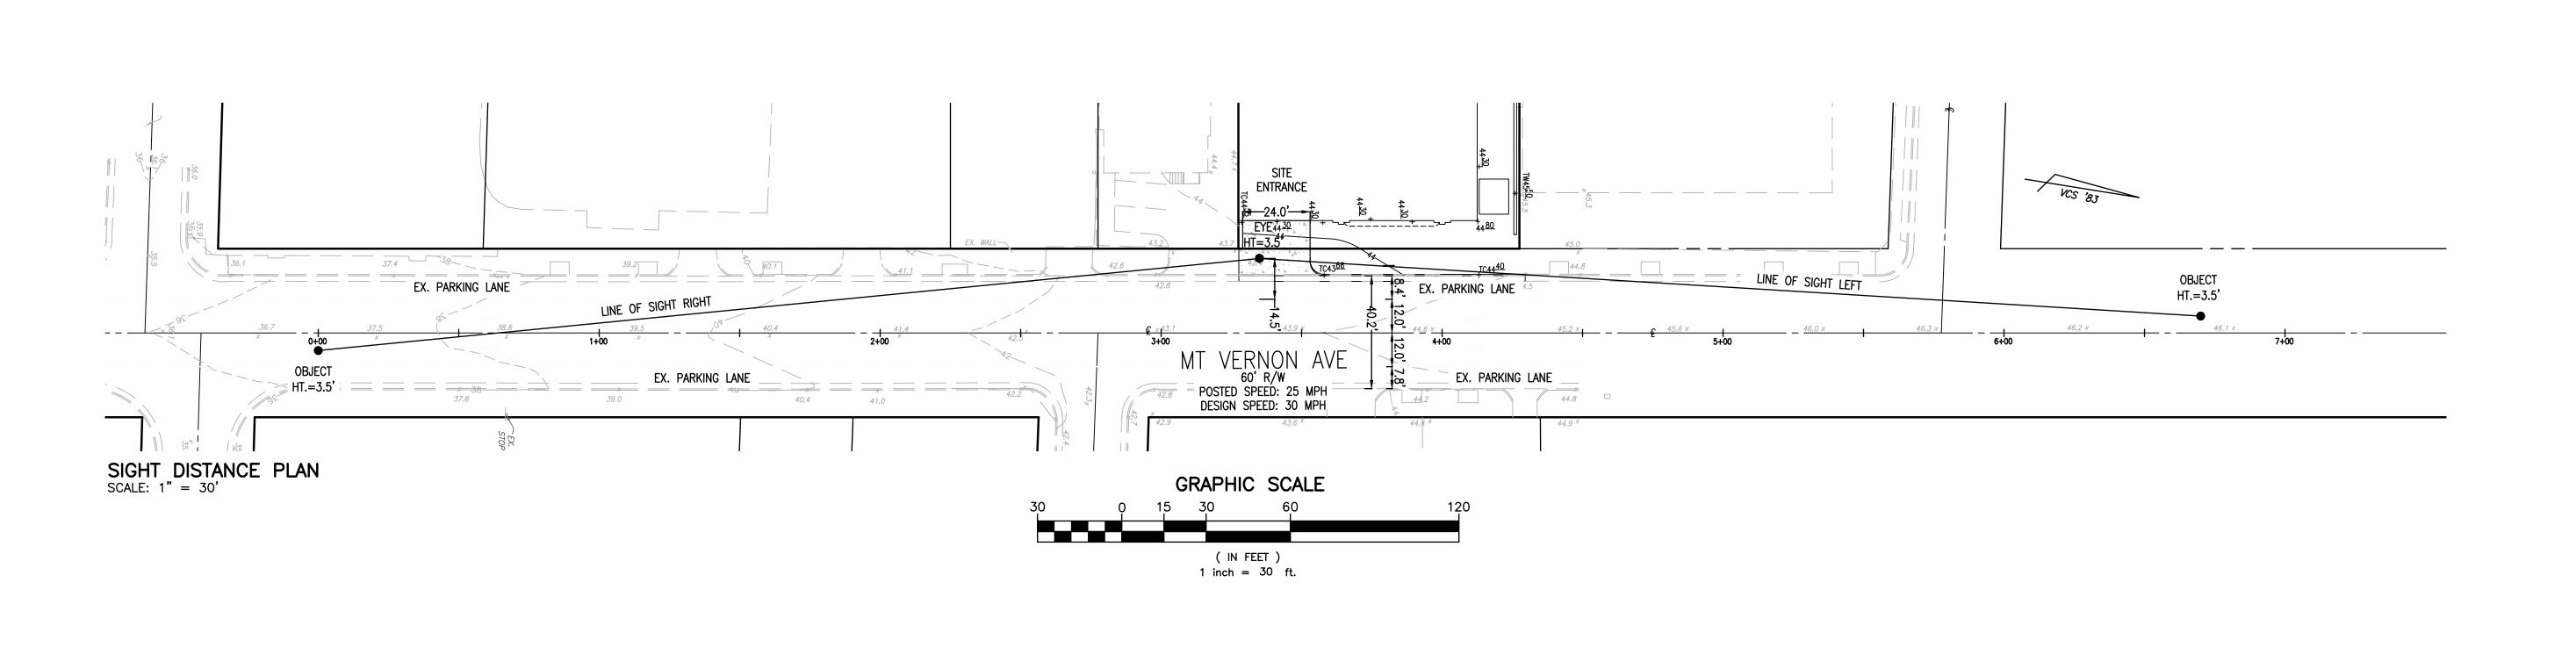
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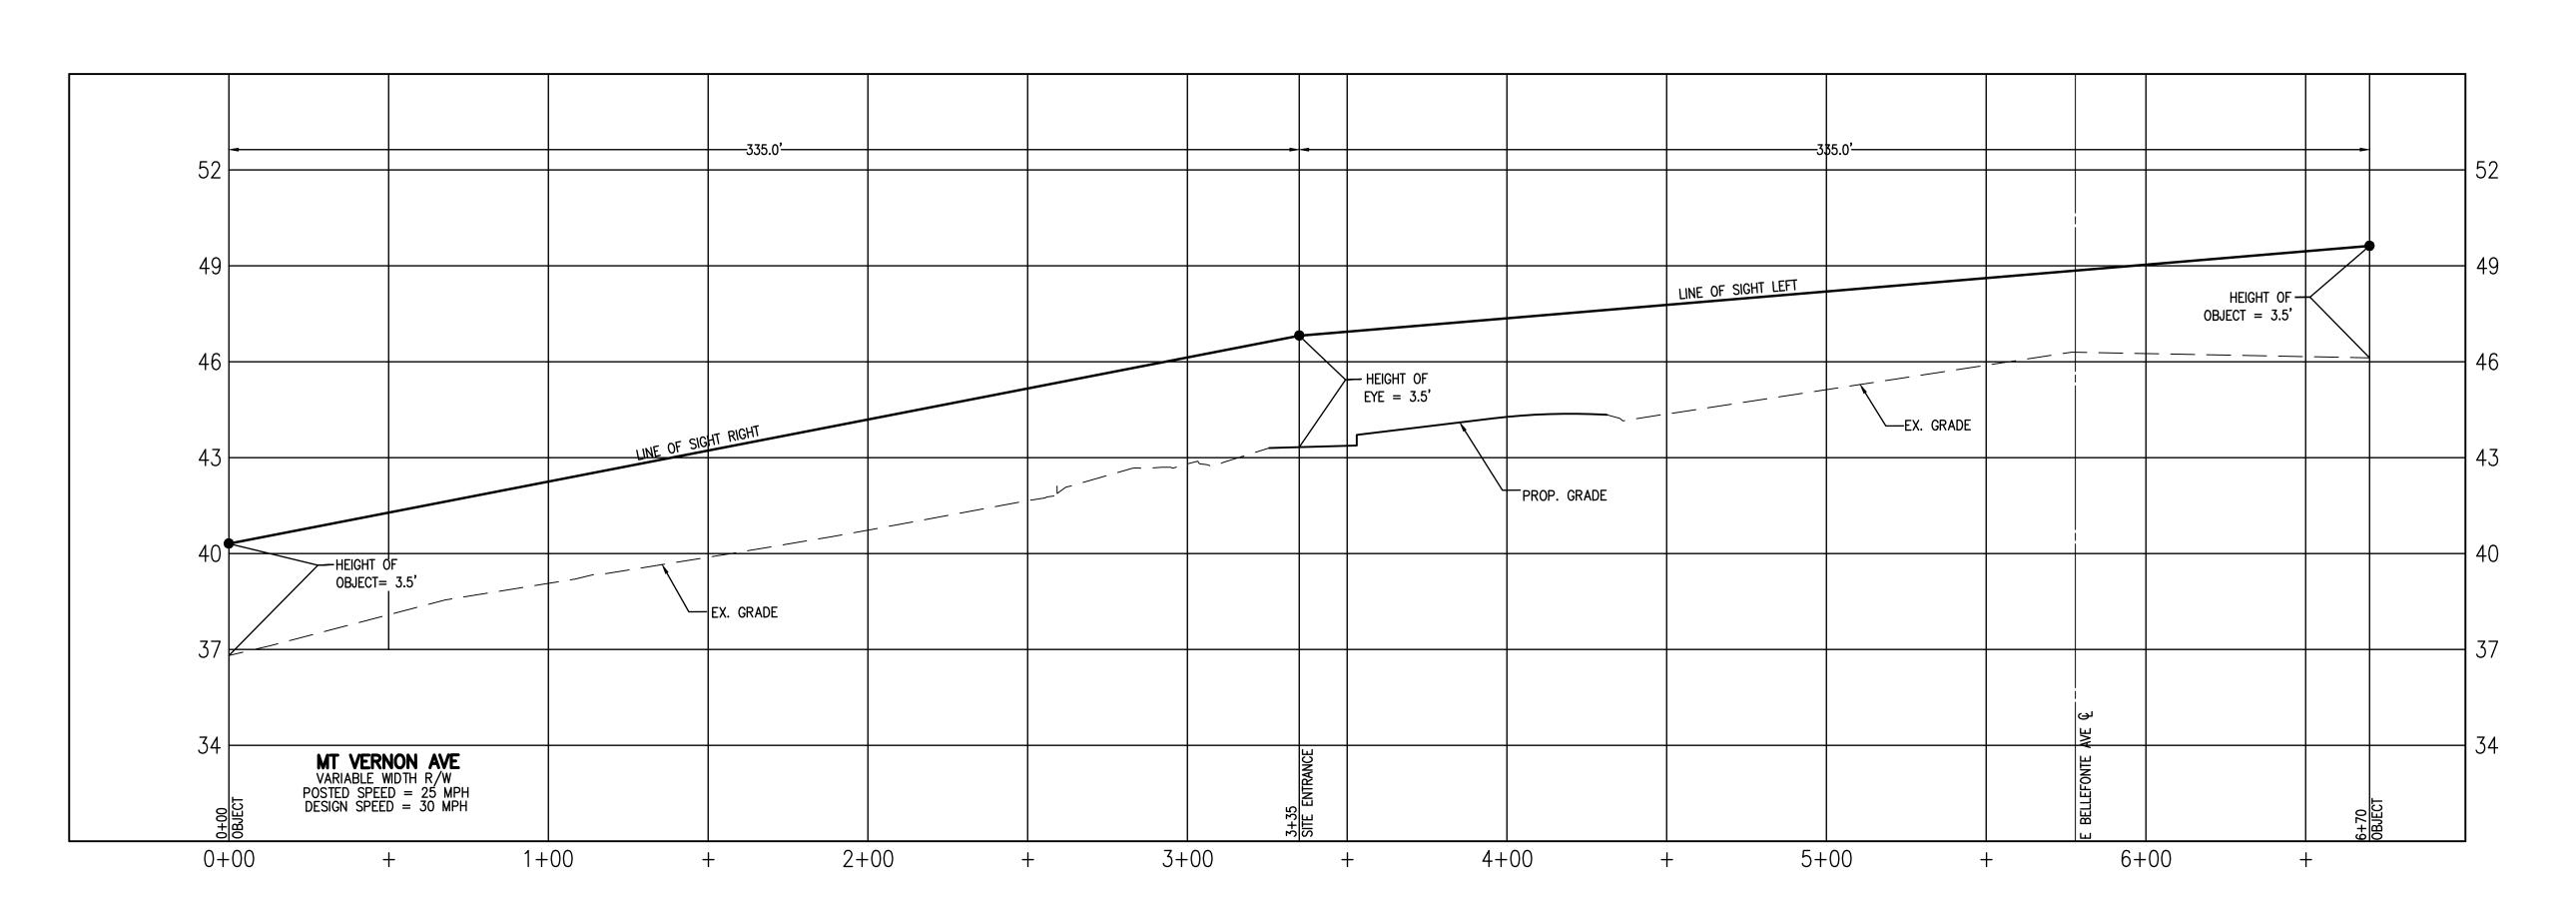
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ALL CONSTRUCTION SHALL CONFORM TO THE CURRENT STANDARDS AND SPECIFICATION OF THE CITY OF

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ALEXANDRIA, VIRGINIA.

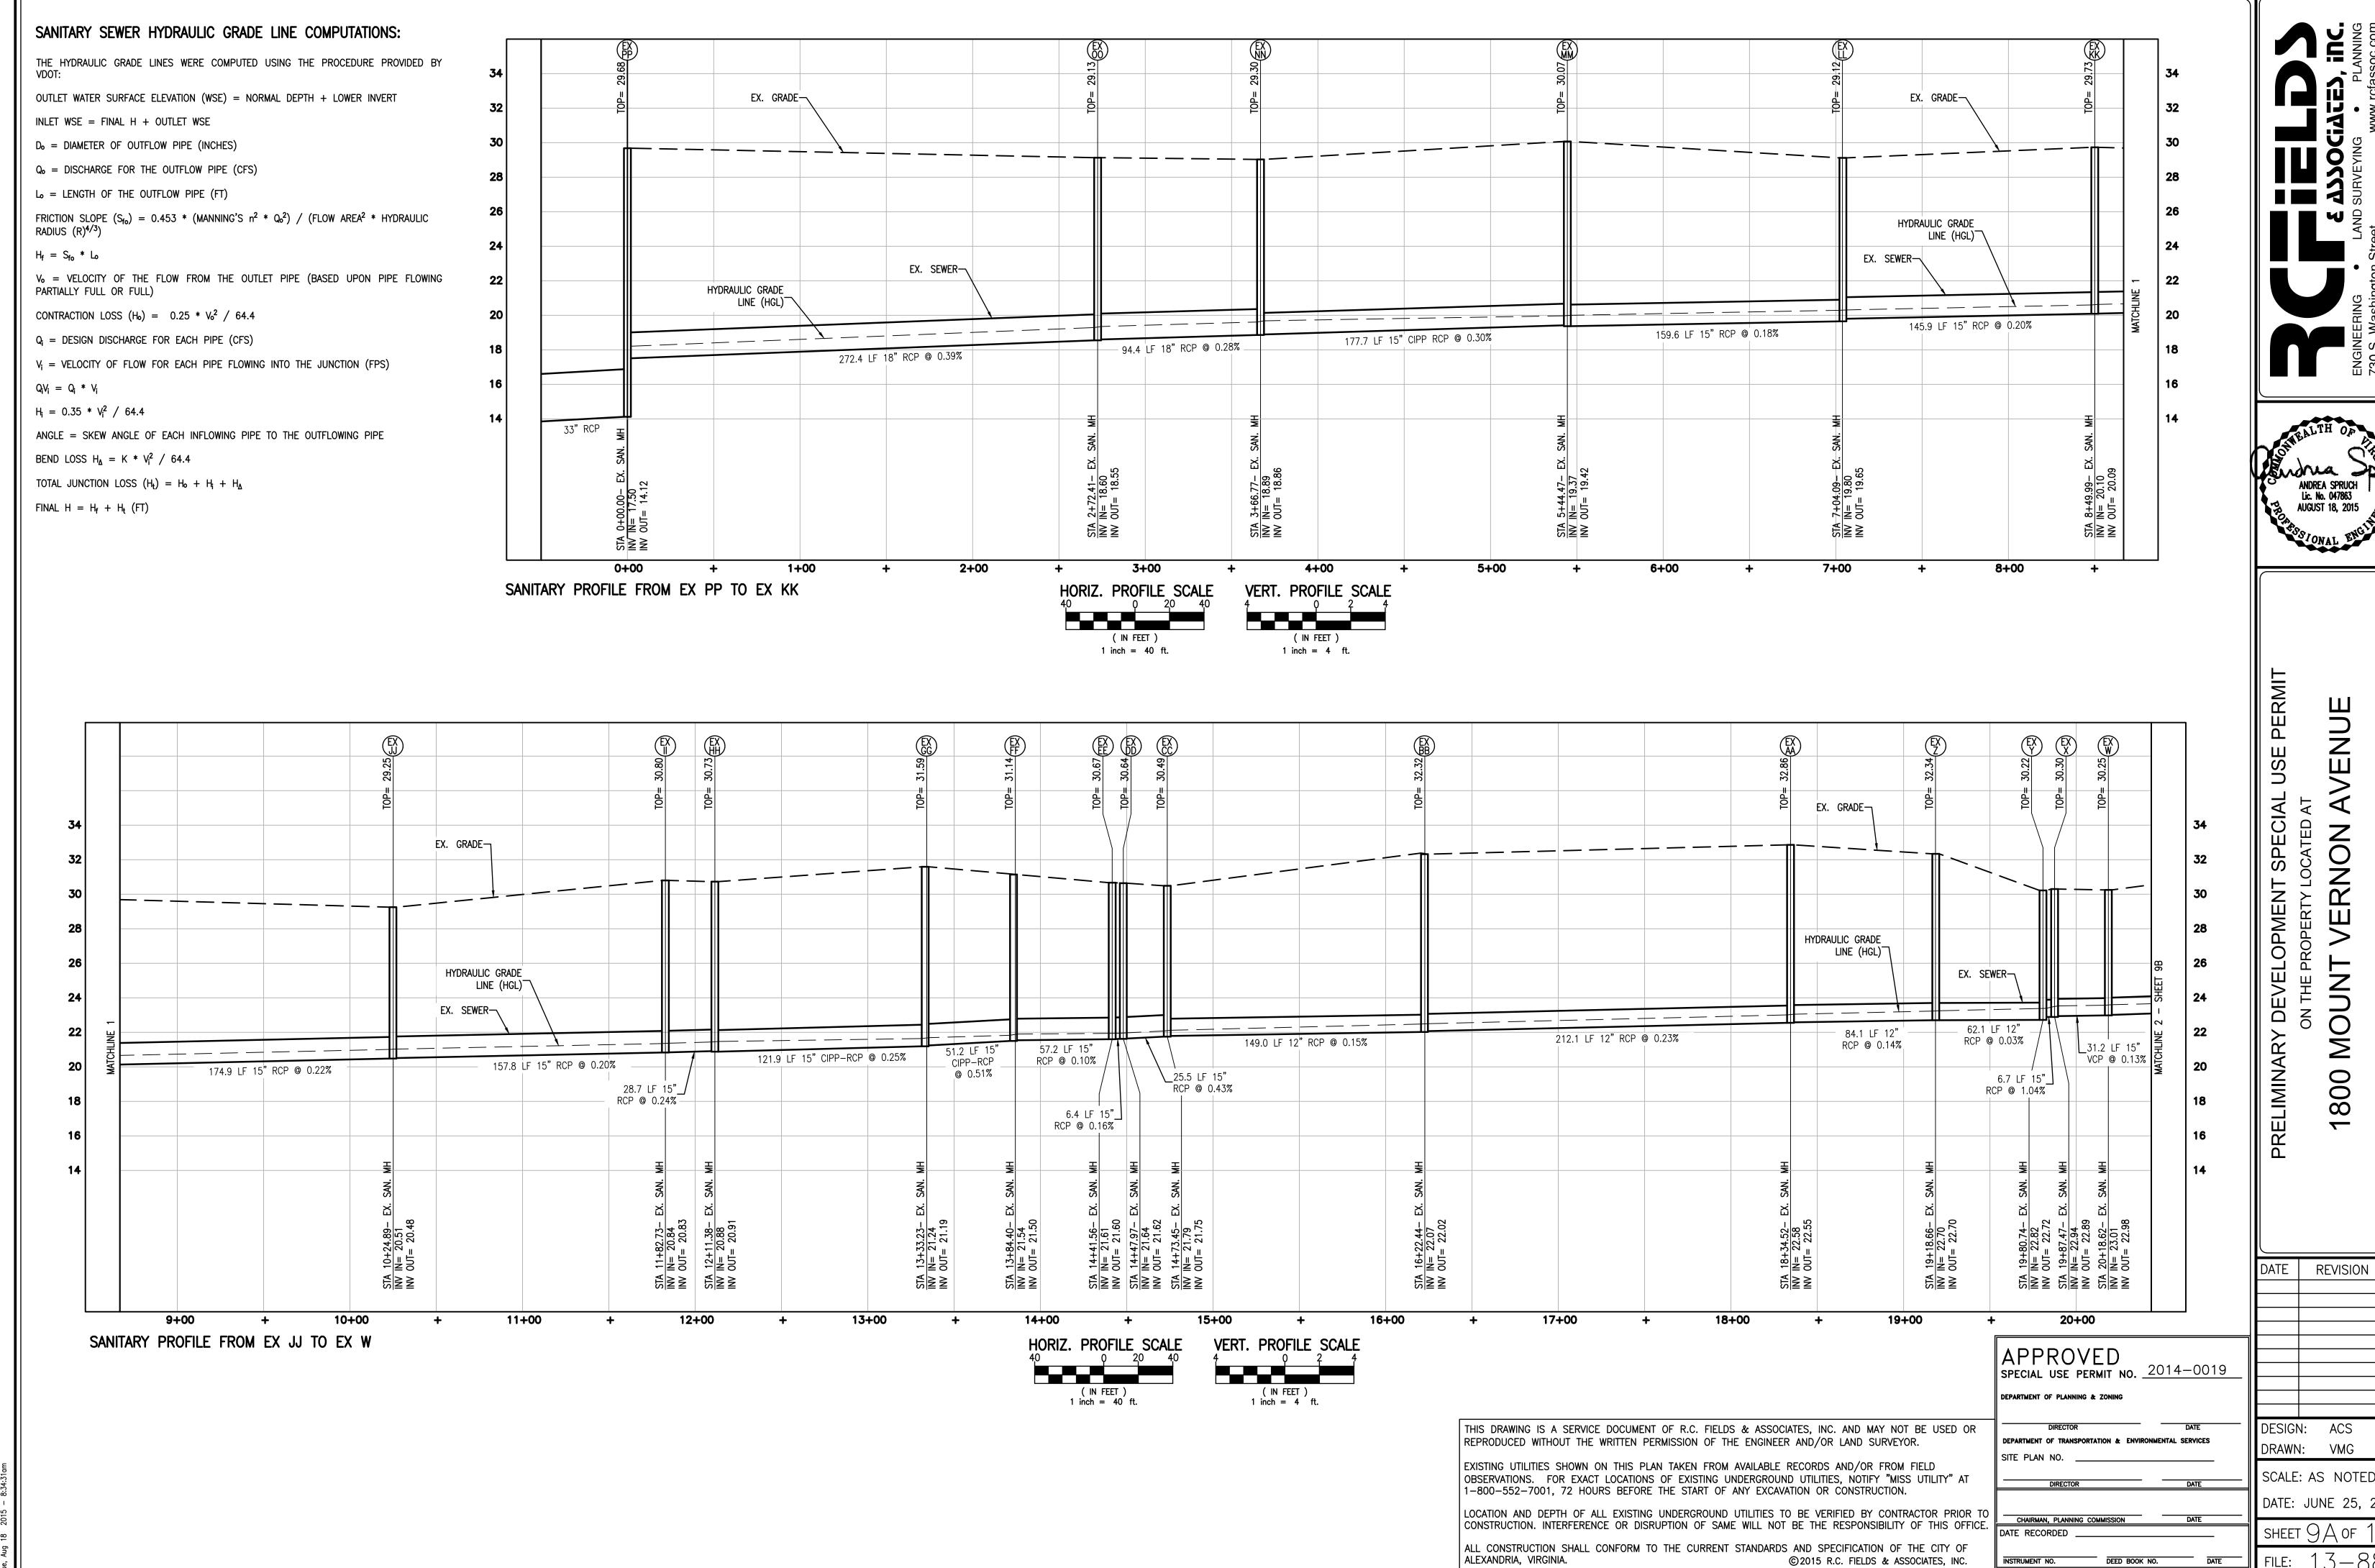





SIGHT DISTANCE PROFILE

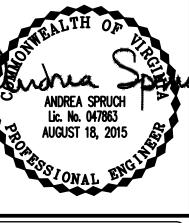SCALE: HORIZ.: 1" = 30'

VERT.: 1" = 3'

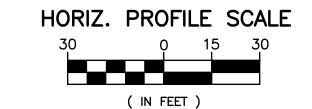

1 inch = 30 ft.

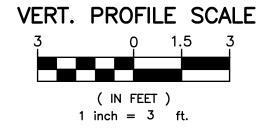

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APPROVED SPECIAL USE PERMIT NO. 2014-0019 DEPARTMENT OF PLANNING & ZONING DEPARTMENT OF TRANSPORTATION & ENVIRONMENTAL SERVICES



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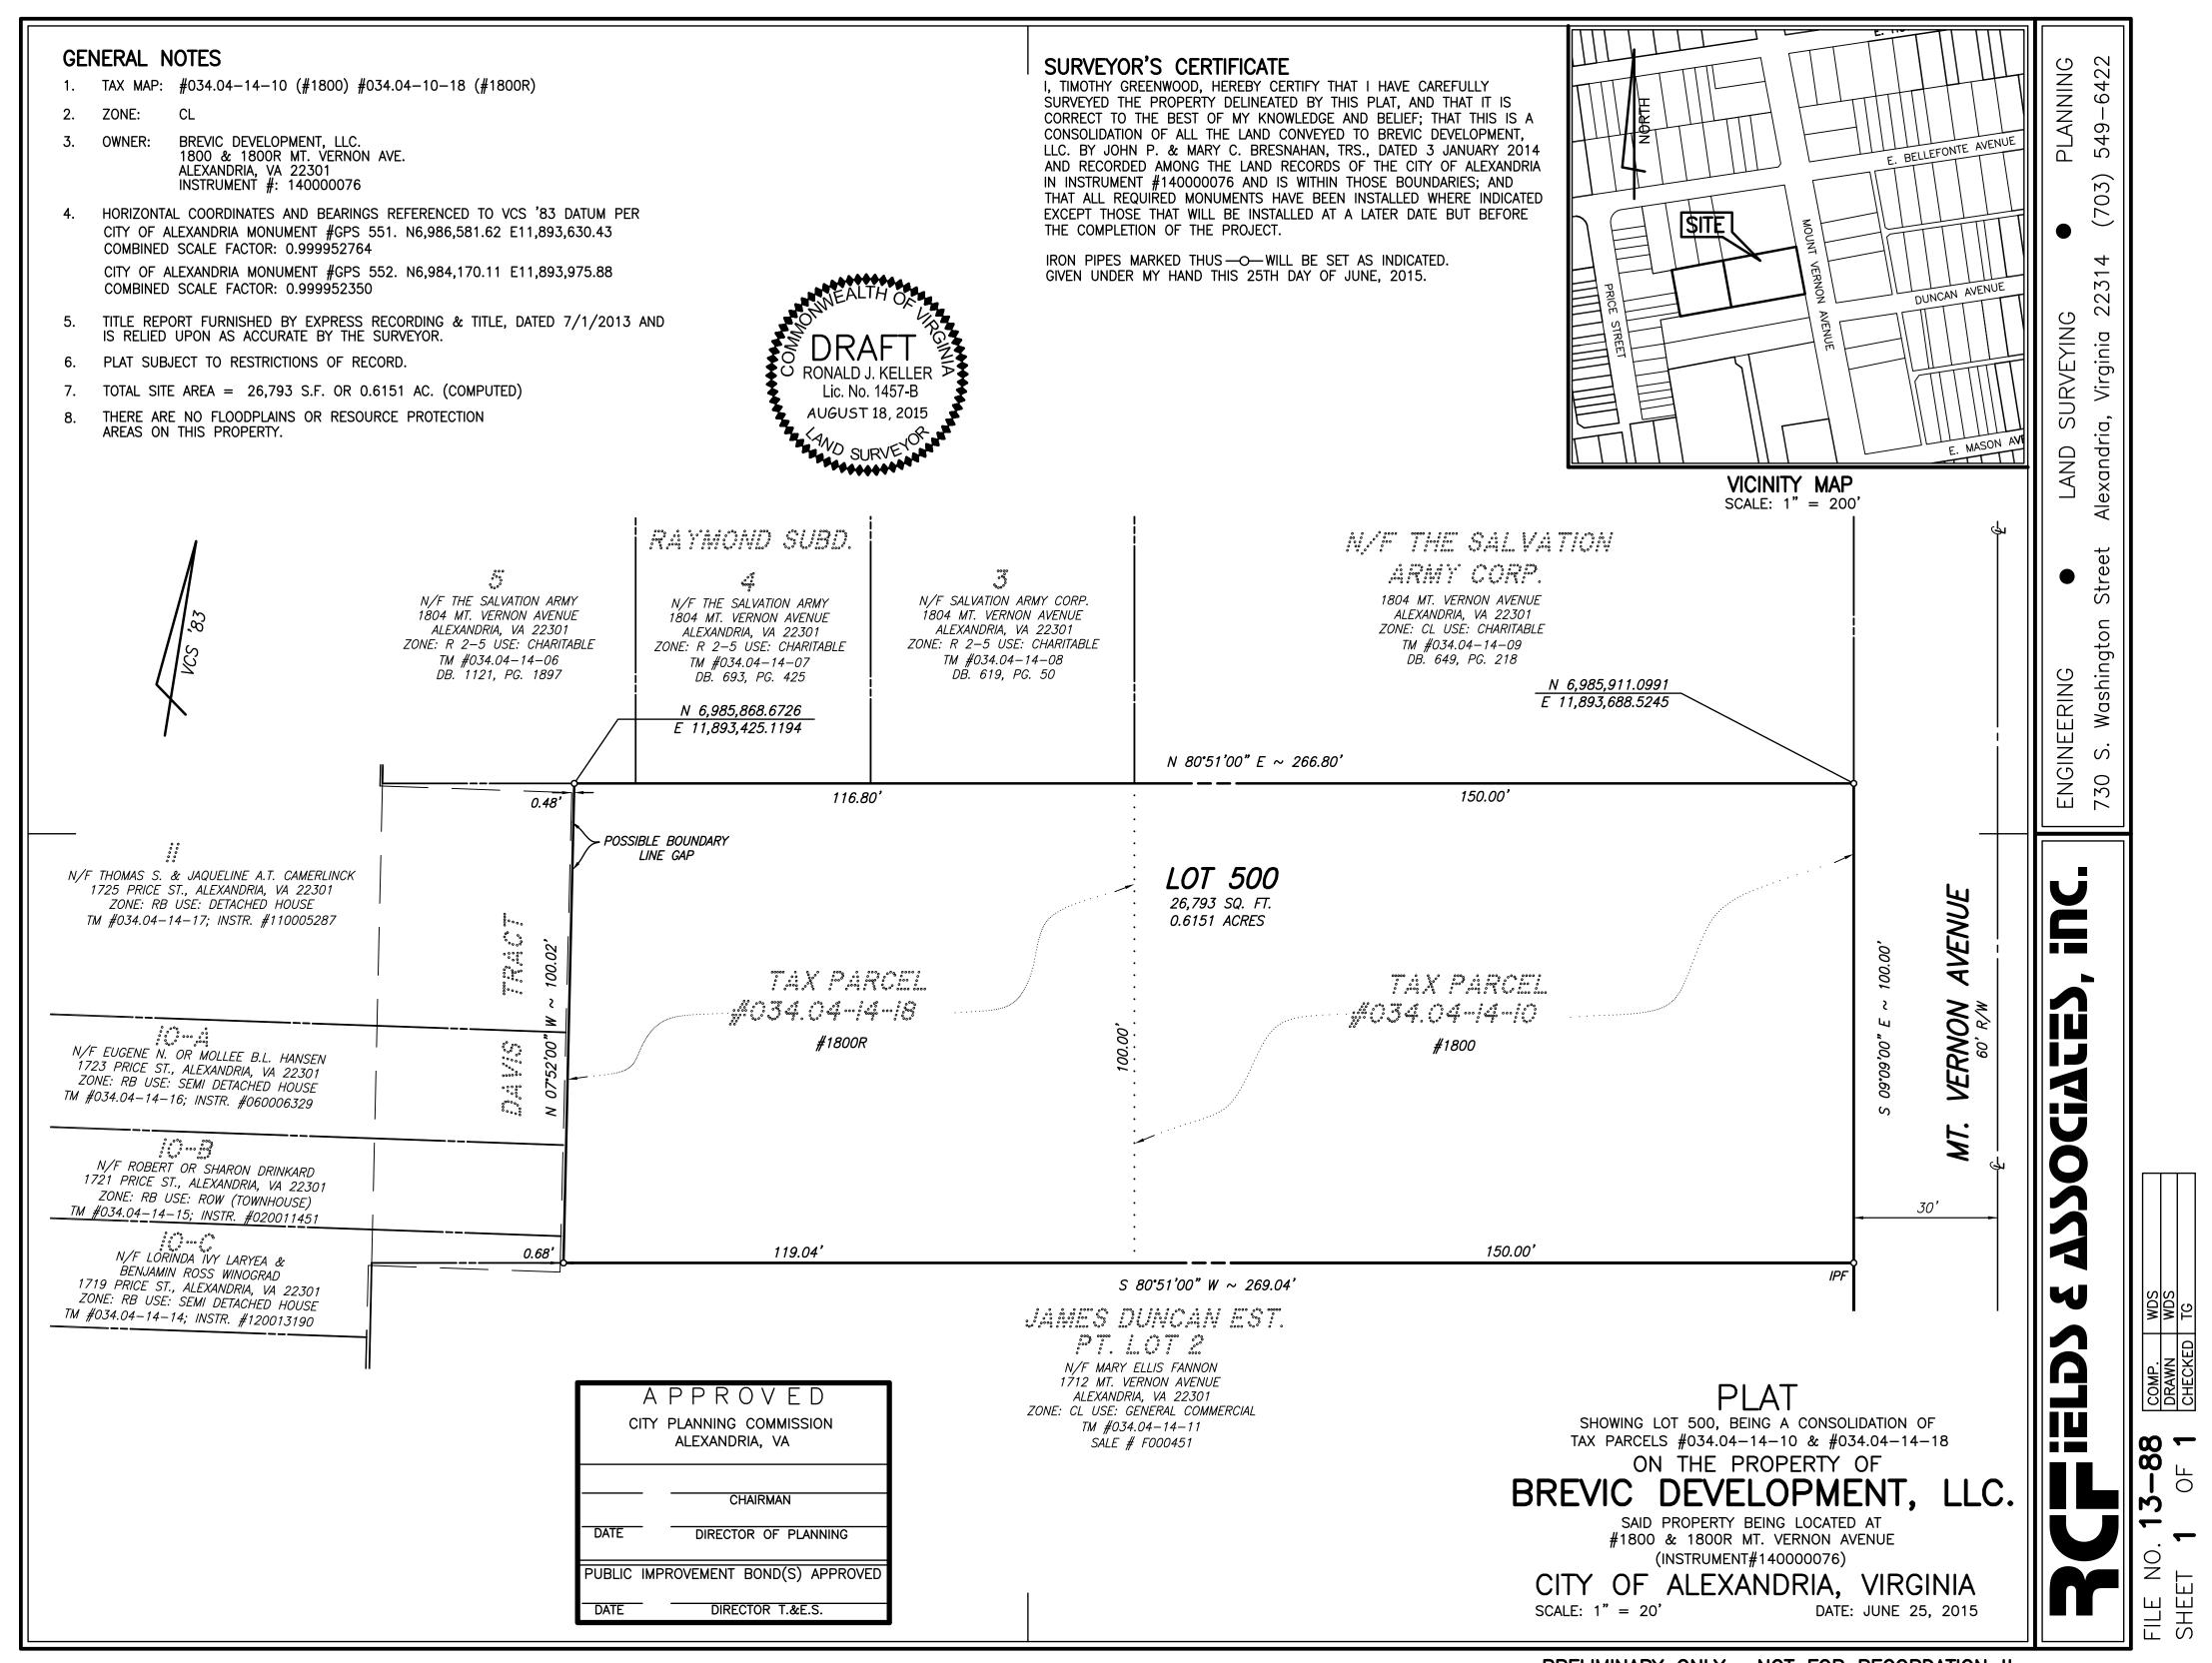
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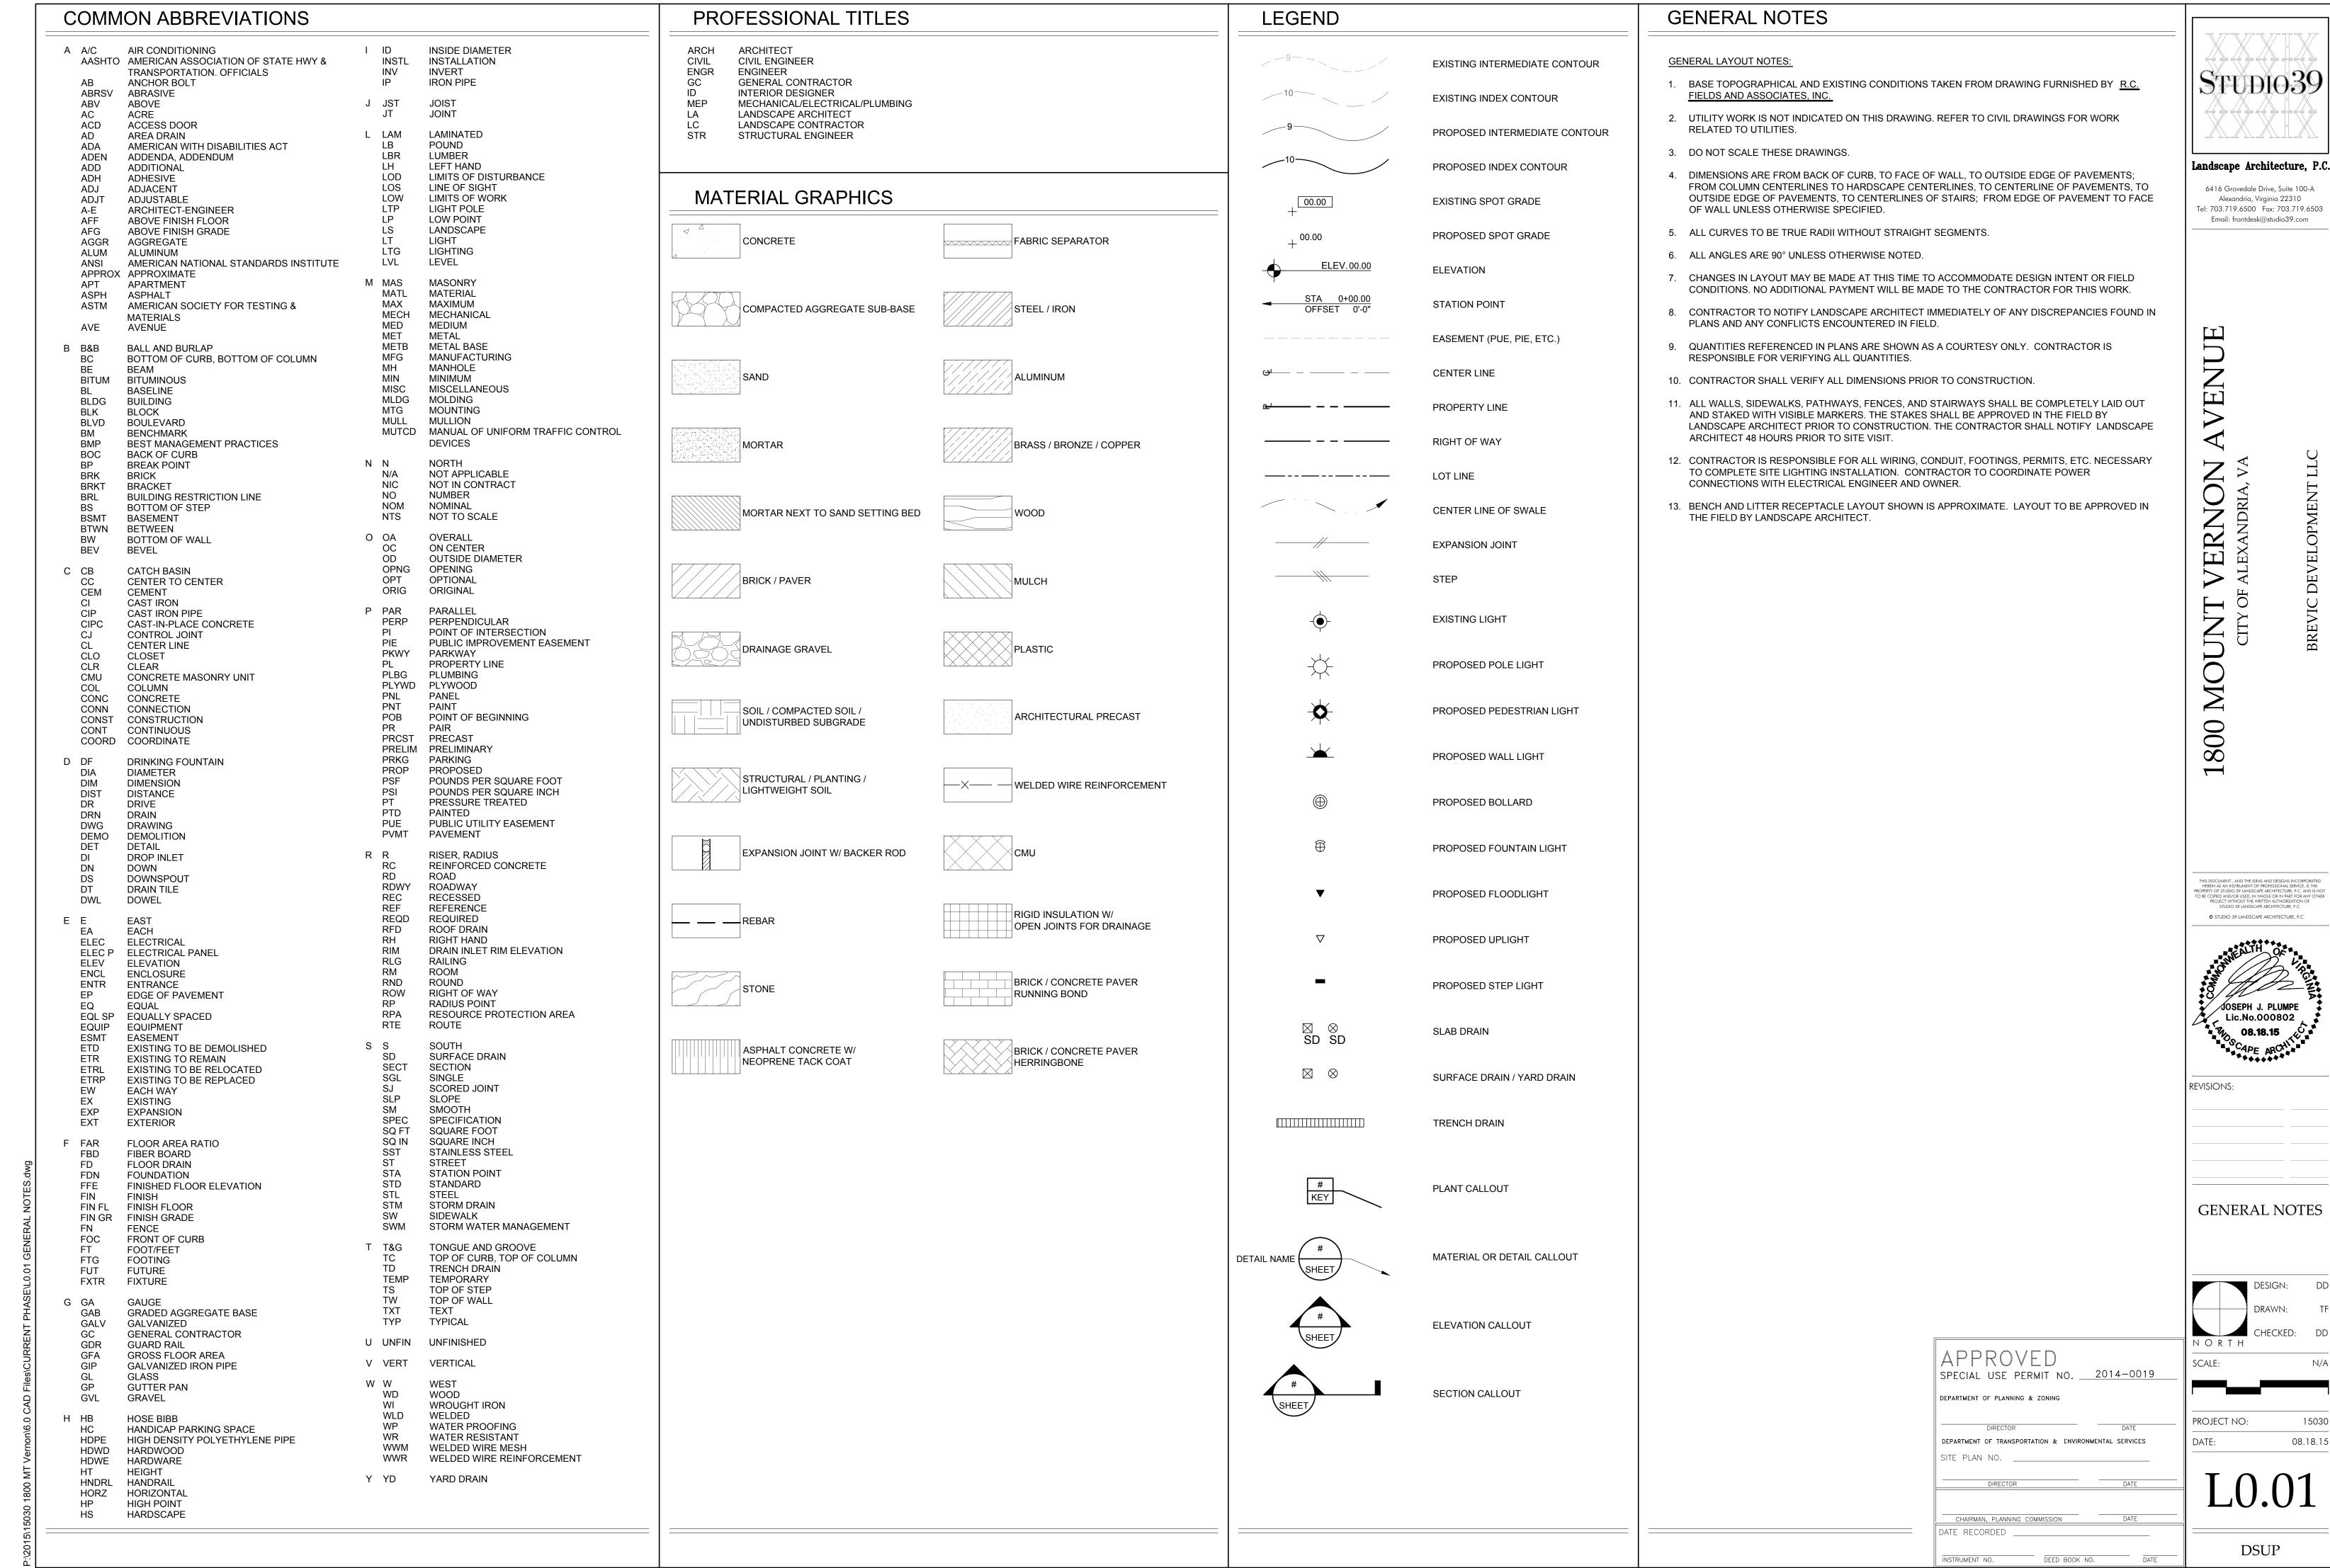
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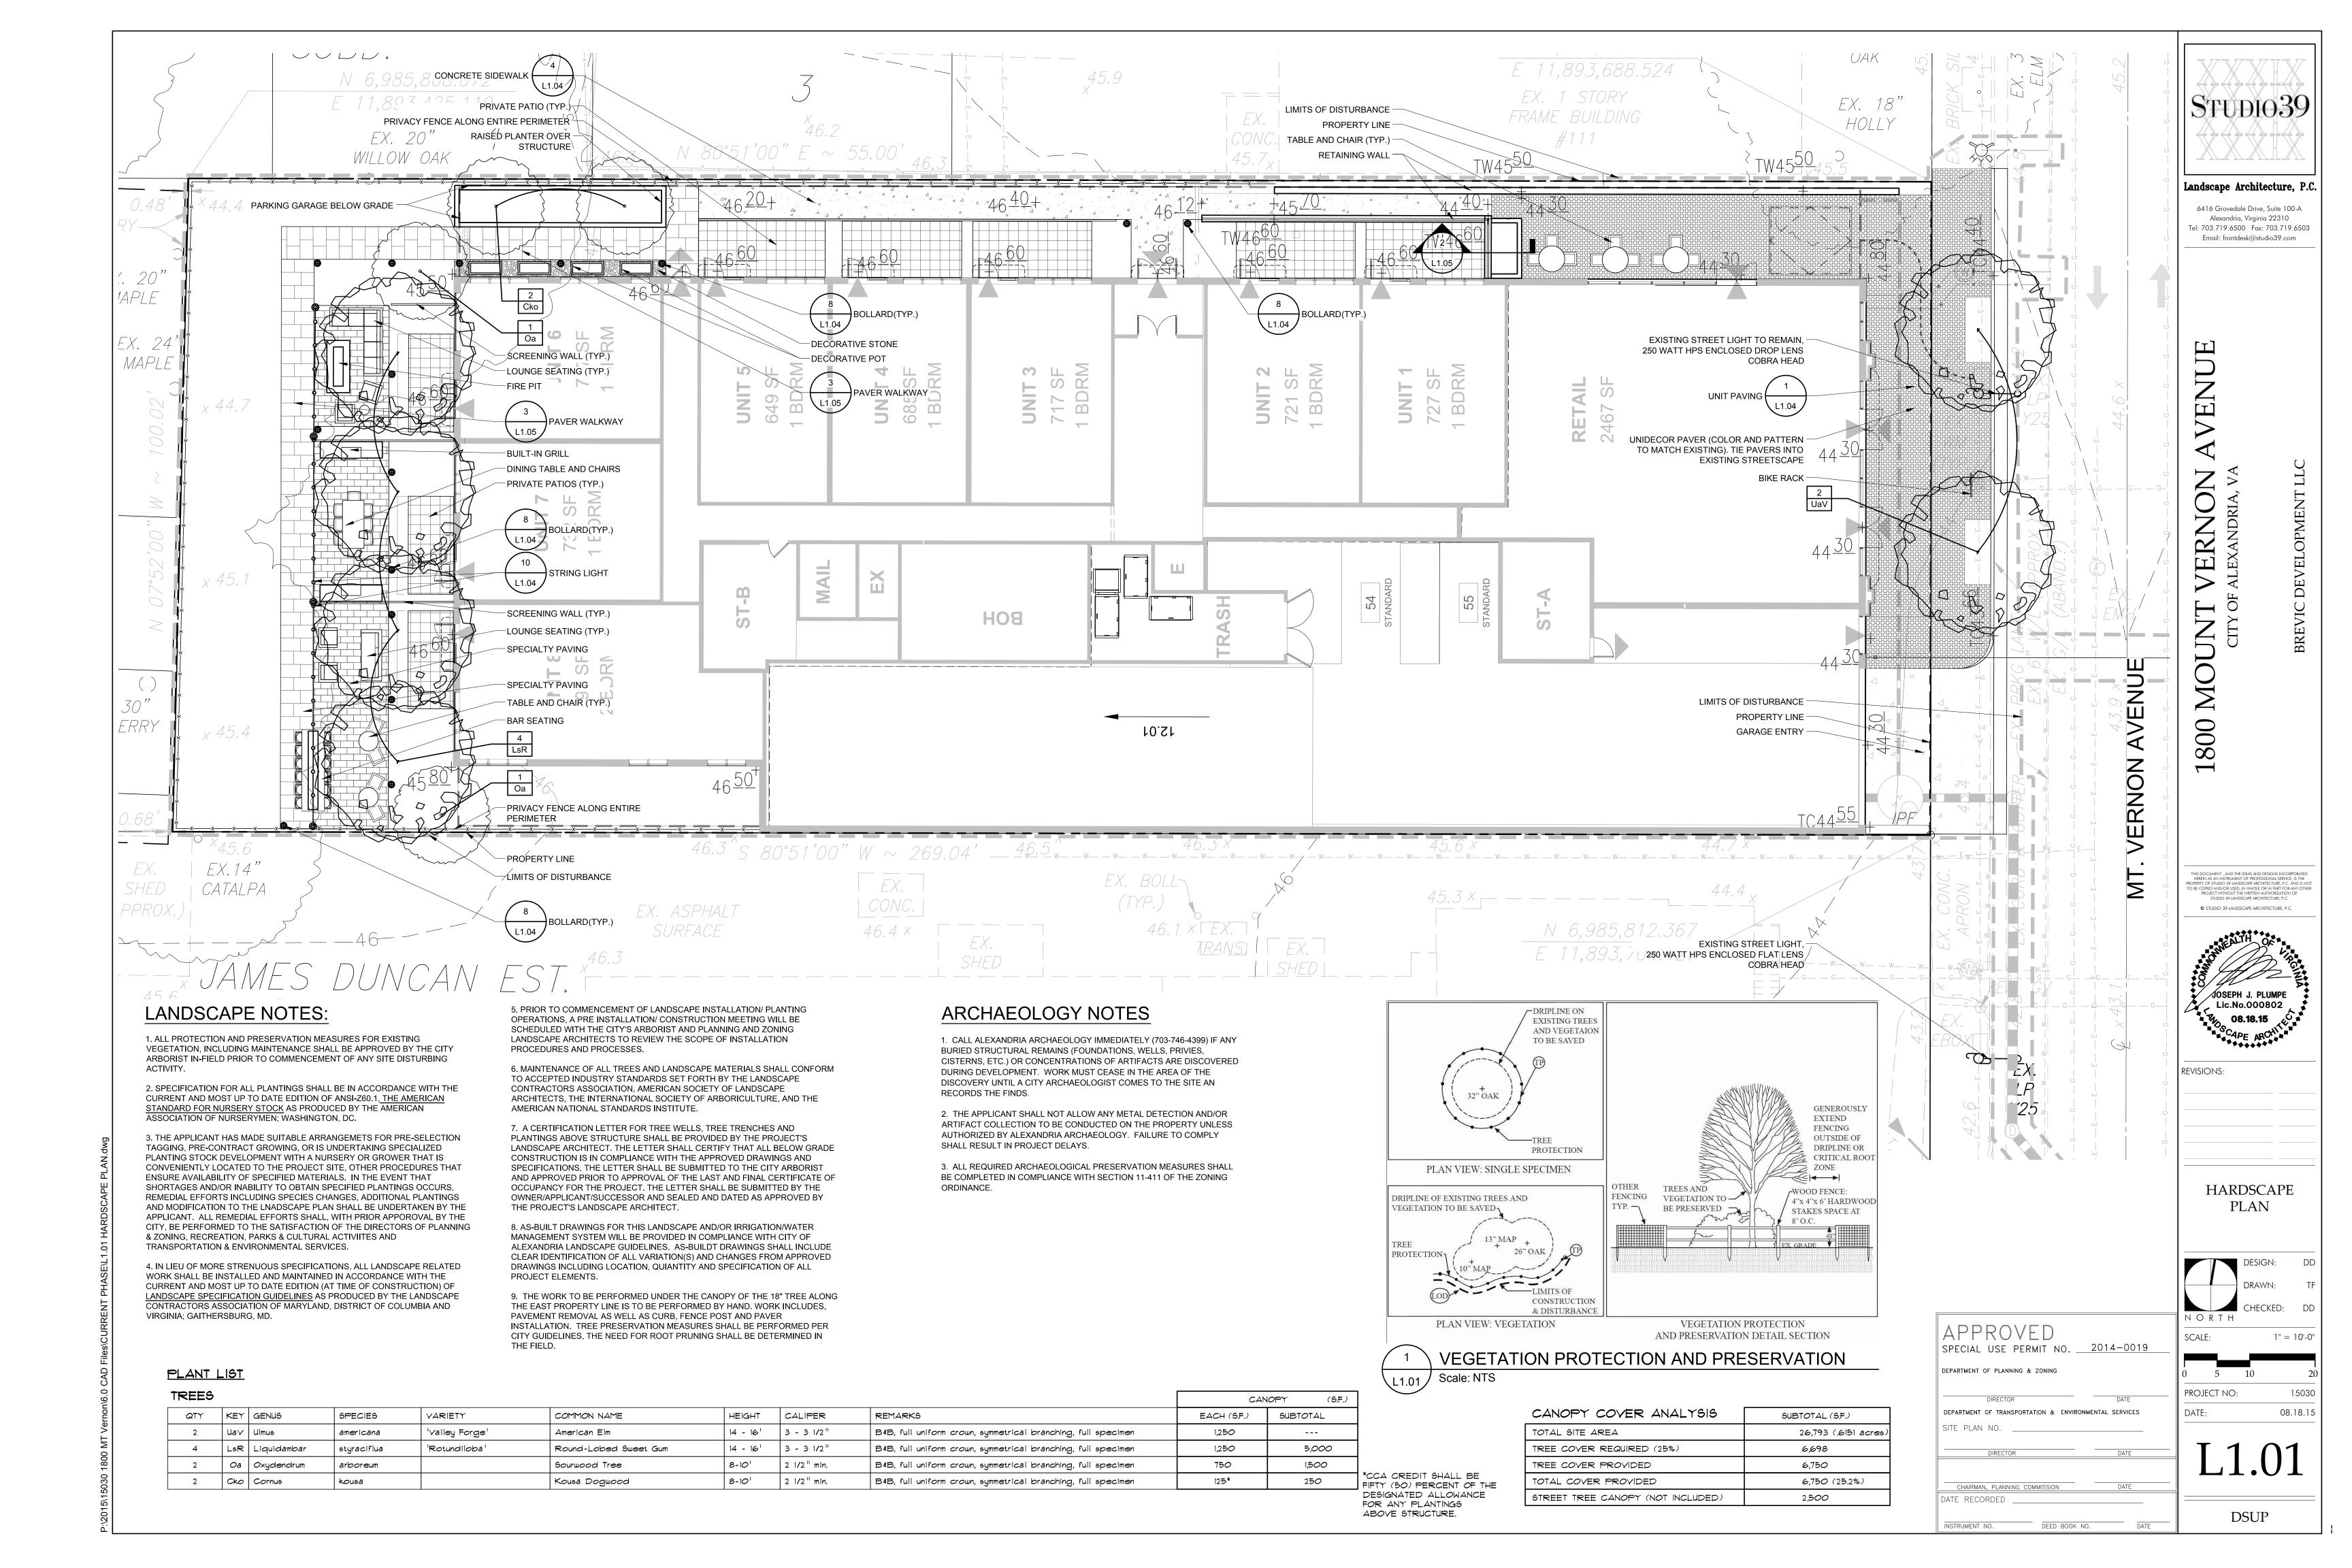
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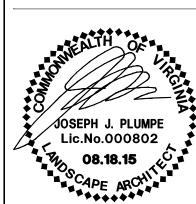
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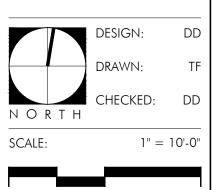








STUDIO39





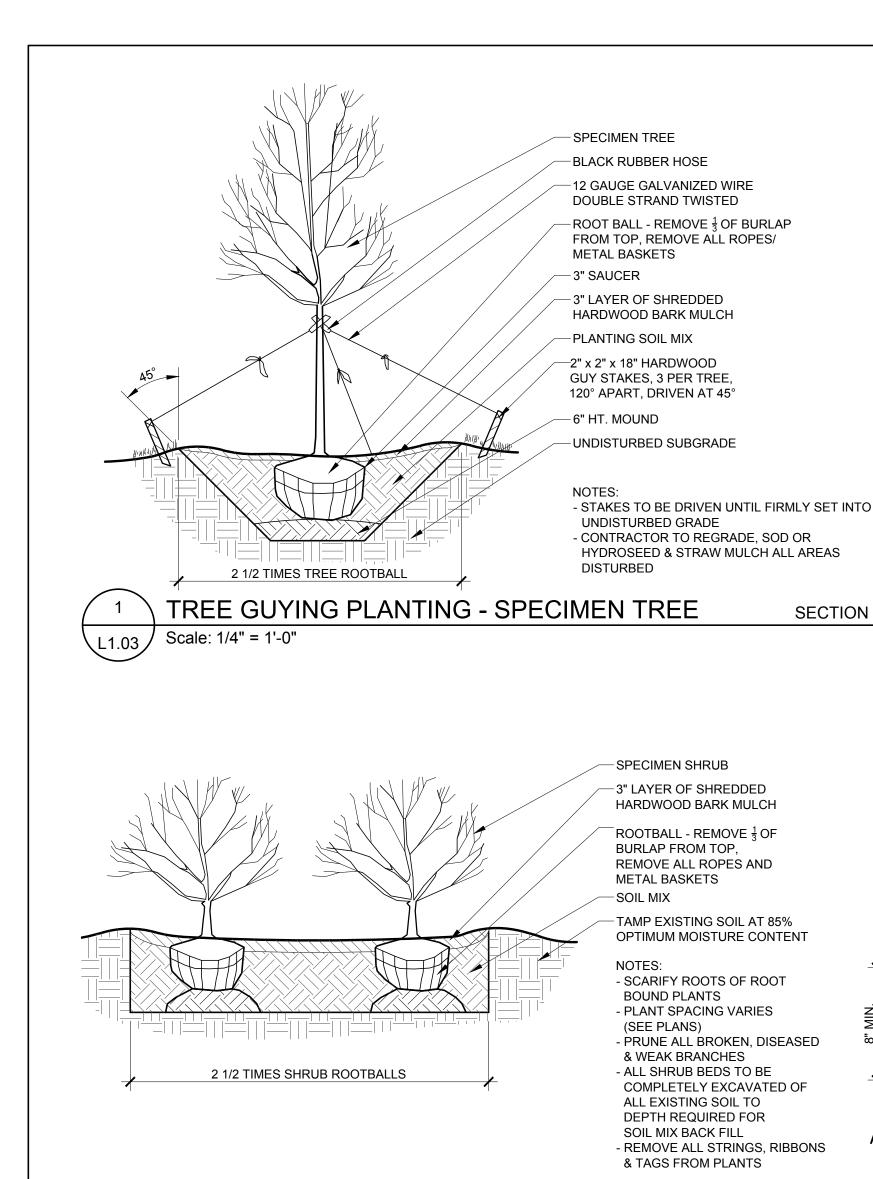

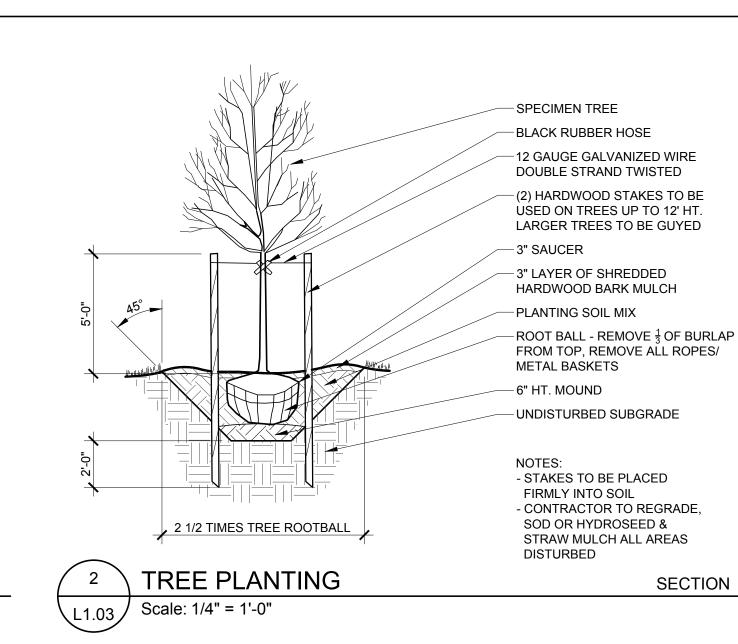

SPECIMEN PLANTS

BULB DEPTH 6-8"

-3" LAYER OF SHREDDED

FERTILIZER & CHEMICAL

ADDITIVE TO BE PLACED AT

6-8" DEPTH (AT ROOT ZONE)

- SOIL MIX: USE 3 PINE FINES (GROUND) OR EARTH LIFE,

BEDS  $\frac{1}{4}$  " MIN. TO NATURAL

SLOPE BOTTOM OF PREPARED

- MIX IN BONE MEAL AT BOTTOM

SECTION


OF BULBS WHEN PLANTED


<sup>1</sup>/<sub>6</sub> PERLITE, <sup>1</sup>/<sub>2</sub> TOP SOIL

LOW POINT

SUBGRADE


HARDWOOD BARK MULCH

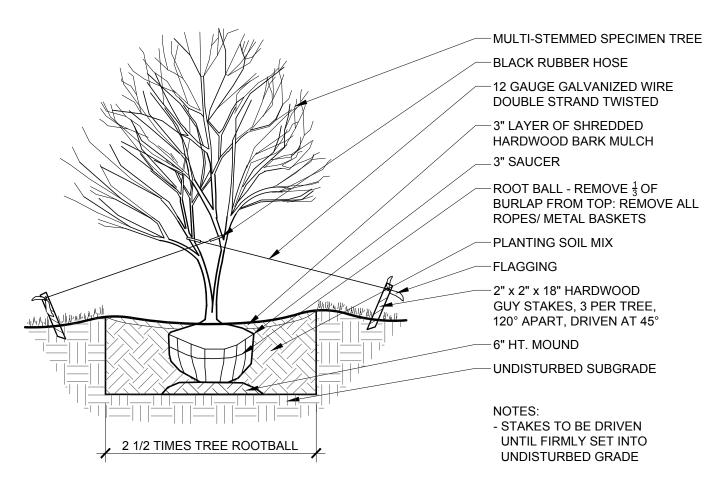


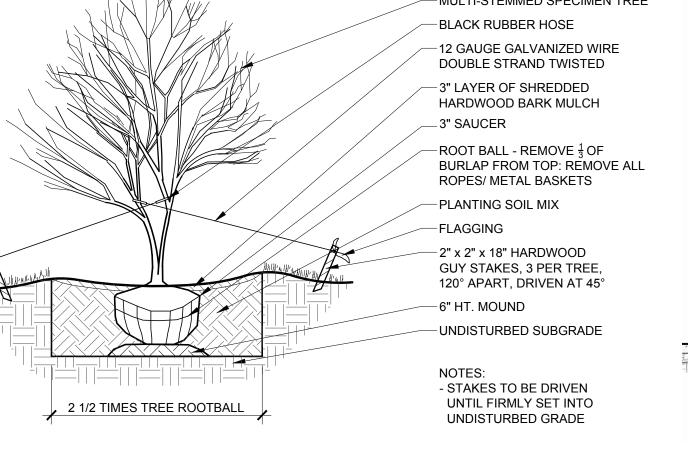

PLANT SPACING CHART


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PRUNE TO REMOVE DAMAGED

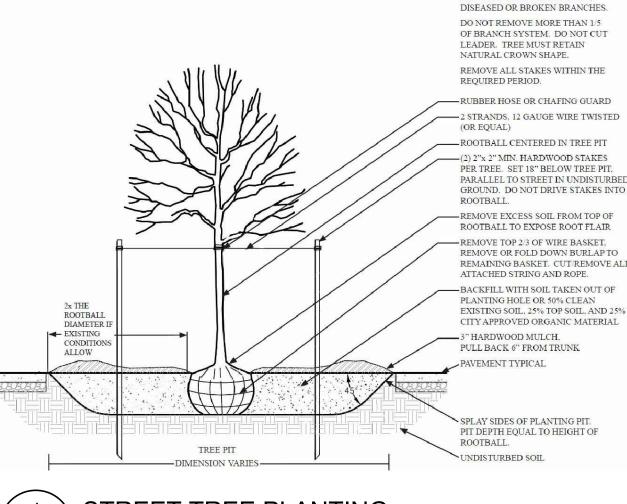STREET TREE PLANTING Scale: NTS L1.03

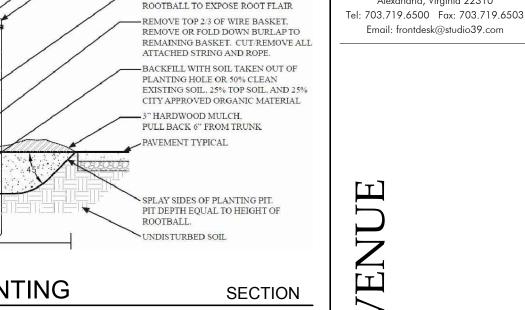

TREE PLANTING DETAIL

L1.03 / Scale: NTS
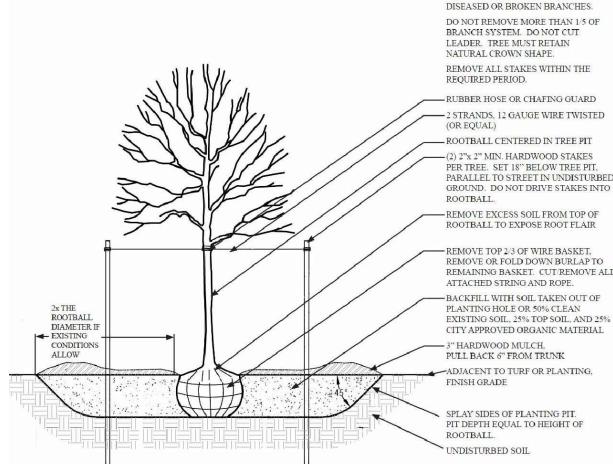
# PLANTING MIX NOTES:

- 1. THE RECOMMENDED PLANTING MEDIUM SHOULD CONTAIN GOOD TOP SOIL THAT WILL
- SUSTAIN PLANT GROWTH. 2. THE TOP SOIL SHALL NOT BE LACKING IN POTASSIUM, PHOSPHORUS, MAGNESIUM OR CALCIUM. THE TOP SOIL SHALL NOT CONTAIN ANY MATERIALS TOXIC TO PLANT
- 3. THE TOP SOIL SHALL BE A SANDY CLAY LOAM OR A SILTY CLAY LOAM WITH WELL AGGREGATED CLAYS AND A MINIMUM OF 4% (FOUR PERCENT) ORGANIC MATTER. 4. THE SOILS PH RANGE SHOULD BE WITHIN 5.5 TO 7.0 AND ADJUSTED AS NECESSARY
- FOR INDIVIDUAL PLANT SPECIES REQUIREMENTS. 5. A SOIL TEST SHALL BE PERFORMED BY A FULL-SERVICE TESTING COMPANY AND THE RESULTS SHALL BE PROVIDED TO THE LANDSCAPE ARCHITECT PRIOR TO

APPROVED

DEPARTMENT OF PLANNING & ZONING

CHAIRMAN, PLANNING COMMISSION

DEED BOOK NO.

INSTALLATION OF PLANTING MEDIUM. 6. IF A LOCAL, REPUTABLE TESTING COMPANY CANNOT BE EMPLOYED, A&L LABS IS AVAILABLE TO CONDUCT THE TESTING. CONTACT THEM AT:

A&L ANALYTICAL LABORATORIES, INC. 2790 WHITTEN ROAD MEMPHIS, TN 38133

1-800-264-4522

7. THE LAB SHALL PERFORM AN S1A TEST AND SUBMIT THE RESULTS TO STUDIO 39 LANDSCAPE ARCHITECTURE, PC.

# **SECTION**

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RTY OF STUDIO 39 LANDSCAPE ARCHITECTURE, P.C. AND

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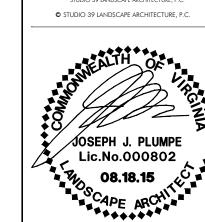
STUDIO39

andscape Architecture, P.C

6416 Grovedale Drive, Suite 100-A

Alexandria, Virginia 22310

Email: frontdesk@studio39.com



**REVISIONS:** 

LANDSCAPE

NOTES AND **DETAILS** DESIGN: DRAWN:

CHECKED: as shown SPECIAL USE PERMIT NO. \_\_\_\_2014-0019 PROJECT NO: 08.18.15

DSUP

AS SPECIFIED ON PLANT LIST NUMBER OF PLANTS PER SQUARE FOOT 5 1/4" o.c. 4.62 6" o.c. 2.60 8" o.c. 6 7/8" o.c. 10" o.c. 8 5/8" o.c. 1.66 12" o.c. 1.15 10 3/8" o.c. 15" o.c. 13" o.c. 0.74 0.51 18" o.c. 15 5/8" o.c. 0.29 24" o.c. 20 3/4" o.c. 30" o.c. 0.18 26" o.c 31 1/8" o.c. 0.13 0.09 42" o.c. 36 3/8" o.c.

TREE GUYING PLANTING - MULTI-STEMMED

TRIANGULAR SPACING FOR SHRUBS -**GROUND COVERS - BULBS AND PERENNIALS** / Scale: 1" = 1'-0" L1.03

48" o.c.

# PLANTING NOTES

Scale: 1/2" = 1'-0"

\L1.03/

SPECIFICATIONS.

SHRUB PLANTING

1. PLANT MATERIAL SHALL BE FURNISHED AND INSTALLED AS INDICATED, INCLUDING ALL LABOR, MATERIALS, PLANTS, EQUIPMENT, INCIDENTALS, AND CLEAN-UP.

**SECTION** 

**SECTION** 

2% SLOPE

Scale: 1" = 1'-0"

L1.03

**ANNUAL & PERENNIAL PLANTING** 

- 2. THE CONTRACTOR SHALL BE RESPONSIBLE FOR PLANTING AT CORRECT GRADES AND ALIGNMENT. LAYOUT TO BE APPROVED BY OWNERS' REPRESENTATIVE PRIOR TO INSTALLATION.
- 3. PLANTS SHALL BE TYPICAL OF THEIR SPECIES AND VARIETY; HAVE NORMAL GROWTH HABITS, WELL-DEVELOPED DENSELY FOLIATED BRANCHES, AND VIGOROUS ROOT SYSTEMS; AND BE FREE FROM DEFECTS AND INJURIES.
- 4. CONTRACTOR SHALL REPORT ANY SOIL OR DRAINAGE CONDITIONS CONSIDERED DETRIMENTAL TO GROWTH OF PLANT MATERIAL 5. ALL PLANT MATERIAL SHALL BE GUARANTEED BY THE CONTRACTOR TO BE IN VIGOROUS GROWING CONDITION. PROVISION SHALL BE MADE FOR A GROWTH GUARANTEE OF AT LEAST ONE YEAR FROM THE DATE OF ACCEPTANCE FOR TREES, SHRUBS, GROUNDCOVER AND PERENNIALS.
- REPLACEMENTS SHALL BE MADE AT THE BEGINNING OF THE FIRST SUCCEEDING PLANTING SEASON. ALL REPLACEMENTS SHALL HAVE A GUARANTEE EQUAL TO THAT STATED ABOVE. 6. PLANT MATERIAL SHALL BE PLANTED ON THE DAY OF DELIVERY IF/WHEN PRACTICAL. IN THE EVENT THAT THIS IS NOT POSSIBLE, THE CONTRACTOR


7. QUALITY AND SIZE OF PLANTS, SPREAD OF ROOTS, AND SIZE OF ROOT BALL SHALL BE IN ACCORDANCE WITH THE MOST RECENT VERSION OF ANSI Z60

- SHALL PROTECT STOCK NOT PLANTED. PLANTS SHALL NOT REMAIN UNPLANTED FOR LONGER THAN A THREE-DAY PERIOD AFTER DELIVERY. ANY PLANTS NOT INSTALLED DURING THIS PERIOD SHALL BE REJECTED, UNLESS OWNER AND CONTRACTOR PROVIDE OTHERWISE BY WRITTEN AGREEMENT.
- "AMERICAN STANDARD FOR NURSERY STOCK" PUBLISHED BY THE AMERICAN ASSOCIATION OF NURSERYMEN, INC. 8. ALL PLANTS SHALL BE PLANTED IN AMENDED TOP SOIL THAT IS THOROUGHLY WATERED AND TAMPED AS BACK-FILLING PROCESSES. PLANTING MIX TO BE AS SHOWN ON PLANTING DETAILS. LARGE PLANTING AREAS TO INCORPORATE FERTILIZER AND SOIL CONDITIONERS AS STATED IN PLANTING
- 9. PLANTS SHALL NOT BE BOUND WITH WIRE OR ROPE AT ANY TIME SO AS TO DAMAGE THE BARK OR BREAK BRANCHES. PLANTS SHALL BE HANDLED FORM THE BOTTOM OF THE BALL ONLY.
- 10. PLANTING OPERATIONS SHALL BE PERFORMED DURING PERIODS WITHIN THE PLANTING SEASON WHEN WEATHER AND SOIL CONDITIONS ARE SUITABLE AND IN ACCORDANCE WITH ACCEPTED LOCAL PRACTICE. PLANTS SHALL NOT BE INSTALLED IN TOP SOIL THAT IS IN A MUDDY OR FROZEN CONDITION. ALL PLANT MATERIAL SHALL BE SPRAYED WITH "WILT-PRUF" OR EQUAL AS PER MANUFACTURER'S INSTRUCTIONS.
- 11.NO PLANT, EXCEPT GROUND COVERS, SHALL BE PLANTED LESS THAN TWO FEET FROM EXISTING STRUCTURES AND SIDEWALKS. 12. SET ALL PLANTS PLUMB AND STRAIGHT. SET AT SUCH LEVEL THAT A NORMAL OR NATURAL RELATIONSHIP TO THE GROUND IF THE PLANT WITH THE
- GROUND SURFACE WILL BE ESTABLISHED. LOCATE THE PLANT IN THE CENTER OF THE PIT 13. ALL INJURED ROOTS SHALL BE PRUNED TO MAKE CLEAN ENDS BEFORE PLANTING UTILIZING CLEAN, SHARP TOOLS. IT IS ADVISABLE TO PRUNE
- APPROXIMATELY 1/3 OF THE GROWTH OF LARGE TREES (2" CALIPER AND GREATER) BY THE REMOVAL OF SUPERFLUOUS BRANCHES, THOSE WHICH CROSS, THOSE WHICH RUN PARALLEL, ETC. MAIN LEADER OF TREES SHALL NOT BE CUT BACK. LONG SIDES BRANCHES SHALL BE SHORTENED. 14.EACH TREE AND SHRUB SHALL BE PRUNED IN ACCORDANCE WITH STANDARD HORTICULTURAL PRACTICE TO PRESERVE THE NATURAL CHARACTER OF PLANT. PRUNING SHALL BE DONE WITH CLEAN, SHARP TOOLS.
- 15. TREES SHALL BE SUPPORTED IMMEDIATELY AFTER PLANTING. ALL TREES 6" AND GREATER IN CALIPER SHALL BE GUYED. SMALLER TREES SHALL BE STAKED. GUYING WIRES AND STAKES SHALL BE INSTALLED AS INDICATED. THE LANDSCAPE CONTRACTOR SHALL REMOVE STAKING, GUYING AND TREE WRAP AT THE END OF ONE YEAR MAINTENANCE AND GUARANTEE PERIOD.
- 16. ALL PLANTING BEDS SHALL BE MULCHED WITH 3" LAYER OF MULCH. 17. NEW PLANTING AREAS AND SOD SHALL BE ADEQUATELY WATERED TO ESTABLISH THE PROPOSED PLANTS AND LAWN.
- 18. ALL PLANTS SHOWN ON THE APPROVED LANDSCAPE PLAN SHALL BE INSTALLED, INSPECTED AND APPROVED BY THE LANDSCAPE ARCHITECT OR HIS REPRESENTATIVE. THE LANDSCAPE ARCHITECT SHALL TAKE INTO ACCOUNT SEASONAL CONSIDERATIONS IN THIS REGARD. TREES, SHRUBS, VINES AND GROUNDCOVER AS REQUIRED BY OR ASSOCIATED WITH A SUBDIVISION OR SITE PLAN APPROVED BY THE PLANNING AUTHORITIES SHALL BE INSTALLED DURING THE FOLLOWING PLANTING SEASONS: LAWNS: 03/15 TO 06/15 AND 09/15 TO 12/01. THE FOLLOWING TREE VARIETIES SHALL NOT BE PLANTED DURING THE FALL PLANTING SEASON DUE TO THE HAZARDS ASSOCIATED WITH PLANTING THESE TREES IN THIS SEASON: ACER RUBRUM POPULUS SPP.; BETULA SPP. PRUNUS SPP.; CARPINUS SPP. PYRUS SPP.; CRATECUS SPP. QUERCUS SPP.; KOELREUTERIA PANICULATA SALIX SPP.; LIQUIDAMBAR STYRACIFLUA TILIA TOMENTOSA; LIRIODENDRON TULIPIFERA ZELKOVA; PLATANUS ACERIFOLIA; ANY PLANTING INSTALLED IN CONFLICT WITH THIS REQUIREMENT MUST RECEIVE WRITTEN APPROVAL OF THE LANDSCAPE ARCHITECT PRIOR TO PLANTING. FAILURE TO COMPLY WITH THESE REQUIREMENTS WILL REQUIRE THE REMOVAL OF THE PLANTING IN QUESTION. THIS REQUIREMENT DOES NOT APPLY TO SEEDING OR SODDING OR PLANTINGS SPECIFICALLY FOR SOIL STABILIZATION PURPOSES. PLANTINGS ASSOCIATED WITH ANY LOT GIVEN A CERTIFICATE OF OCCUPANCY OUTSIDE THESE PERIODS SHALL BE PROVIDED DURING THE PREVIOUS OR NEXT APPROPRIATE SEASON.
- 19. ALL DISTURBED AREAS SHALL BE TREATED WITH 4" TOP SOIL SODDED OR SEEDED AS NOTED IN ACCORDANCE WITH PERMANENT STABILIZATION METHODS INDICATED ON SOIL EROSION AND SEDIMENT CONTROL SHEET.

20.CONTRACTOR SHALL BE SOLELY RESPONSIBLE FOR ALL PLANT MAINTENANCE; INCLUDING SHRUBS AND GROUNDCOVER, AND SHALL MAINTAIN AREA IN A WEED AND DEBRIS FREE CONDITION THROUGHOUT THE ONE-YEAR GUARANTEE PERIOD, UNLESS OTHERWISE SPECIFIED.

Scale: 1/4" = 1'-0"

- 21.CONTRACTOR SHALL LAYOUT AND CLEARLY STAKE ALL PROPOSED IMPROVEMENTS INCLUDED ON THIS PLAN. 22.CONTRACTOR TO VERIFY PLANT LIST TOTALS WITH QUANTITIES SHOWN ON PLAN. LANDSCAPE ARCHITECT SHALL BE ALERTED BY CONTRACTOR OF ANY DISCREPANCIES PRIOR TO FINAL BID NEGOTIATION. UNIT PRICES FOR ALL MATERIAL SHALL BE SUPPLIED TO THE OWNER AT BIDDING TIME
- 23.ALL MATERIALS SHALL BE SUBJECT TO APPROVAL BY THE LANDSCAPE ARCHITECT. OWNER SHALL RECEIVE TAG FROM EACH PLANT SPECIES AND A LIST OF PLANT SUPPLIERS. WHERE ANY REQUIREMENTS ARE OMITTED FROM THE PLANT LIST, THE PLANTS FURNISHED SHALL MEET THE NORMAL REQUIREMENTS FOR THE VARIETY PER THE AMERICAN STANDARD FOR NURSERY STOCK, LATEST EDITION, PUBLISHED BY THE AMERICAN ASSOCIATION
- OF NURSERYMEN (AAN). PLANTS SHALL BE PRUNED PRIOR TO DELIVERY ONLY UPON THE APPROVAL OF THE LANDSCAPE ARCHITECT 24.SIZES SPECIFIED IN THE PLANT LIST ARE MINIMUM SIZES TO WHICH THE PLANTS ARE TO BE JUDGED. FAILURE TO MEET MINIMUM SIZE ON ANY PLANT WILL RESULT IN REJECTION OF THAT PLANT.
- 25.ALL PLANTS SHALL BE FRESHLY DUG, SOUND, HEALTHY, VIGOROUS, WELL BRANCHED, FREE OF DISEASE, INSECT EGGS, AND LARVAE, AND SHALL HAVE ADEQUATE ROOT SYSTEMS.
- 26.ALL CONTAINER GROWN MATERIAL SHALL BE HEALTHY, VIGOROUS, WELL-ROOTED PLANTS AND ESTABLISHED IN THE CONTAINER IN WHICH THEY ARE SOLD. THE PLANTS SHALL HAVE TOPS WHICH ARE GOOD QUALITY AND ARE IN A HEALTHY GROWING CONDITION. 27.GROUPS OF SHRUBS SHALL BE PLACED IN A CONTINUOUS MULCH BED WITH SMOOTH CONTINUOUS LINES. ALL MULCHED BED EDGES SHALL BE
- CURVILINEAR IN SHAPE FOLLOWING THE CONTOUR OF THE PLANT MASS. TREES LOCATED WITHIN FOUR FEET OF SHRUB BEDS SHALL SHARE SAME MULCH BED. 28.TREES SHALL BE LOCATED A MINIMUM OF 3' - 4' FROM WALLS AND WALKS WITHIN THE PROJECT. IF CONFLICTS ARISE BETWEEN ACTUAL SIZE OF AREA AND PLANS, CONTRACTOR SHALL CONTACT LANDSCAPE ARCHITECT FOR RESOLUTION. FAILURE TO MAKE SUCH CONFLICTS KNOWN TO THE OWNER OR
- LANDSCAPE ARCHITECT WILL RESULT IN CONTRACTOR'S LIABILITY TO RELOCATE MATERIALS. 29.TREE STAKING AND GUYING SHALL BE DONE PER DETAILS. CONTRACTOR SHALL ENSURE THAT TREES REMAIN VERTICAL AND UPRIGHT FOR THE
- DURATION OF THE GUARANTEE PERIOD. 30.CROWN OF ROOT BALL SHALL BE HIGHER (AFTER SETTLING) THAN ADJACENT SOIL.
- 31.TAGS AND TWINE ARE TO BE REMOVED AND BURLAP IS TO BE ROLLED BACK ONE-THIRD ON ALL B&B PLANT MATERIAL. REMOVE BURLAP IF IT IS NON-BIODEGRADABLE. FOR STREET TREES TAGS, TWINE, CORD, BURLAP AND WIRE BASKET TO BE CUT 12" DOWN SIDE OF ROOT BALL AND REMOVED 32.SHRUBS AND GROUND COVERS SHALL BE TRIANGULARLY SPACED AT SPACING SHOWN ON PLANTING PLANS.
- 33.SHADE TREES: HEIGHT SHALL BE MEASURED FROM THE CROWN OF THE ROOT BALL TO THE TOP OF MATURE GROWTH. SPREAD SHALL BE MEASURED TO THE END OF BRANCHING EQUALLY AROUND THE CROWN FROM THE CENTER OF THE TRUNK. MEASUREMENTS ARE NOT TO INCLUDE ANY TERMINAL GROWTH. SINGLE TRUNK TREES SHALL BE FREE OF "V" CROTCHES THAT COULD BE POINTS OF WEAK LIMB STRUCTURE OR DISEASE INFESTATION. SHRUBS: HEIGHT SHALL BE MEASURED FROM THE GROUND TO THE AVERAGE HEIGHT OF THE TOP OF THE PLANT. SPREAD SHALL BE MEASURED TO THE END OF BRANCHING EQUALLY AROUND THE SHRUB MASS. MEASUREMENTS ARE NOT TO INCLUDE ANY TERMINAL GROWTH
- 34.ALL SUBSTITUTIONS OF PLANT MATERIAL ARE TO BE REQUESTED IN WRITING TO THE LANDSCAPE ARCHITECT AND APPROVED BY THE OWNER. IF CONTRACTOR FAILS TO SUBMIT A WRITTEN REQUEST, IT WILL RESULT IN LIABILITY TO THE CONTRACTOR.
- 35.ALL CONTRACTORS SHALL BE REQUIRED TO COMPLETELY REMOVE ALL TRASH, DEBRIS AND EXCESS MATERIALS FROM THE WORK AREA AND THE PROPERTY, ESPECIALLY AT ALL CURB, GUTTERS AND SIDEWALKS DAILY DURING INSTALLATION.
- 36.DEAD PLANTS ARE TO BE REMOVED FROM THE JOB BY THE CONTRACTOR WEEKLY. CONTRACTOR SHALL MAINTAIN AN UPDATED, COMPREHENSIVE LIST OF ALL DEAD MATERIALS REMOVED FROM THE JOB SITE. A COPY OF THE LIST IS TO BE SUBMITTED TO THE OWNER AT THE END OF EVERY MONTH DURING THE CONTRACT PERIOD.
- 37.TOPSOIL REQUIRED FOR SOIL MIXES AND SPECIAL SEEDING AREAS SHALL BE PROVIDED BY LANDSCAPE CONTRACTOR. CONTRACTOR MUST LOAD, HAUL
- MIX, AND SPREAD ALL TOPSOIL AND OTHER SOIL ADDITIVES ARE REQUIRED. 38.CONTRACTOR SHALL GUARANTEE ALL LANDSCAPE IMPROVEMENTS, INCLUDING SEEDING, FOR ONE FULL YEAR AS REQUIRED BY THE SPECIFICATIONS. CONTRACTOR MUST CONTACT THE OWNER AT LEAST TEN WORKING DAYS IN ADVANCE TO SCHEDULE ACCEPTANCE INSPECTION(S). CONTRACTOR MUST
- REPLACE ALL DEAD OR UNACCEPTABLE PLANTS DURING THE FOLLOWING RECOMMENDED PLANTING SEASON. 39. THE SPECIFICATIONS FOR ALL WORK INCLUDED IN THIS CONTRACT SHALL BE LANDSCAPE SPECIFICATIONS GUIDELINES FOR BALTIMORE-WASHINGTON METROPOLITAN AREA, CURRENT EDITION, UNLESS OTHERWISE NOTED ON THESE PLANS.

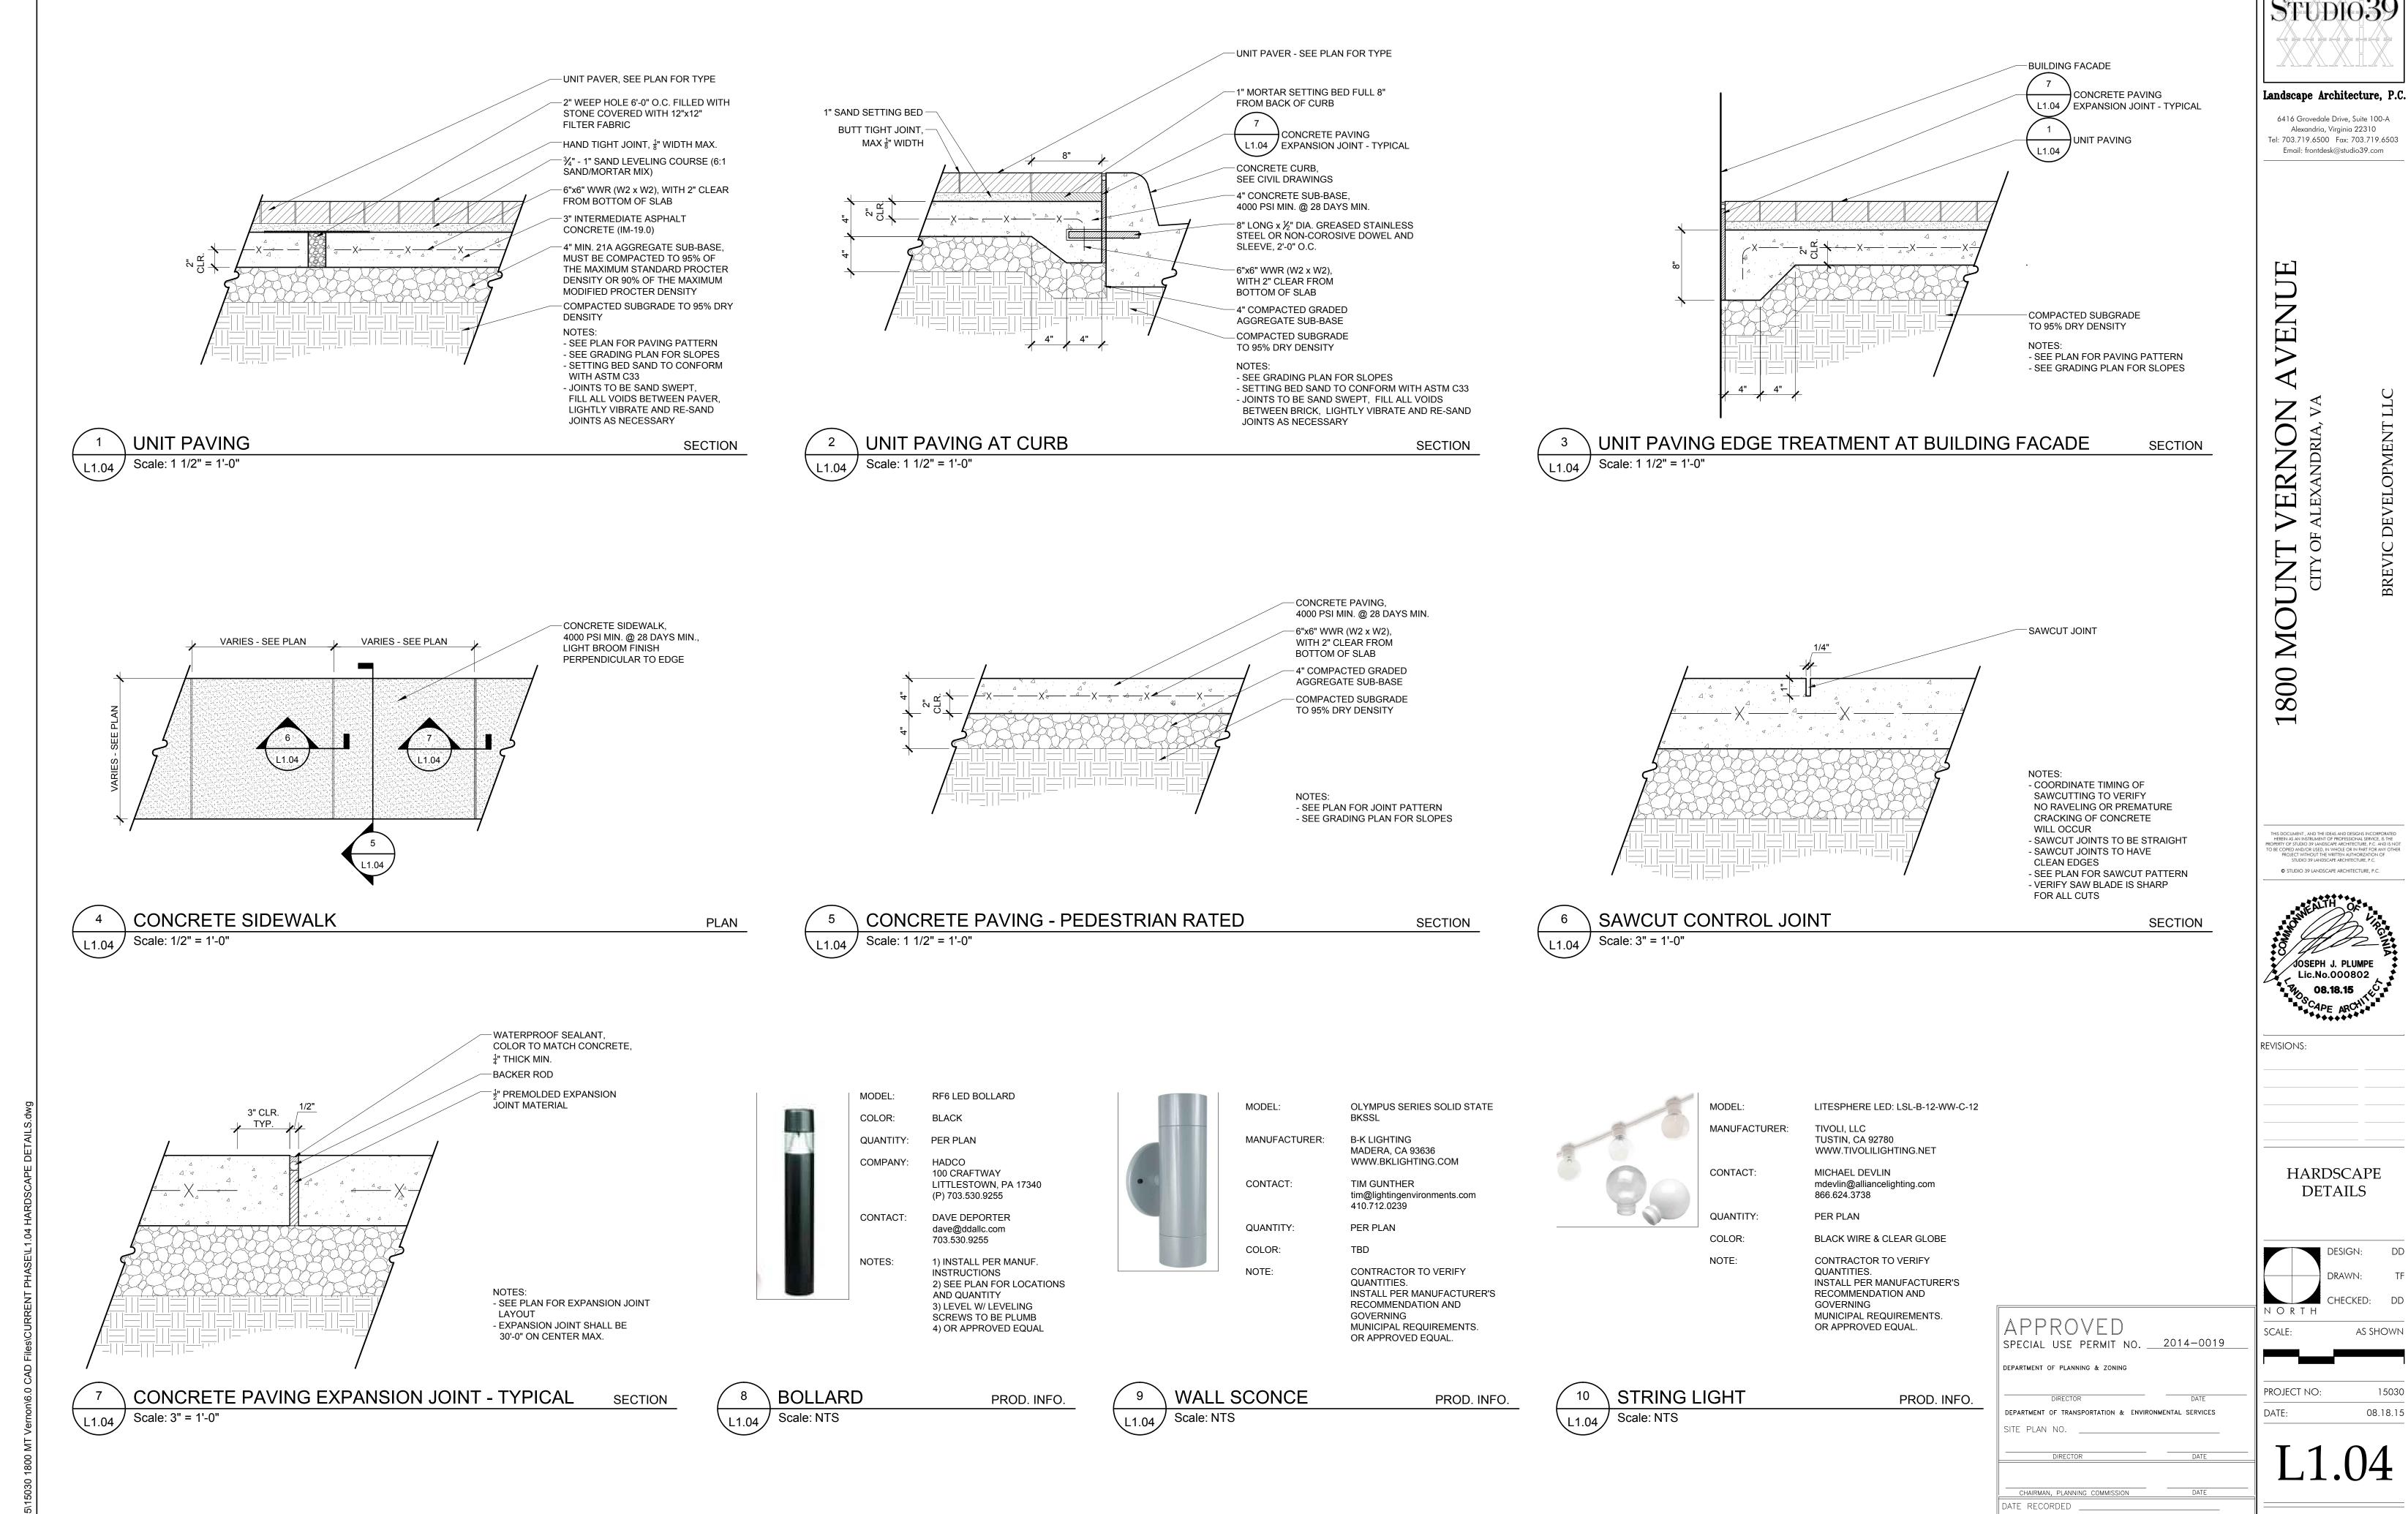

STUDIO39


6416 Grovedale Drive, Suite 100-A Alexandria, Virginia 22310

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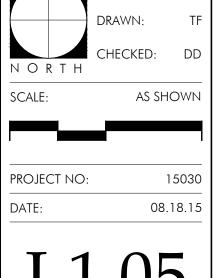
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INSTRUMENT NO.

DEED BOOK NO. DATE



STUDIO39

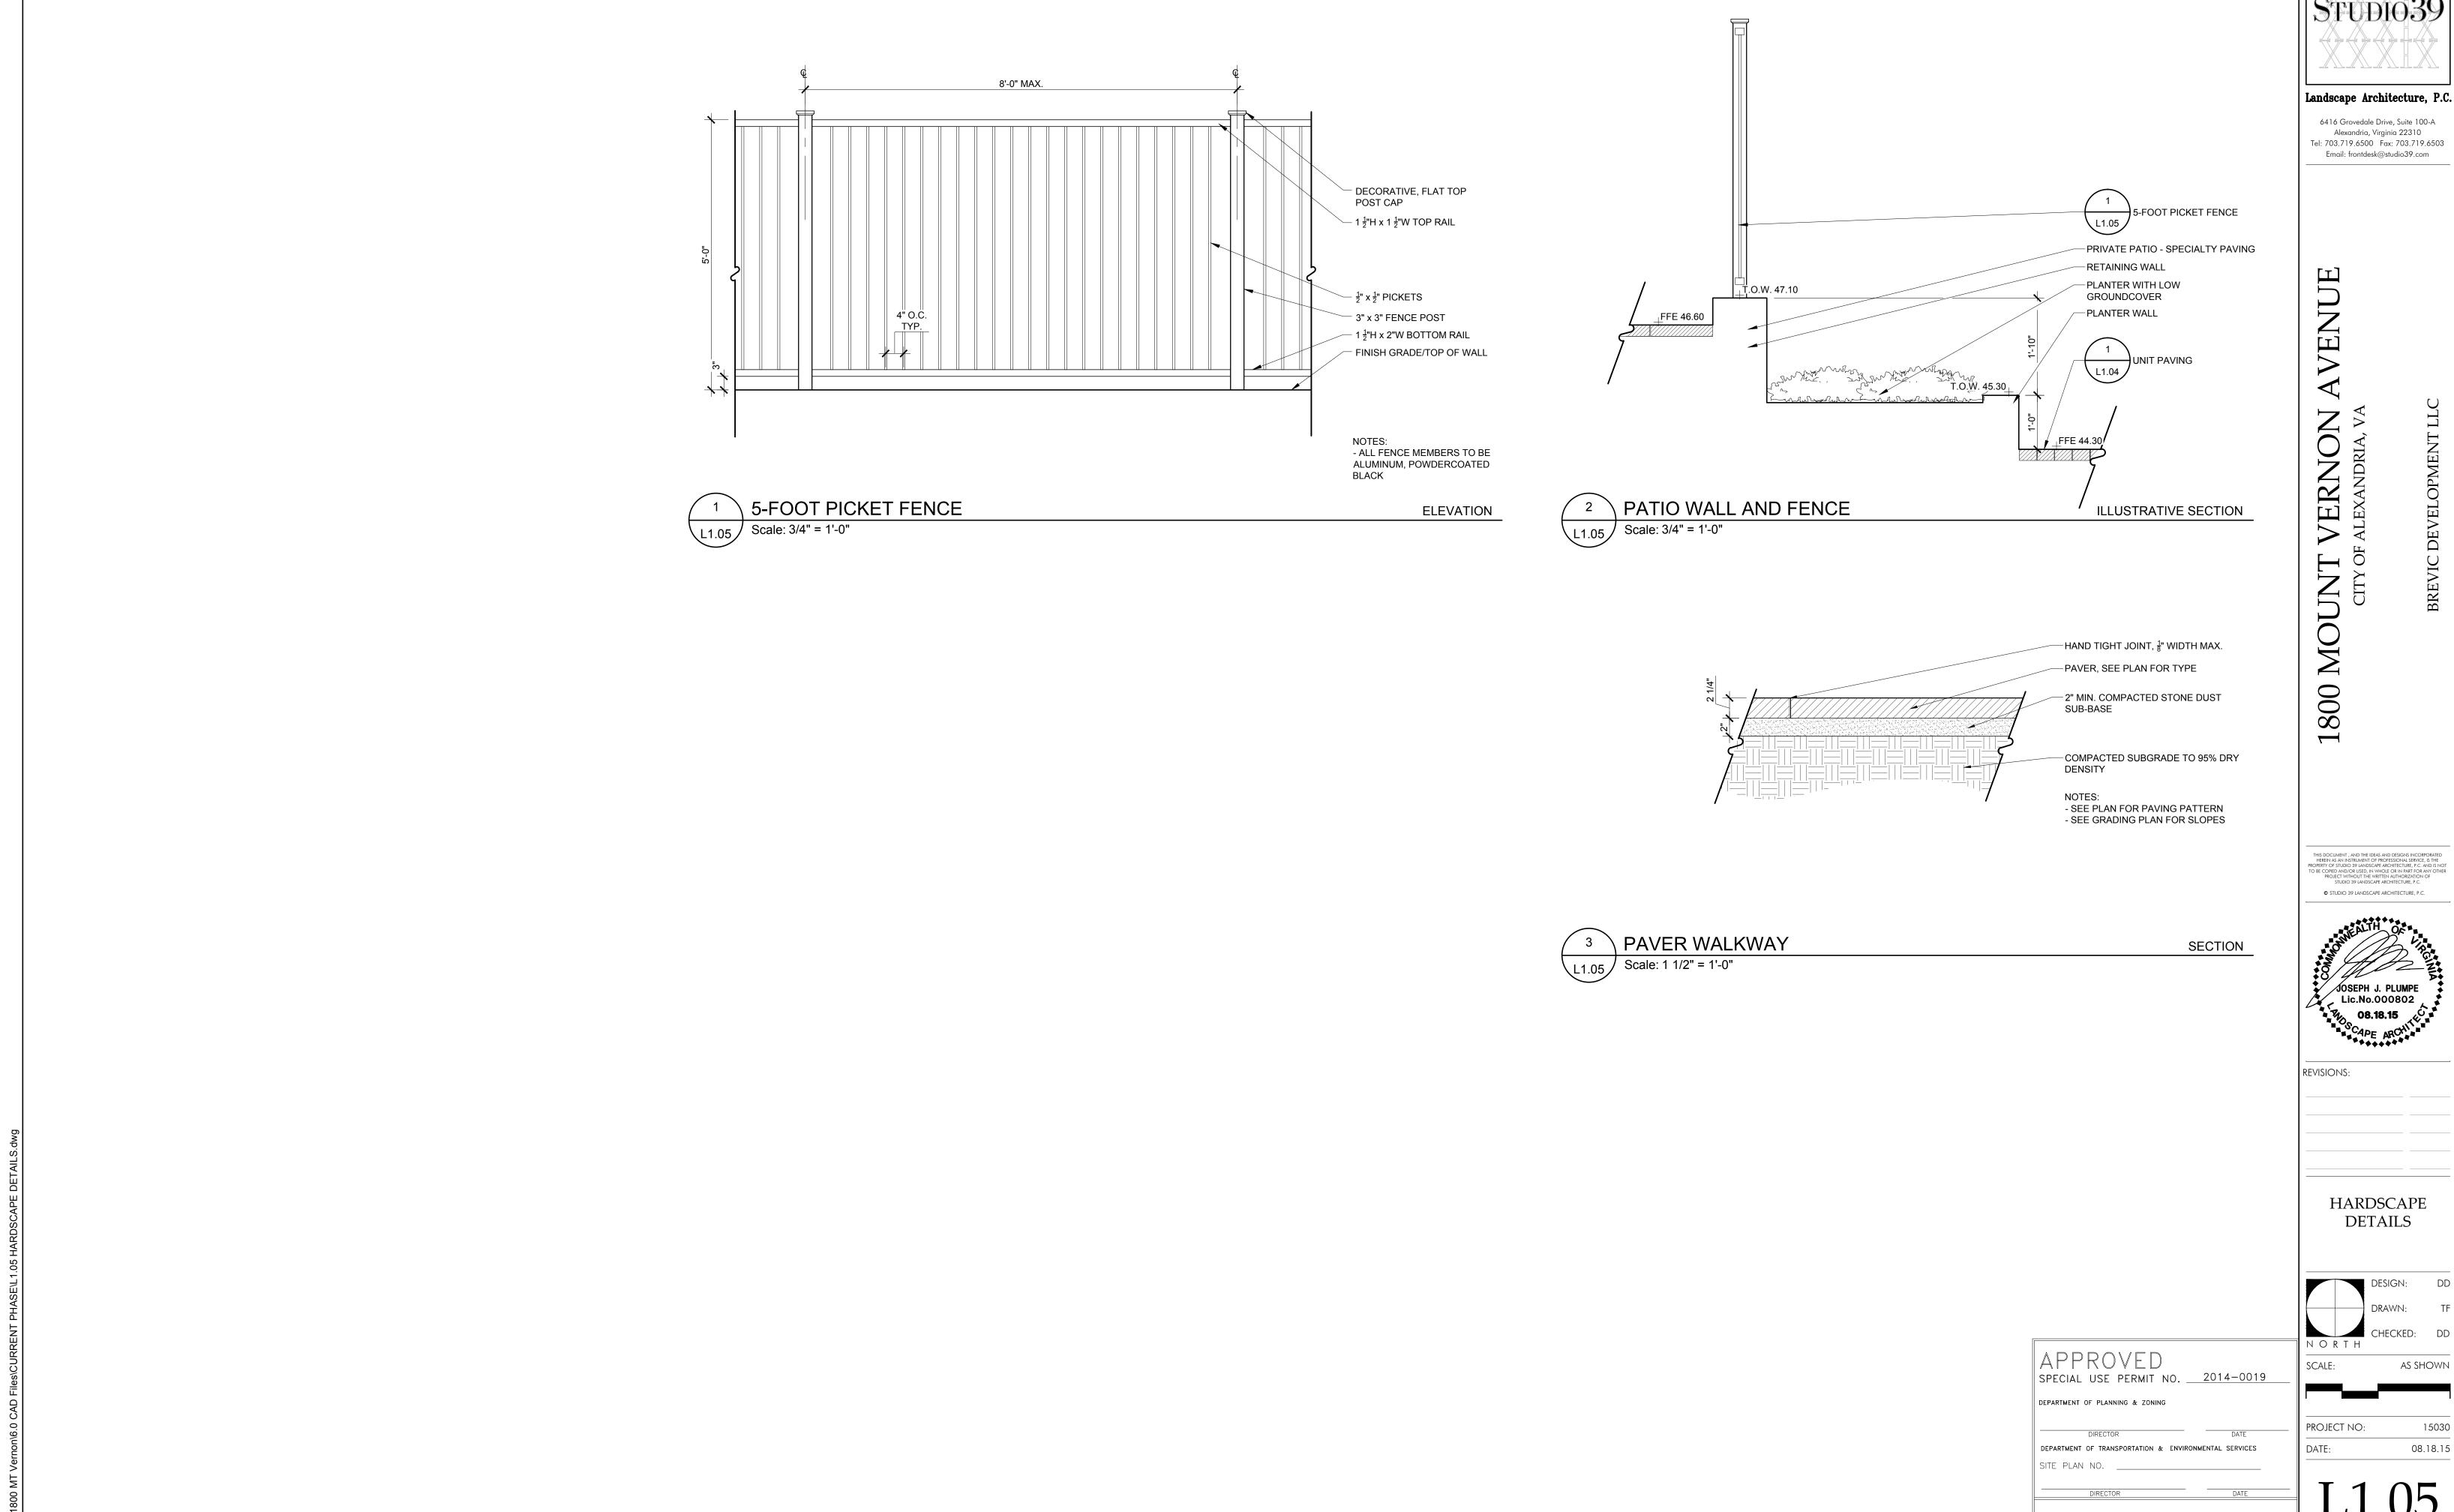

DSUP

CHAIRMAN, PLANNING COMMISSION DATE

INSTRUMENT NO. DEED BOOK NO. DATE





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# 1800 MT VERNON AVENUE

Alexandria, VA

ISSUE	DESCRIPTION	DAT
PROJECT N	JMBER	130

PROJECT NUMBER 13030
PRINT DATE 08.17.15

CONTEXT PLAN

SHEET NUMBER

SHEET TITLE

APPROVED


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DEPARTMENT OF PLANNING & ZONING

A100

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PROJE	CT NUMBER	130

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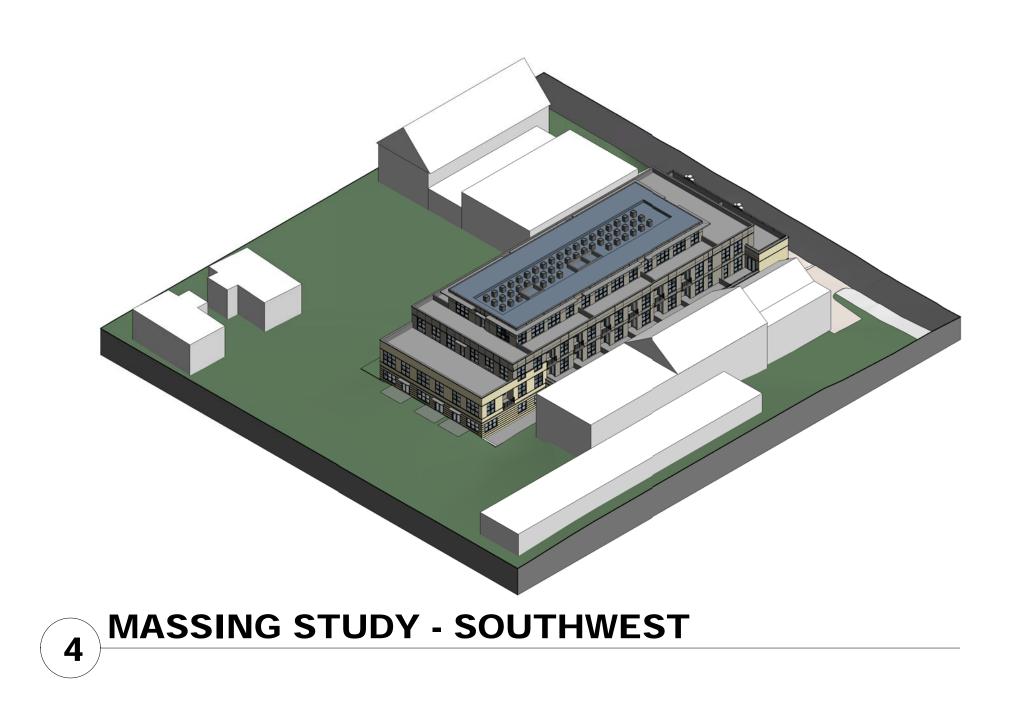
DEPARTMENT OF PLANNING & ZONING


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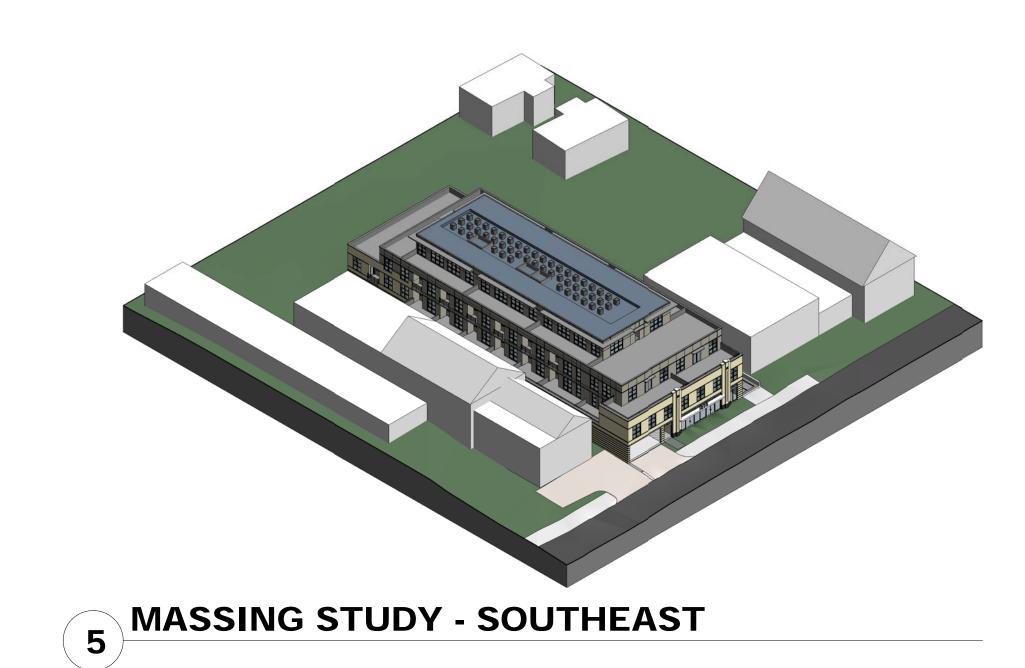
**ARCH SITE PLAN** 

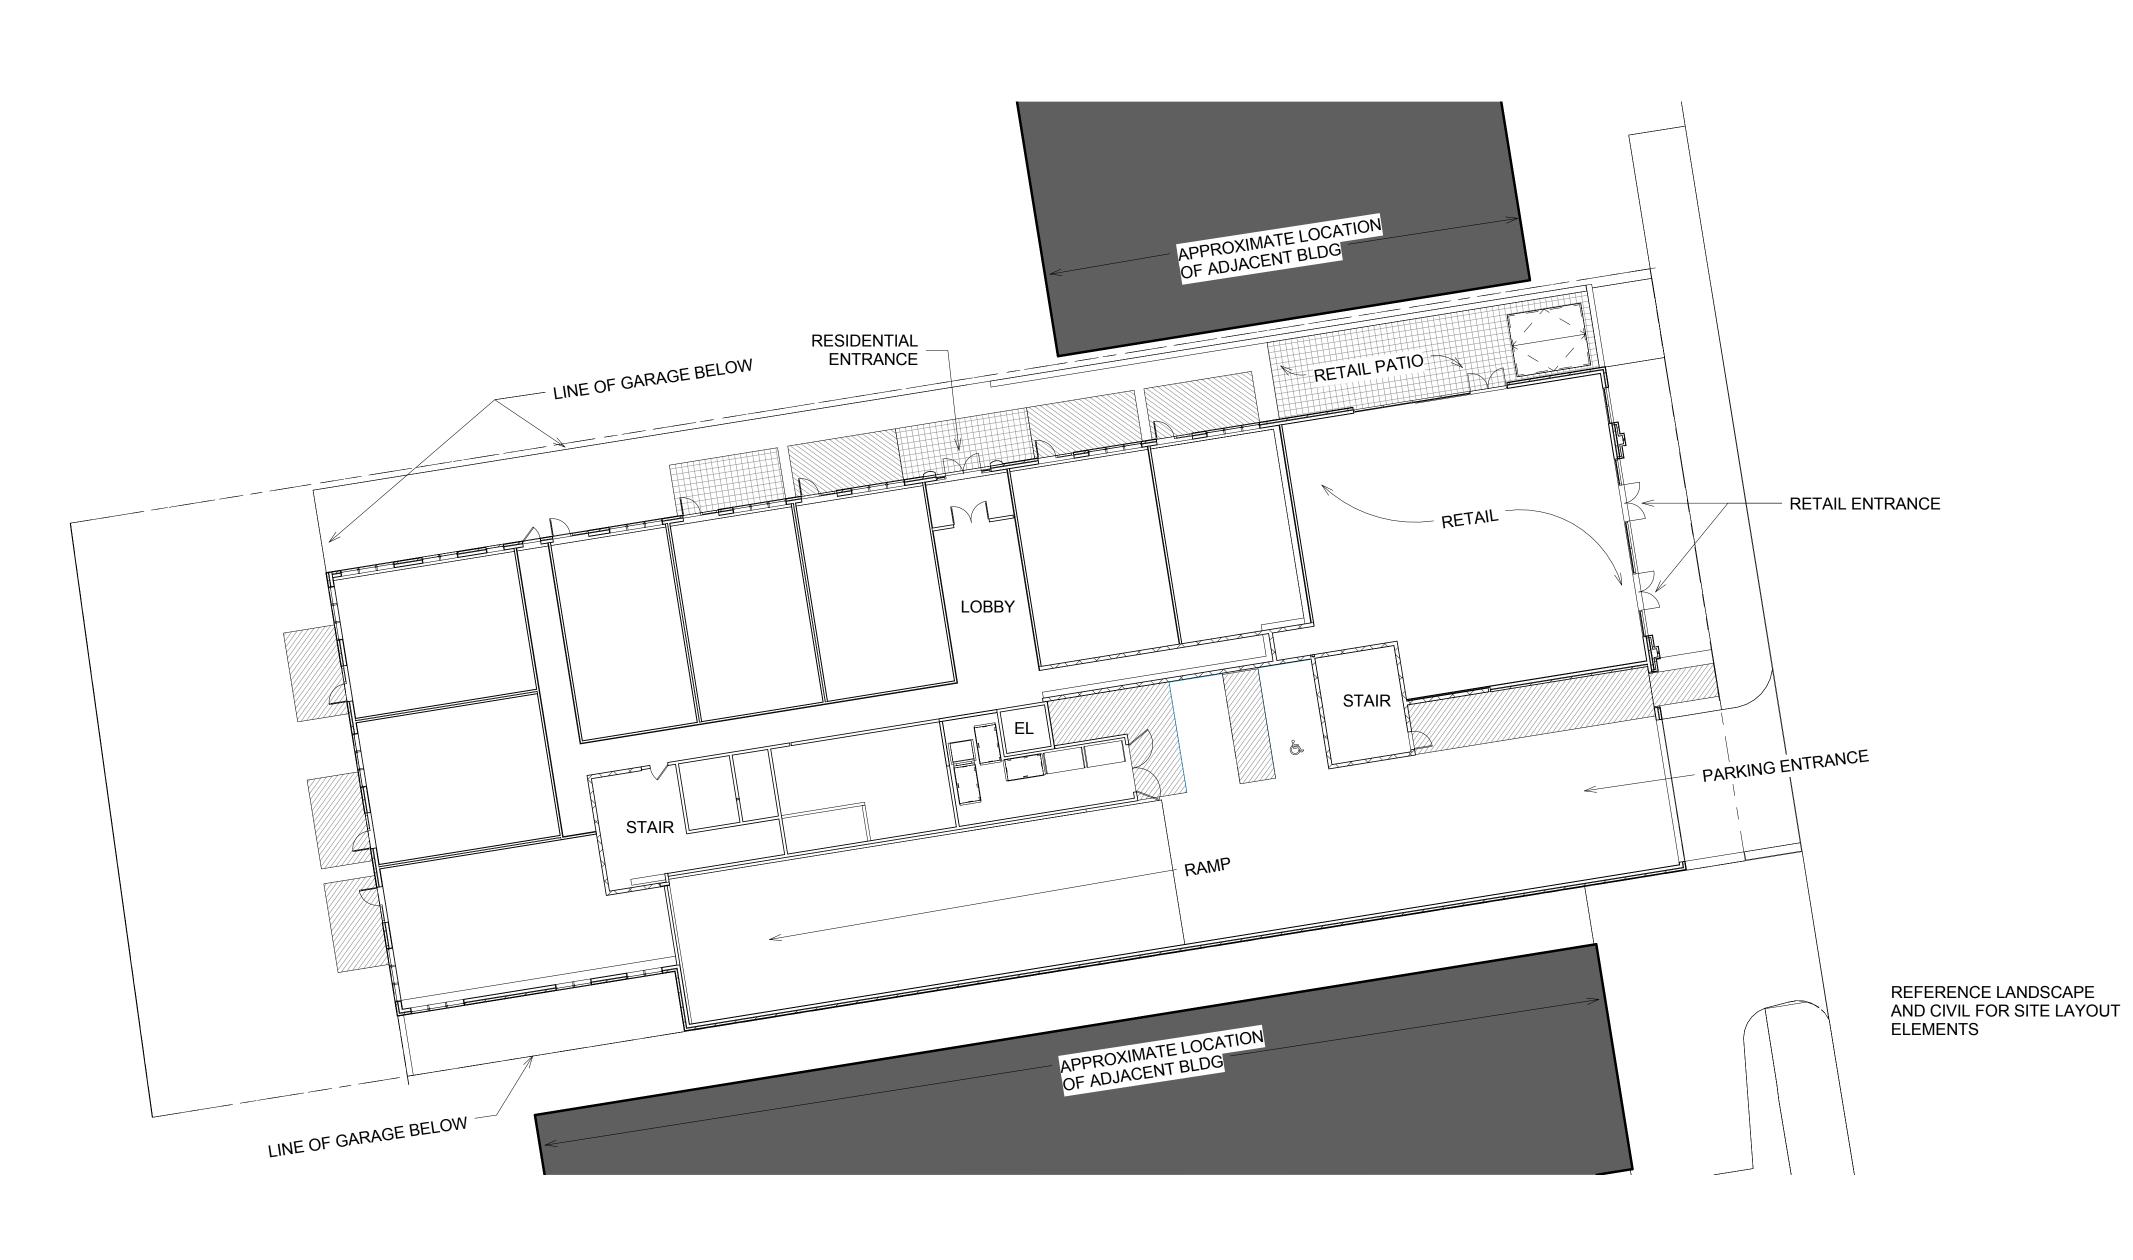
SHEET NUMBER


A101





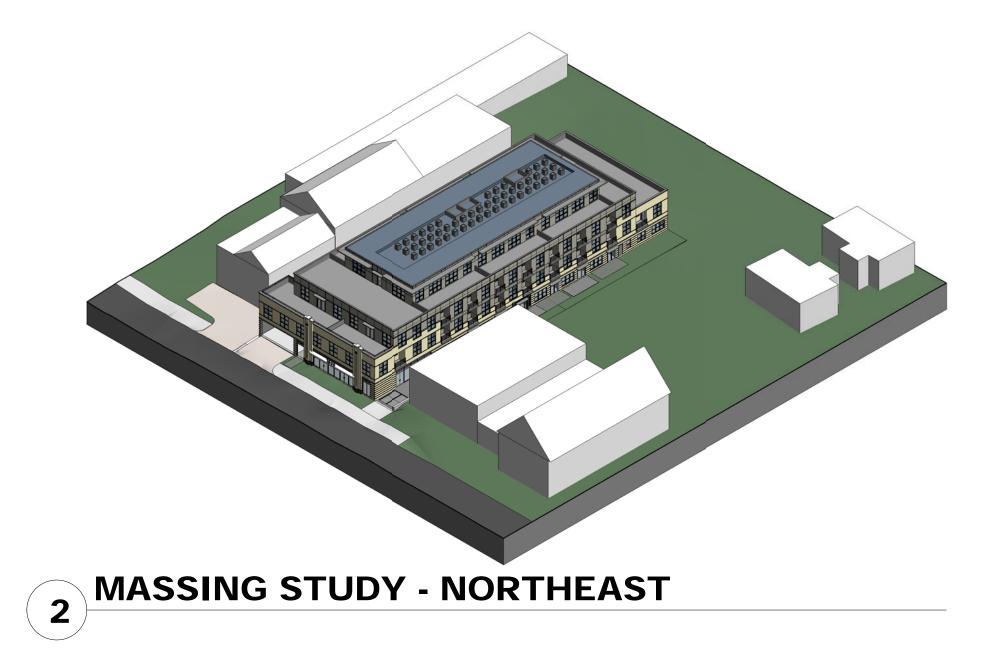

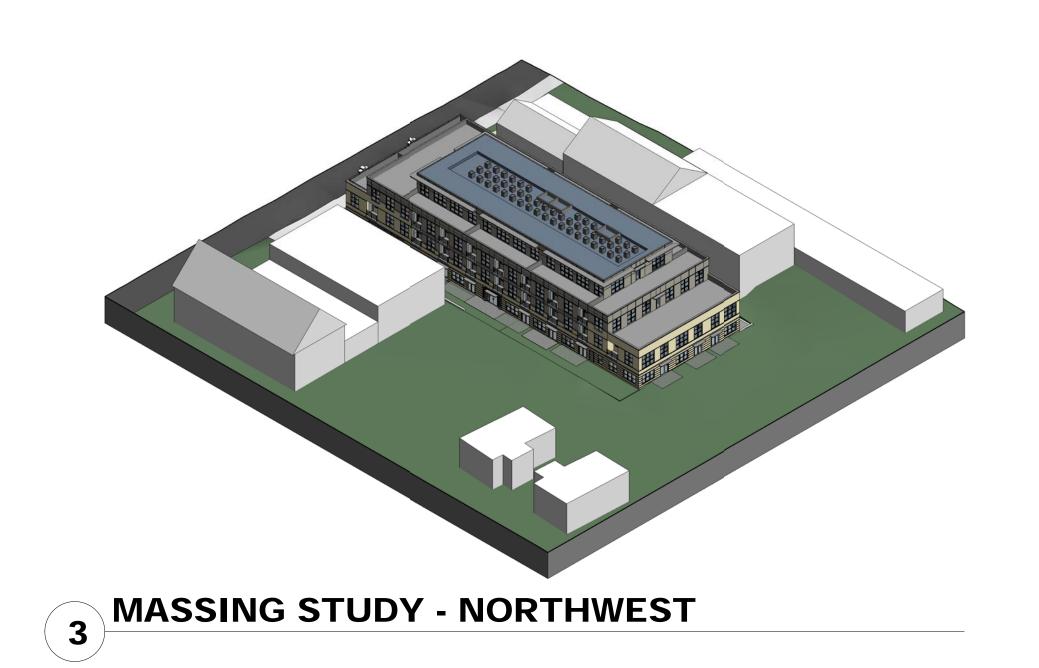

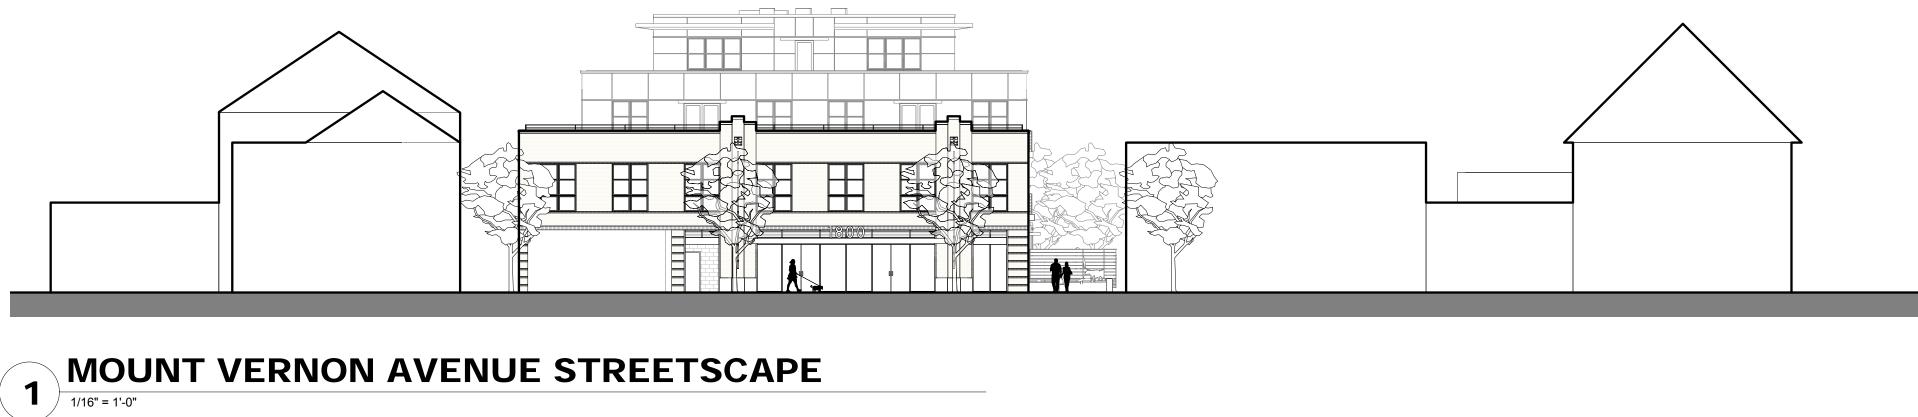

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DIRECTOR

DATE

DEPARTMENT OF TRANSPORTATION & ENVIRONMENTAL SERVICES

SITE PLAN NO.

DIRECTOR

DATE

CHAIRMAN, PLANNING COMMISSION

DATE



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Alexandria, VA

ISSUE	DESCRIPTION		DATE
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STREETSCAPE AND BUILDING MASSING

SHEET NUMBER

SHEET TITLE

A102





VIEW 3



NOTE:
1. REFERENCE LANDSCAPE AND CIVIL FOR ALL SITE LAYOUT ELEMENTS.
2. REFERENCE LANDSCAPE FOR FENCE DESIGN.



VIEW 1

VIEW 4



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0,050,700	DATE		
DIRECTOR	DATE		
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SITE PLAN NO.  DIRECTOR  CHAIRMAN, PLANNING COMMISSION	DATE		

ARCHITECTS PC

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PROJECT N		130

 PROJECT NUMBER
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SHEET TITLE

PERSPECTIVES AND BUILDING MASSING

SHEET NUMBER

A103


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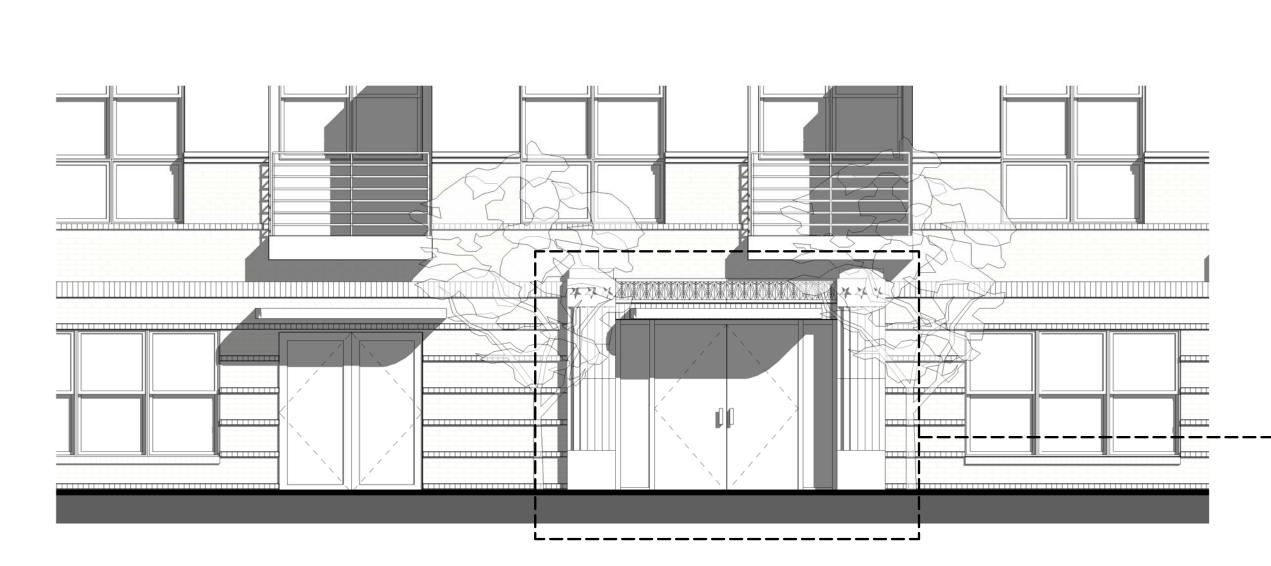
VIEW 5

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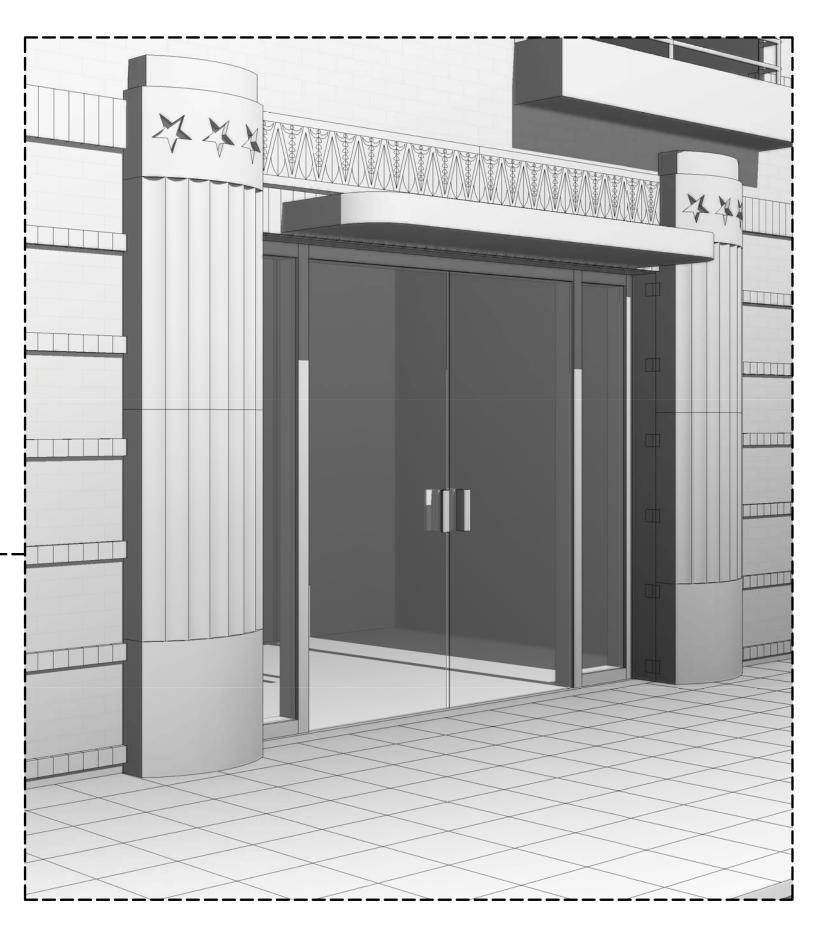
IMAGE FROM EXISTING BUILDING





RIGHT SIDE ELEVATION

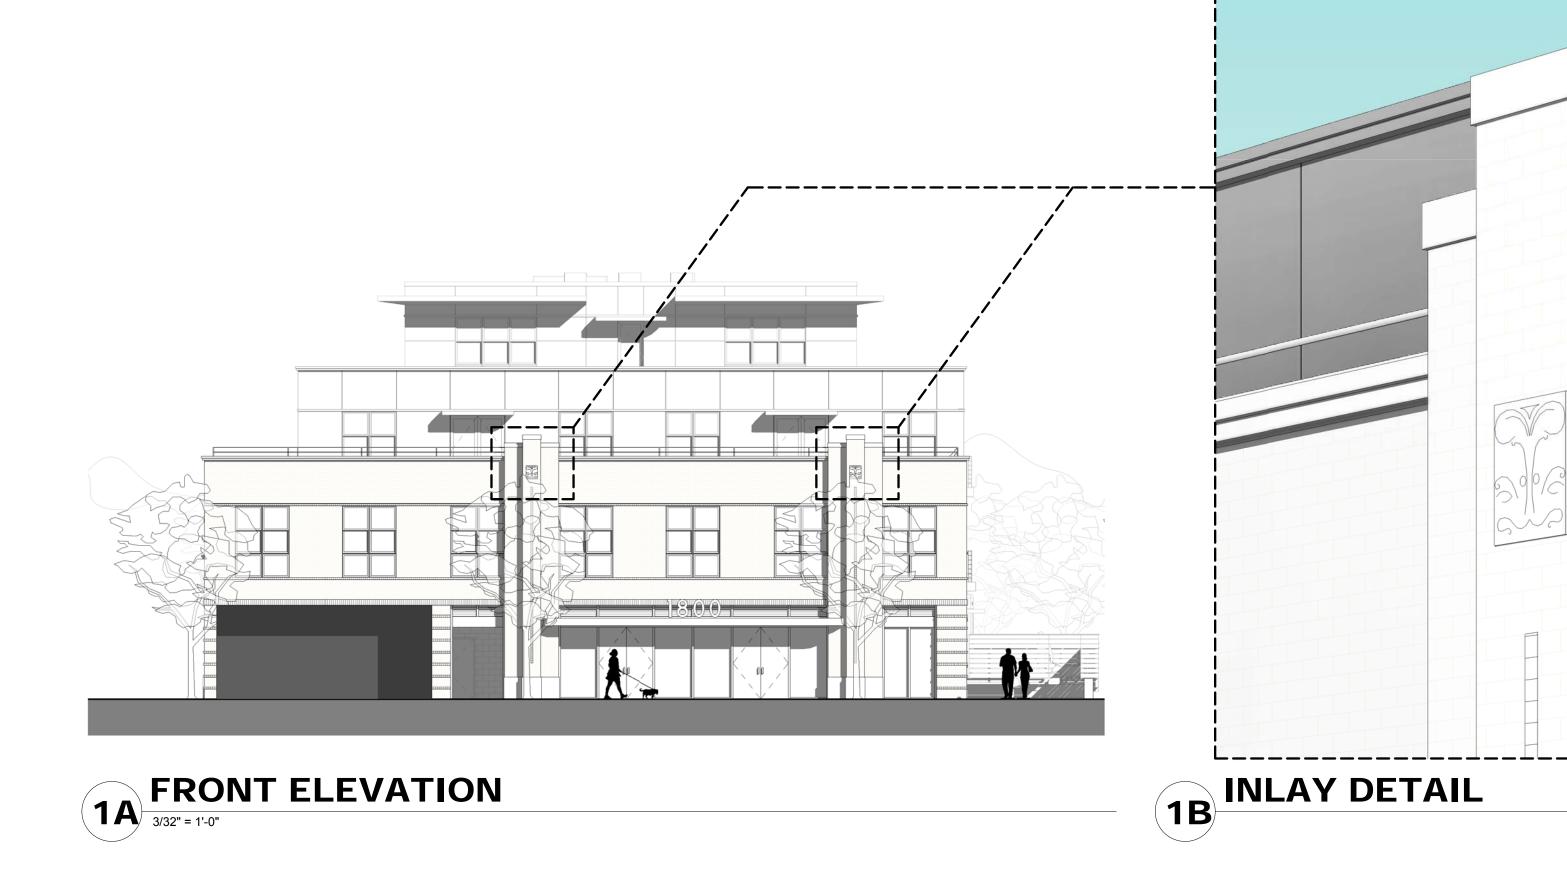1/4" = 1'-0"



2B RESIDENTIAL ENTRY DETAIL

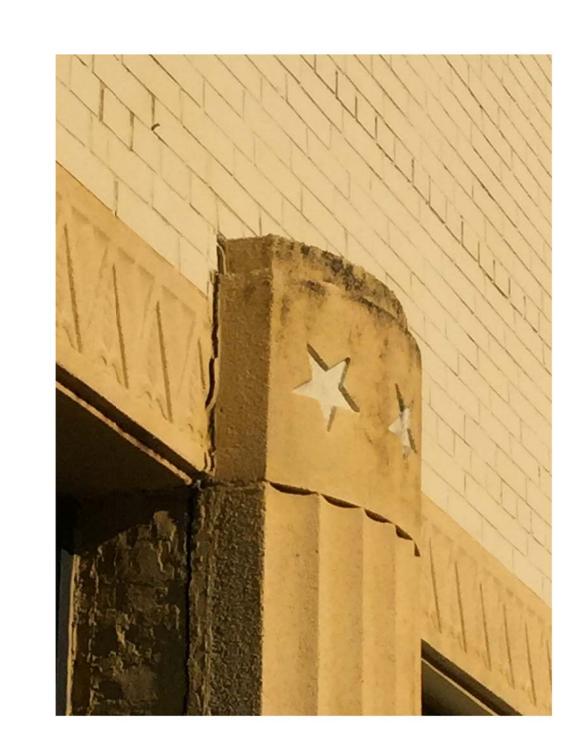


IMAGE FROM EXISTING BUILDING





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PERSPECTIVES AND HISTORIC DETAILS

SHEET NUMBER

A104



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# 1800 MT **VERNON AVENUE**

Alexandria, VA



PRINT DATE 08.17.15

SHEET TITLE **NET AREA PLANS** 

SHEET NUMBER


A105 **PLANNING** © 2015 HEFFNER ARCHITECTS PC


3 SECOND FLOOR

1/32" = 1'-0" 2 FIRST FLOOR
1/32" = 1'-0"



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SECOND FLOOR

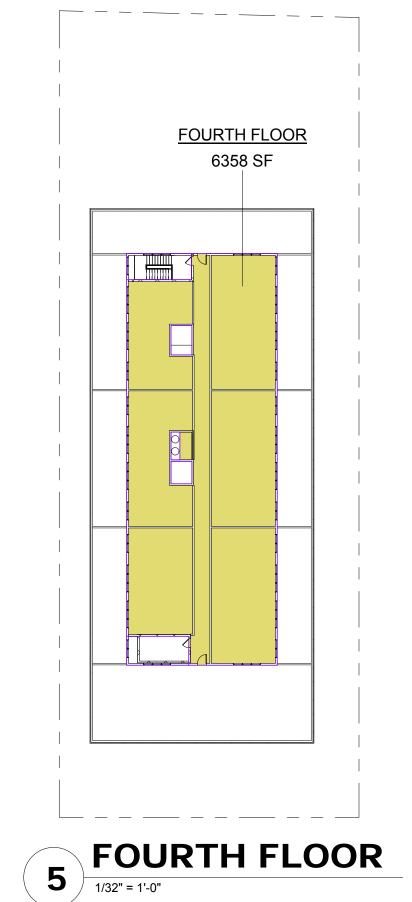15907 SF

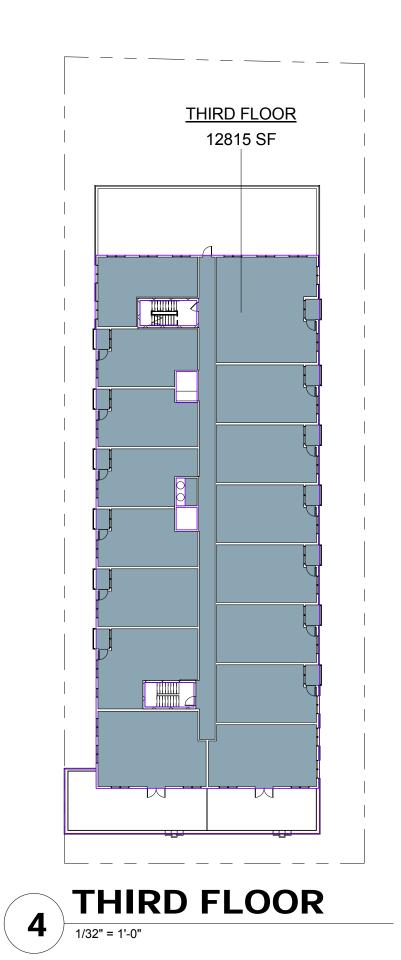GARAGE 1/32" = 1'-0" NOTE: SHADED AREAS ARE INCLUDED IN FAR CALCULATIONS





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ISSUE	DESCRIPTION	DATE
PROJECT N	JMBER	13030
PRINT DATE		08.17.15

SHEET TITLE

FLOOR PLANS

SHEET NUMBER

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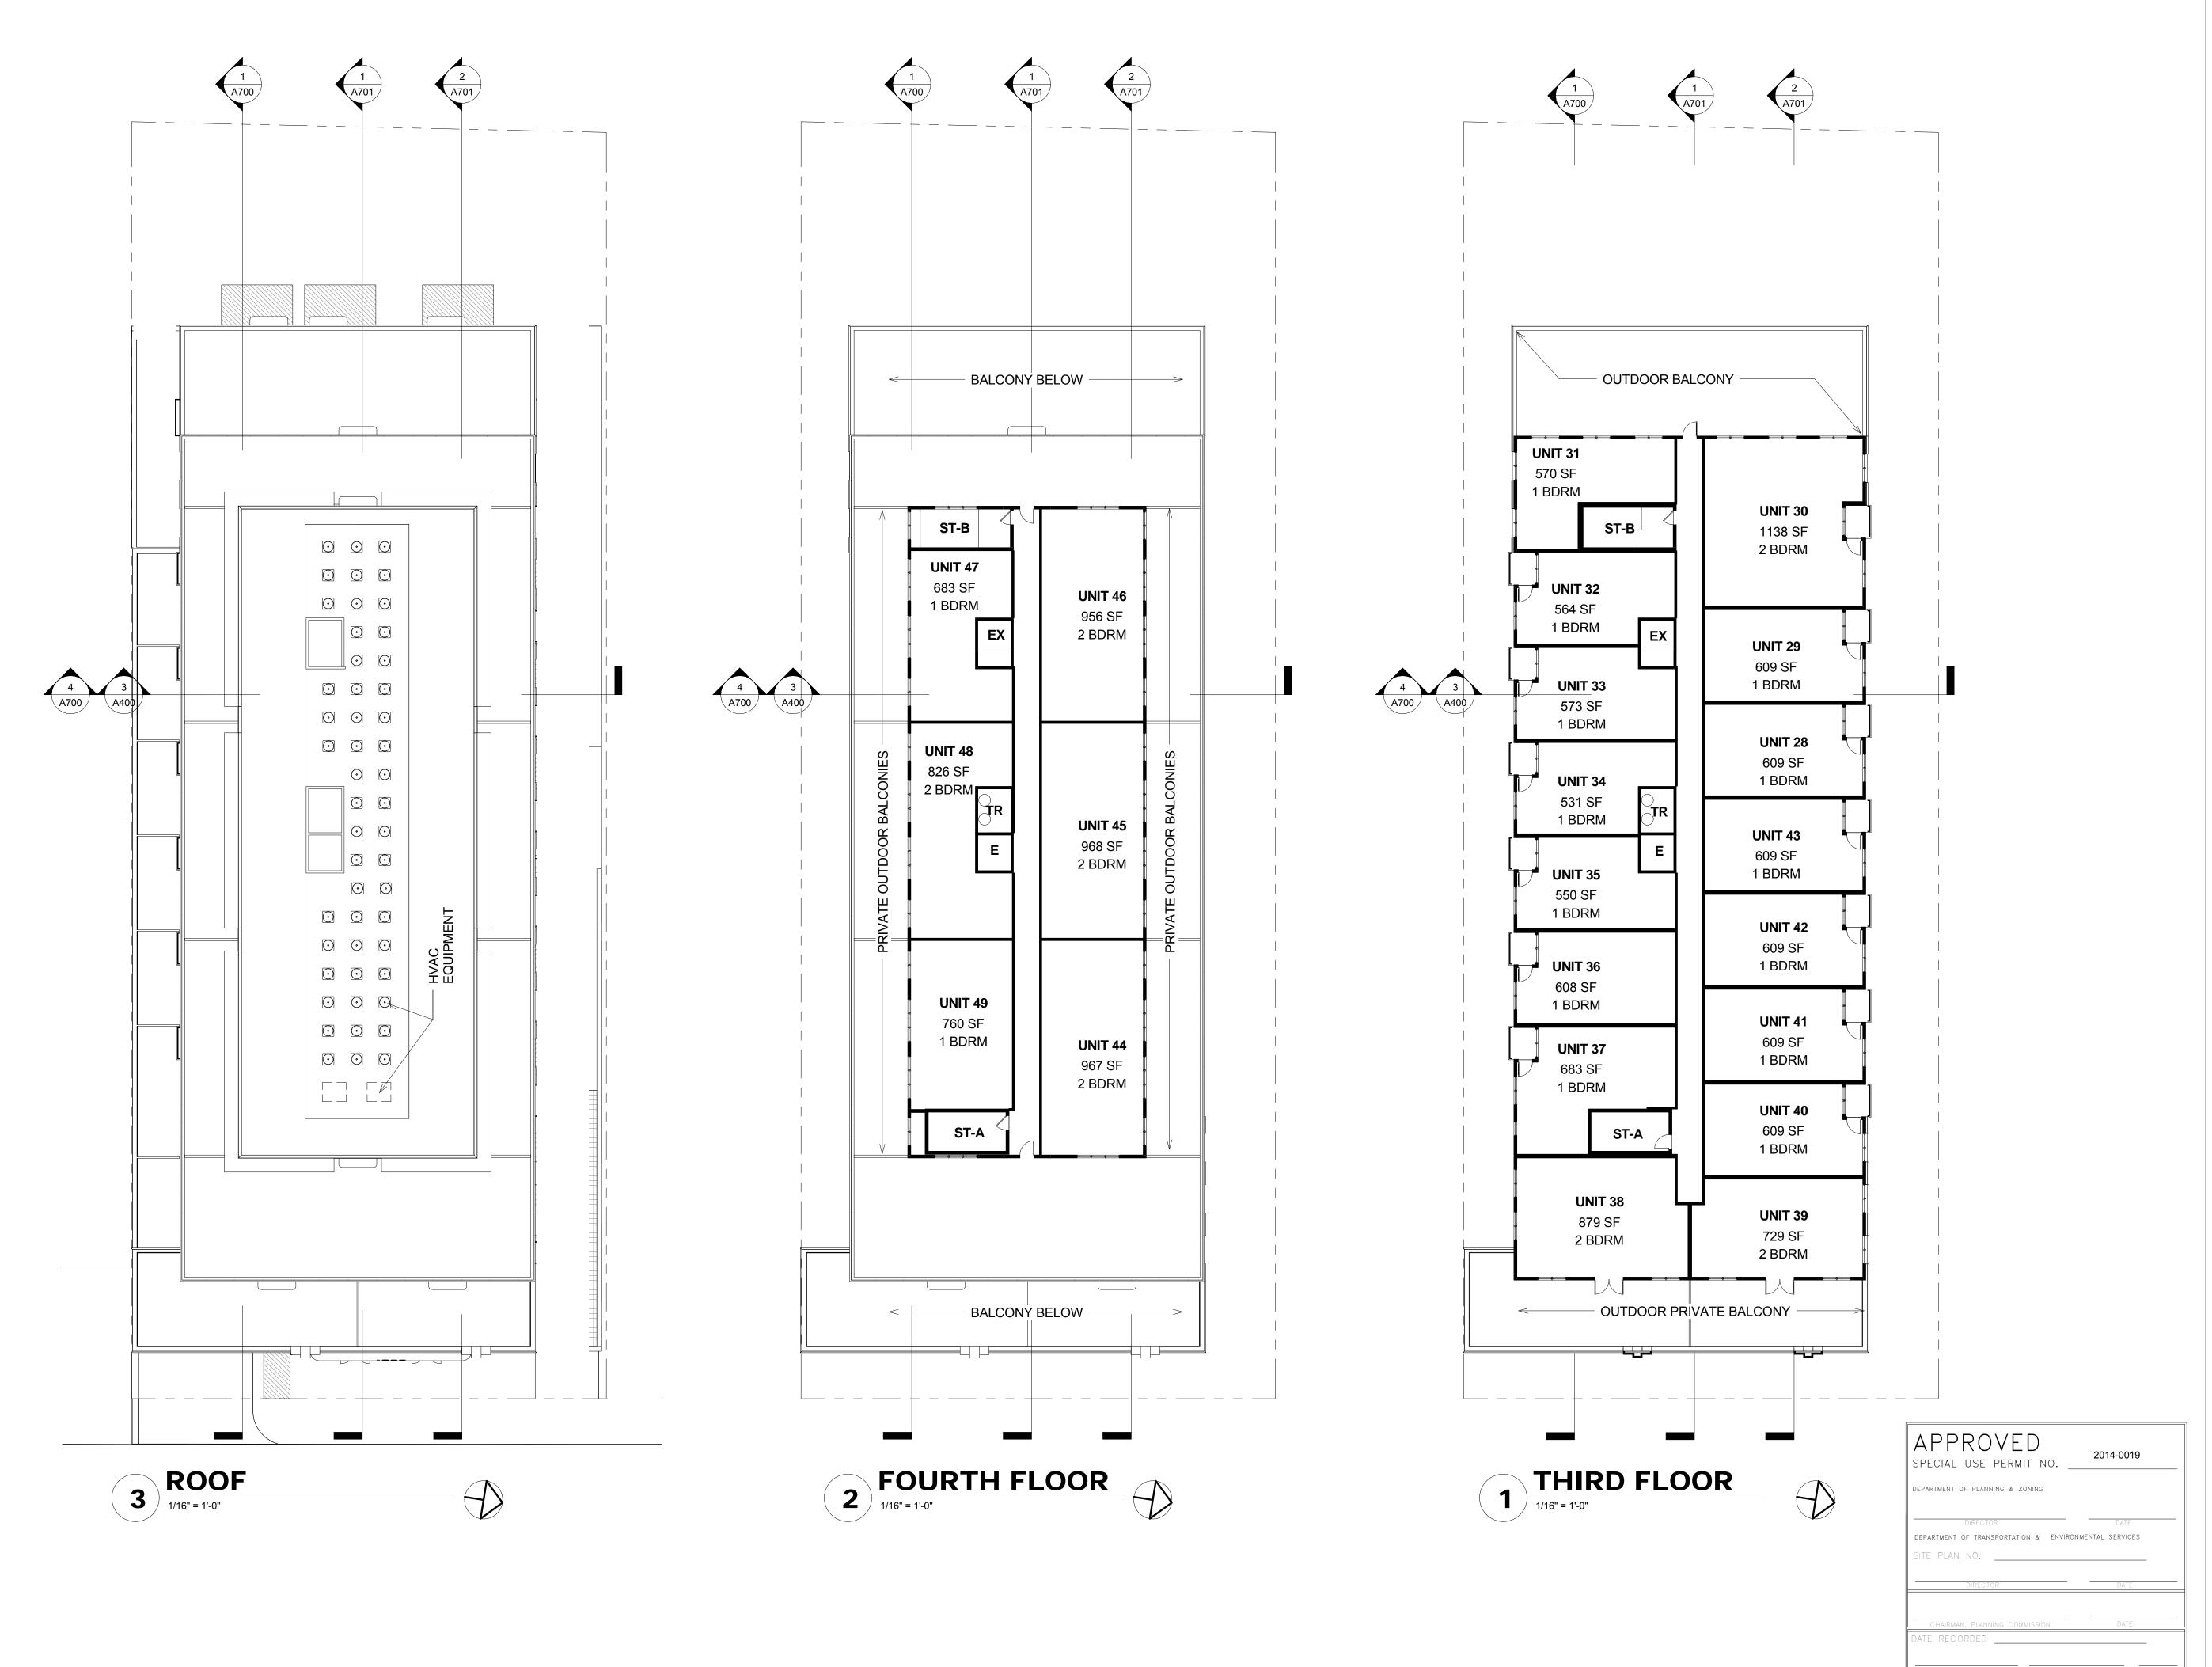
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**A200** 

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Alexandria, VA

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**FLOOR PLANS** 

SHEET NUMBER

SHEET TITLE

**A201** 





Alexandria, VA

**AVENUE** 

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PROJECT NU	JMBER	1303
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SHEET TITLE **BUILDING** 

**ELEVATIONS** 

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SHEET NUMBER **A400** 

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3 1/8" = 1'-0"

**BUILDING SECTION** 



1. REFERENCE LANDSCAPE AND CIVIL FOR ALL SITE LAYOUT ELEMENTS. 2. REFERENCE LANDSCAPE FOR FENCE DESIGN.



1 REAR ELEVATION (WEST)
1/8" = 1'-0"





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PRINT	DATE	0	B.17.15

SHEET TITLE **BUILDING ELEVATIONS** 


SHEET NUMBER

**A401** 

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2 LEFT ELEVATION (SOUTH)

1/8" = 1'-0"



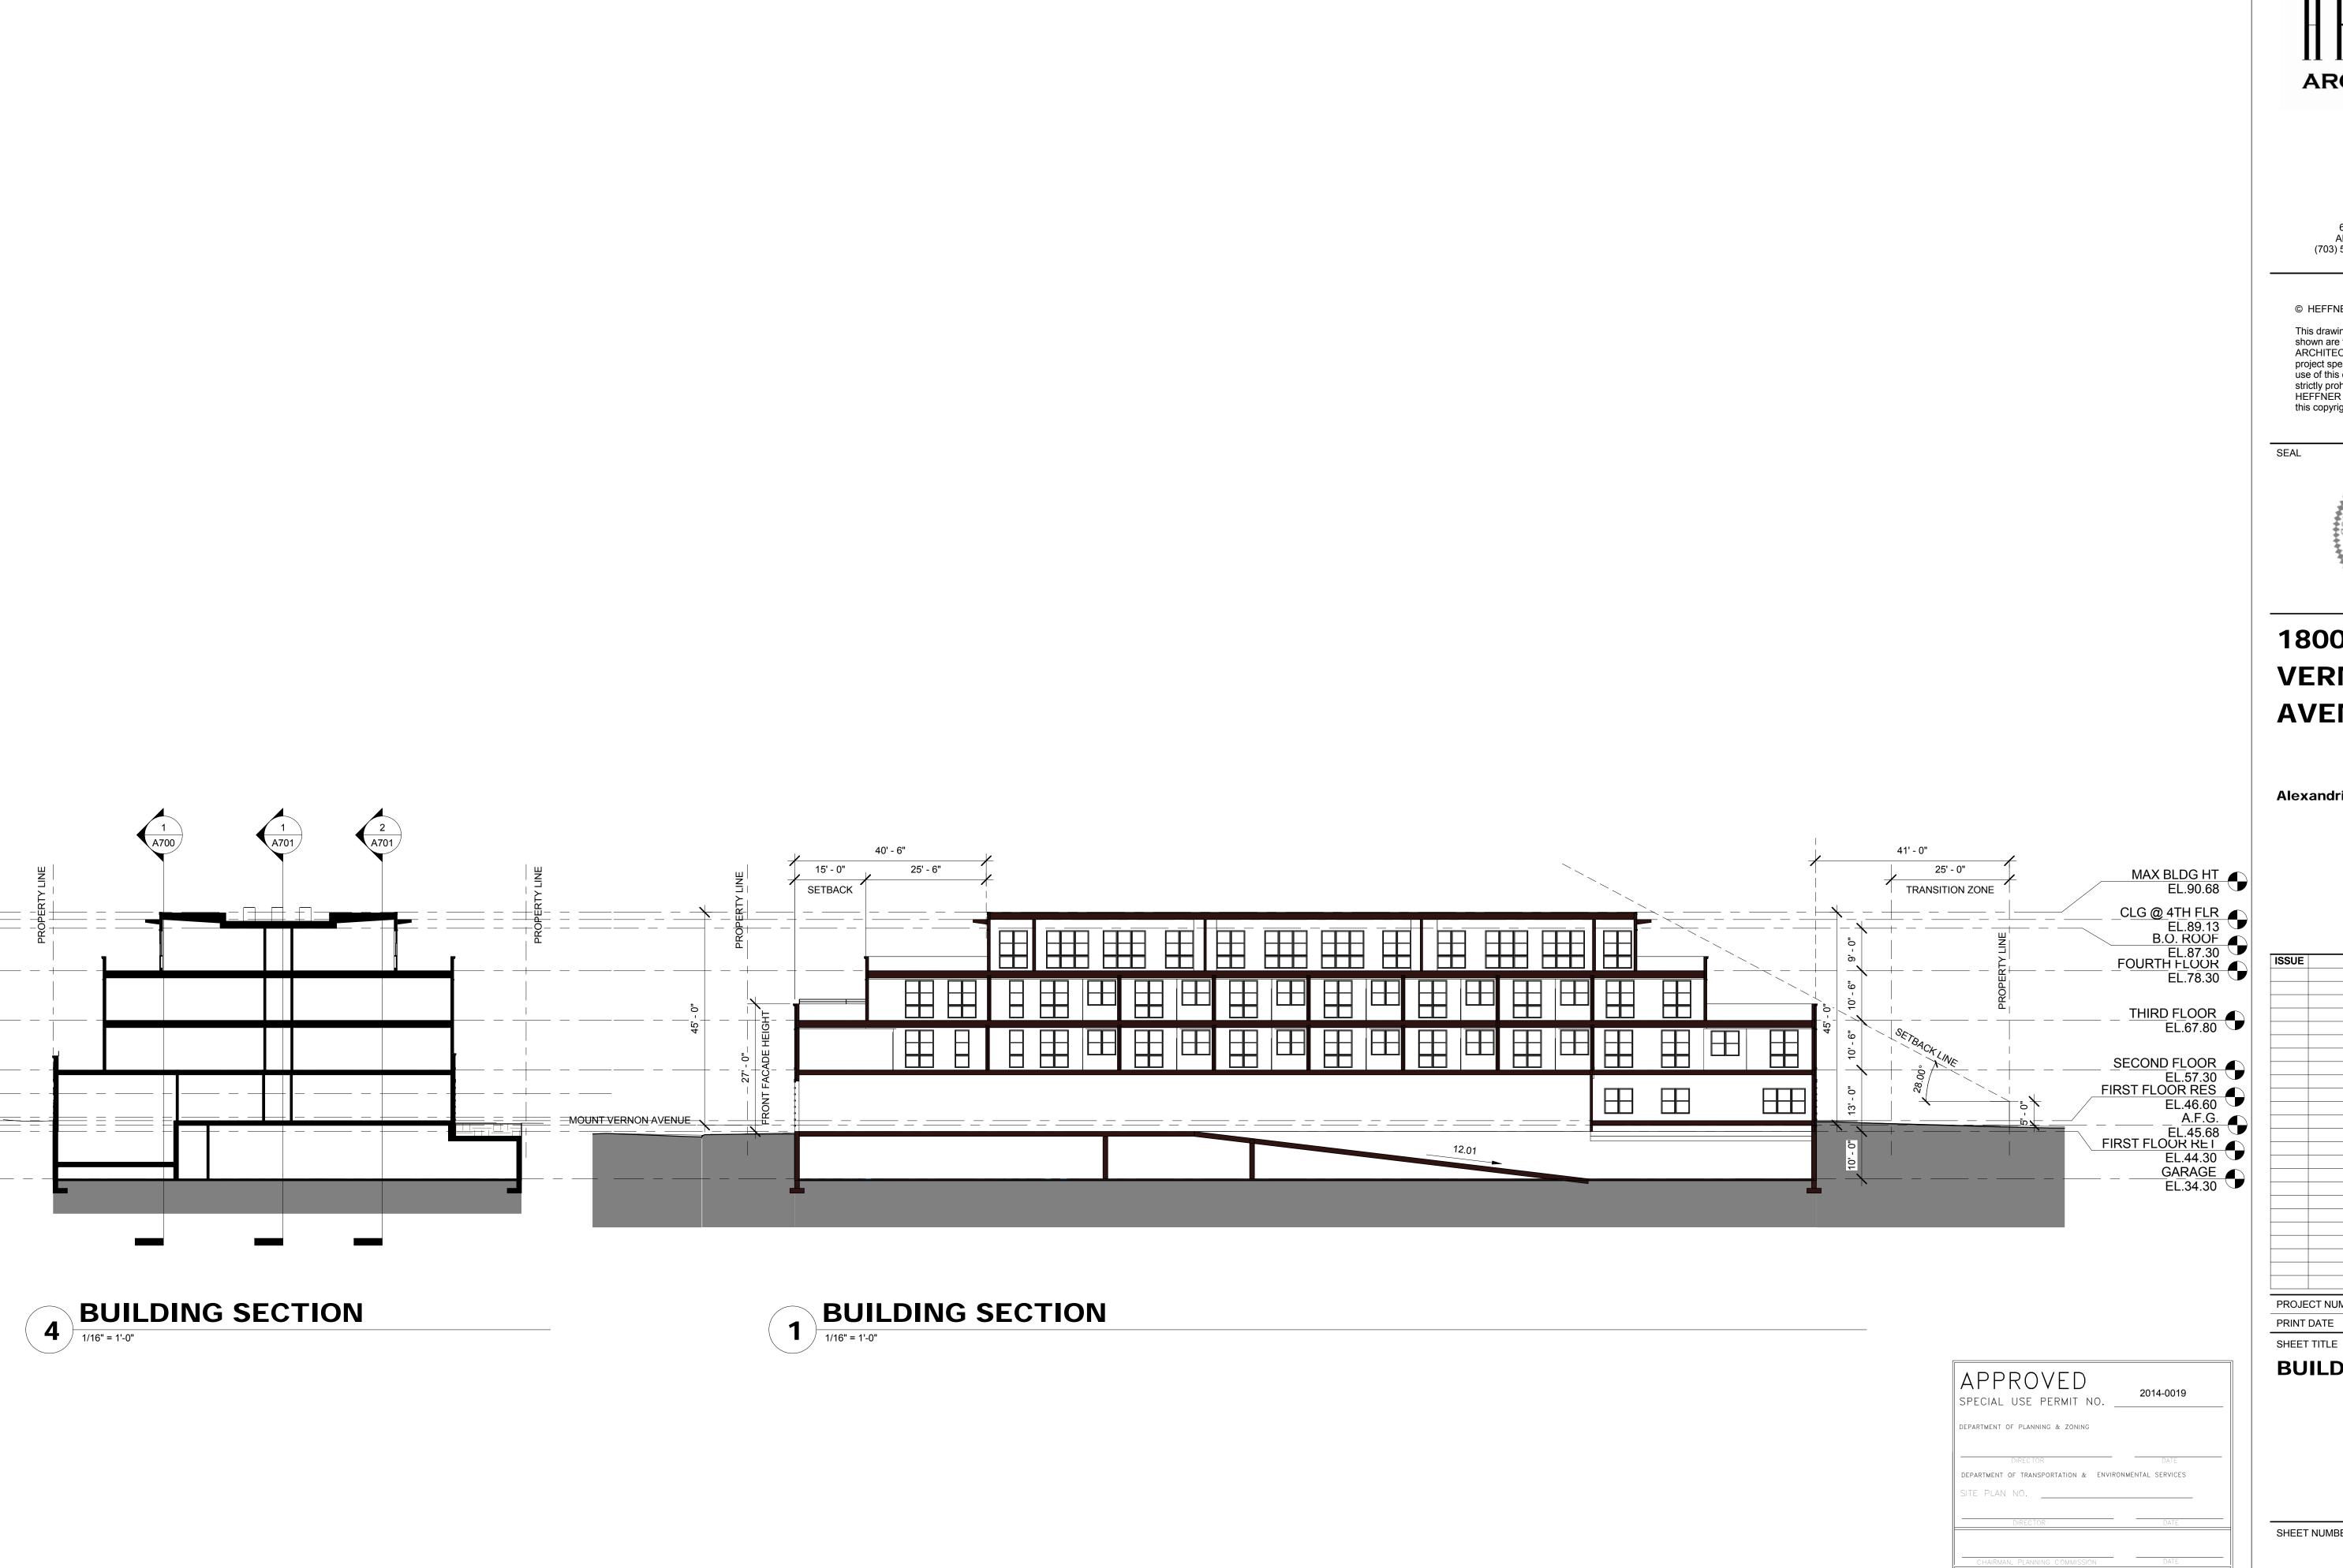

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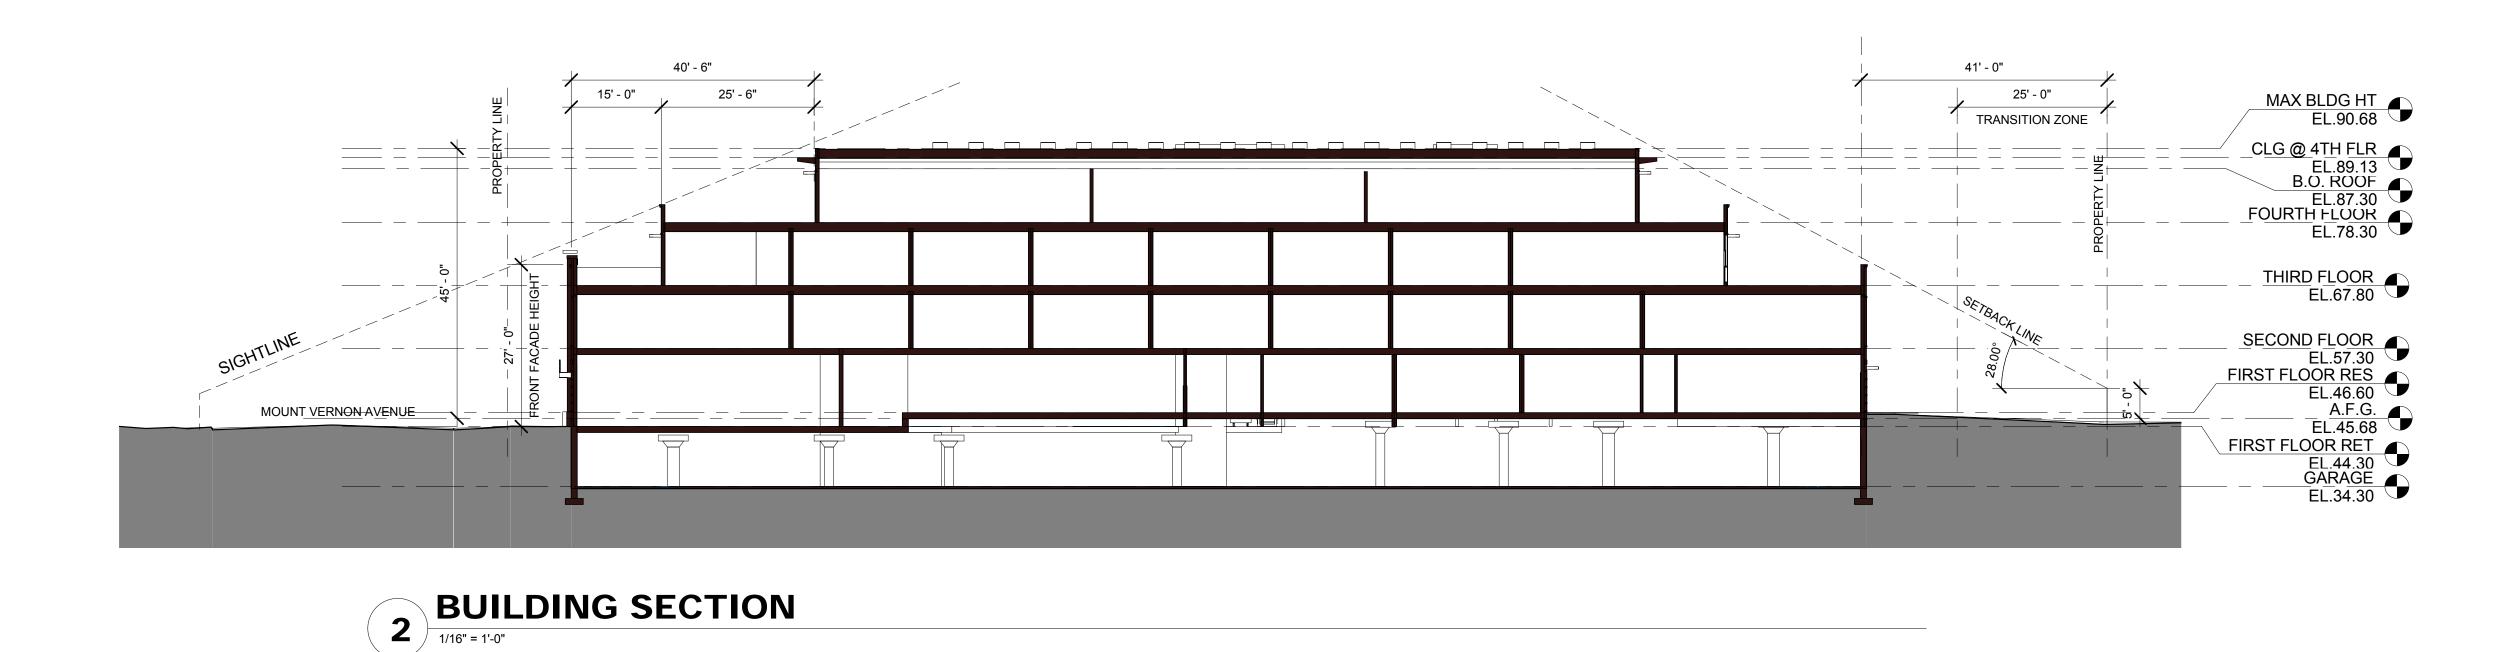
Alexandria, VA


ISSUE	DESCRIPTION	DATE
PROJECT N	UMBER	13030
PRINT DATE		08.17.15

**BUILDING SECTIONS** 

SHEET NUMBER

A700



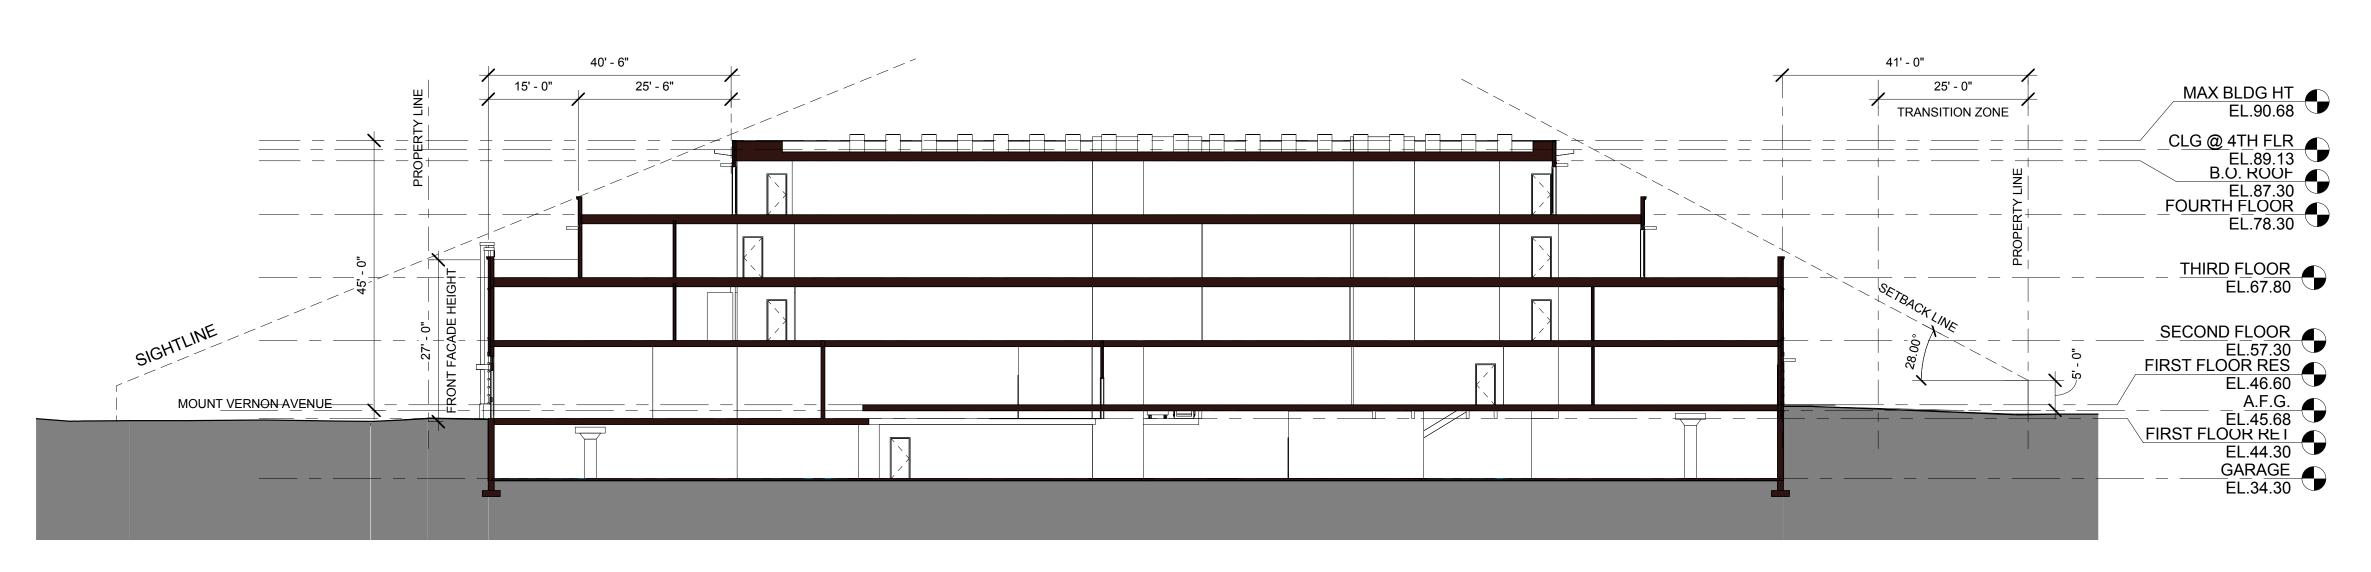

BUILDING SECTION

1/16" = 1'-0"





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		08.17.15
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**BUILDING SECTIONS** 

SHEET NUMBER

SHEET TITLE

A701