OWNER/APPLICANT

WOODBINE PROPERTY 1 LLC 1608 ROUTE 88, SUITE 301 BRICK, NJ 08724 **CONTACT: PETER MODRI** EMAIL: pmodri@thcgco.com

WALSH, COLUCCI, LUBELEY & WALSH 2200 CLARENDON BOULEVARD **SUITE 1300** ARLINGTON, VA 22201 CONTACT: M. CATHARINE PUSKAR EMAIL: cpuskar@thelandlawyers.com

ARCHITECT

ATTORNEY

FREDERICK WARD ASSOCIATES 5 SOUTH MAIN STREET BEL AIR, MD 21014 CONTACT: WILLIAM STARR EMAIL: bstarr@fredward.com

CIVIL ENGINEER

URBAN, LTD. 7712 LITTLE RIVER TURNPIKE ANNANDALE, VA 22003 CONTACT: DAVID T. McELHANEY EMAIL: dmcelhaney@urban-ltd.com

DSUP 2022-10014

CONSULTING ARCHITECT

BROMMER ARCHITECTS, LLC 723 ELECTRONIC DRIVE, SUITE 300 HORSHAM, PA 19044 CONTACT: RYAN McDERMOTT EMAIL: rmcdermott@brommerarchitects.com

ZONING TABULATIONS

2729 KING STREET, ALEXANDRIA, VA 22302 TAX MAP 052 02-06-05

			TAX MAP
1) ZONINGEXISTING ZON	ing: R-8 pr	oposed zoning: RE	3
2) EXISTING USE		JRSING HOME	
3) PROPOSED USE		JRSING HOME	
4) TOTAL SITE AREA	16	57,165 SF	
5) EXISTING IMPERVIOUS	AREA10	2,608 SF	
6) PROPOSED IMPERVIOUS	AREA11	0,103 SF (INCLUD	ES EXISTING)
7) TOTAL DISTURBED ARE		5,400 SF	
4) REQUIRED LOT AREA _	<u>·</u>	/A	
5) PROVIDED LOT AREA _	<u> </u>	/A	
6) AVERAGE LOT AREA _	•	/A	
7) MIN. LOT AREA		/A	
8) MIN. LOT WIDTH			
9) MAXIMUM DENSITY			
10) DENSITY	N,	/A	
11) GROSS & NET FLOOR	AREA		
DESCRIPTION	GROSS FLOOR AREA (sf)	NET FLOOR AREA (sf)	COMMENTS
EX. BUILDING	101,110	85,039	PER FAR EXHIBIT(7/21
PORTION OF EX. BUILDING TO BE DEMOLISHED	6,068	6,068	
SUBTOTAL (EX. BUILDING TO REMAIN)	95,042	78,971	
PROP. BUILDING ADDITION	31,909	26,817	
TOTAL	126,951	105,788	
(EX. BUILDING TO REMAIN	,	,	
PLUS BUILDING ADDITION)			
40) 140/1411 DEDUITED E	4.5	75	
12) MAXIMUM PERMITTED F	AR	7.5	
13) FAR CALCULATIONS			
DESCRIPTION	FLOOR AREA RATIO	_	
EX. BUILDING TO REMAIN	0.472	_	
PROP. BUILDING ADDITION	0.161	_	
OVERALL (EX. BUILDING TO REMAIN	0.633		

*	SEE	"DSUP	AND	MODIFICATIONS	REQUESTED".

PLUS BUILDING ADDITION)

14) EXISTING STORAGE TO REMAIN _____456 SF

5) TOTAL NUMBER OF BEDS	307 (NO CHANGE FROM EXISTING)
	EX. BLDG. TO REMAIN	PROP. BLDG. ADDITION
6) MAX. PERMITTED BLDG. HEIGHT	45 FT.	35 FT.
7) PROP. BLDG. HEIGHT	40 FT.	* 42 FT.
8) AVG. BLDG. FINISHED GRADE	152.4 FT.	158.8 FT.
9) NUMBER OF FLOORS	4 (3 ABOVE + BASEMENT)	3 (NO BASEMENT)
20) REQUIRED MIN. BLDG. SETBACKS FRONT	N/A	20 FT.
NORTHERN SIDE	40 FT.	42 FT.
SOUTHERN SIDE	40 FT.	42 FT.
REAR	40 FT.	N/A
21) PROPOSED MIN. BLDG. SETBACKS		
FRONT	N/A	20 FT.
NORTHERN SIDE	*20 FT.	* 38 FT.
SOUTHERN SIDE	*20 FT.	*27 FT.
REAR	40 FT.	N/A
22) REQUIRED MIN. ZONE SETBACKS FRONT	N/A	20 FT.
NORTHERN SIDE	N/A	42 FT.
SOUTHERN SIDE	N/A	42 FT.
REAR	N/A	42 FT.
23) PROPOSED MIN. ZONE SETBACKS		
FRONT	N/A	20 FT.
NORTHERN SIDE	N/A	42 FT.
SOUTHERN SIDE	N/A	*27 FT. ^a
REAR	N/A	42 FT.
24) LOT FRONTAGE REQUIRED 25) LOT FRONTAGE PROVIDED	50 FT. 167 FT.	
26) OPEN SPACE REQUIRED	N/A N/A	

•					
33) HANDICAPPED PARKING	6	1		5	6
	REQUIRED LOADING	EX. LO	ADING EMAIN	PROP. LOADING	TOTAL PROVIDED LOADING
34) LOADING SPACES	5	2		0	*2
35) EXISTING TRIP GENERATION	728 TPI) (53 PEAI	K AM;	68 PEAK PM)	
36) PROPOSED TRIP GENERATION	728 TPI) (53 PEA	K AM;	68 PEAK PM)	
	NE	W	UF	PGRADED	
37) CROSSWALKS (NUMBER):				0	

28) TOTAL EXISTING PARKING ON SITE 143 (5 STANDARD + 132 COMPACT + 6 HANDICAPPED)

REQUIRED EX. PARKING PROP. TOTAL PROVIDED

12

16

TO REMAIN PARKING

115

PARKING

17

*****131

29) TOTAL REQUIRED PARKING 154 (307 TOTAL BEDS @ 1 SPACE/2 BEDS

30) TOTAL PROVIDED PARKING ______154

31) STANDARD PARKING

32) COMPACT PARKING

38) CURB RAMPS_ 380 39) SIDEWALKS (LF)_ 40) BICYCLE PARKING (NUMBER SPACES): N/A N/A PUBLIC/VISITOR . N/A N/A PRIVATE/GARAGE N/A N/A 41) BICYCLE PATHS (LF) N/A N/A 42) PEDESTRIAN SIGNALS_

a) SEE "ZONE TRANSITION SETBACK SCHEMATIC" ON SHEET 2 FOR ADDITIONAL INFO b) PER MAY 2022 SITE SURVEY

BRADDOCK SEMINARY ROAD CEMETERY SITE MELROSE STREET TELEGRAPH ROAD ` VICINITY MAP SCALE: 1" = 2000'

PRELIMINARY DEVELOPMENT SITE PLAN

WOODBINE

CITY OF ALEXANDRIA

PROJECT NARRATIVE:

REOUEST FOR A MASTER PLAN AMENDMENT TO AMEND MAP 14 TO ALLOW A BUILDING HEIGHT UP TO 45 FT.. REZONING FROM THE R-8 DISTRICT TO THE RB DISTRICT, AND APPLICATION FOR A DEVELOPMENT SPECIAL USE PERMIT TO CONSTRUCT A 3-STORY ADDITION CONTAINING APPROXIMATELY 31,909 SQUARE FEET TO THE EXISTING WOODBINE REHABILITATION & HEALTHCARE CENTER TO FACILITATE ADDITIONAL PRIVATE ROOMS WHILE MAINTAINING THE TOTAL NUMBER OF EXISTING LICENSED BEDS.

EXISTING APPROVALS THAT APPLY TO THE SUBJECT SITE:

- SUP #2002
- SUP #97-0053
- EXISTING TREE PROTECTION EASEMENT, RECORDED UNDER INST. #160010326


*DSUP AND MODIFICATIONS REQUESTED:

- MASTER PLAN AMENDMENT TO AMEND MAP 14 TO ALLOW A BUILDING HEIGHT UP TO 45 FT.
- REZONING FROM THE R-8 TO THE RB DISTRICT.
- DEVELOPMENT SPECIAL USE PERMIT FOR "NURSING HOME" ADDITION. MODIFICATION TO BUILDING SETBACKS ALONG SIDE YARDS AS FOLLOWS:
- NORTH SIDE YARD MODIFICATION FOR THE EXISTING BUILDING FROM 40 FT. TO 20 FT. AND FOR THE PROPOSED ADDITION FROM 42 FT. TO 38 FT. SOUTH SIDE YARD MODIFICATION FOR THE EXISTING BUILDING FROM 40 FT. TO 20 FT AND FOR THE PROPOSED ADDITION FROM 42 FT. TO 27 FT.
- MODIFICATION TO ZONE TRANSITION SETBACK ALONG SOUTHERN BOUNDARY FOR THE PROPOSED ADDITION FROM 42 FT. TO 27 FT.
- MODIFICATION TO ALLOW GREATER THAN 50% OF THE SOUTHERN SIDE YARD FOR PARKING.
- MODIFICATION TO ALLOW REDUCTION IN LOADING FROM 5 TO 2 SPACES.
- SPECIAL USE PERMIT FOR A PARKING REDUCTION TO INCREASE PERMITTED NUMBER OF COMPACT SPACES FROM MAX. 75% TO 85%.

BUILDING CODE SUMMARY - ADDITION ONLY

Beildh (e code bei min mit	11001	1101 01 21
APPLICABLE CODES (VIRGINIA STATEWIDE BUILDING COD	ES)	USE GROUP
VIRGINIA BUILDING & FIRE CODE RELATED REGULATIONS VIRGINIA CONSTRUCTION CODE VIRGINIA STATEWIDE FIRE PREVENTION CODE	2018 2018 2018	IBC = I-2 INSTITUTIONAL NFPA = HEALTH CARE
VIRGINIA ENERGY CONSERVATION CODE VIRGINIA EXISTING BUILDING CODE VIRGINIA FUEL GAS CODE VIRGINIA MECHANICAL CODE VIRGINIA PLUMBING CODE	2018 2018 2018 2018 2018	CONSTRUCTION TYPE VUBC = IIA NFPA = II(111)
VIRGINIA MAINTENANCE CODE	2018	SPRINKLERED =YES
INTERNATIONAL FIRE CODE	2018	STORIES = 3

SEE SHEET 13 FOR FLOOR AREAS PER FLOOR

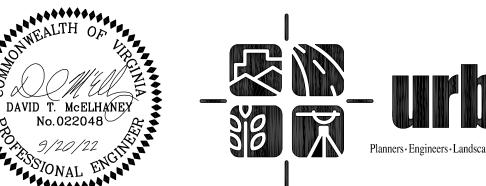



SHEET INDEX

- 1 COVER SHEET
- 2 GENERAL NOTES & DETAILS
- 3 CONTEXT MAP
- 4 EXISTING CONDITIONS
- 5 PRELIMINARY SITE PLAN 30 SCALE
- 6 PRELIMINARY SITE PLAN 20 SCALE
- 7 SITE SECTIONS
- 8 BUILDING ELEVATION WEST
- 9 BUILDING ELEVATION NORTH
- 10 BUILDING ELEVATION EAST
- 11 BUILDING ELEVATION SOUTH
- 11A GROUND FLOOR PLAN
- 11B SECOND FLOOR PLAN
- 11C THIRD FLOOR PLAN
- 12 ROOF PLAN
- 13 FAR
- 14 SCHEMATIC ARCHITECTURAL MASSING
- 15 AUTOTURN ANALYSIS
- 16 EXISTING TREE SURVEY
- 17 TREE PRESERVATION NOTES AND DETAILS
- 18 LANDSCAPE PLAN
- 19 LANDSCAPE COMPUTATIONS
- 20 LANDSCAPE NOTES AND DETAILS
- 21 ENVIRONMENTAL STORMWATER PLAN
- 22 ENVIRONMENTAL STORMWATER PLAN
- 23 ENVIRONMENTAL STORMWATER PLAN
- 24 ENVIRONMENTAL STORMWATER PLAN
- 25 LIGHTING & SIGNAGE PLAN
- 26 G.I.S. DIMENSION PLAN
- 27 SIGHT DISTANCE

PLAN DAT

SHEET OF ZP-13088

CLAN DATE 6/3/22 7/21/22	APPROVED SPECIAL USE PERMIT NO DEPARTMENT OF PLANNING & ZONING
8/19/22 9/20/22	DIRECTOR DATE DEPARTMENT OF TRANSPORTATION & ENVIRONMENTAL SERVICES SITE PLAN NO.
	DIRECTOR DATE CHAIRMAN, PLANNING COMMISSION DATE
	DATE RECORDED INSTRUMENT NO. DEED BOOK NO. PAGE NO.

- THE SUBJECT SITE IS LOCATED ON CITY OF ALEXANDRIA ASSESSMENT MAP NO. 052.02-60-05 AND IS ZONED R-8. PROPERTY OWNER: WOODBINE PROPERTY 1, LLC
- SITE ADDRESS: 2729 KING STREET, ALEXANDRIA, VA 22302.
- AREA TABULATIONS CAN BE FOUND ON THE COVER SHEET.
- 5. THE NATURAL SOILS AT THE SITE CONSIST OF LEONARDTOWN SILT LOAM PER THE GENERALIZED ALEXANDRIA SOILS
- MAP PROVIDED IN THE CITY OF ALEXANDRIA MASTER PLAN'S WATER QUALITY MANAGEMENT SUPPLEMENT. THE PROPOSED AREA OF DEVELOPMENT IS LOCATED IN THE TAYLOR RUN WATERSHED
- CONSTRUCTION PERMITS ARE REQUIRED FOR THIS PROJECT. THE APPROVED SITE PLAN MUST BE ATTACHED TO THE
- PERMIT APPLICATION THAT FULLY DETAILS THE CONSTRUCTION AS WELL AS LAYOUTS AND SCHEMATICS OF THE MECHANICAL, ELECTRICAL, AND PLUMBING SYSTEMS. 8. ALL PUBLIC AND PRIVATE EASEMENTS OR ALL KNOWN PUBLIC AND PRIVATE EASEMENTS, INCLUDING ALL UTILITY, EGRESS. AND CONSERVATION RESTRICTIONS ARE SHOWN. THE APPLICANT SHALL NOT CONSTRUCT ANY PERMANENT
- STRUCTURES OVER ANY EXISTING OR PROPOSED PUBLIC AND/OR PRIVATE EASEMENTS UNLESS OTHERWISE APPROVED BY THE PLANNING COMMISSION AND CITY OF ALEXANDRIA COUNCIL.
- 9. PLAT SUBJECT TO RESTRICTIONS OF RECORD.
- 10. BUILDING HEIGHT SHALL NOT EXCEED THE ALLOWABLE LIMIT BY CITY OF ALEXANDRIA ZONING ORDINANCE OR AS APPROVED BY THE PLANNING COMMISSION AND CITY OF ALEXANDRIA COUNCIL.
- 11. ALL NEW CONSTRUCTION SHALL CONFORM TO THE CURRENT STANDARDS AND SPECIFICATIONS OF THE CITY OF ALEXANDRIA AND TO THE VIRGINIA UNIFORM STATEWIDE BUILDING CODE (USBC).
- 12. FLOOR AREA CALCULATIONS WITH ALLOWABLE LIMITS, AS APPROVED BY PLANNING COMMISSION AND CITY COUNCIL, ARE DEMONSTRATED HEREIN.
- 13. PRIOR TO COMMENCING NEW WORK, THE CONTRACTOR SHALL PROTECT FROM DAMAGE ALL EXISTING ADJACENT AREAS. IF CITY'S EXISTING PUBLIC INFRASTRUCTURE, INCLUDING BUT NOT LIMITED TO, STREETS, ALLEYWAYS, DRIVEWAY APRONS, SANITARY AND STORM SEWERS, STREET LIGHTING, TRAFFIC AND PEDESTRIAN SIGNALS, SIDEWALKS, CURB AND GUTTER, AND STORM WATER DROP INLET STRUCTURES ARE DAMAGED BY THE CONTRACTOR OR BY ACTIVITIES RELATING TO THE SITE CONSTRUCTION THEN THE APPLICANT SHALL REPAIR THE SAME TO THE SATISFACTION OF DIRECTOR, TRANSPORTATION AND ENVIRONMENTAL SERVICES (T&ES). A PRE-CONSTRUCTION WALK/SURVEY OF THE SITE SHALL OCCUR WITH CONSTRUCTION AND INSPECTION STAFF TO DOCUMENT EXISTING CONDITIONS PRIOR TO ANY LAND DISTURBING ACTIVITY
- 14. ALL IMPROVEMENTS TO THE CITY'S RIGHT-OF-WAY SUCH AS CURB, GUTTER, SIDEWALK, AND DRIVEWAY APRONS, ETC., ARE DESIGNED PER THE CITY OF ALEXANDRIA STANDARDS AND SPECIFICATIONS.
- 15. ALL STREET CUT AND PATCH WORK LOCATED IN PUBLIC RIGHT-OF-WAYS. REQUIRED FOR ANY UTILITY INSTALLATION SHALL BE PERFORMED IN STRICT ACCORDANCE WITH THE CITY OF ALEXANDRIA STANDARDS AND SPECIFICATIONS AND TO THE SATISFACTION OF THE DIRECTOR OF TRANSPORTATION AND ENVIRONMENTAL SERVICES (T&ES).
- 16. CONTRACTOR MUST ENSURE THAT THERE IS NO DISTURBANCE ON ADJACENT PROPERTIES WITHOUT RECORDED EASEMENT OR NOTARIZED LETTER OF PERMISSION FROM THE ADJACENT PROPERTY OWNERS.
- 17. ALL REQUIRED STATE AND FEDERAL PERMITS, WHICH COULD INCLUDE PERMITS FROM THE VIRGINIA DEPARTMENT OF CONSERVATION AND RECREATION (VDCRI, VIRGINIA DEPARTMENT OF ENVIRONMENTAL QUALITY (VDEQ), VIRGINIA DEPARTMENT OF HISTORIC RESOURCES (VDHR), UNITED STATES ENVIRONMENTAL PROTECTION AGENCY (USEPA), ARMY CORPS OF ENGINEERS AND VIRGINIA MARINE RESOURCES, MUST BE IN PLACE FOR ALL PROJECT CONSTRUCTION AND MITIGATION WORK PRIOR TO RELEASE OF THE FINAL SITE PLAN. THIS INCLUDES THE STATE REQUIREMENT FOR A VIRGINIA STORMWATER MANAGEMENT PROGRAM (VSMP) GENERAL PERMIT FOR DISCHARGES OF STORMWATER FROM CONSTRUCTION ACTIVITIES FOR LAND DISTURBING ACTIVITIES GREATER THAN 2,500. INFORMATION REGARDING THE VSMP GENERAL PERMIT CAN BE FOUND ONLINE AT: http://www.dcr.virginia.gov/soil_and_water/vsmp.shtml.
- 18. PERMITS FROM THE CITY OF ALEXANDRIA OFFICE OF ENVIRONMENTAL QUALITY (OEQ), TRANSPORTATION AND ENVIRONMENTAL SERVICES (T&ES), AND BUILDING AND FIRE CODE ADMINISTRATION SHALL BE OBTAINED BY THE APPLICANT, AS REQUIRED AND DOCUMENTED HEREIN. THE CONTRACTOR CAN CONTACT ALEXANDRIA FIRE AND CODE ADMINISTRATION DEPARTMENT AT (703) 838-4644 OR (703) 746-4200 FOR ANY QUESTIONS OR ADDITIONAL INFORMATION.
- 19. ANY WORK IN THE PUBLIC RIGHT OF WAY SHALL REQUIRE A SEPARATE PERMIT FROM THE DIRECTOR, TRANSPORTATION AND ENVIRONMENTAL SERVICES. THE CONTRACTOR CAN CONTACT THE DEPARTMENT OF TRANSPORTATION AND ENVIRONMENTAL SERVICES AT (703) 746-4035 FOR ANY QUESTIONS OR ADDITIONAL INFORMATION.
- 20. THE PROPERTY ADDRESS MUST BE CLEARLY MARKED IN THE FRONT AND BACK OF THE PROPOSED DEVELOPMENT SITE DURING CONSTRUCTION FOR EMERGENCY RESPONSE PURPOSES IN CONTRASTING COLORS FOR EASY
- 21. THE APPLICANT SHALL CONTACT THE CRIME PREVENTION UNIT OF THE ALEXANDRIA POLICE DEPARTMENT AT 703-838-4520 REGARDING SECURITY HARDWARE FOR NEW CONSTRUCTION. THIS SHALL BE COMPLETED PRIOR TO ISSUANCE OF BUILDING PERMIT
- 22. ROOF DRAINAGE SYSTEM, SUMP PUMP DISCHARGE, AND FOUNDATION DRAIN SYSTEM MUST BE INSTALLED SO AS NEITHER TO ADVERSELY IMPACT UPON, NOR CAUSE EROSION DAMAGE TO ADJACENT PROPERTIES OR THE PUBLIC
- RIGHT-OF-WAY 23. THE CONTRACTOR MUST ENSURE THAT POSITIVE DRAINAGE OCCURS ON SITE TO PREVENT PONDING OR DRAINAGE PROBLEMS ON ADJACENT PROPERTIES.
- 24. IN THE EVENT, THE PROPOSED ROOF DRAINAGE AND/OR SUMP PUMP DISCHARGE, AND FOUNDATION DRAIN SYSTEMS AND/OR GRADING ADVERSELY IMPACTS AND/OR CREATES A NUISANCE ON PUBLIC RIGHT-OF-WAY OR PRIVATE PROPERTIES THEN THE APPLICANT SHALL BE RESPONSIBLE TO PROVIDE ADDITIONAL IMPROVEMENTS TO THE ROOF DRAINAGE AND/OR SUMP PUMP DISCHARGE AND FOUNDATION DRAIN SYSTEMS AND/OR GRADING TO THE SATISFACTION OF DIRECTOR, TRANSPORTATION AND ENVIRONMENTAL SERVICES.
- 25. PER THE REQUIREMENTS OF SECTION 8-1-12 OF THE CITY CHARTER AND CODE: WHEN THE BUILDING FOOTING HAS BEEN PLACED AND THE WALLS HAVE BEEN RAISED TO THE FIRST JOIST BEARING OR STORY HEIGHT ABOVE GRADE. A PLOT PLAN SHOWING THE EXACT LOCATION OF THE WALLS SHALL BE PREPARED BY A LICENSED, CERTIFIED PUBLIC LAND SURVEYOR OR PROFESSIONAL ENGINEER AND FILED WITH THE BUILDING OFFICIAL FOR APPROVAL BEFORE PROCEEDING FURTHER WITH THE CONSTRUCTION.
- 26. A SEPARATE DESIGN IS REQUIRED FOR ALL WALLS 24" AND OVER IN HEIGHT FROM THE GRADE AND SUBJECT TO SEPARATE PERMITS TO BE OBTAINED BY THE OWNERS. GEOTECHNICAL AND STRUCTURAL DESIGN IS TO BE COMPLETED BY OTHERS. THIS FINAL SITE PLAN SHOWS LOCATION, PROPOSED GRADING, AND DESIGN OF ALL THE
- 27. SUBMIT A SURVEY, CONSISTENT WITH THE REQUIREMENTS FOR CERTIFICATE OF OCCUPANCY CHECKLIST, TO THE DEPARTMENT OF TRANSPORTATION AND ENVIRONMENTAL SERVICES PRIOR TO REQUESTING AN INSPECTION FOR A CERTIFICATE OF OCCUPANCY.
- 28. ALL SANITARY LATERALS AND/OR SEWERS NOT SHOWN IN THE EASEMENTS SHALL BE OWNED AND MAINTAINED PRIVATELY.
- 29. ALL STORM DRAINS NOT SHOWN WITHIN AN EASEMENT OR IN A PUBLIC RIGHT-OF-WAY SHALL BE OWNED AND MAINTAINED PRIVATELY.
- 30. ALL WATER FACILITY CONSTRUCTION SHALL CONFORM TO VIRGINIA AMERICAN WATER COMPANY STANDARDS AND SPECIFICATIONS. CONTRACTOR SHALL CONTACT VIRGINIA AMERICAN WATER COMPANY AT (703) 549-7080 TO COORDINATE CONSTRUCTION AND INSPECTION OF WATER FACILITIES.
- 31. THE SIDEWALKS SHALL REMAIN OPENED DURING CONSTRUCTION OR PEDESTRIAN ACCESS SHALL BE MAINTAINED TO THE SATISFACTION OF THE DIRECTOR OF TRANSPORTATION AND ENVIRONMENTAL SERVICES THROUGHOUT THE CONSTRUCTION OF THE PROJECT.
- 32. PRIOR TO THE RELEASE OF THE FINAL SITE PLAN, A TRAFFIC CONTROL PLAN FOR CONSTRUCTION DETAILING PROPOSED CONTROLS TO TRAFFIC MOVEMENT, LANE CLOSURES, CONSTRUCTION ENTRANCES, HAUL ROUTES, AND STORAGE AND STAGING SHALL BE PROVIDED FOR INFORMATION PURPOSES; HOWEVER, AN AMENDED TRAFFIC CONTROL PLAN, IF REQUIRED BY THE DIRECTOR OF TRANSPORTATION AND ENVIRONMENTAL SERVICES SHALL BE SUBMITTED TO THE DIRECTOR OF TRANSPORTATION AND ENVIRONMENTAL SERVICES ALONG WITH THE BUILDING PERMIT APPLICATION. THE FINAL SITE PLAN SHALL INCLUDE A STATEMENT "FOR INFORMATION ONLY" ON THE TRAFFIC
- CONTROL PLAN SHEETS. 33. A CERTIFICATE OF OCCUPANCY SHALL BE OBTAINED PRIOR TO ANY OCCUPANCY OF THE BUILDING OR PORTION
- THEREOF, IN ACCORDANCE WITH VIRGINIA USBC 115.0. 34. THIS SITE IS NOT LOCATED WITHIN A COMBINED SEWER AREA.
- 35. THERE ARE NO RESOURCE PROTECTION AREAS (RPA), AS DEFINED IN ARTICLE XIII OF THE ZONING ORDINANCE, ON
- THIS SITE. 36. THE PROPERTY HEREON IS LOCATED IN FLOOD HAZARD ZONE "X", WHICH IS AN AREA DETERMINED TO BE OUTSIDE THE 500 YEAR FLOODPLAIN, AS SHOWN ON FLOOD INSURANCE RATE MAP (F.I.R.M.) FOR CITY OF ALEXANDRIA,
- VIRGINIA, COMMUNITY PANEL #515519 0029E, REVISED JUNE 16, 2011. 37. COORDINATES SHOWN HEREON ARE REFERENCED TO NAD1983 VIRGINIA STATE PLANE COORDINATE SYSTEM AND ARE EXPRESSED IN SURVEY FEET.
- 38. ELEVATION DATUM USED IS REFERENCED TO THE NATIONAL GEODETIC VERTICAL DATUM 88.
- 39. CONTRACTOR SHALL ENSURE ALL DISCHARGES ARE IN ACCORDANCE WITH CITY OF ALEXANDRIA CODE TITLE 5,
- CHAPTER 6, ARTICLE B. 40. DEWATERING AND OTHER CONSTRUCTION-RELATED DISCHARGE LIMITS TO THE SEWER SYSTEM ARE REGULATED BY ALEXRENEW PRETREATMENT. THE CONTRACTOR IS REQUIRED TO CONTACT ALEXRENEW'S PRETREATMENT COORDINATOR AR 703-721-3500 X2020.

GREEN BUILDING / LOW IMPACT DEVELOPMENT NARRATIVE

THE PROJECT SHALL COMPLY WITH THE REQUIREMENTS DEFINED BY THE CITY OF ALEXANDRIA 2019 GREEN BUILDING POLICY USING THE LEED BD&C HEALTHCARE RATING SYSTEM AND WILL ACHIEVE THE EQUIVALENT OF LEED SILVER CERTIFICATION FOR THE BUILDING ADDITION ONLY. PLEASE REFER TO THE "2729 KING STREET ADDITIONS AND RENOVATIONS LEED CERTIFICATION" PACKAGE SUBMITTED UNDER SEPARATE COVER.

STORM WATER MANAGEMENT/ BEST MANAGEMENT PRACTICE

SEE SHEETS 21 - 23 FOR STORMWATER PLAN AND NARRATIVES

SANITARY SEWER OUTFALL NARRATIVE

SANITARY FLOWS FROM THE PROPOSED BUILDING WILL DRAIN INTO THE EXISTING 10" PUBLIC SANITARY SEWER WITHIN THE RIGHT-OF-WAY OF KING STREET. ACCORDING TO CITY GIS, SANITARY SEWERS FLOW WESTWARD FROM THERE INTO THE EXISTING 18" MAIN ALONG TAYLOR RUN TO JOIN THE 24" TRUNK MAIN ACROSS TELEGRAPH ROAD AND ALONG

IT IS NOT ANTICIPATED THAT THE PROPOSED IMPROVEMENTS WILL RESULT IN ADDITIONAL SANITARY FLOWS THAT EXCEED 10,000 GDP. HENCE, A SANITARY OUTFALL ANALYSIS IS NOT REQUIRED.

MARINE CLAY STATEMENT

BASED ON INFORMATION FROM UNITED STATES DEPARTMENT OF AGRICULTURE, NATURAL RESOURCES CONSERVATION SERVICE AND THE GENERALIZED ALEXANDRIA SOILS MAP PROVIDED IN THE CITY OF ALEXANDRIA MASTER PLAN'S WATER QUALITY MANAGEMENT SUPPLEMENT, THERE ARE NO KNOWN MARINE CLAY AREAS WITHIN THE PROPOSED DEVELOPMENT AREA OF THE SITE. HOWEVER, THERE ARE MARINE CLAYS ON THE EAST SIDE OF THE SUBJECT PARCEL.


ENVIRONMENTAL STATEMENT

BASED ON INFORMATION FROM UNITED STATES DEPARTMENT OF AGRICULTURE, NATURAL RESOURCES CONSERVATION SERVICE AND THE GENERALIZED ALEXANDRIA SOILS MAP PROVIDED IN THE CITY OF ALEXANDRIA MASTER PLAN'S WATER QUALITY MANAGEMENT SUPPLEMENT. THERE ARE NO KNOWN OR EXPECTED CONTAMINANTS WITHIN THIS SITE.

ARCHAEOLOGY NOTES

- 1. ALL REQUIRED ARCHAEOLOGICAL PRESERVATION MEASURES SHALL BE COMPLETED PRIOR TO GROUND-DISTURBING ACTIVITIES (SUCH AS CORING, GRADING, FILLING, VEGETATION REMOVAL, UNDERGROUNDING UTILITIES, PILE DRIVING, LANDSCAPING AND OTHER EXCAVATIONS AS DEFINED IN SECTION 2-151 OF THE ZONING ORDINANCE) OR A RESOURCE MANAGEMENT PLAN MUST BE IN PLACE TO RECOVER SIGNIFICANT RESOURCES IN CONCERT WITH CONSTRUCTION ACTIVITIES. TO CONFIRM, CALL ALEXANDRIA ARCHAEOLOGY AT
- 2. THE APPLICANT/DEVELOPER SHALL CALL ALEXANDRIA ARCHAEOLOGY IMMEDIATELY ((703)746-4399) IF ANY BURIED STRUCTURAL REMAINS (WALL FOUNDATIONS, WELLS, PRIVIES, CISTERNS, ETC.) OR CONCENTRATIONS OF ARTIFACTS ARE DISCOVERED DURING DEVELOPMENT. WORK MUST CEASE IN THE AREA OF THE DISCOVERY UNTIL A CITY ARCHAEOLOGIST COMES TO THE SITE AND RECORDS THE FINDS.
- 3. THE APPLICANT/DEVELOPER SHALL NOT ALLOW ANY METAL DETECTION TO BE CONDUCTED ON THE PROPERTY,
- 4. ALL REQUIRED ARCHAEOLOGICAL PRESERVATION MEASURES SHALL BE COMPLETED IN COMPLIANCE WITH SECTION

UNLESS AUTHORIZED BY ALEXANDRIA ARCHAEOLOGY. 11-411 OF THE ZONING ORDINANCE.

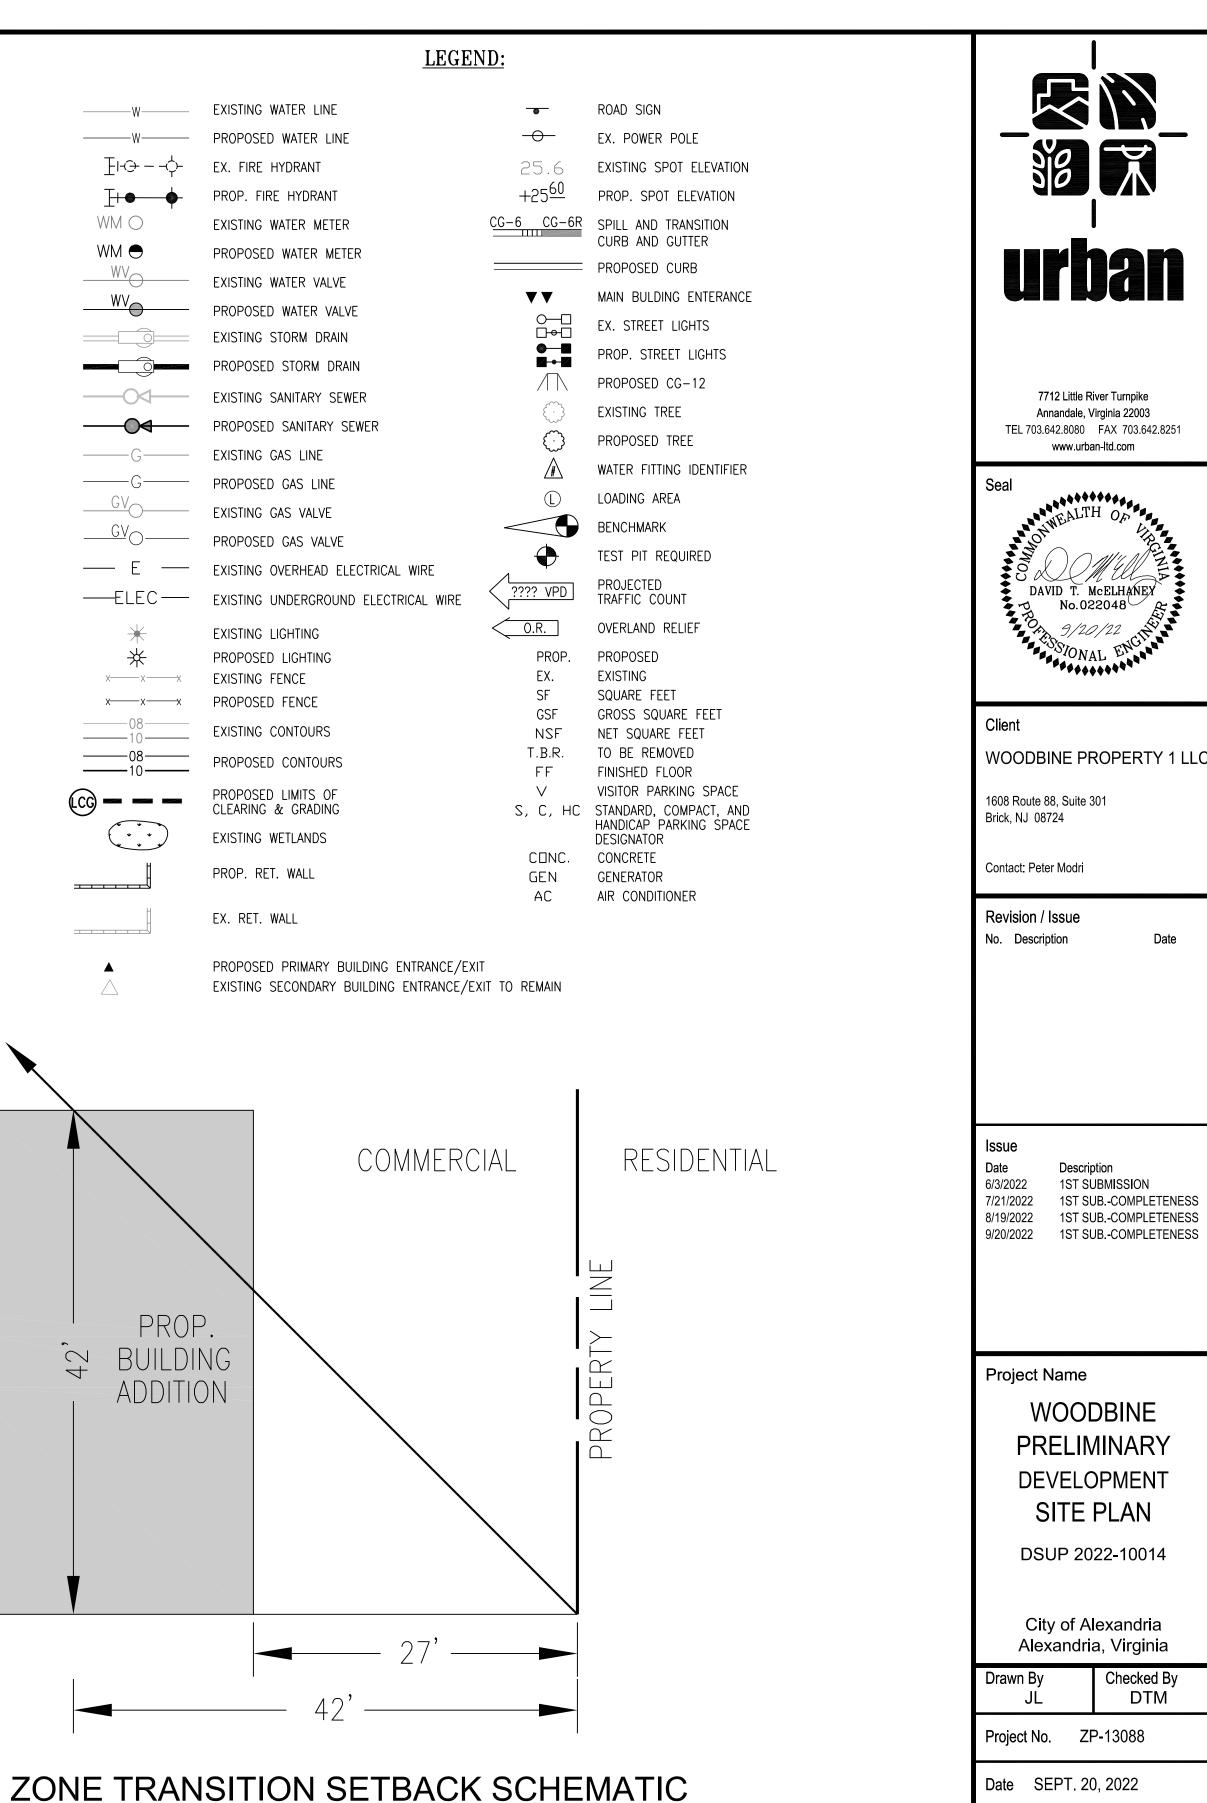

SCALE: 1/8"=1'-0"

City of Alexandria

Checked By DTM

Drawing Title

GENERAL APPROVED **NOTES & DETAILS** SPECIAL USE PERMIT NO. DEPARTMENT OF PLANNING & ZONING DIRECTOR DEPARTMENT OF TRANSPORTATION & ENVIRONMENTAL SERVICES SITE PLAN NO.

PAGE NO.

Scale: N.A. DIRECTOR

DEED BOOK NO.


CHAIRMAN, PLANNING COMMISSION

DATE RECORDED


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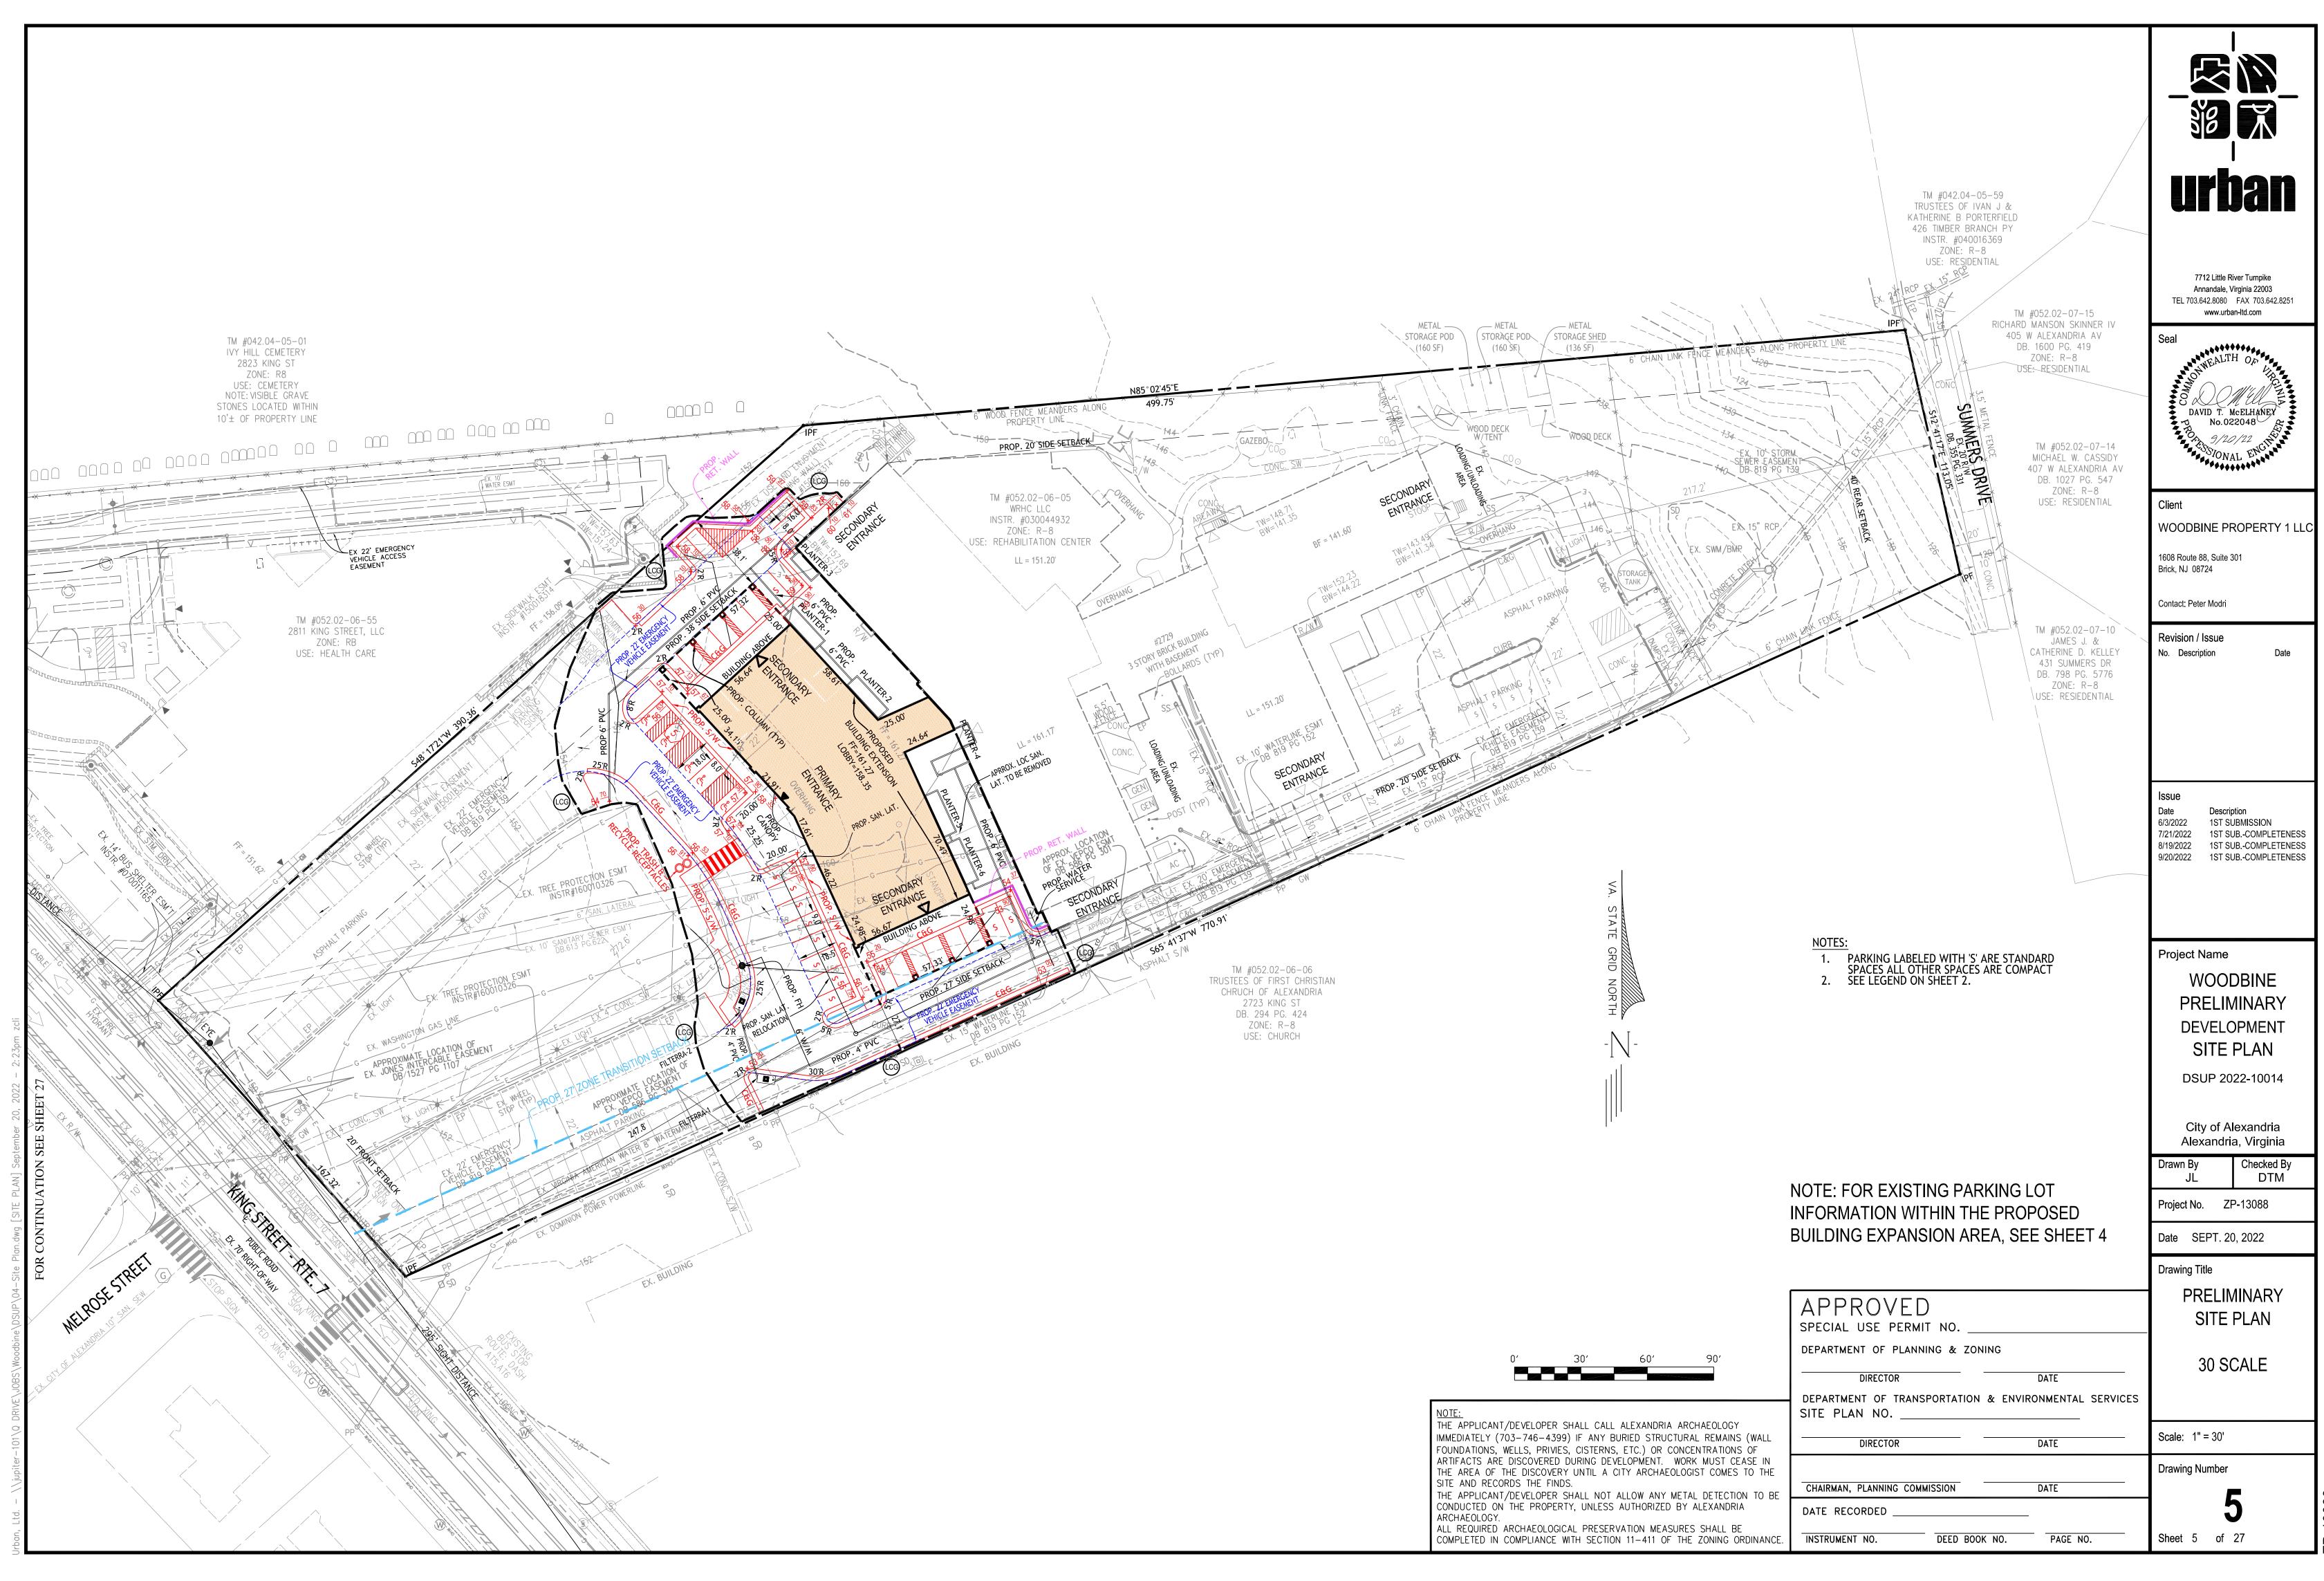
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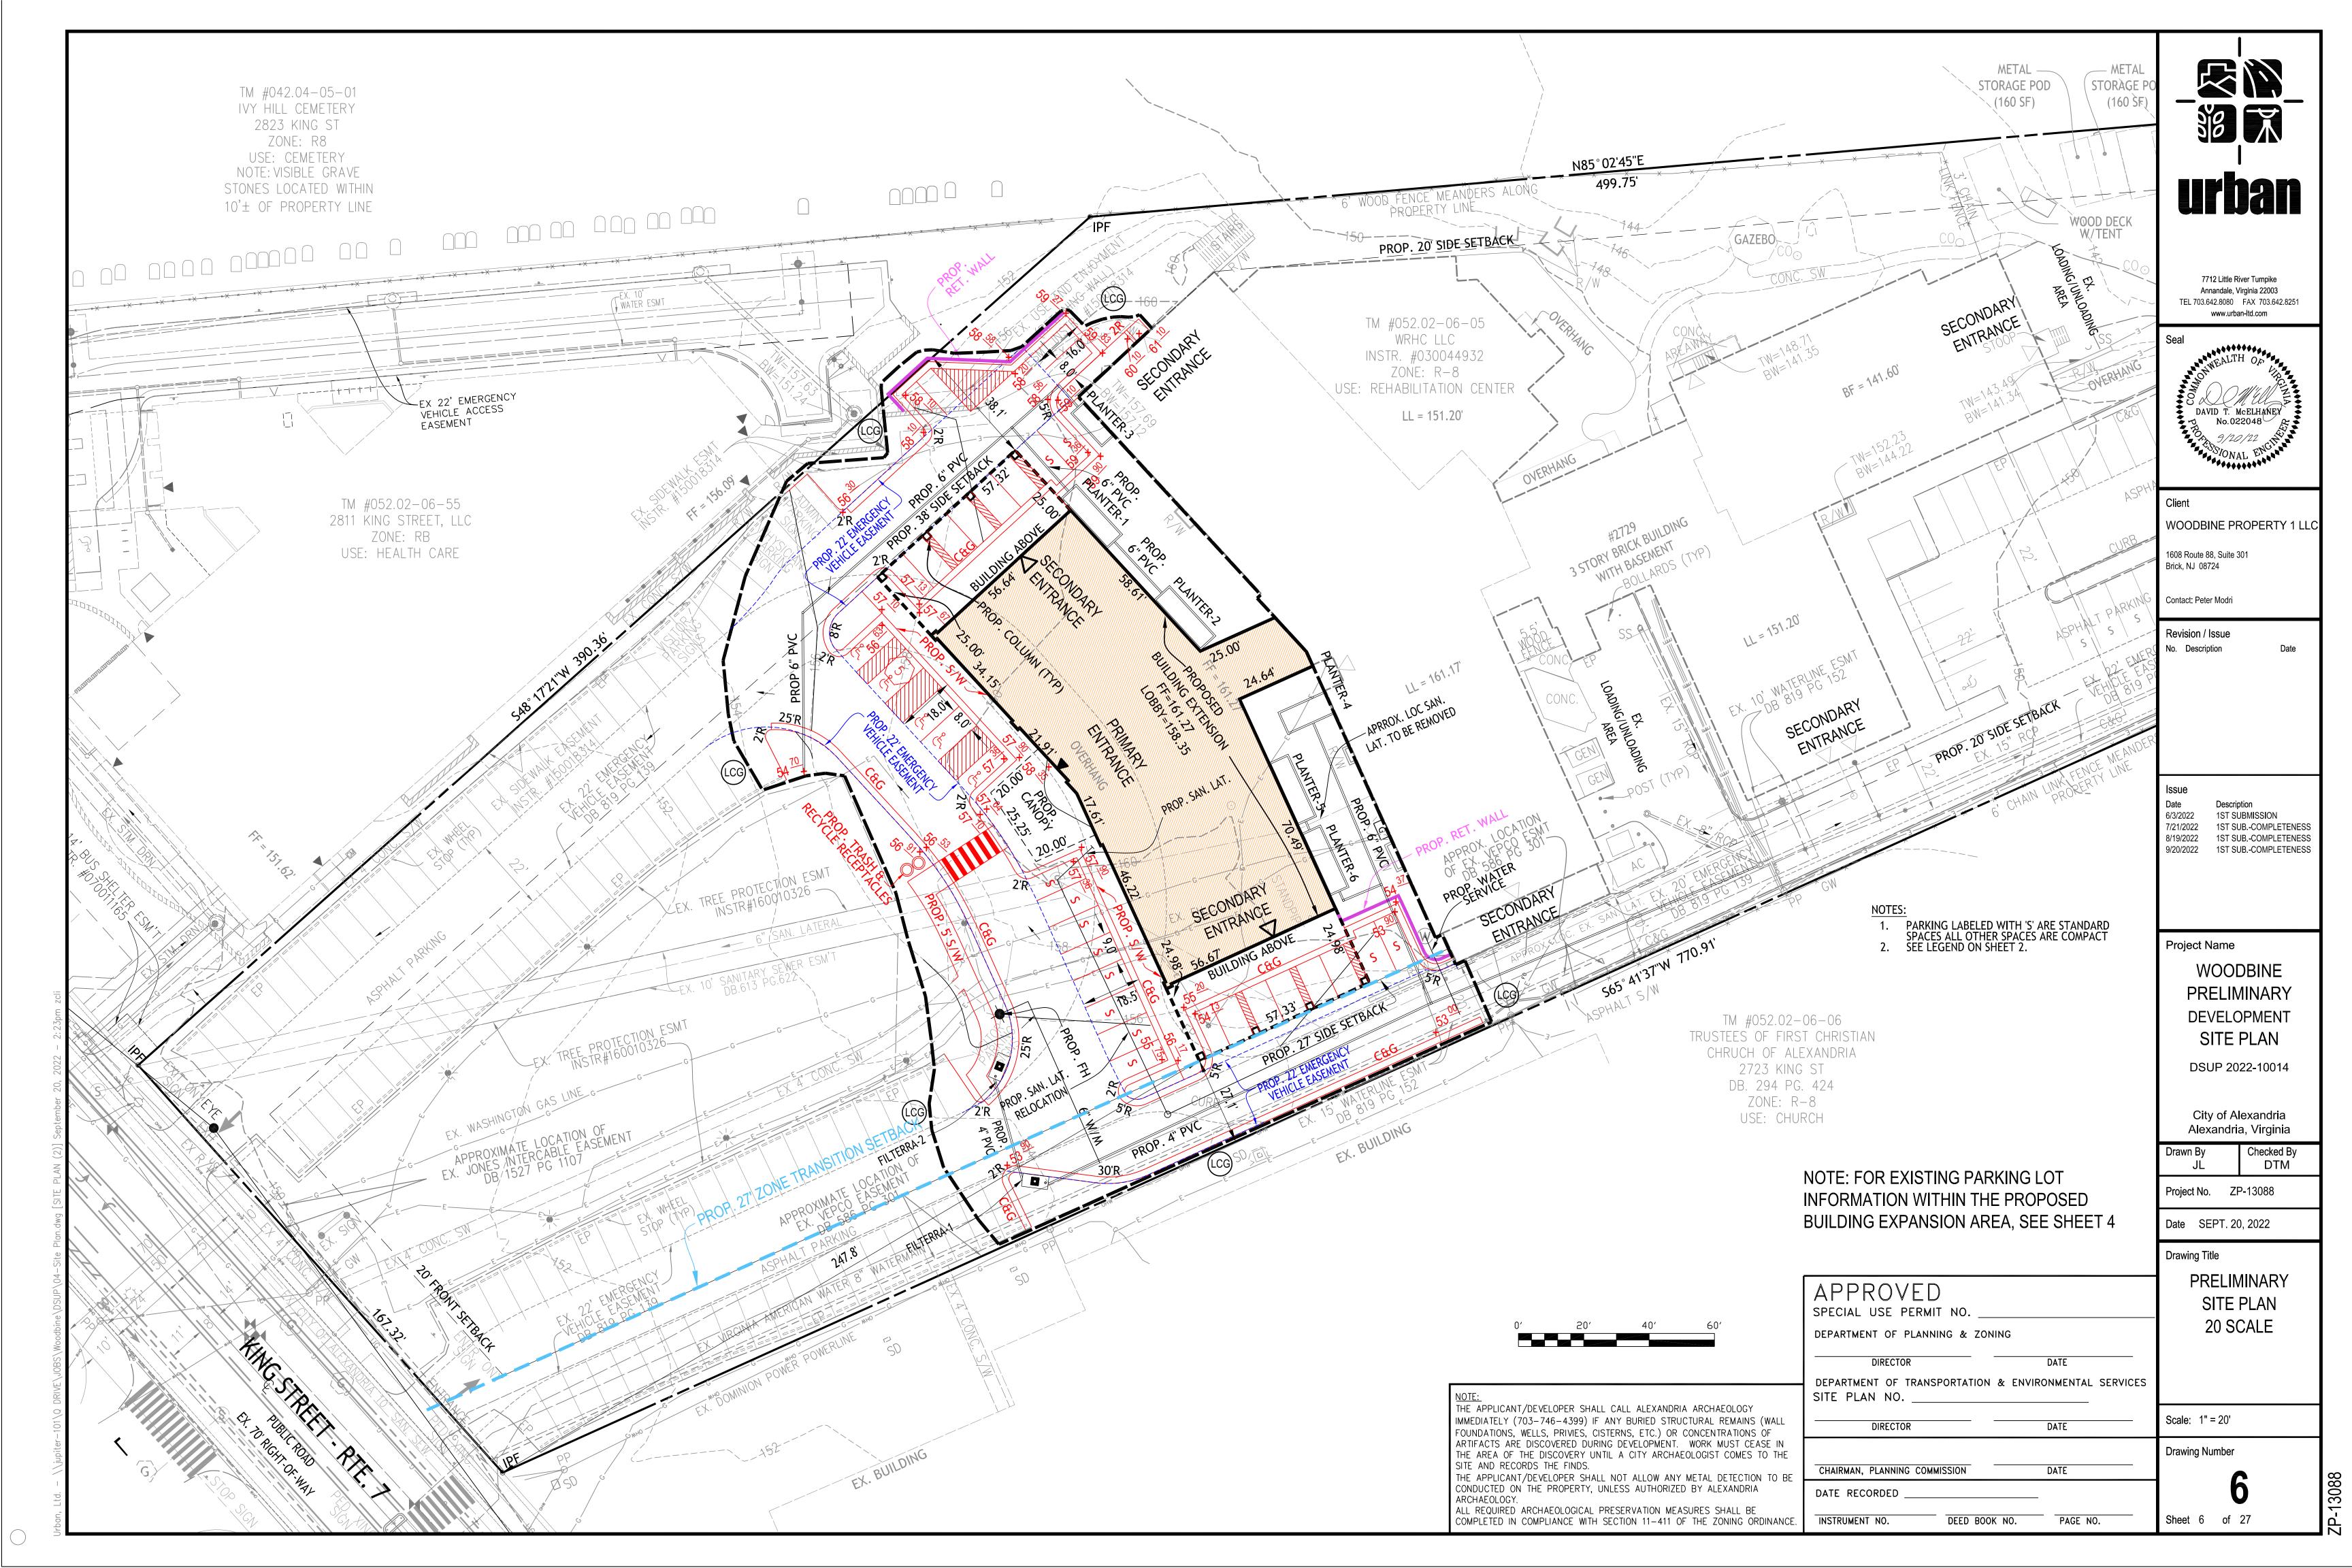
Sheet 2 of 27




ZP-130

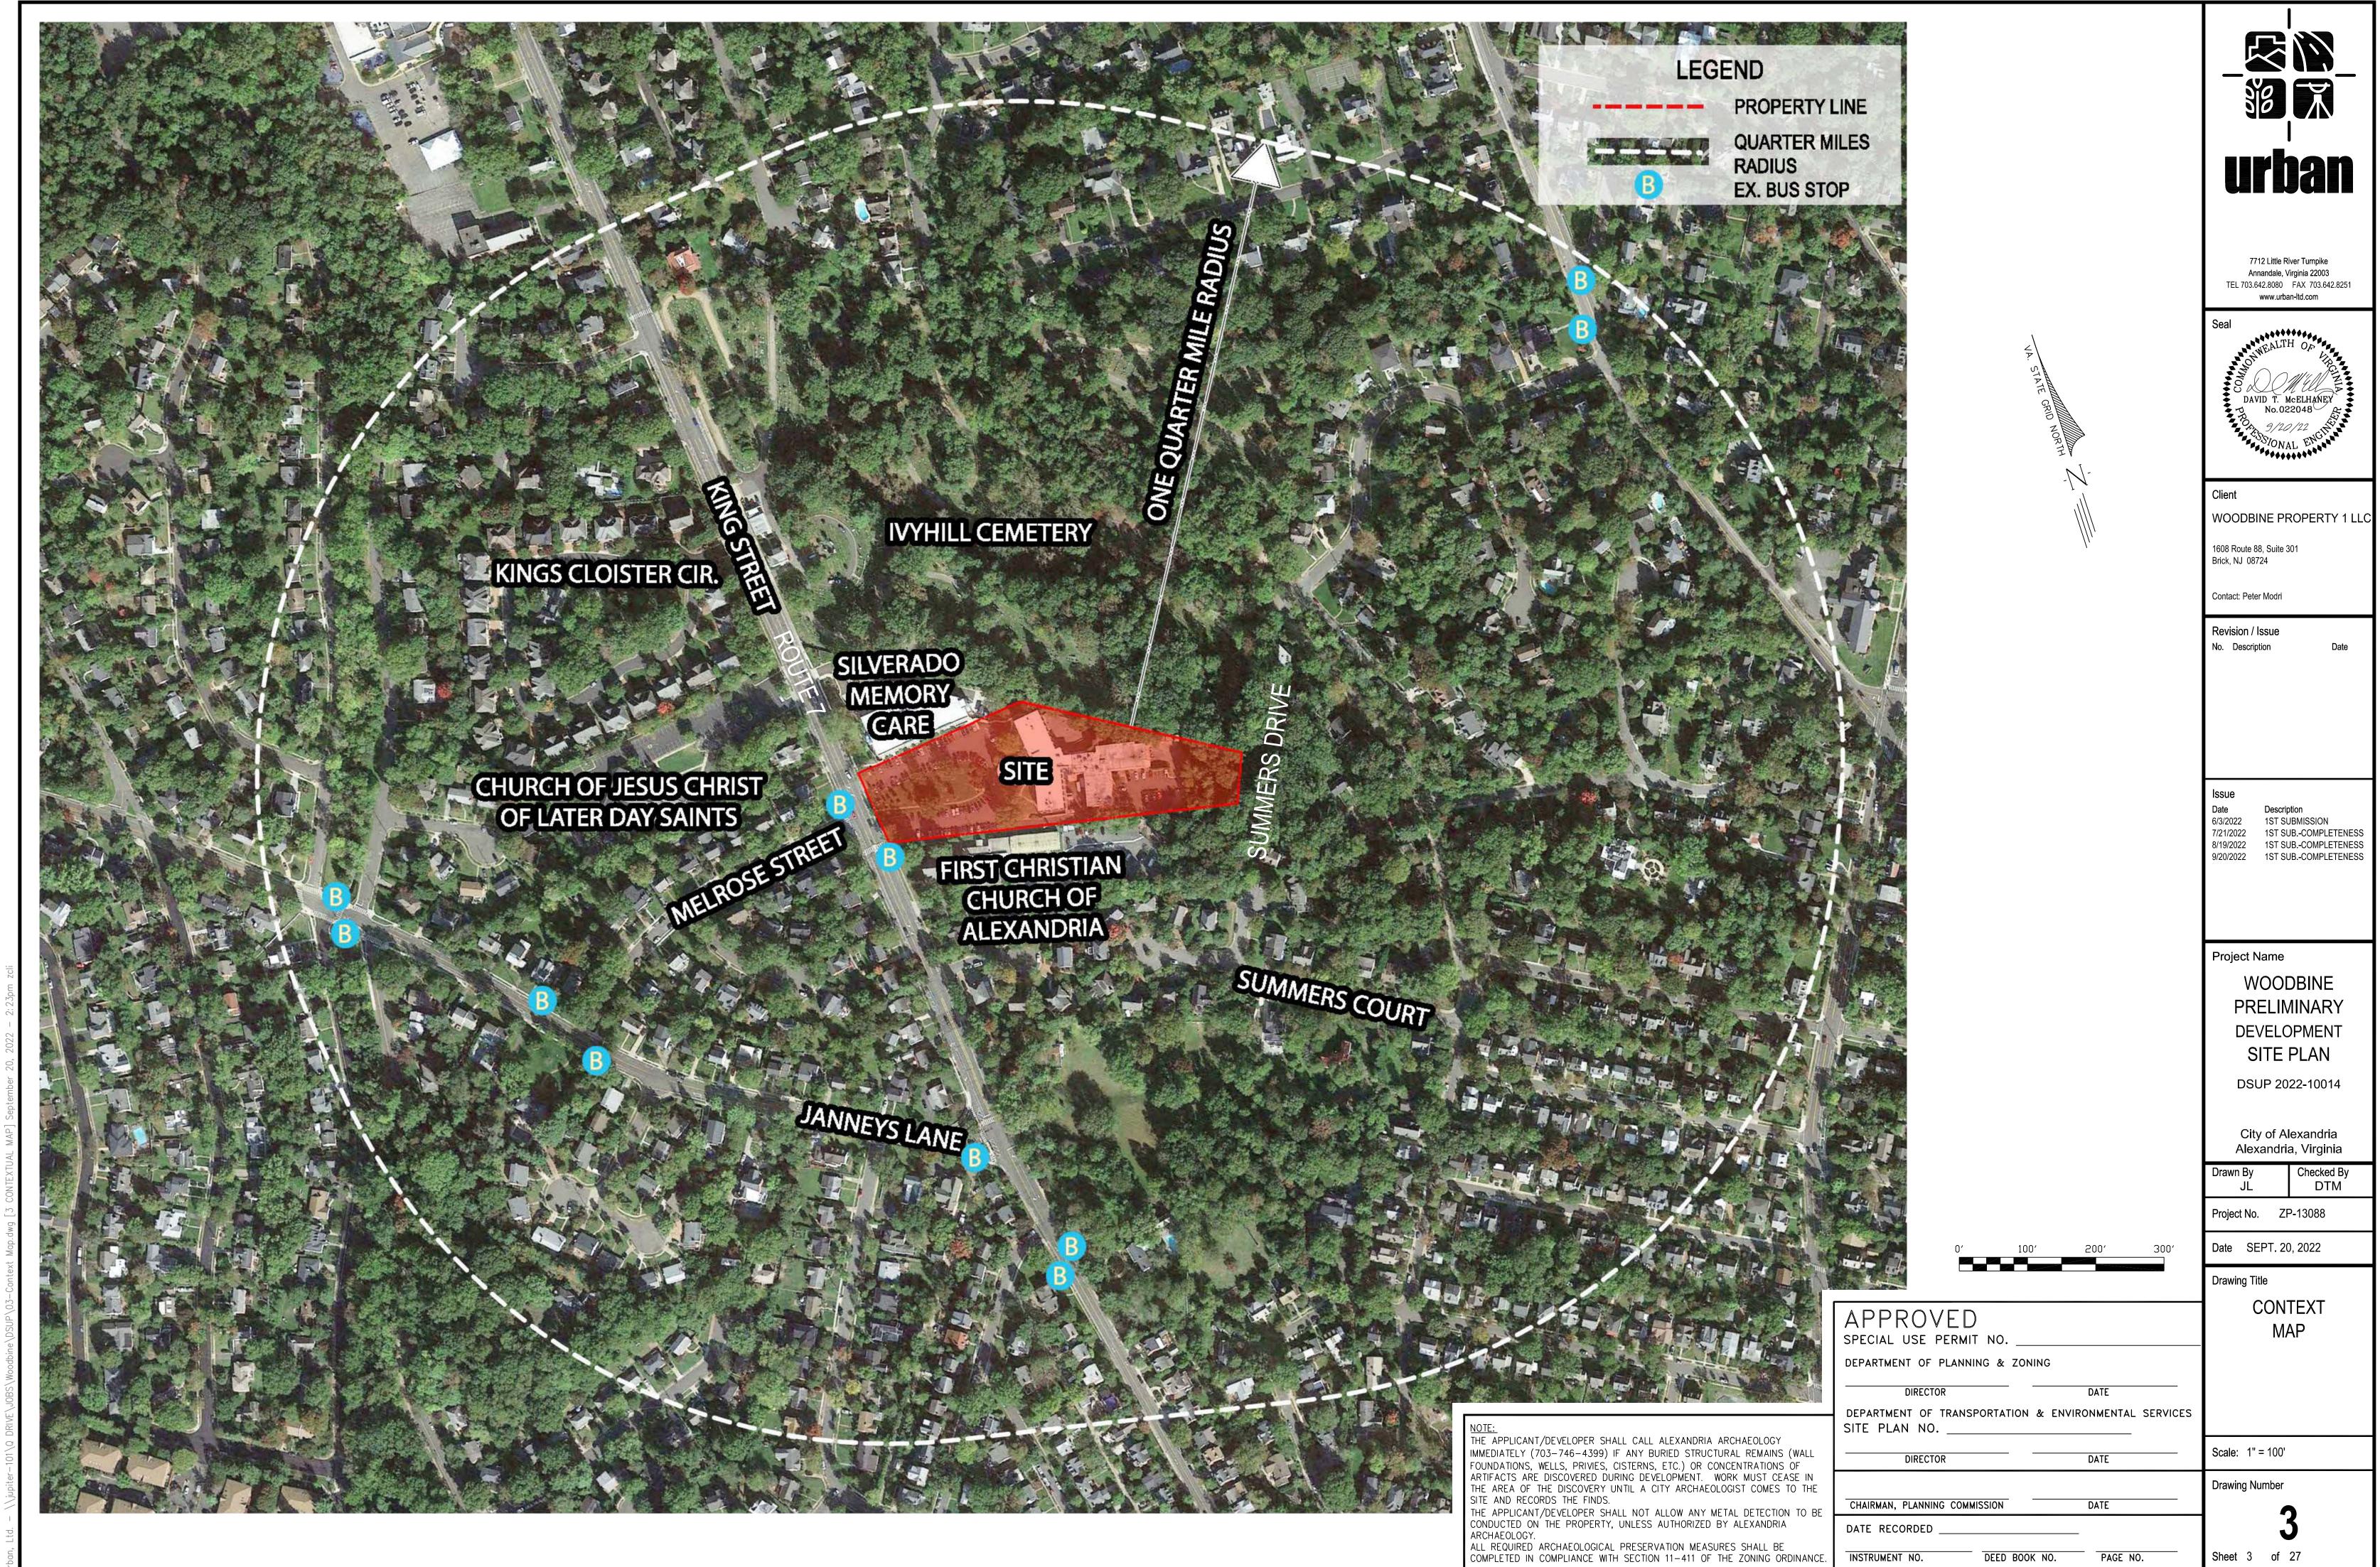



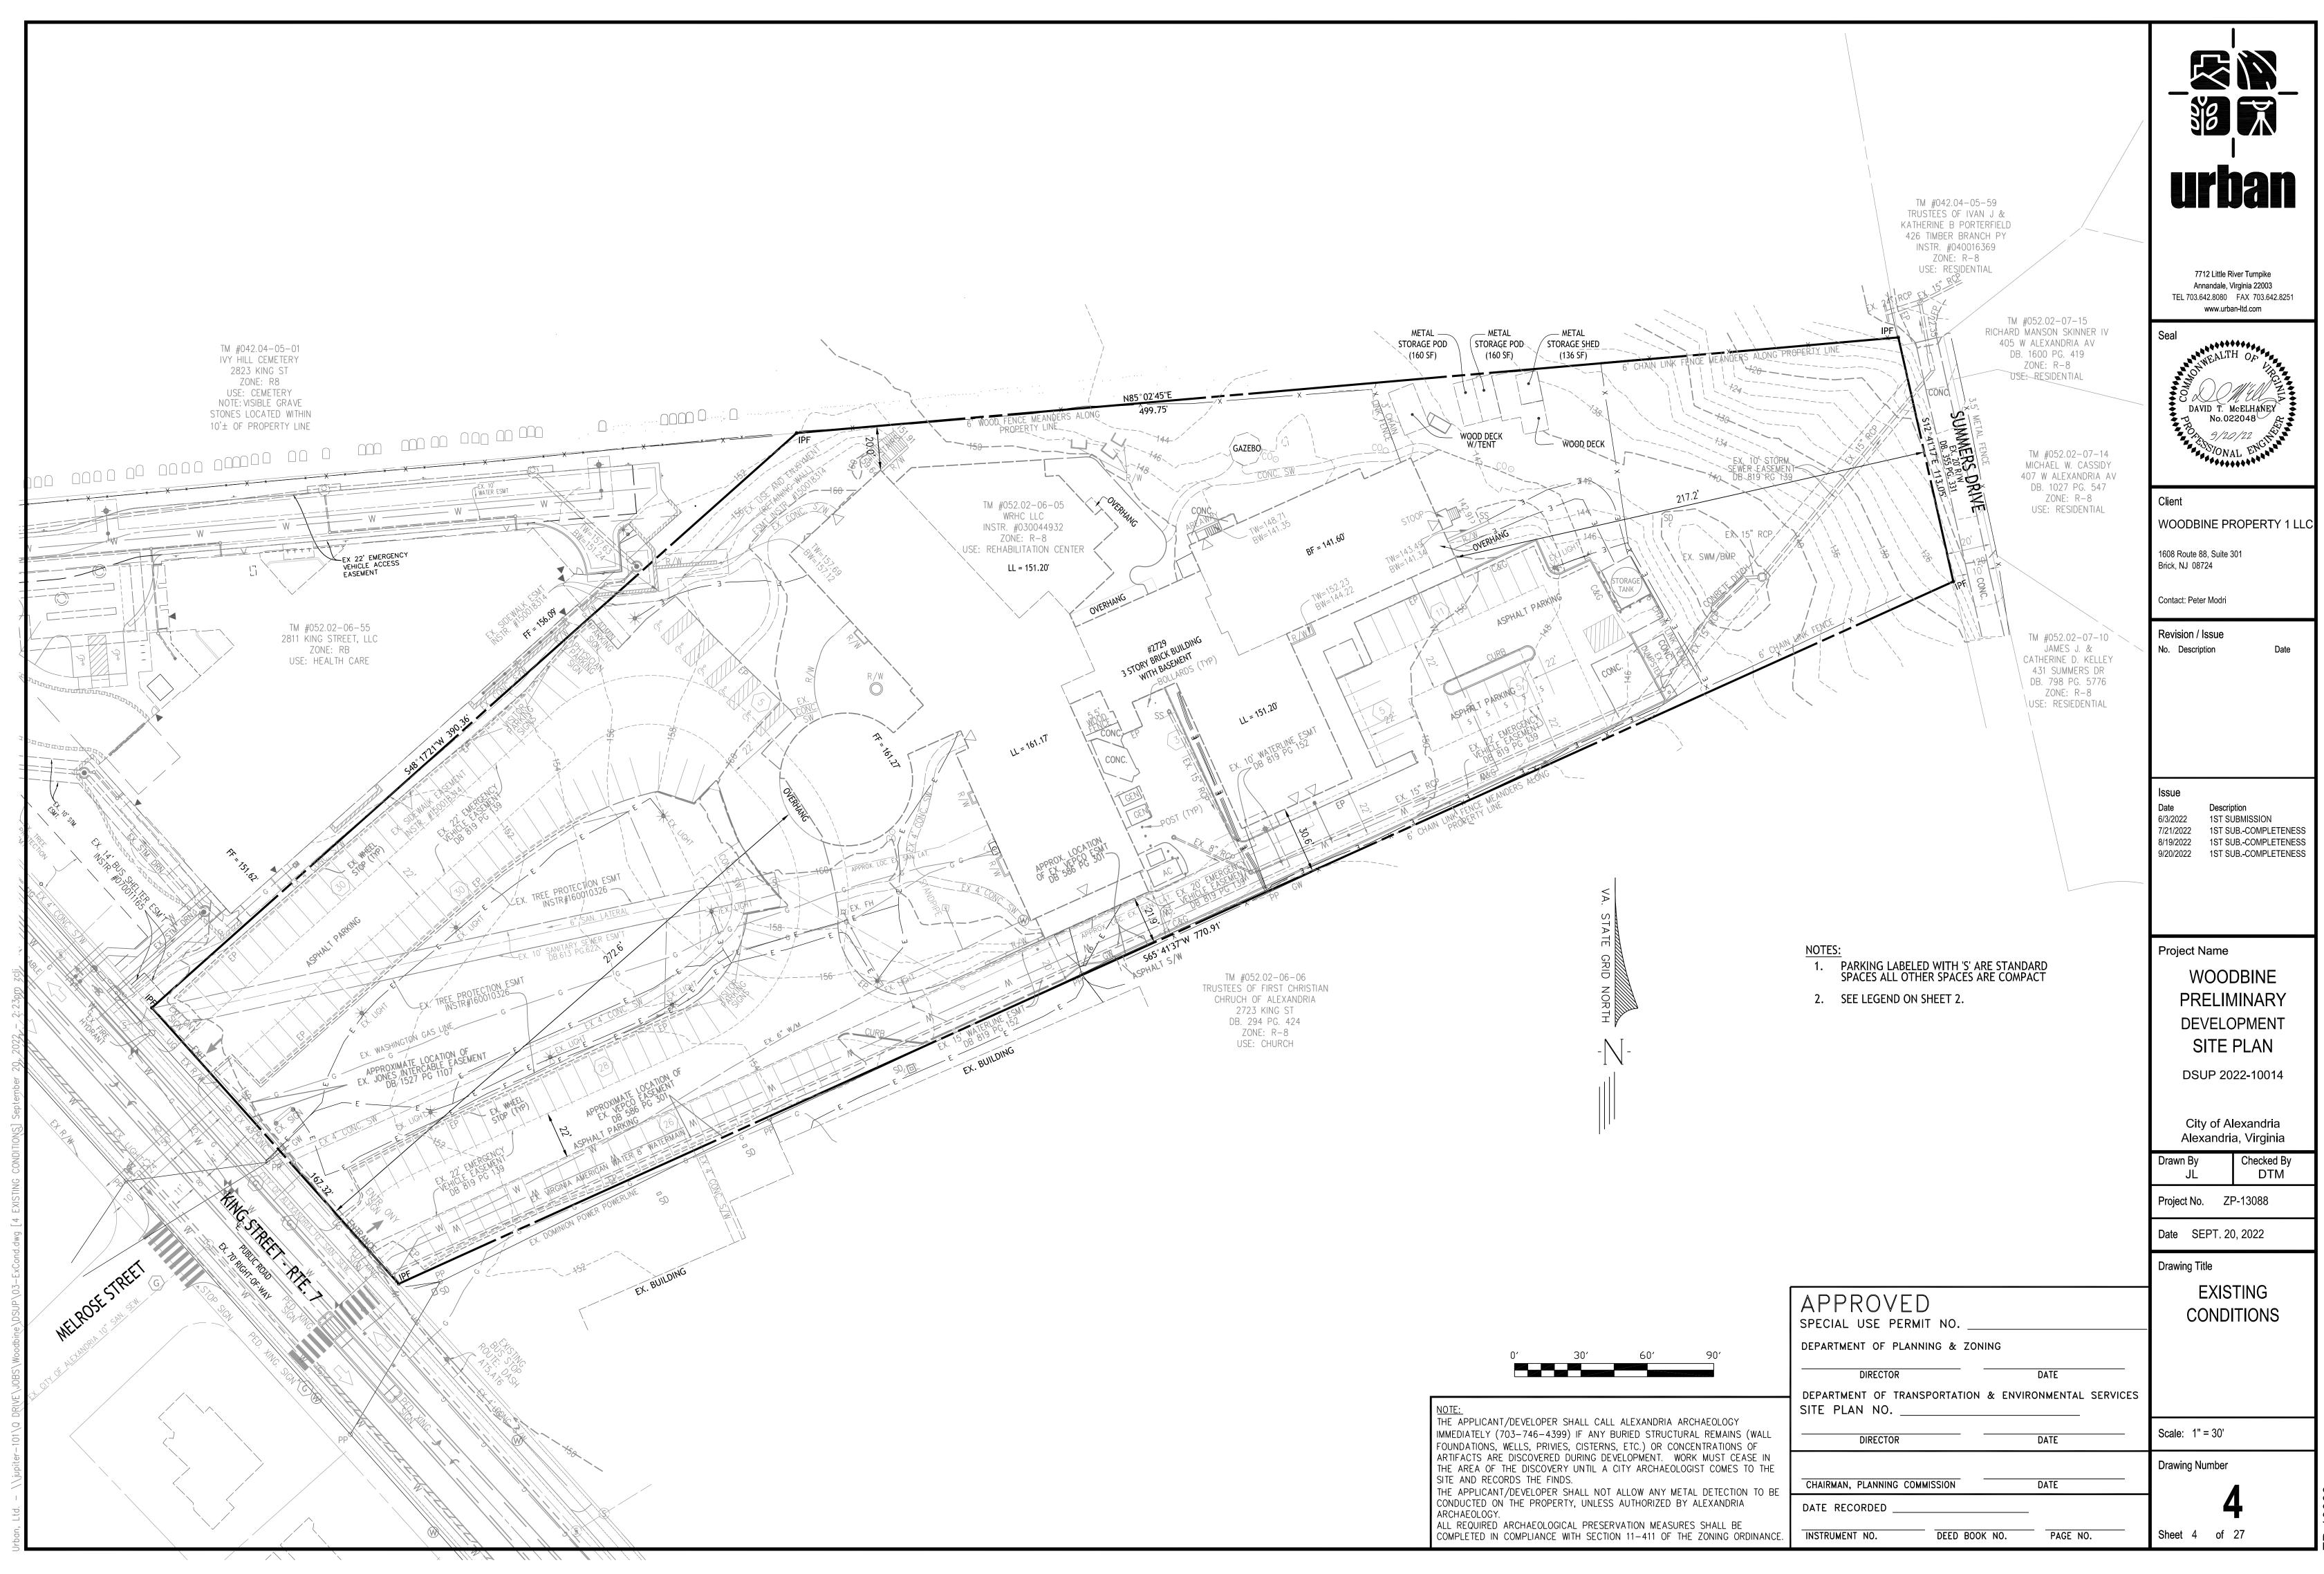

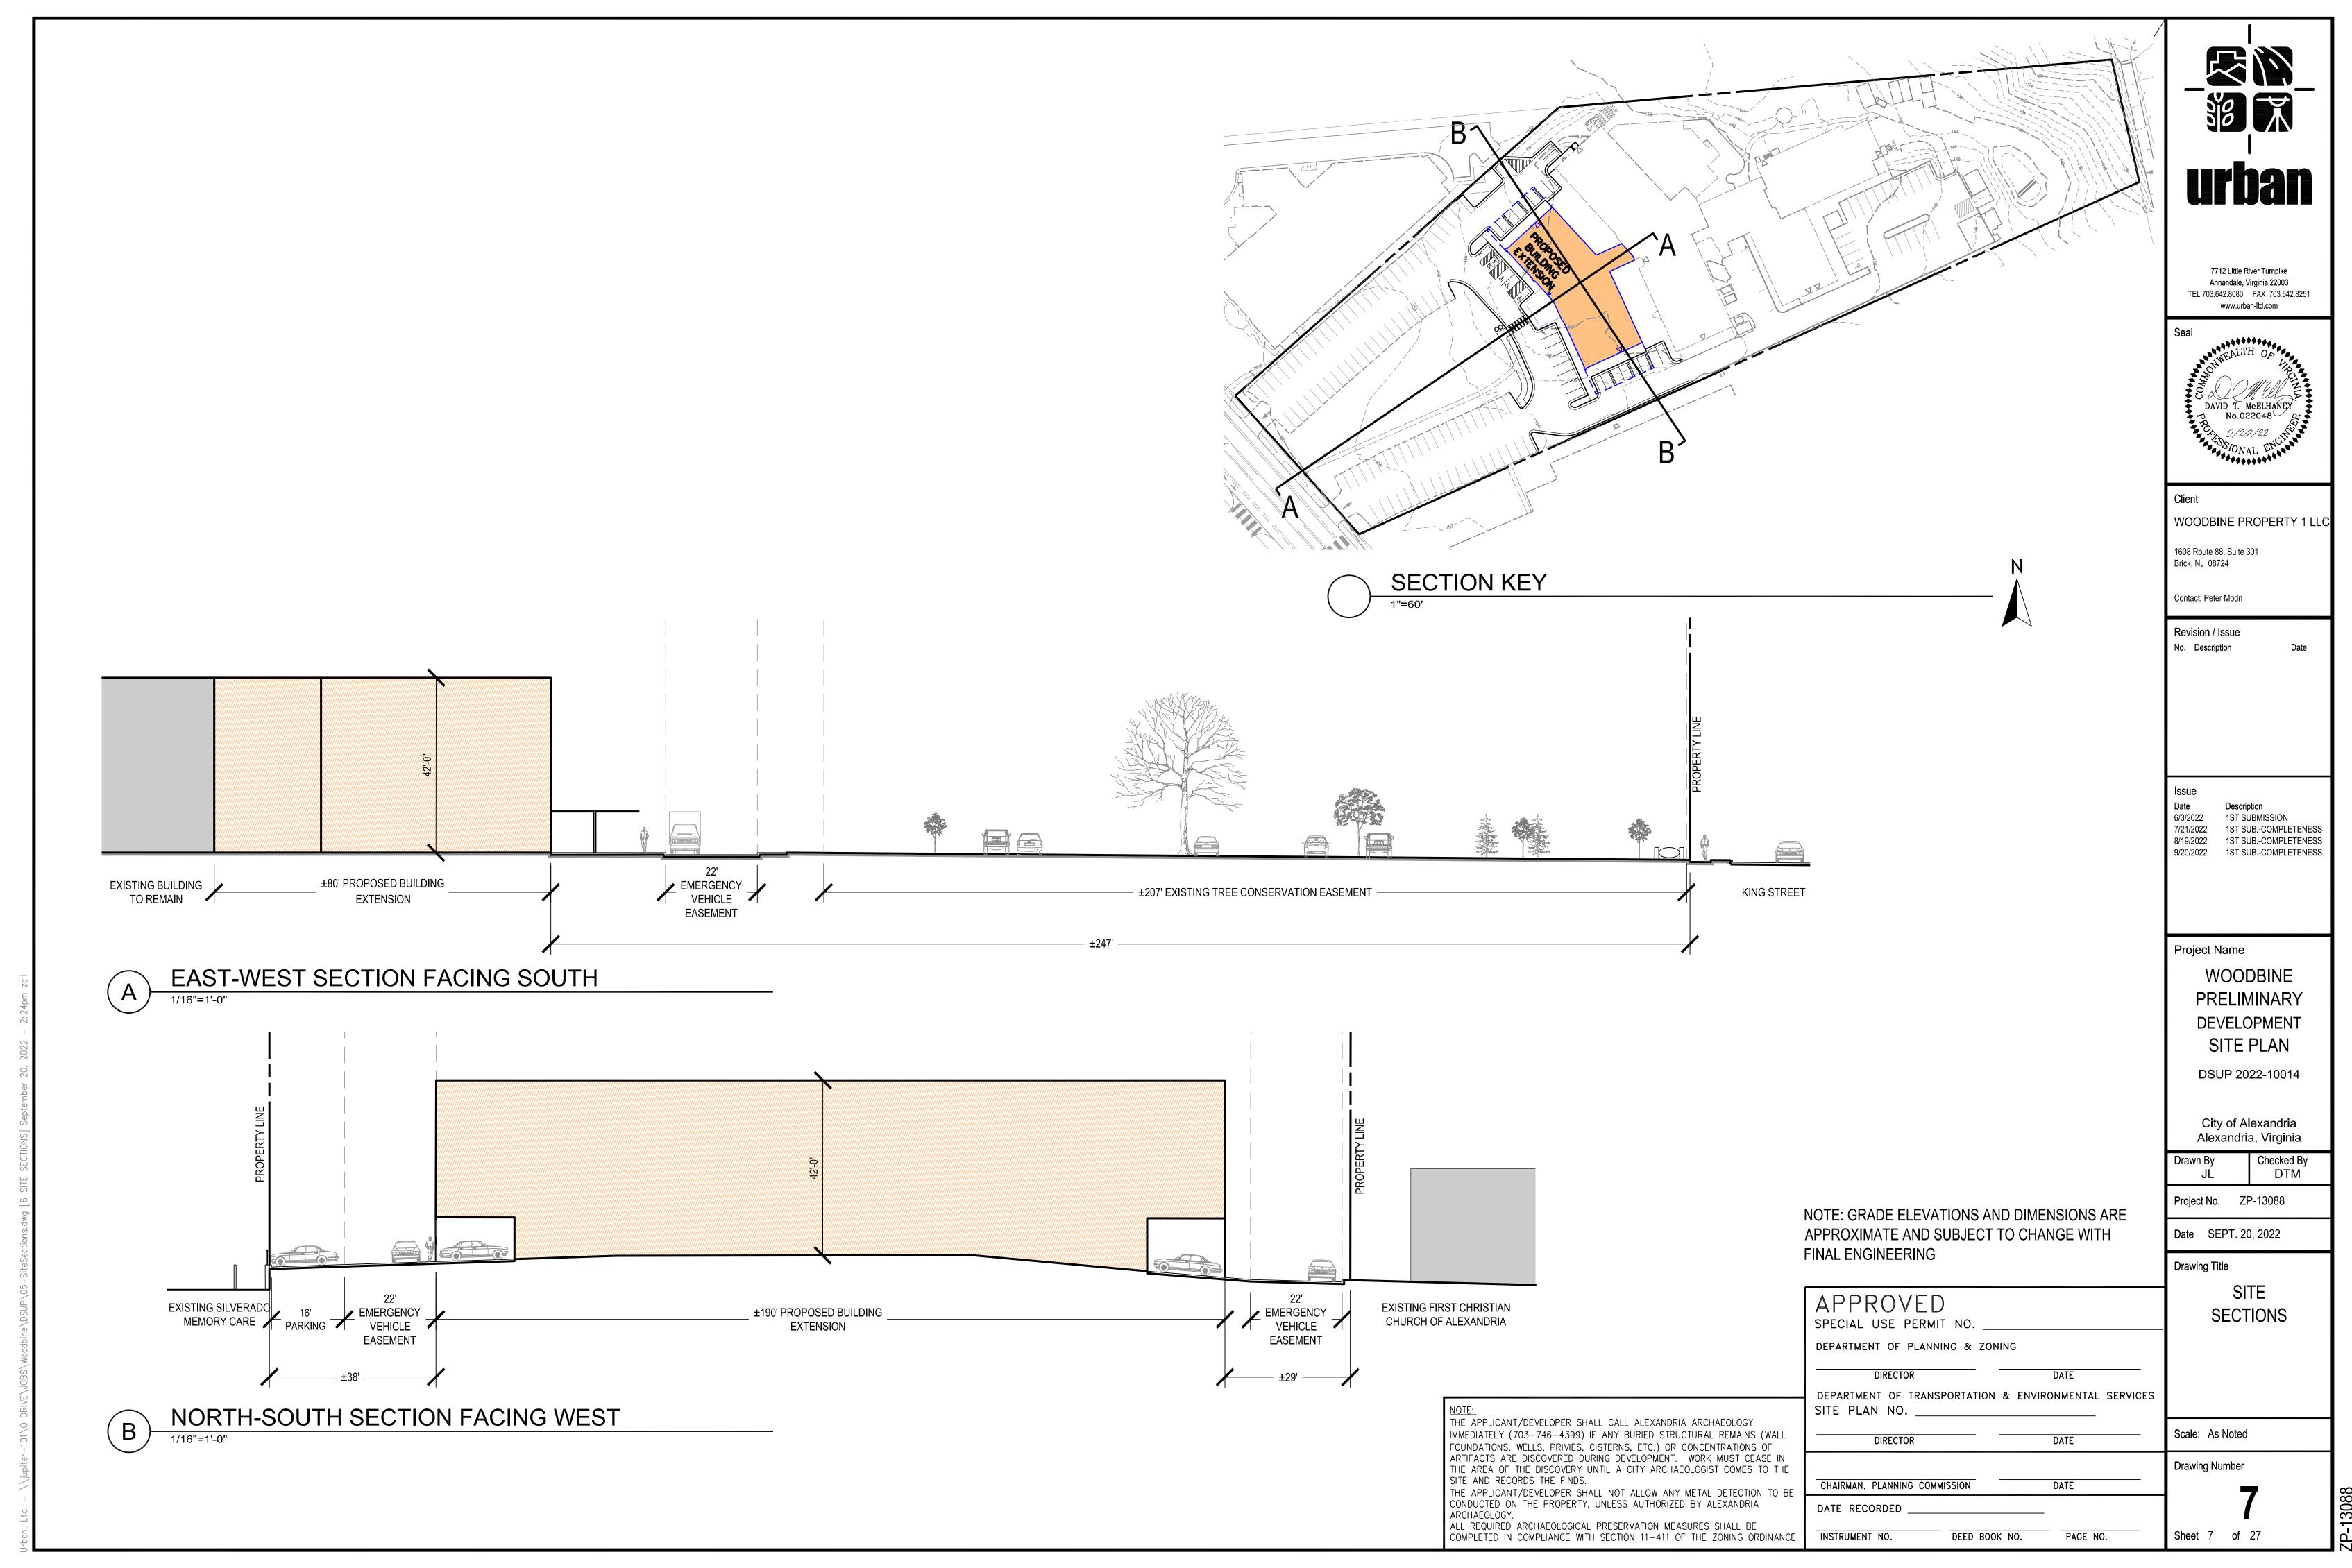



FRONT

RENDERINGS PREPARED BY



P.O. Box 727, 5 South Main Street Bel Air Maryland 21014

5 0 5 10 15 20

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ALL REQUIRED ARCHAEOLOGICAL PRESERVATION MEASURES SHALL BE INSTRUMENT NO. COMPLETED IN COMPLIANCE WITH SECTION 11-411 OF THE ZONING ORDINANCE


NOTE: GRADE ELEVATIONS ARE APPROXIMATE AND SUBJECT TO CHANGE WITH FINAL ENGINEERING

APPROVED SPECIAL USE PERMIT NO	
DEPARTMENT OF PLANNING & ZONING	
DIRECTOR DATE	
DEPARTMENT OF TRANSPORTATION & ENVIRONMENTAL SERVICES SITE PLAN NO	
DIRECTOR DATE	Sca
	Dra
CHAIRMAN, PLANNING COMMISSION DATE	
DATE RECORDED	

DEED BOOK NO.

PAGE NO.

7712 Little River Turnpike Annandale, Virginia 22003 TEL 703.642.8080 FAX 703.642.8251 www.urban-ltd.com

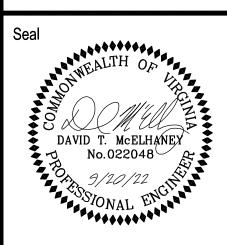

WOODBINE PROPERTY 1 LLC

1608 Route 88, Suite 301

Brick, NJ 08724

Contact: Peter Modri

Revision / Issue

No. Description

6/3/2022 1ST SUBMISSION 7/21/2022 1ST SUB.-COMPLETENESS 8/19/2022 1ST SUB.-COMPLETENESS

9/20/2022 1ST SUB.-COMPLETENESS

Project Name

WOODBINE PRELIMINARY DEVELOPMENT SITE PLAN

DSUP 2022-10014

City of Alexandria Alexandria, Virginia

Checked By

DTM Project No. ZP-13088

Date SEPT. 20, 2022

Drawing Title


BUILDING **ELEVATION:** WEST


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Sheet 8 of 27





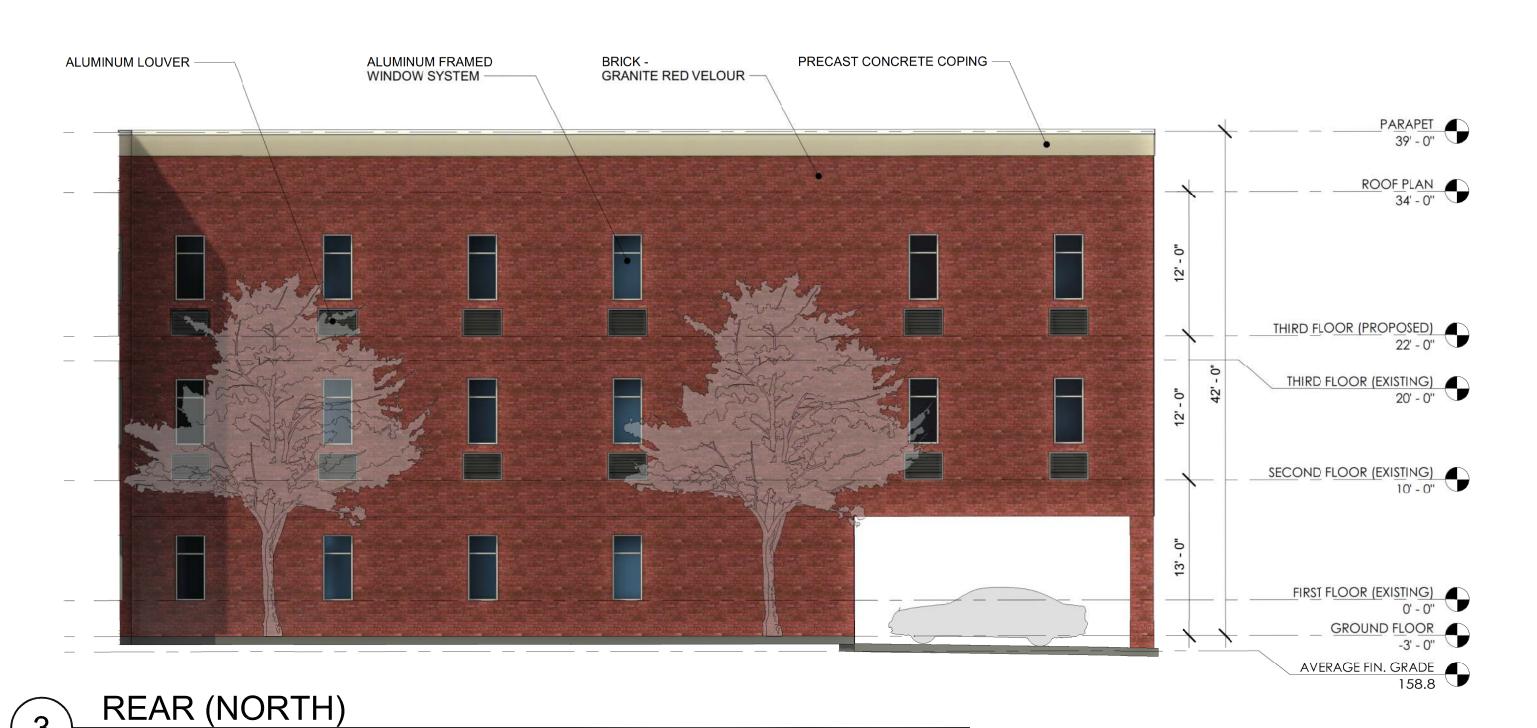

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SCALE
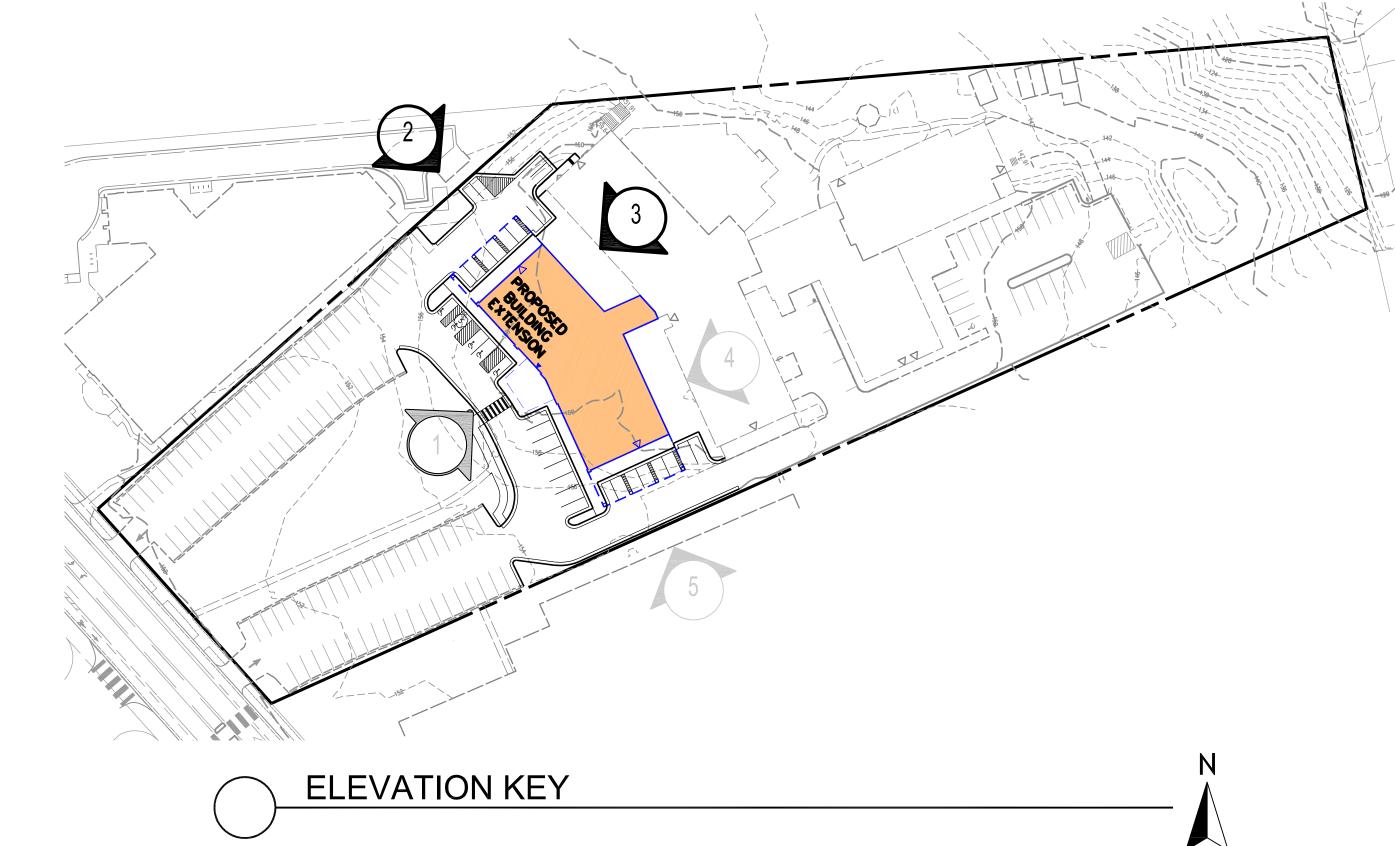
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DSUP 2022-10014

City of Alexandria Alexandria, Virginia

> Checked By DTM

Project No. ZP-13088

Date SEPT. 20, 2022


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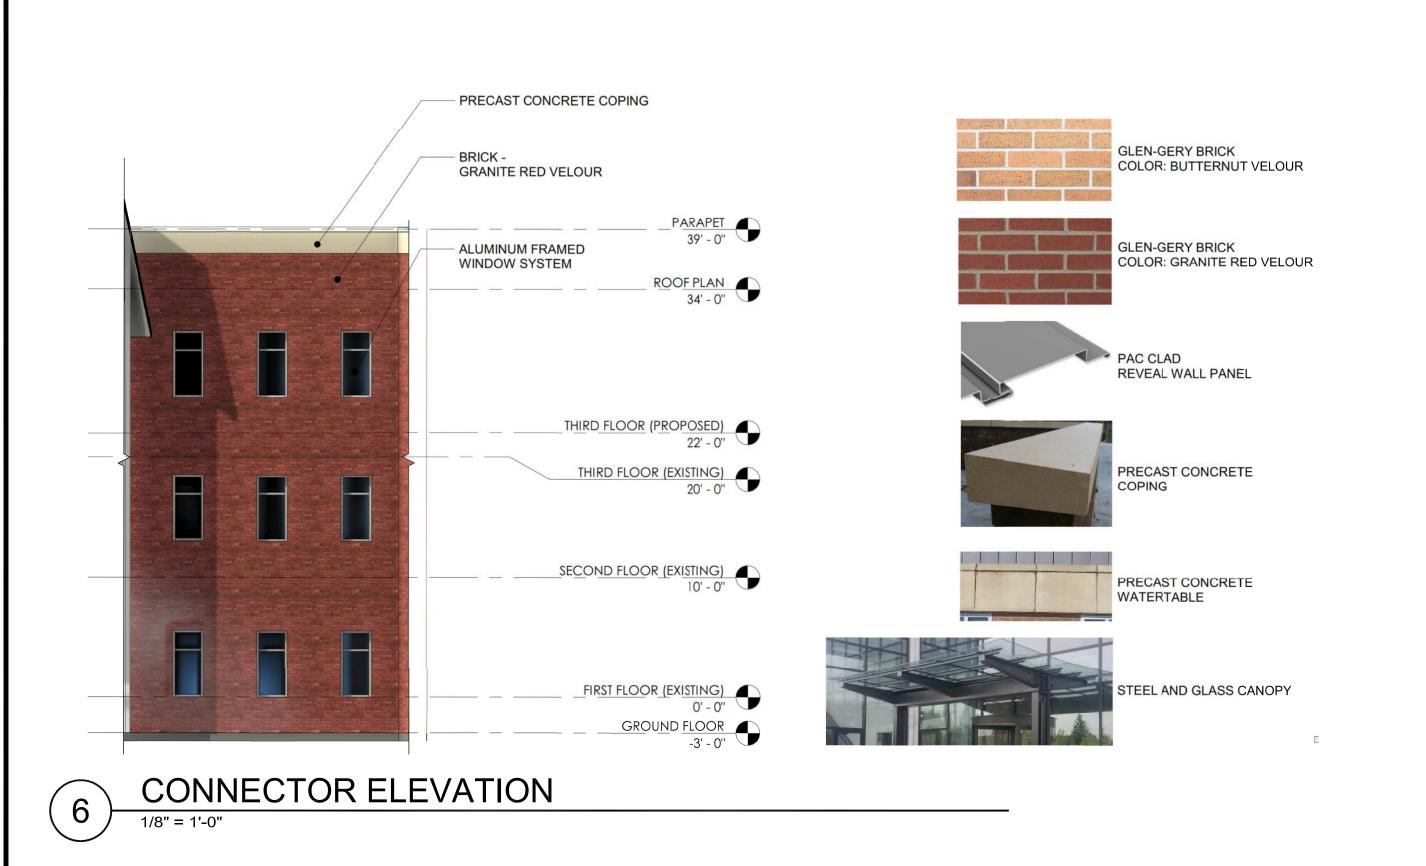
BUILDING **ELEVATION:** NORTH


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Sheet 9 of 27





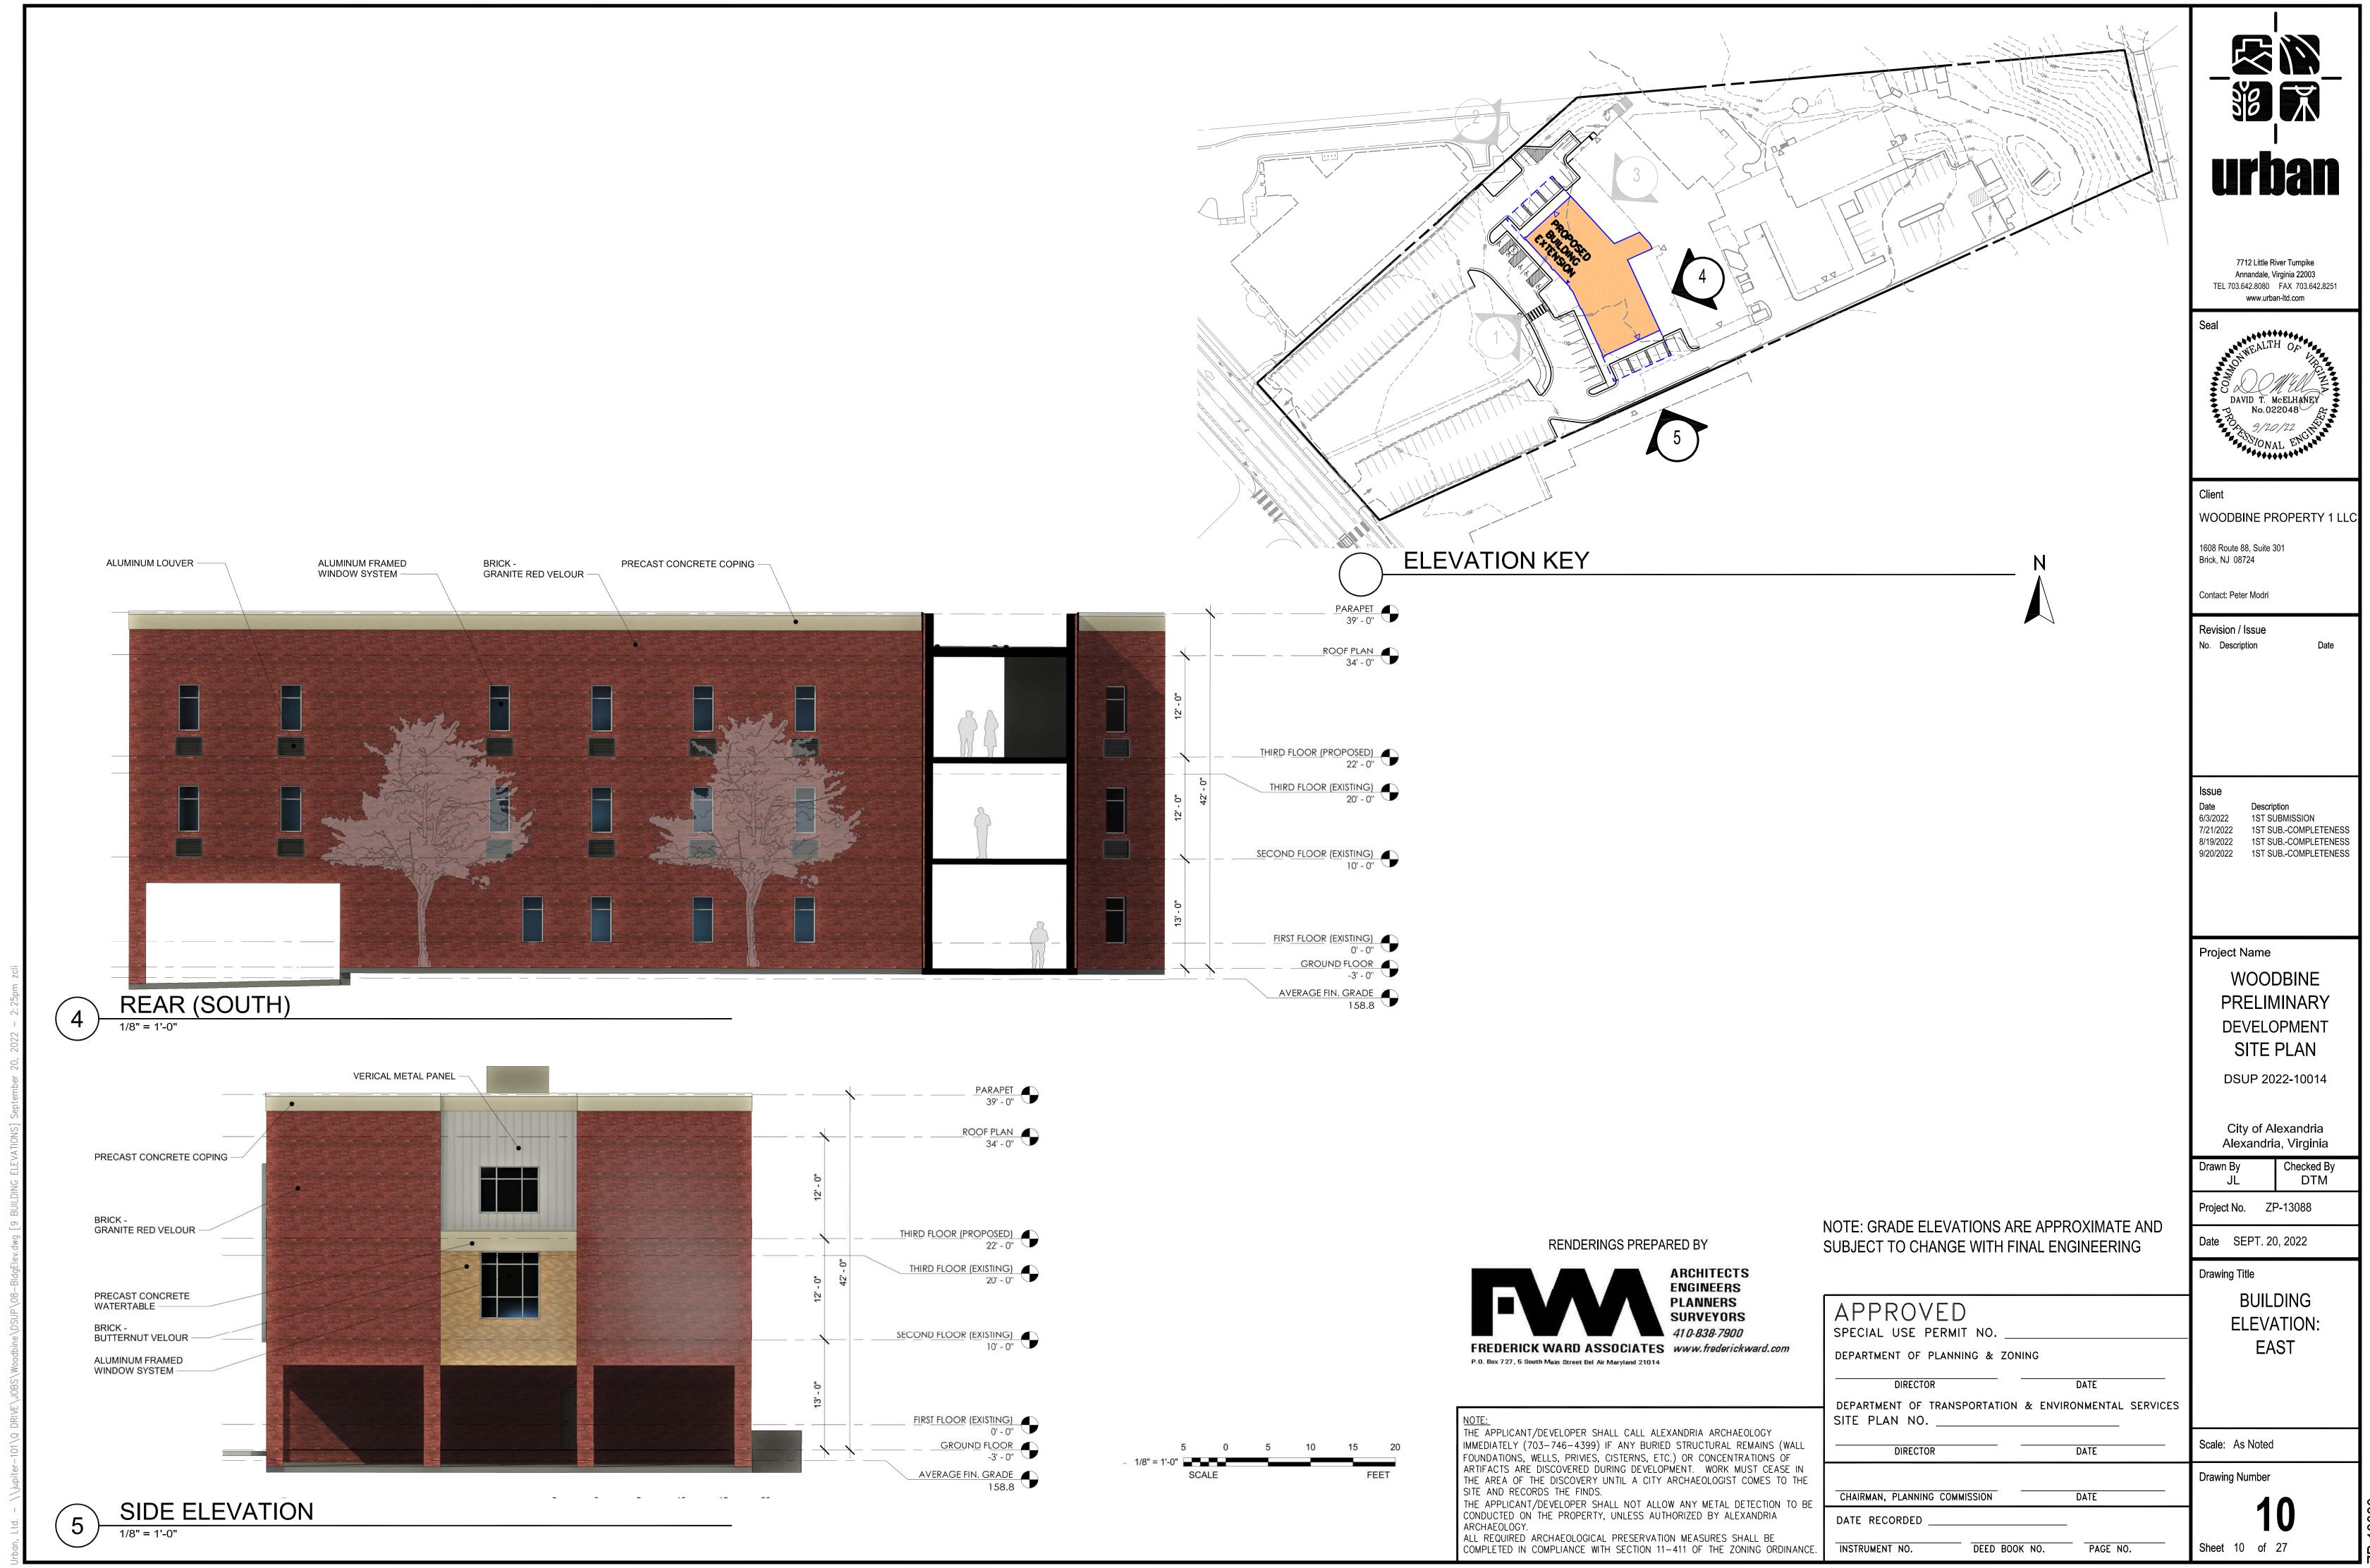

5 0 5 10 15 20 SCALE

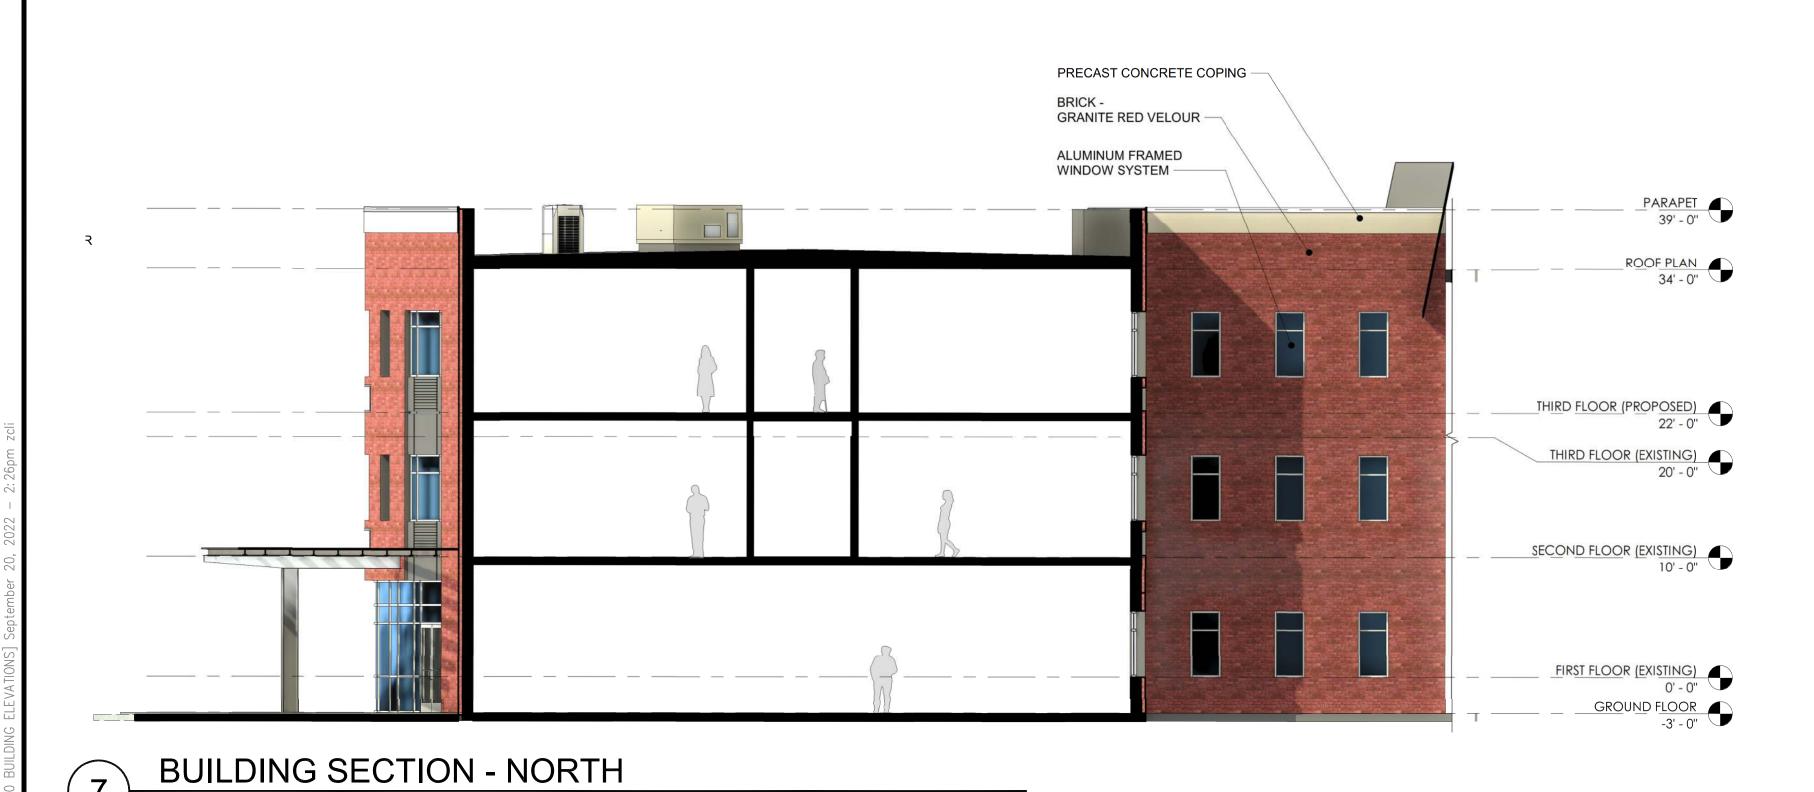



PLANNERS SURVEYORS FREDERICK WARD ASSOCIATES www.frederickward.com P.O. Box 727, 5 South Main Street Bel Air Maryland 21014

ELEVATION KEY

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COMPLETED IN COMPLIANCE WITH SECTION 11-411 OF THE ZONING ORDINANCE

NOTE: GRADE ELEVATIONS ARE APPROXIMATE AND

	Drawing Title
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DIRECTOR DATE	Scale: As No

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Sheet 11 of 27

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WOODBINE PROPERTY 1 LLC

6/3/2022 1ST SUBMISSION 7/21/2022 1ST SUB.-COMPLETENESS 8/19/2022 1ST SUB.-COMPLETENESS

9/20/2022 1ST SUB.-COMPLETENESS

WOODBINE

PRELIMINARY

DEVELOPMENT

SITE PLAN

DSUP 2022-10014

City of Alexandria Alexandria, Virginia

Project No. ZP-13088

Date SEPT. 20, 2022

BUILDING

ELEVATION:

SOUTH

Checked By DTM

Project Name

1608 Route 88, Suite 301

Brick, NJ 08724

Contact: Peter Modri

Revision / Issue No. Description

Client

ARCHITECTS

DATE RECORDED


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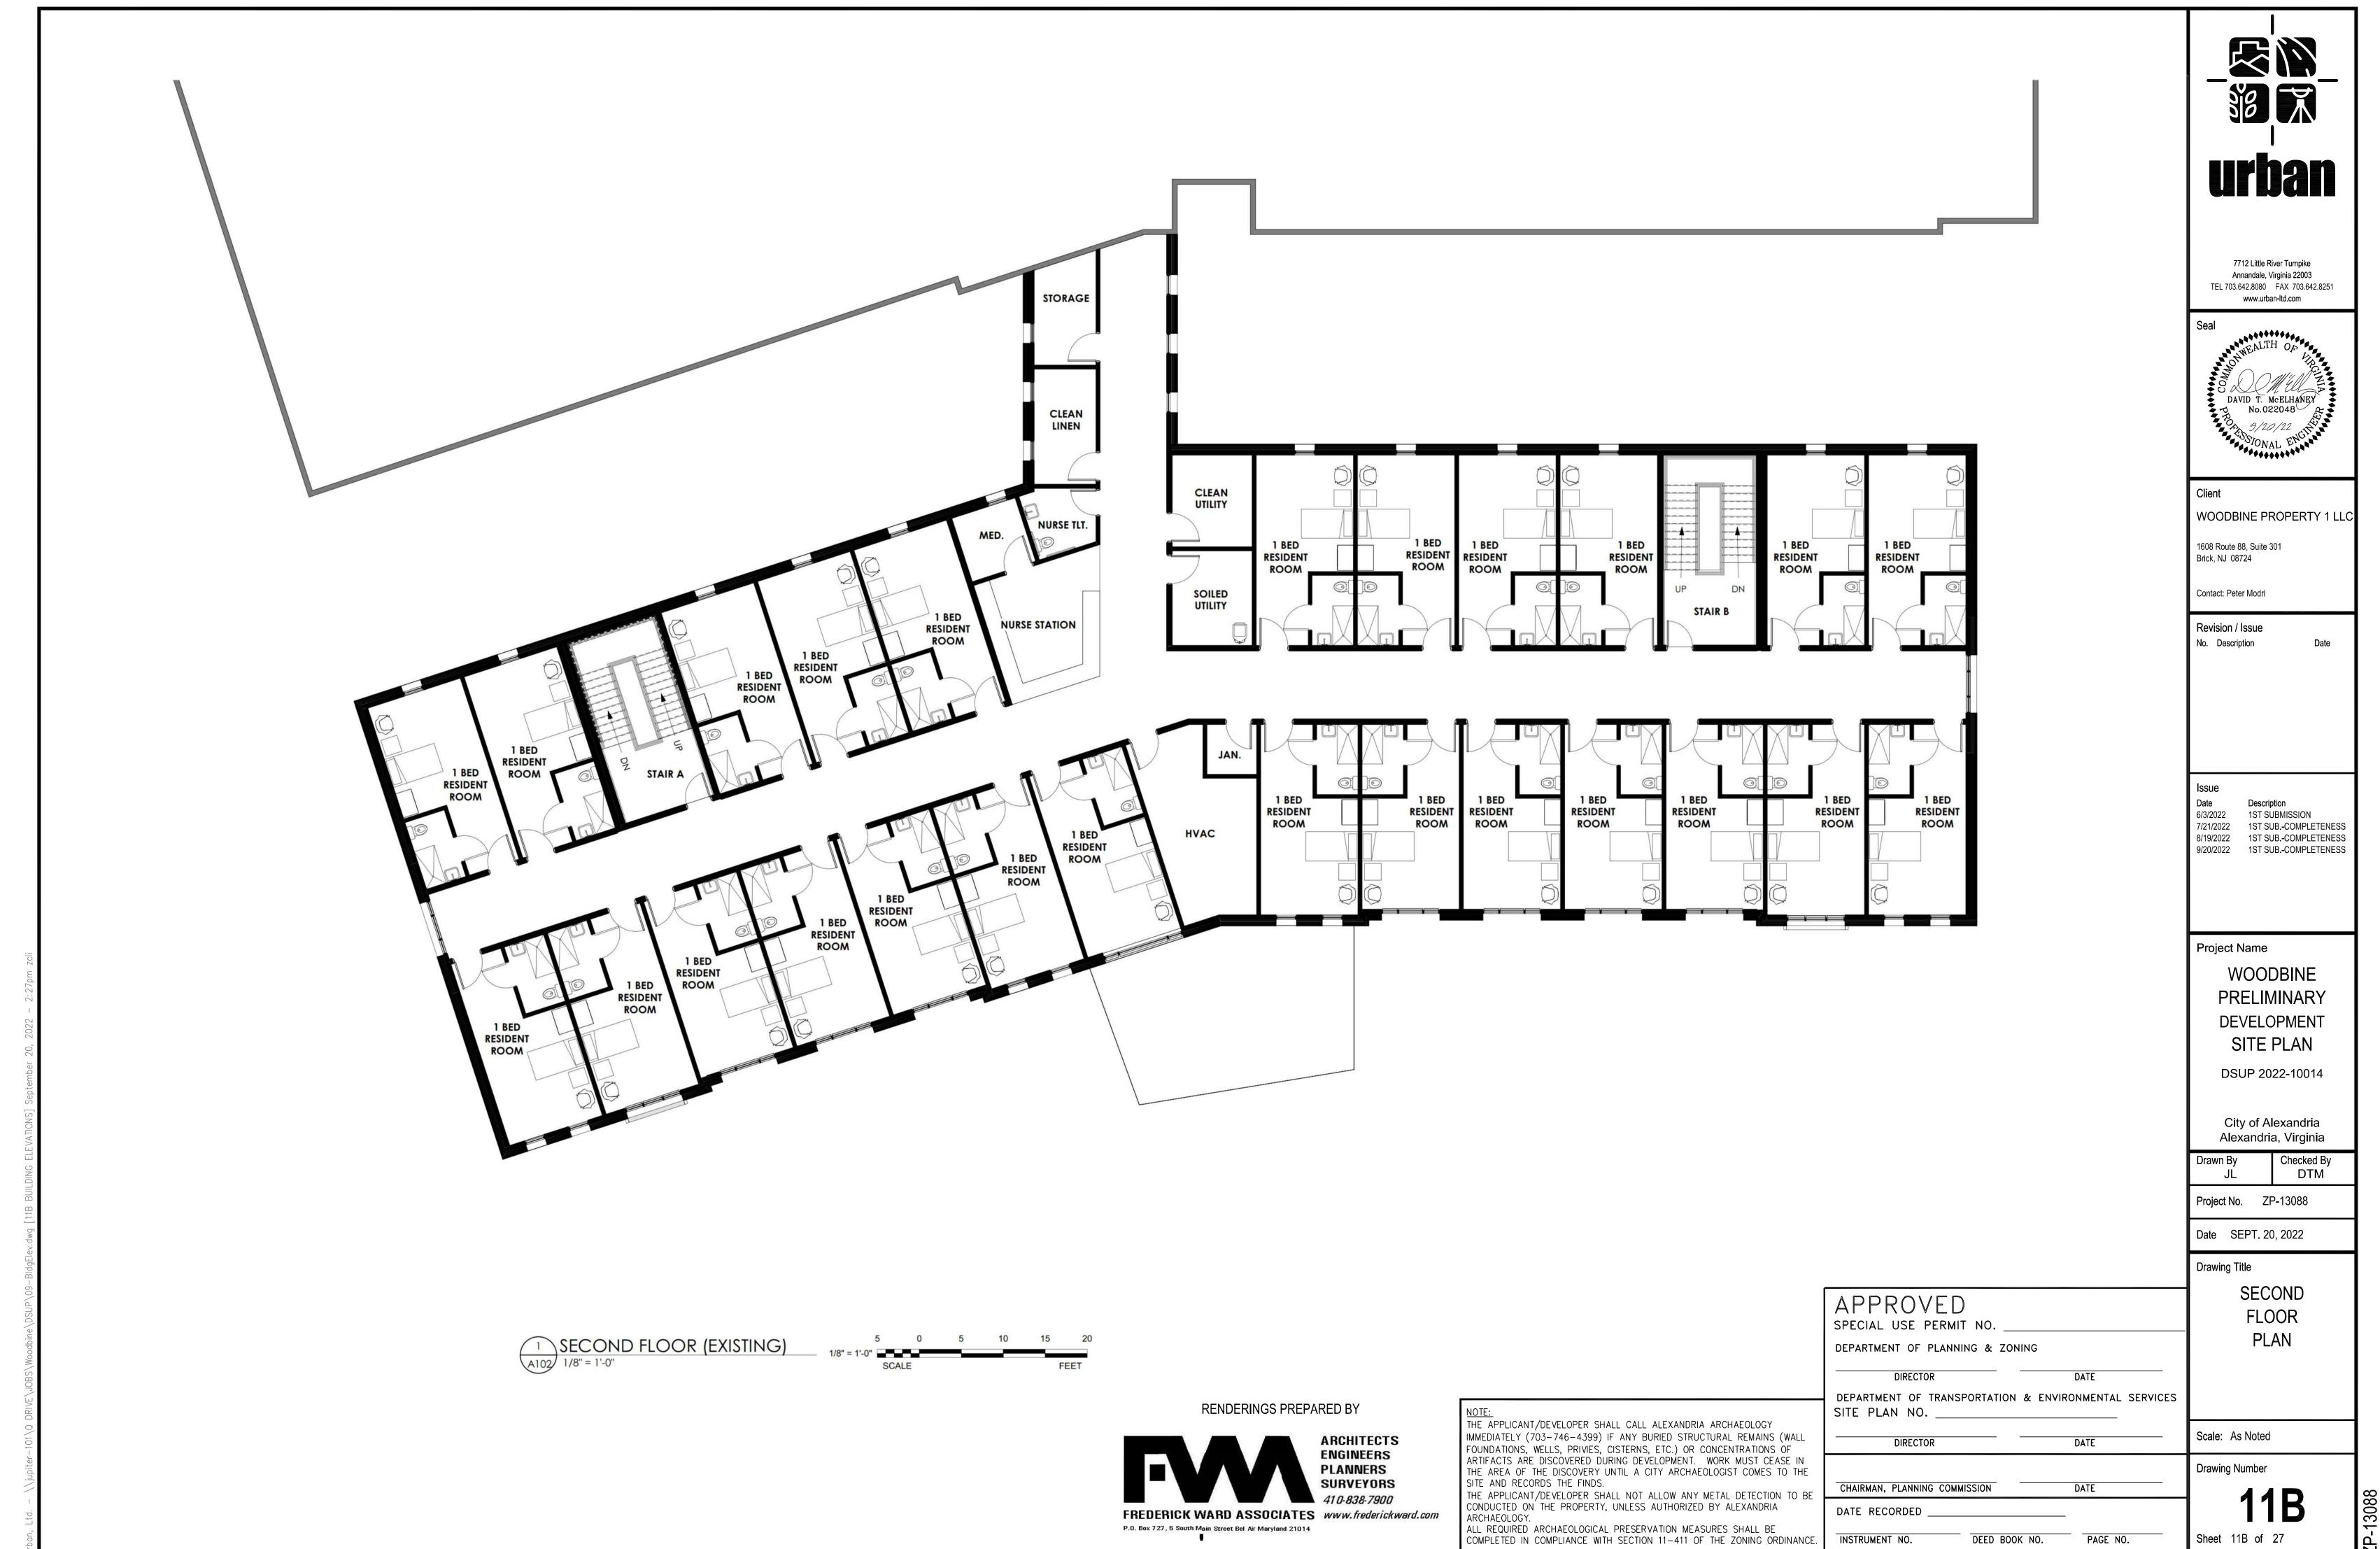
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APPROVED SPECIAL USE PERMIT NO.	
DEPARTMENT OF PLANNING & ZONING	
DIRECTOR	DATE


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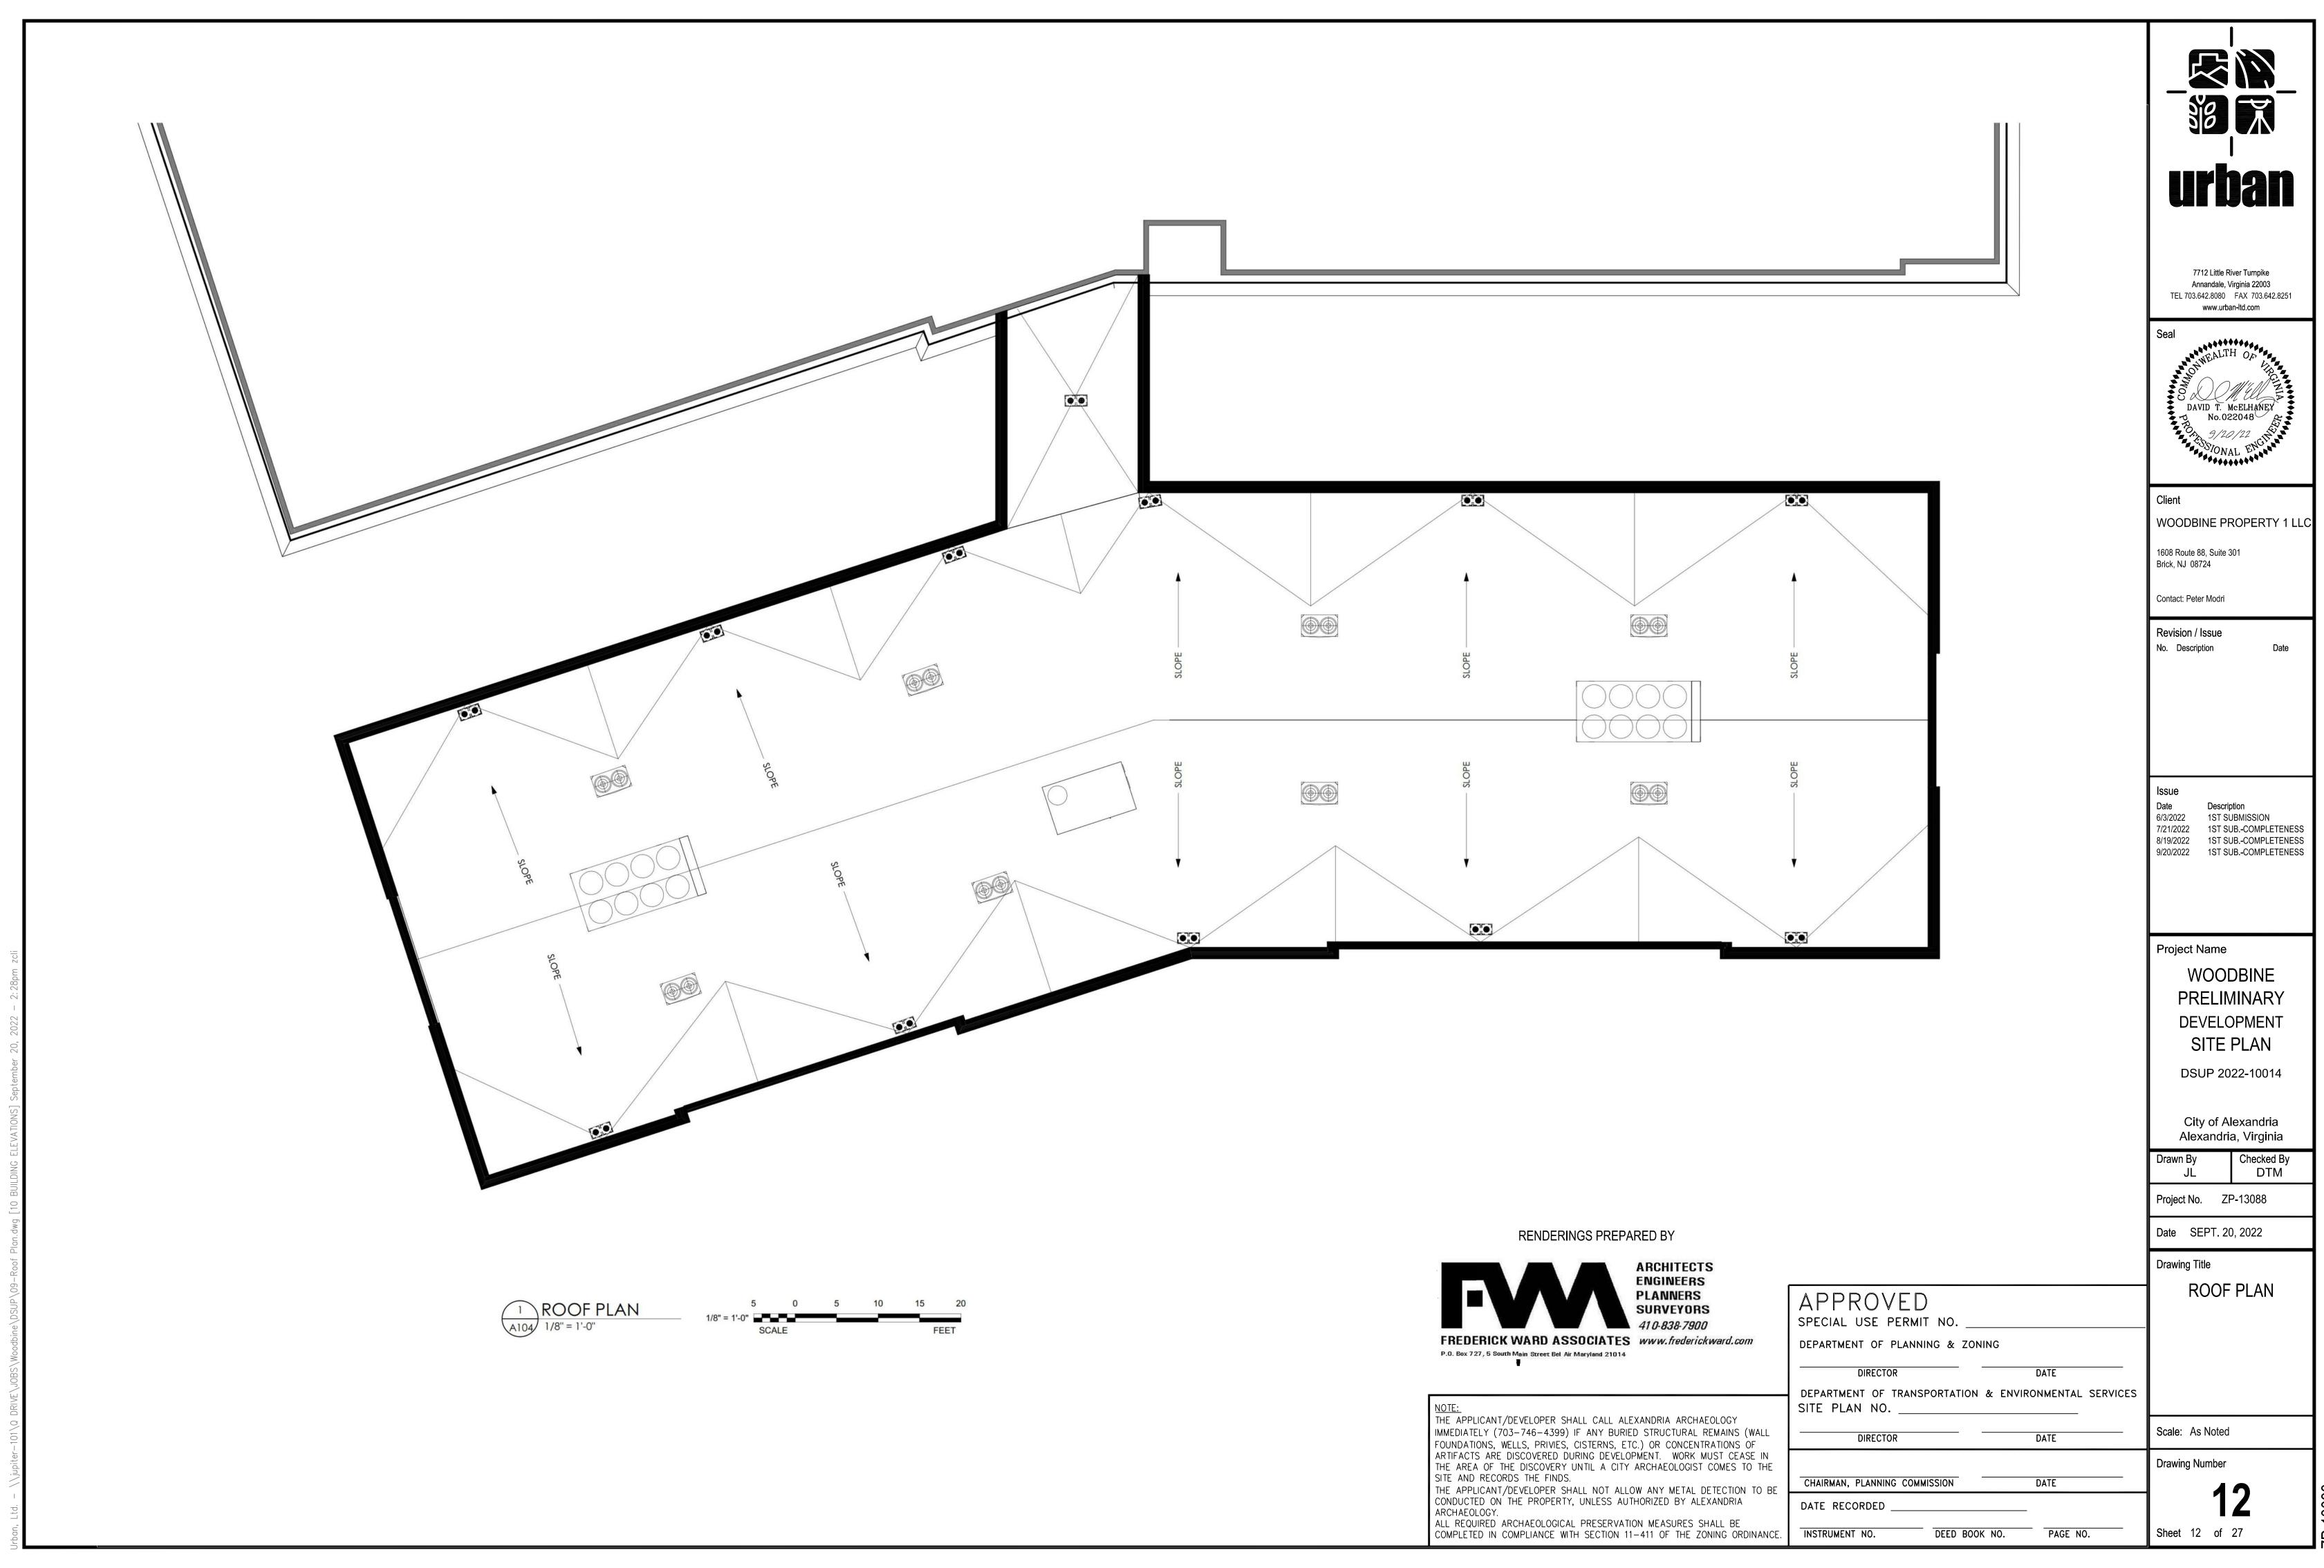
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CHAIRMAN, PLANNING COMMISSION	DATE	


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SOUTH BUILDING NORTH BUILDING SECOND FLOOR KEY PLAN

THE APPLICANT/DEVELOPER SHALL CALL ALEXANDRIA ARCHAEOLOGY

SITE AND RECORDS THE FINDS.

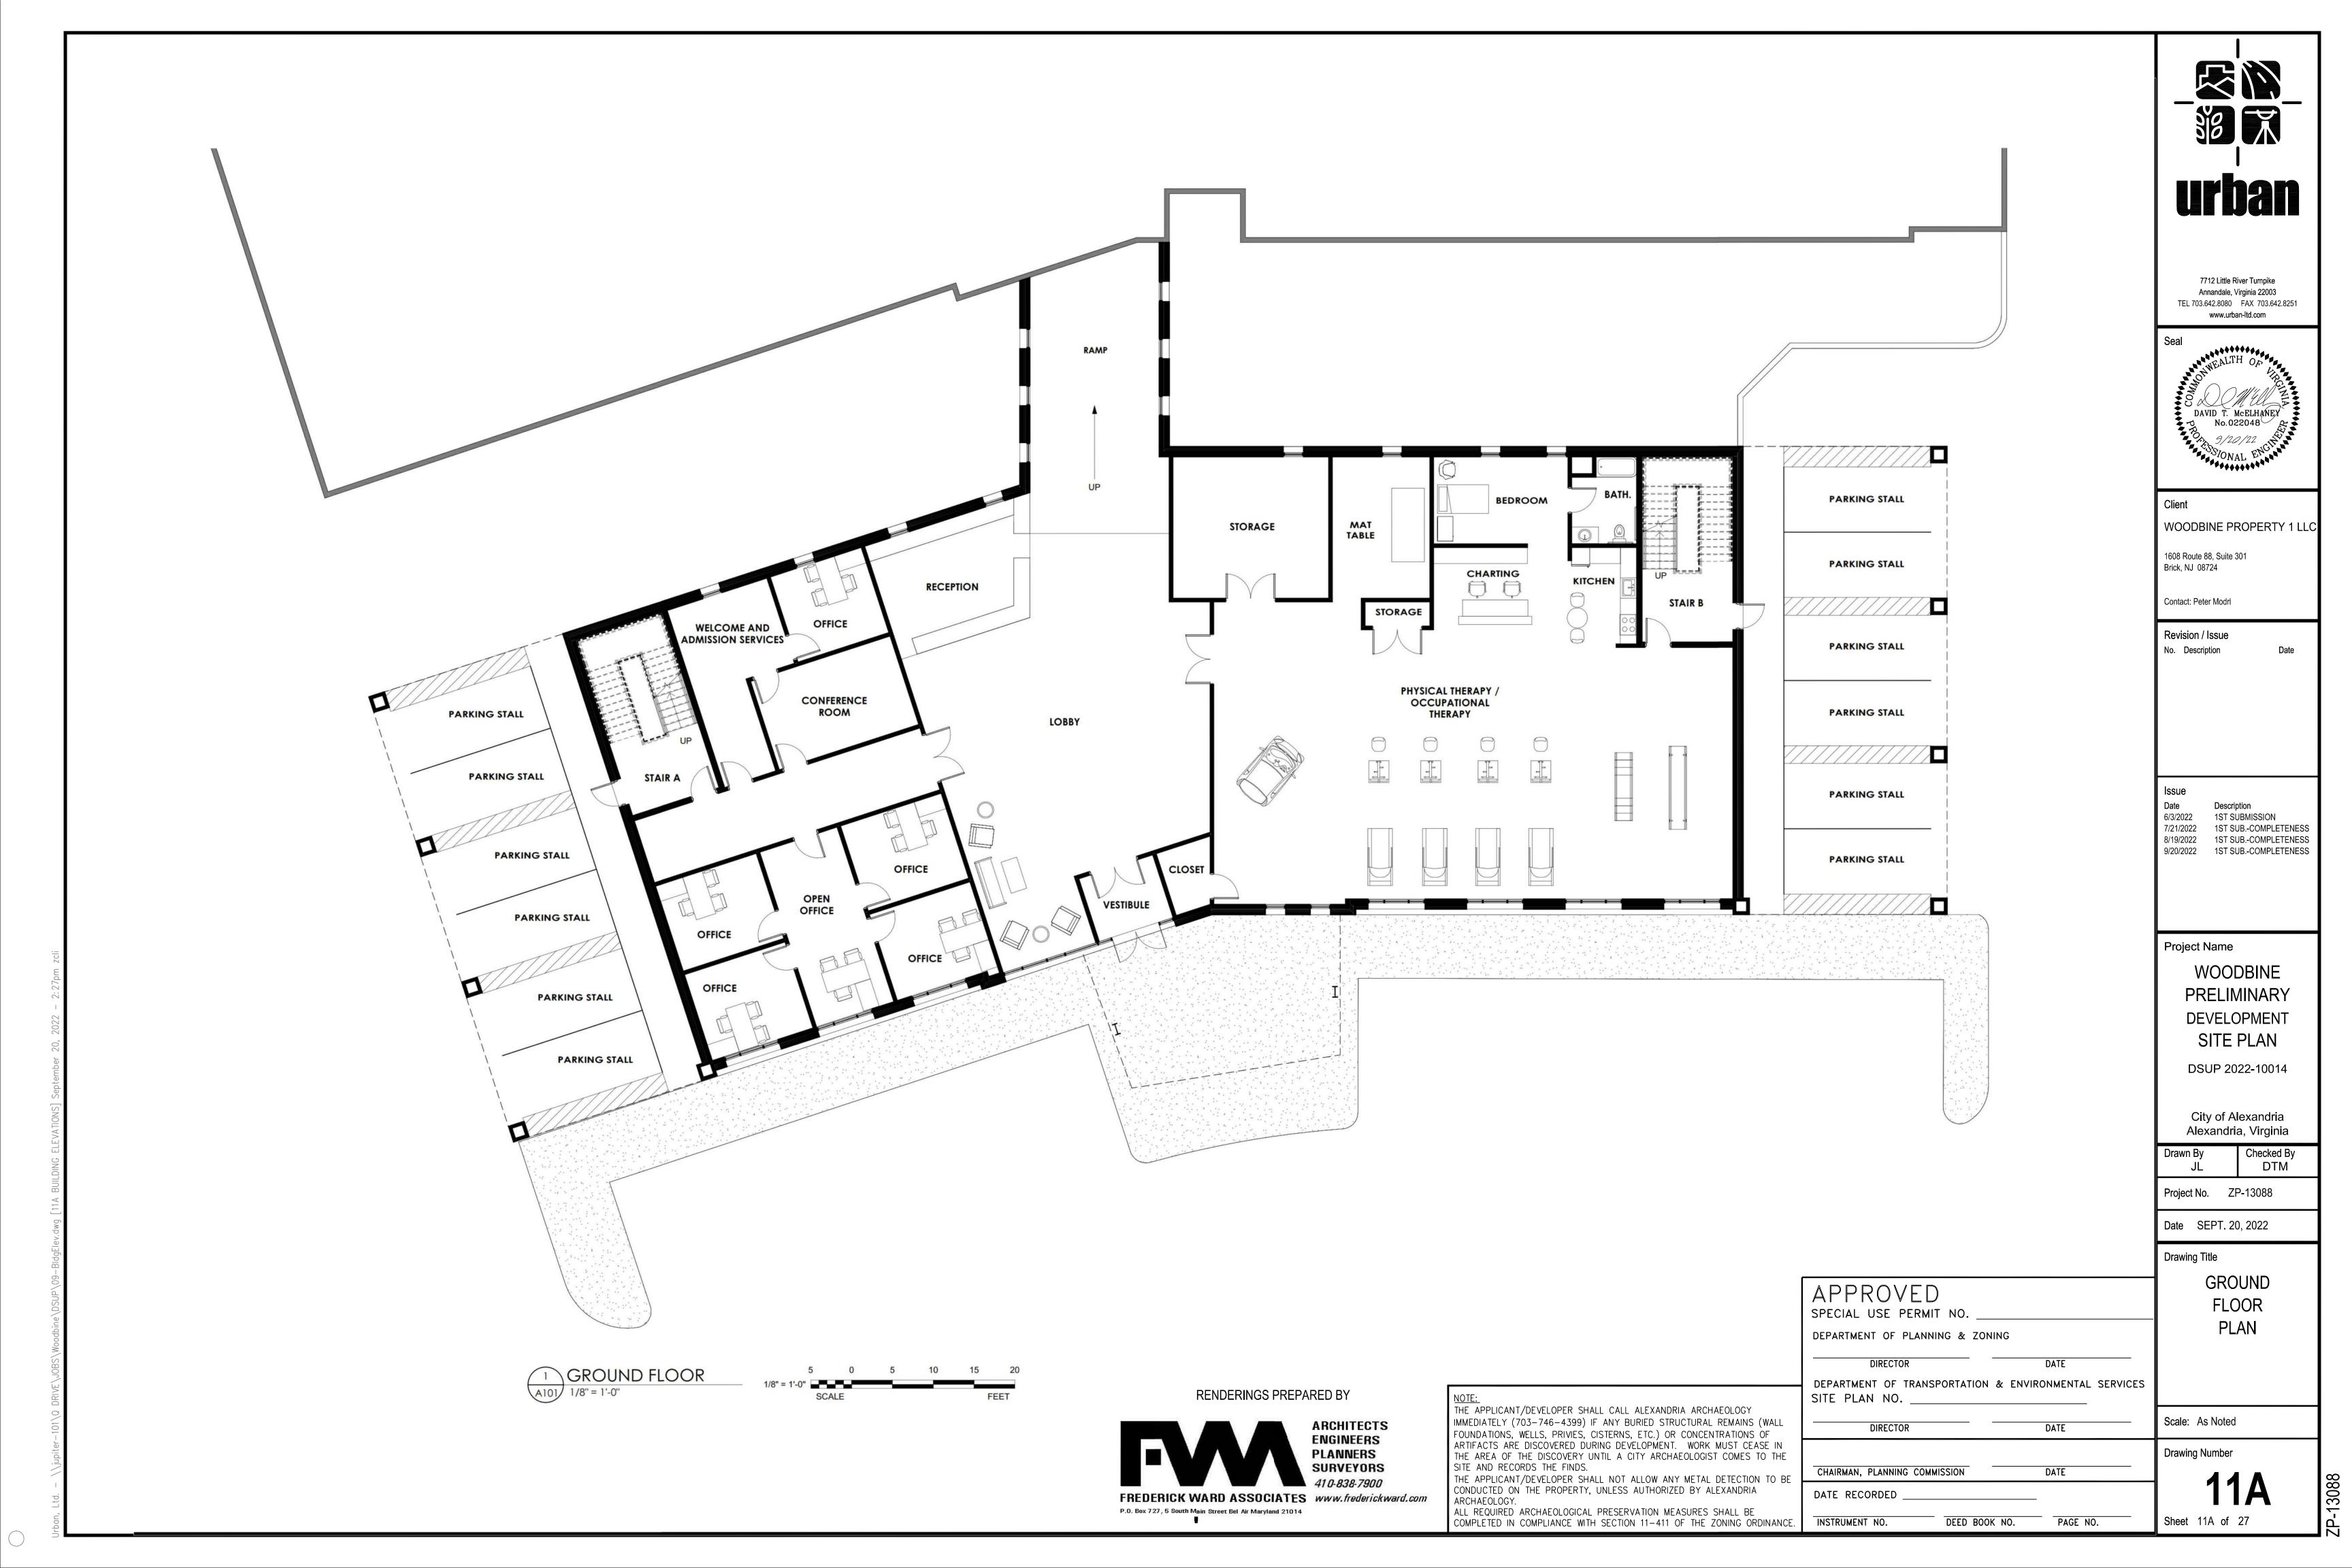ARCHAEOLOGY.

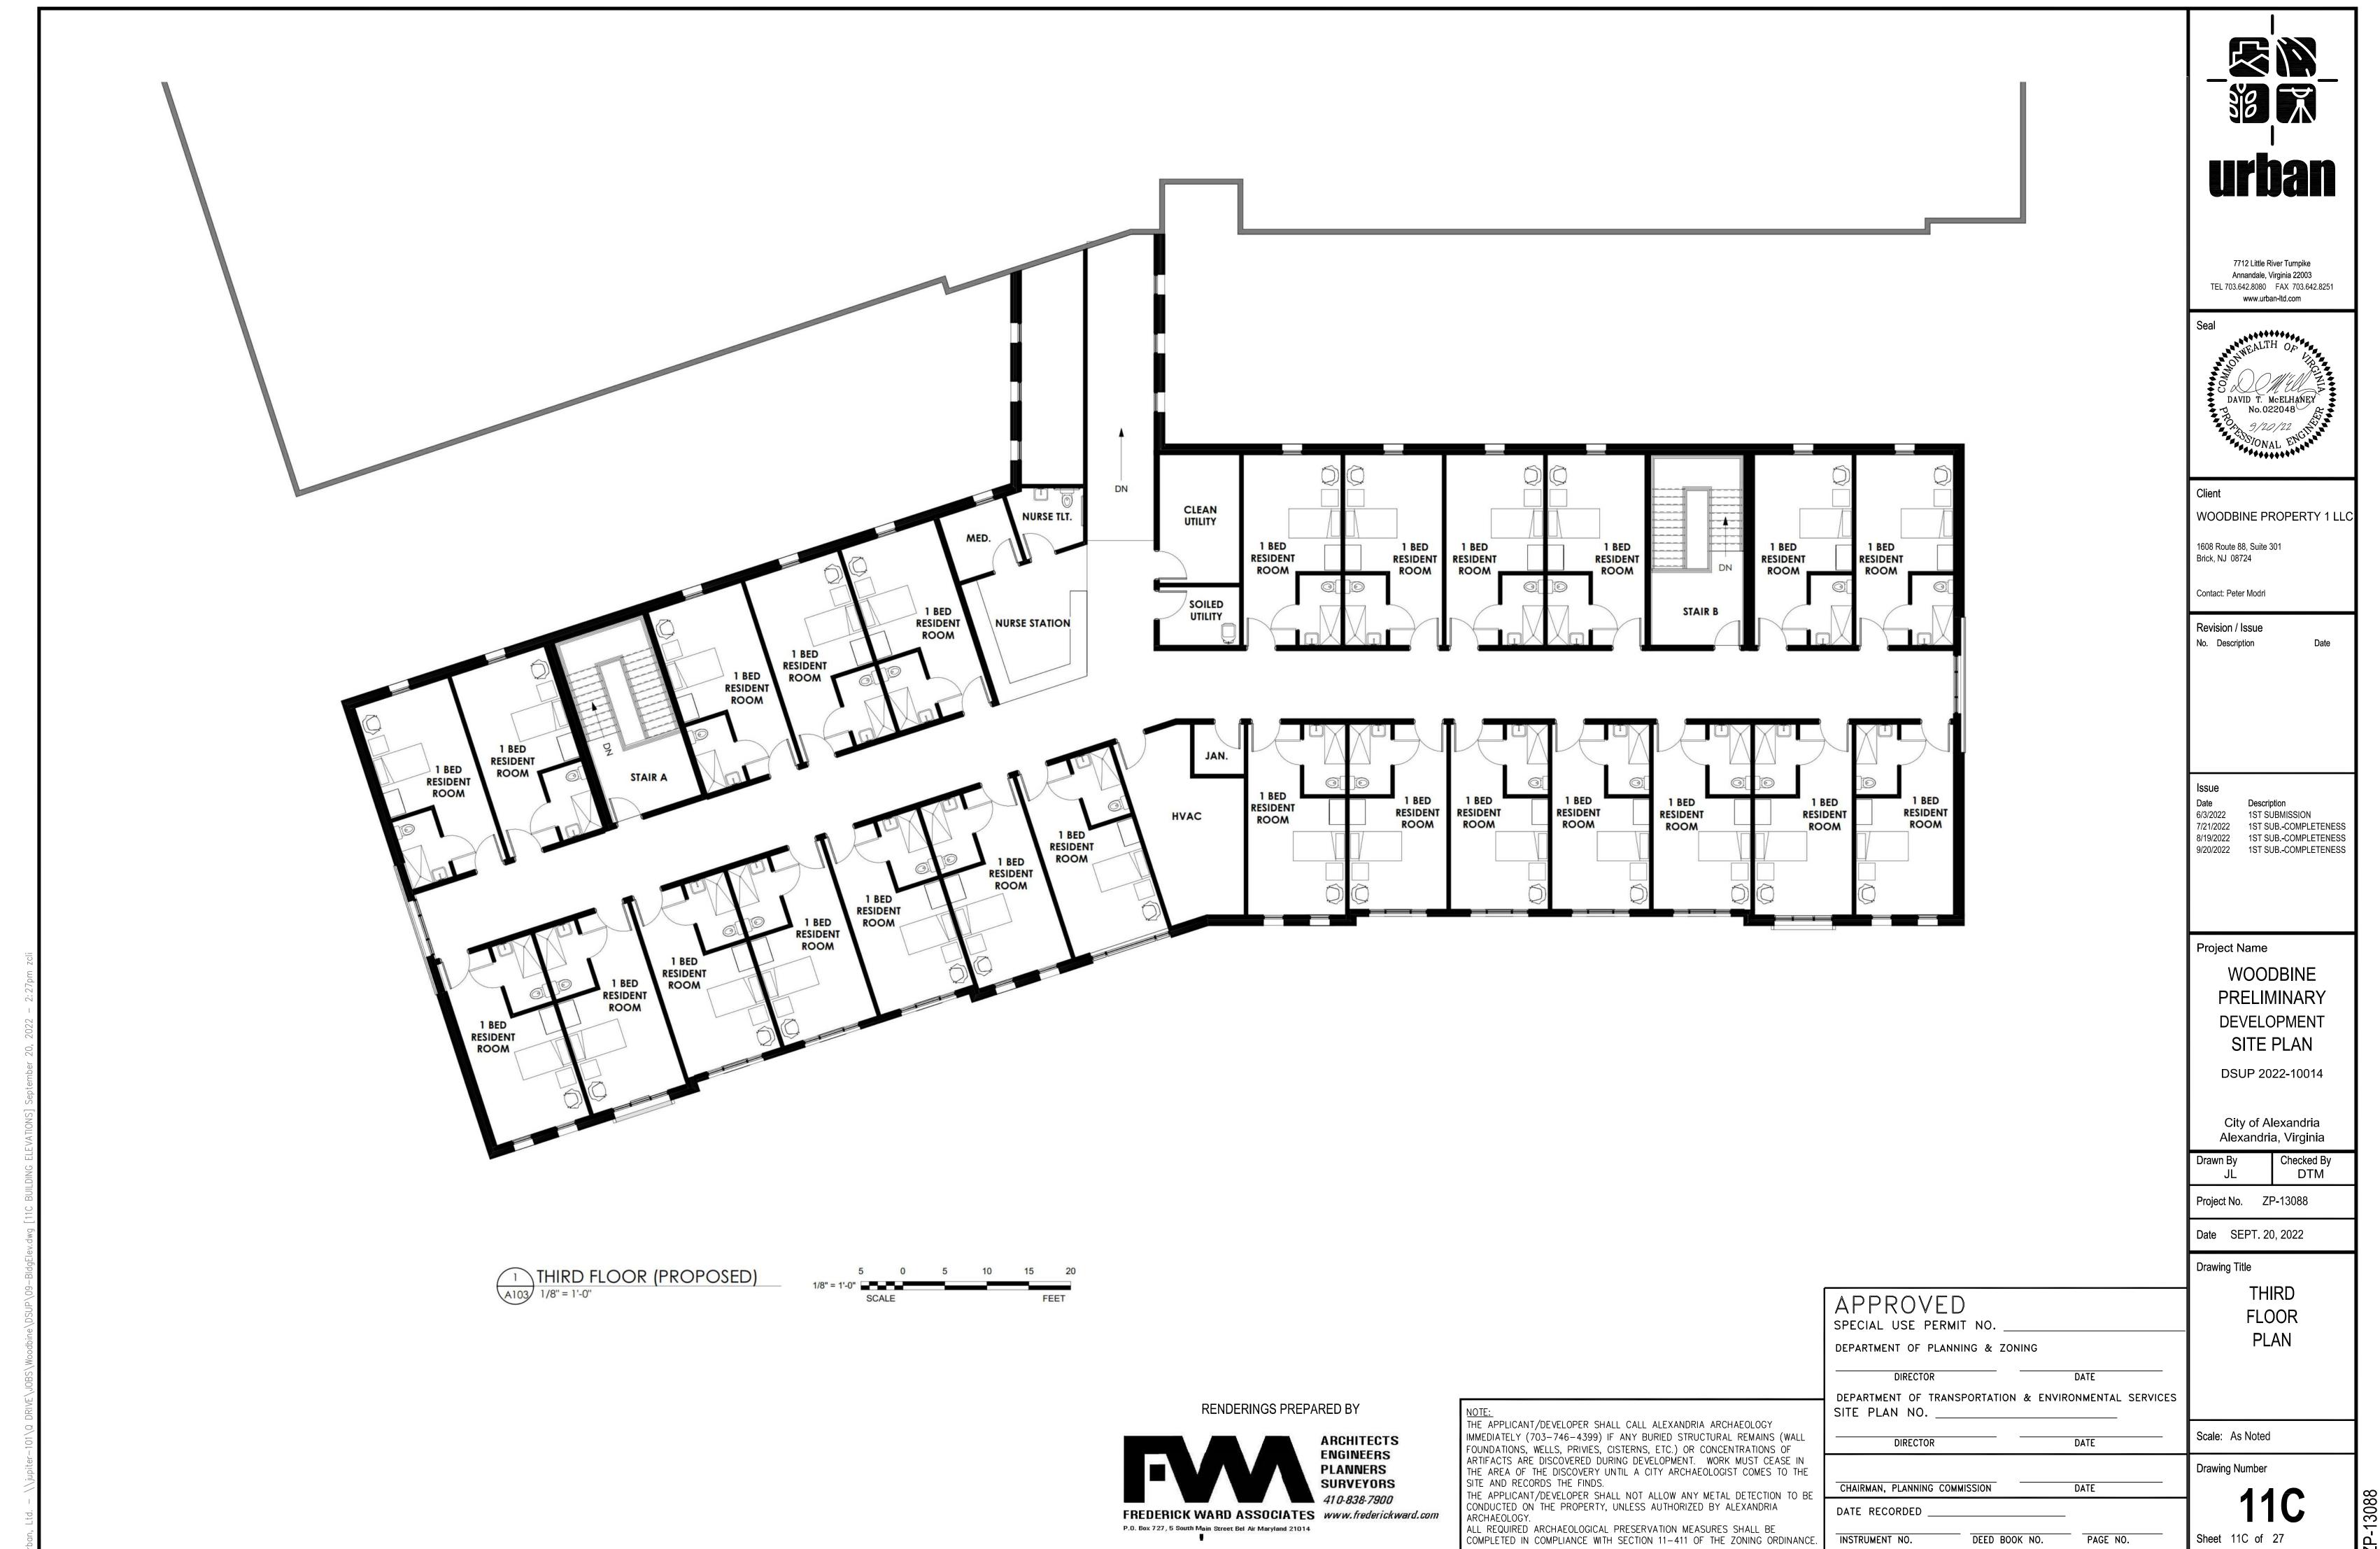IMMEDIATELY (703-746-4399) IF ANY BURIED STRUCTURAL REMAINS (WALL

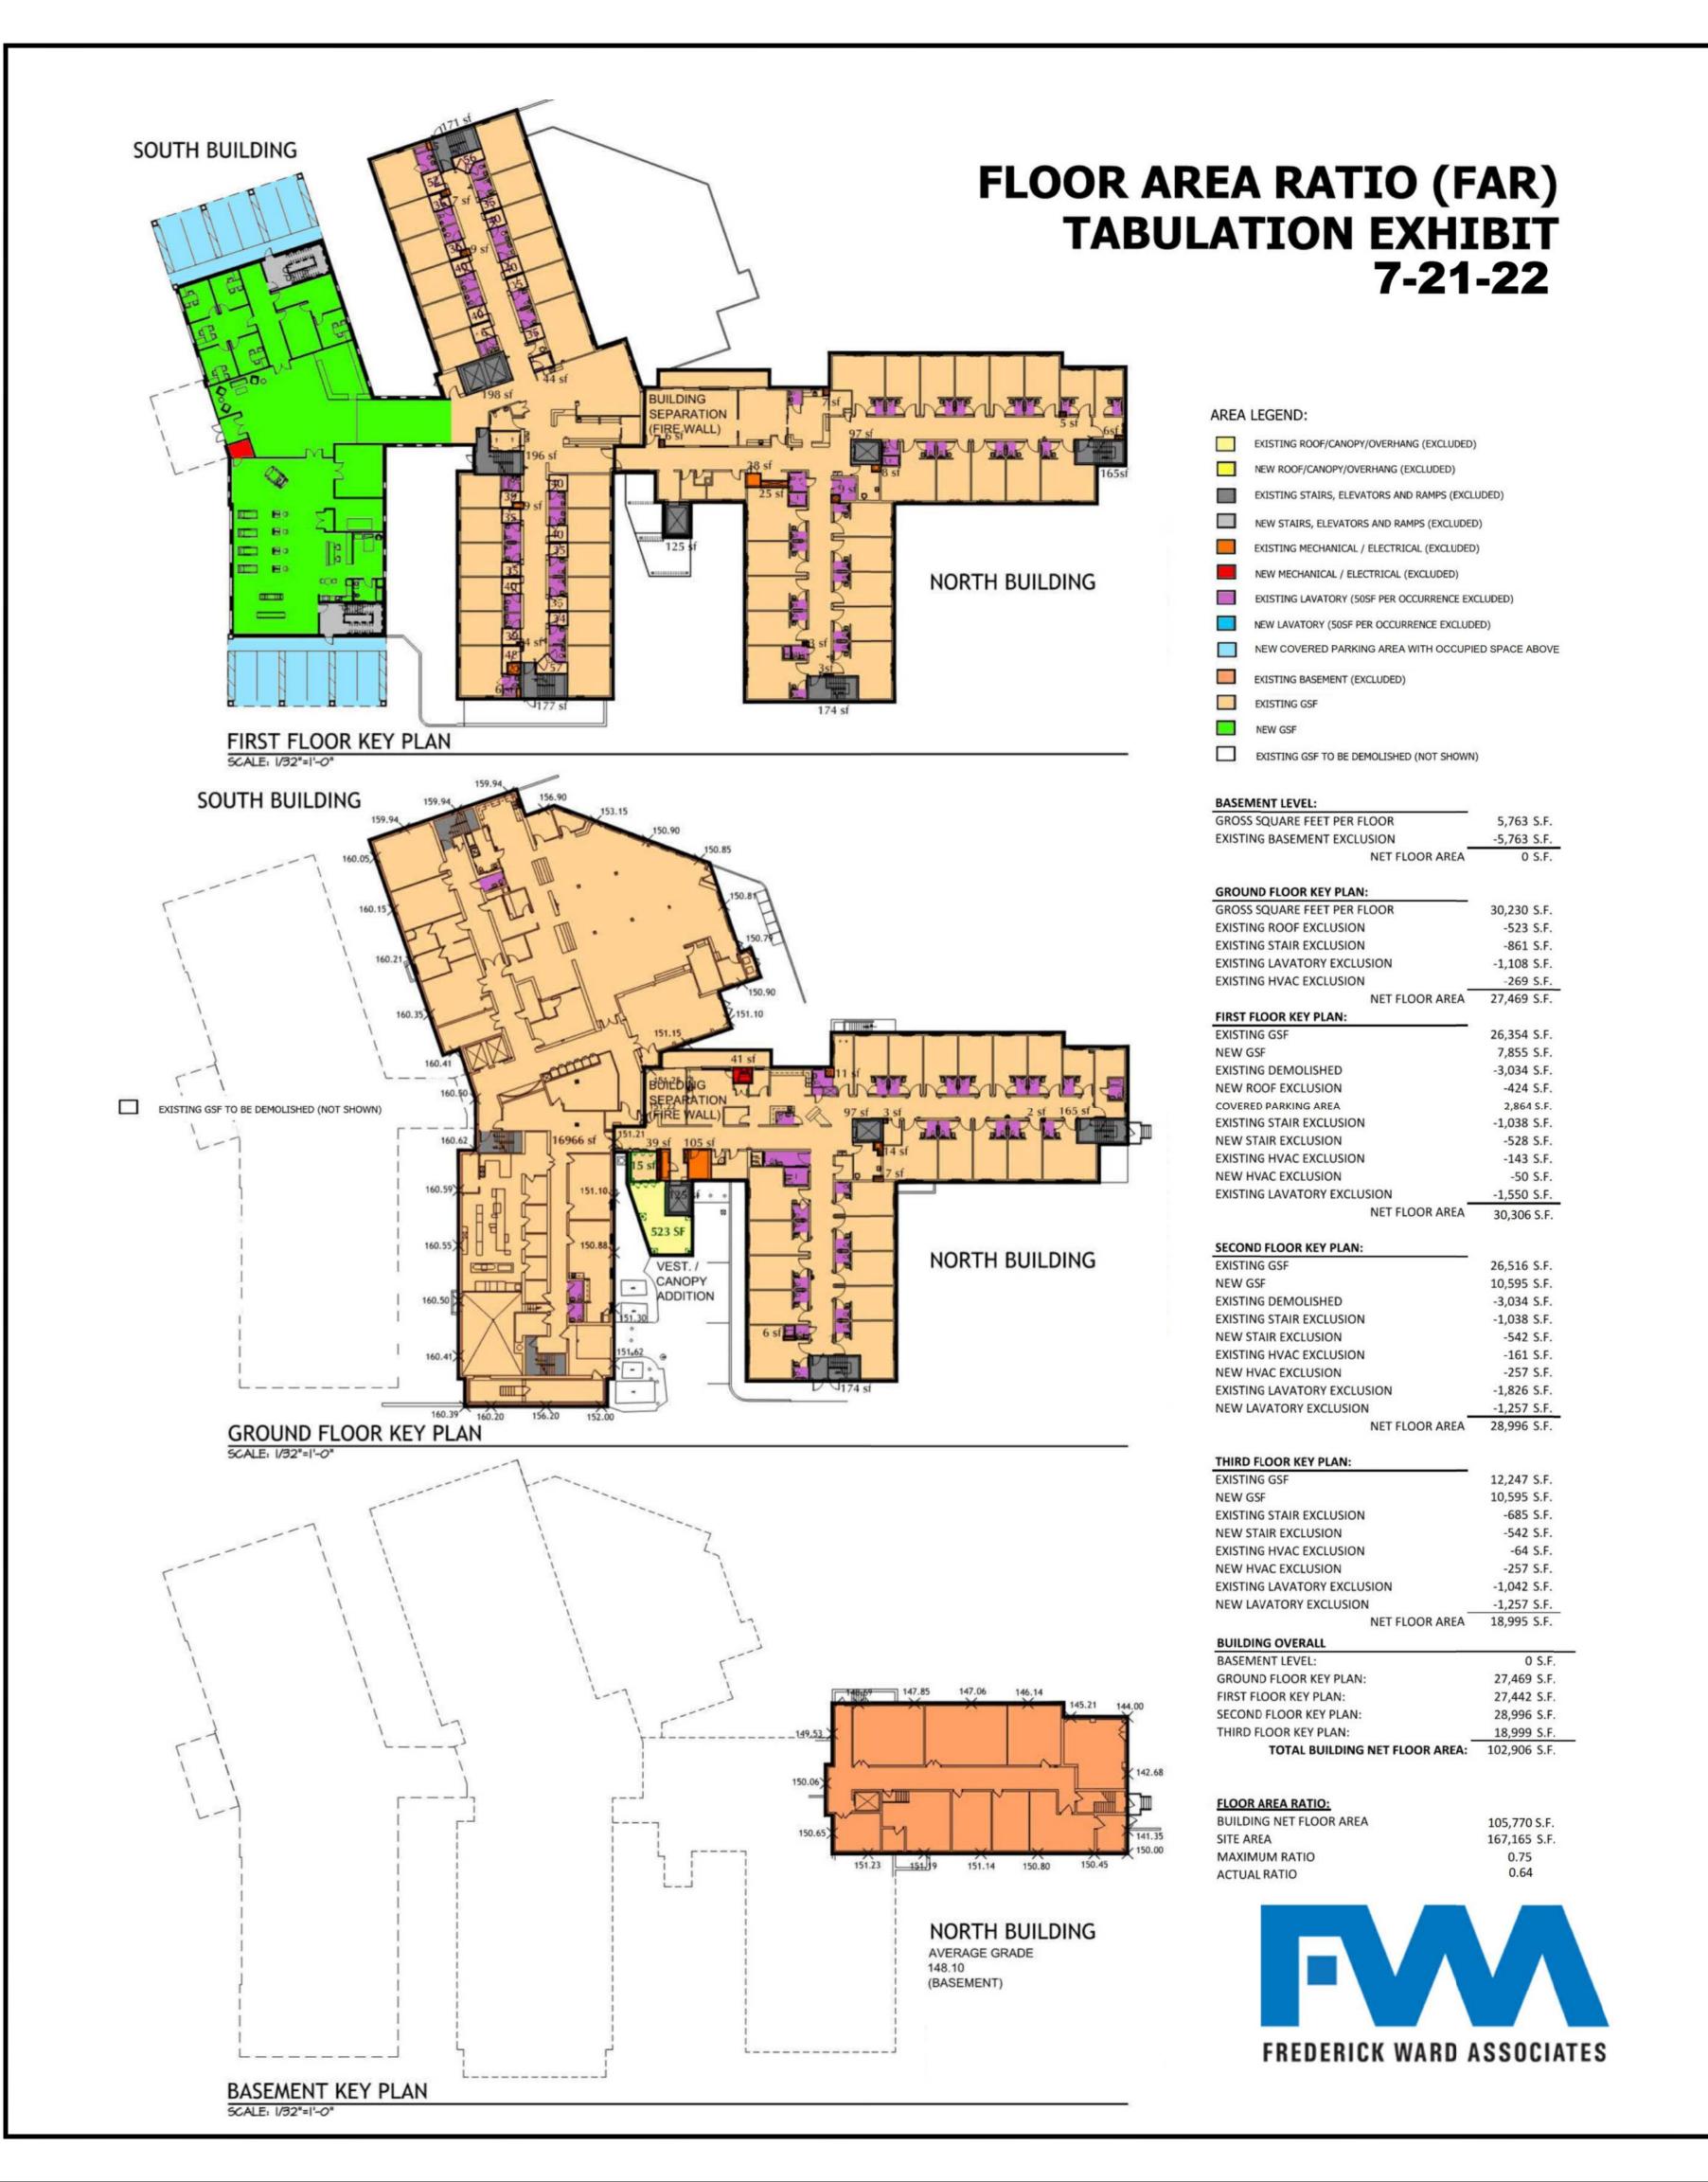THE AREA OF THE DISCOVERY UNTIL A CITY ARCHAEOLOGIST COMES TO THE

THE APPLICANT/DEVELOPER SHALL NOT ALLOW ANY METAL DETECTION TO BE

COMPLETED IN COMPLIANCE WITH SECTION 11-411 OF THE ZONING ORDINANCE

CONDUCTED ON THE PROPERTY, UNLESS AUTHORIZED BY ALEXANDRIA

ALL REQUIRED ARCHAEOLOGICAL PRESERVATION MEASURES SHALL BE

FOUNDATIONS, WELLS, PRIVIES, CISTERNS, ETC.) OR CONCENTRATIONS OF ARTIFACTS ARE DISCOVERED DURING DEVELOPMENT. WORK MUST CEASE IN APPROVED

SITE PLAN NO.

DATE RECORDED

INSTRUMENT NO.

SPECIAL USE PERMIT NO.

DIRECTOR

CHAIRMAN, PLANNING COMMISSION

DEPARTMENT OF PLANNING & ZONING

DEPARTMENT OF TRANSPORTATION & ENVIRONMENTAL SERVICES

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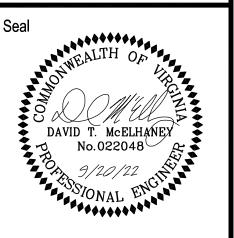
DATE

PAGE NO.

SCALE: 1/32"=1'-0"

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WOODBINE PROPERTY 1 LLC

1608 Route 88, Suite 301 Brick, NJ 08724

Contact: Peter Modri

Revision / Issue No. Description

1ST SUBMISSION

7/21/2022 1ST SUB.-COMPLETENESS 8/19/2022 1ST SUB.-COMPLETENESS 9/20/2022 1ST SUB.-COMPLETENESS

Project Name

WOODBINE **PRELIMINARY** DEVELOPMENT SITE PLAN

DSUP 2022-10014

City of Alexandria Alexandria, Virginia

Checked By DTM

Project No. ZP-13088

Date SEPT. 20, 2022

Drawing Title

Scale: As Noted

Drawing Number

Sheet 13 of 27



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Drawing Number CHAIRMAN, PLANNING COMMISSION DATE

PAGE NO.

Sheet 14 of 27

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DATE RECORDED INSTRUMENT NO.

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1608 Route 88, Suite 301 Brick, NJ 08724

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Revision / Issue

6/3/2022 1ST SUBMISSION

Project Name

7/21/2022 1ST SUB.-COMPLETENESS 8/19/2022 1ST SUB.-COMPLETENESS 9/20/2022 1ST SUB.-COMPLETENESS

WOODBINE

PRELIMINARY

DEVELOPMENT

SITE PLAN

DSUP 2022-10014

City of Alexandria Alexandria, Virginia


Date SEPT. 20, 2022


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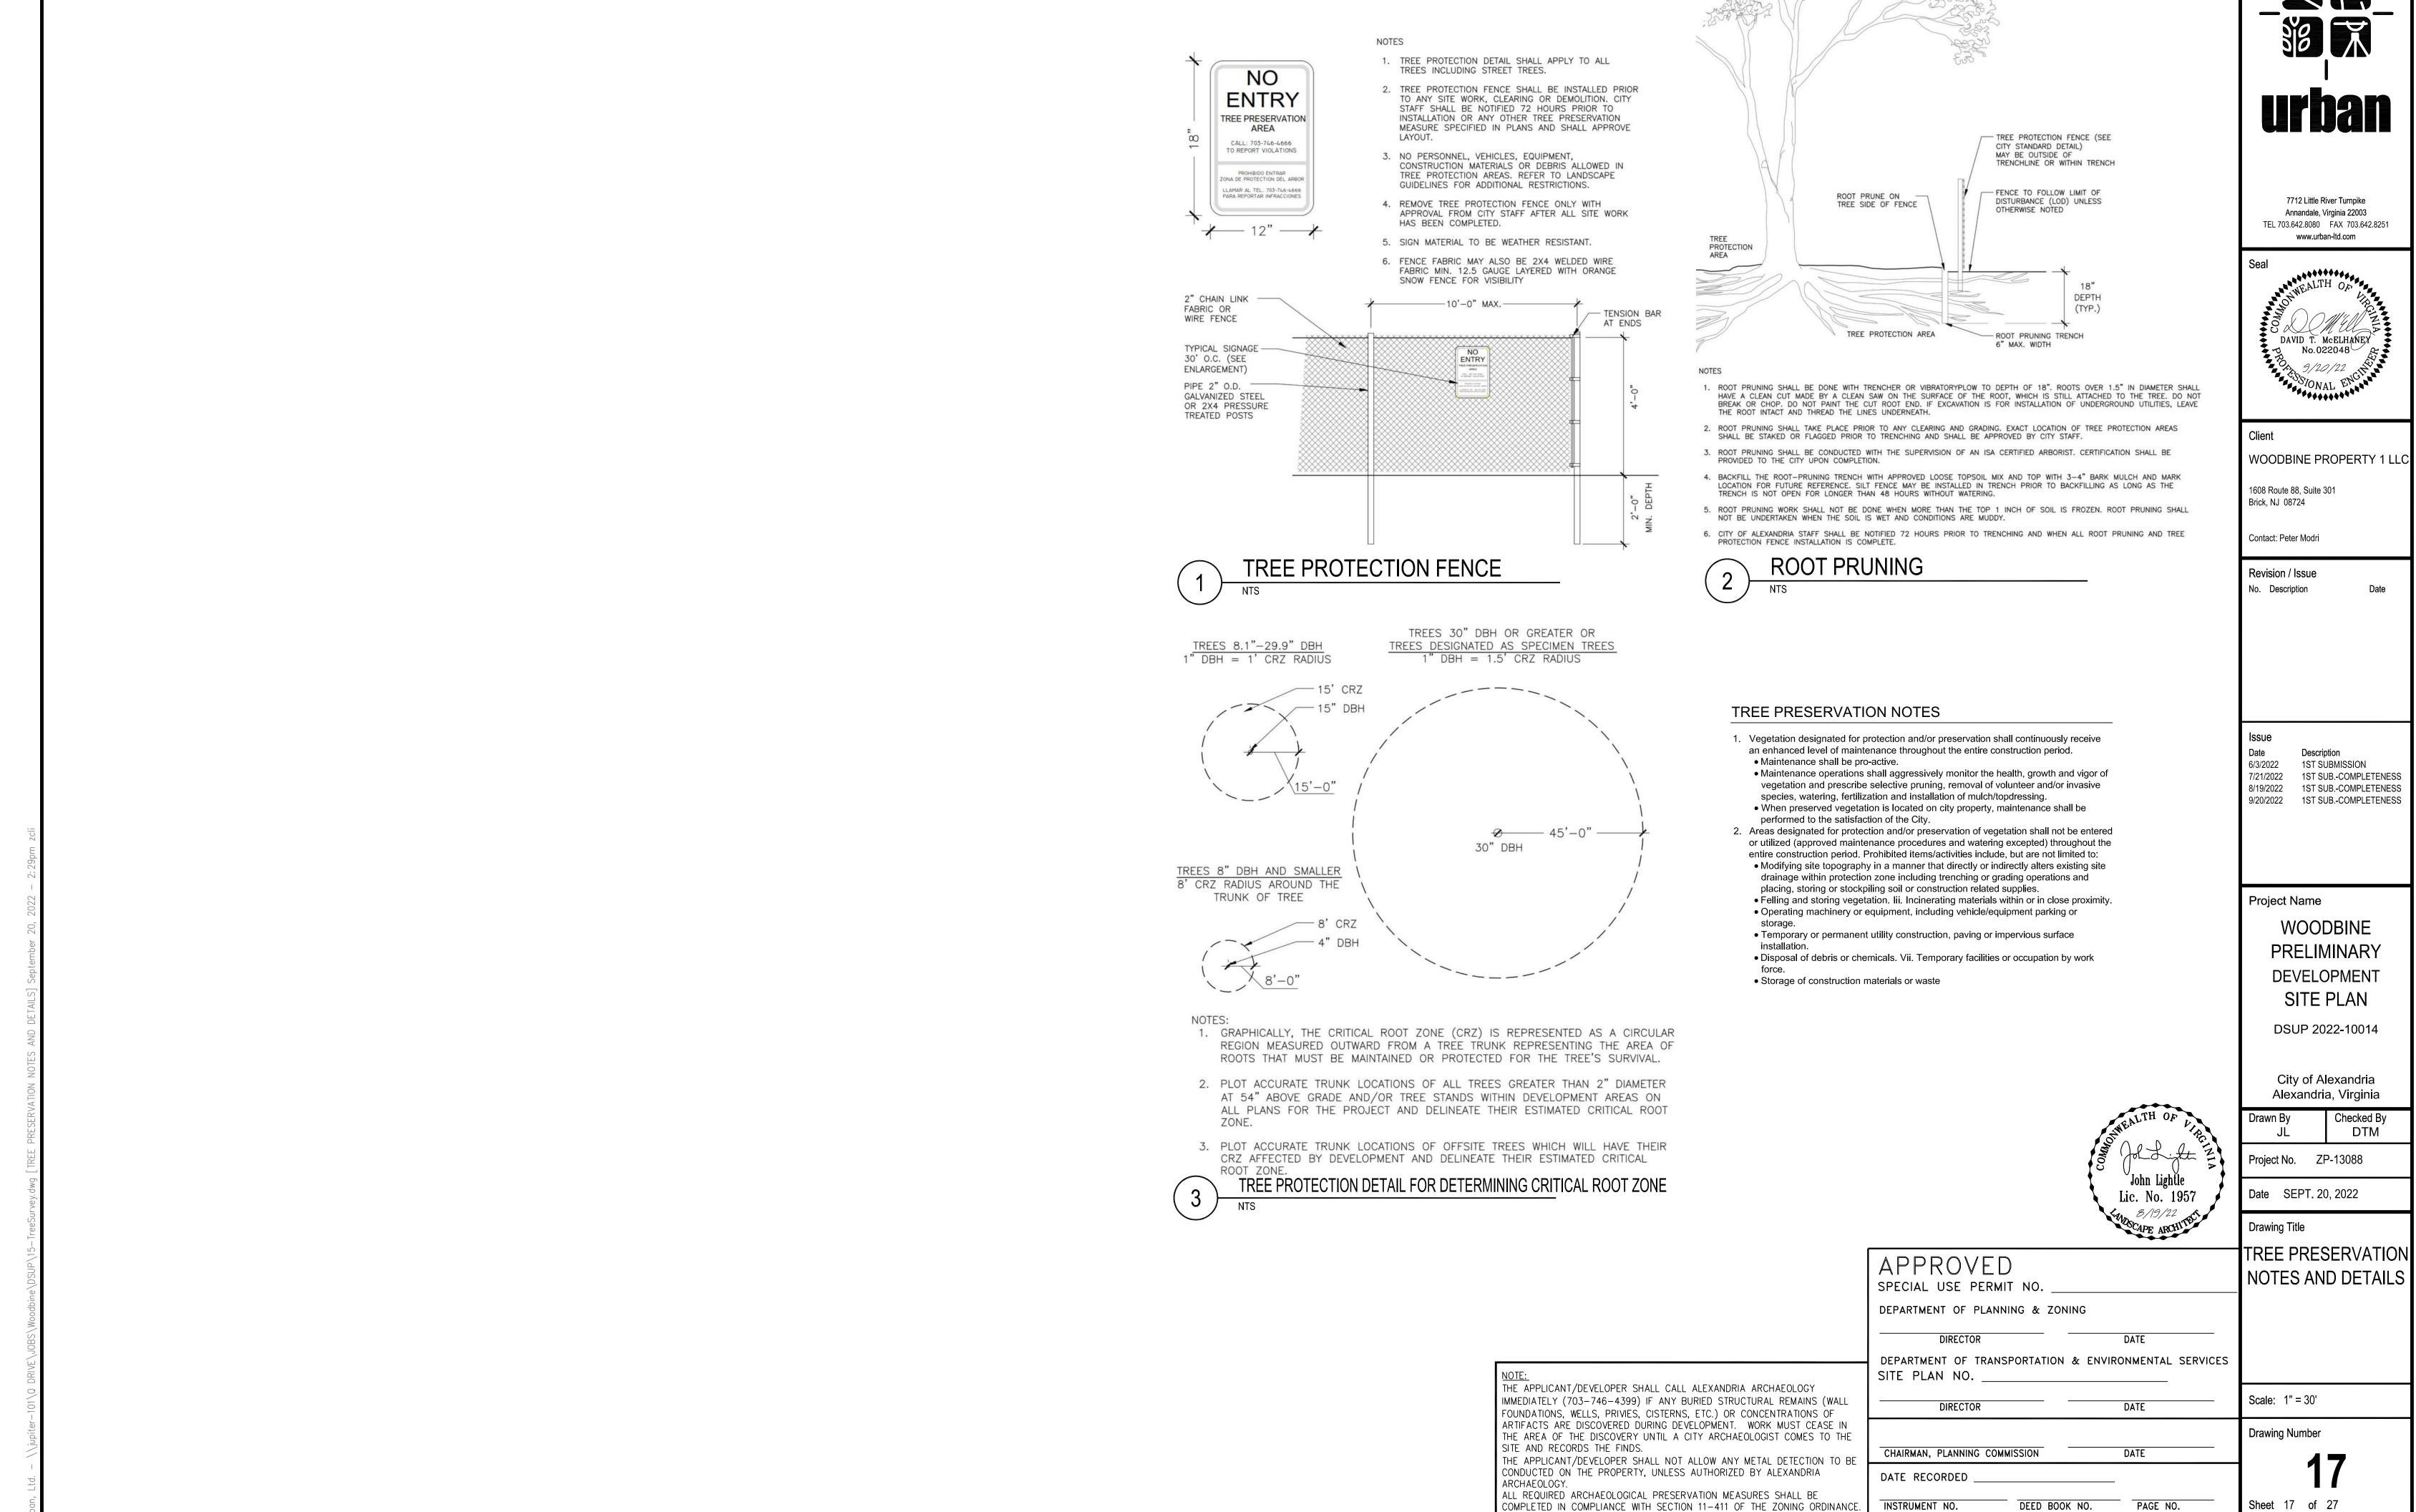
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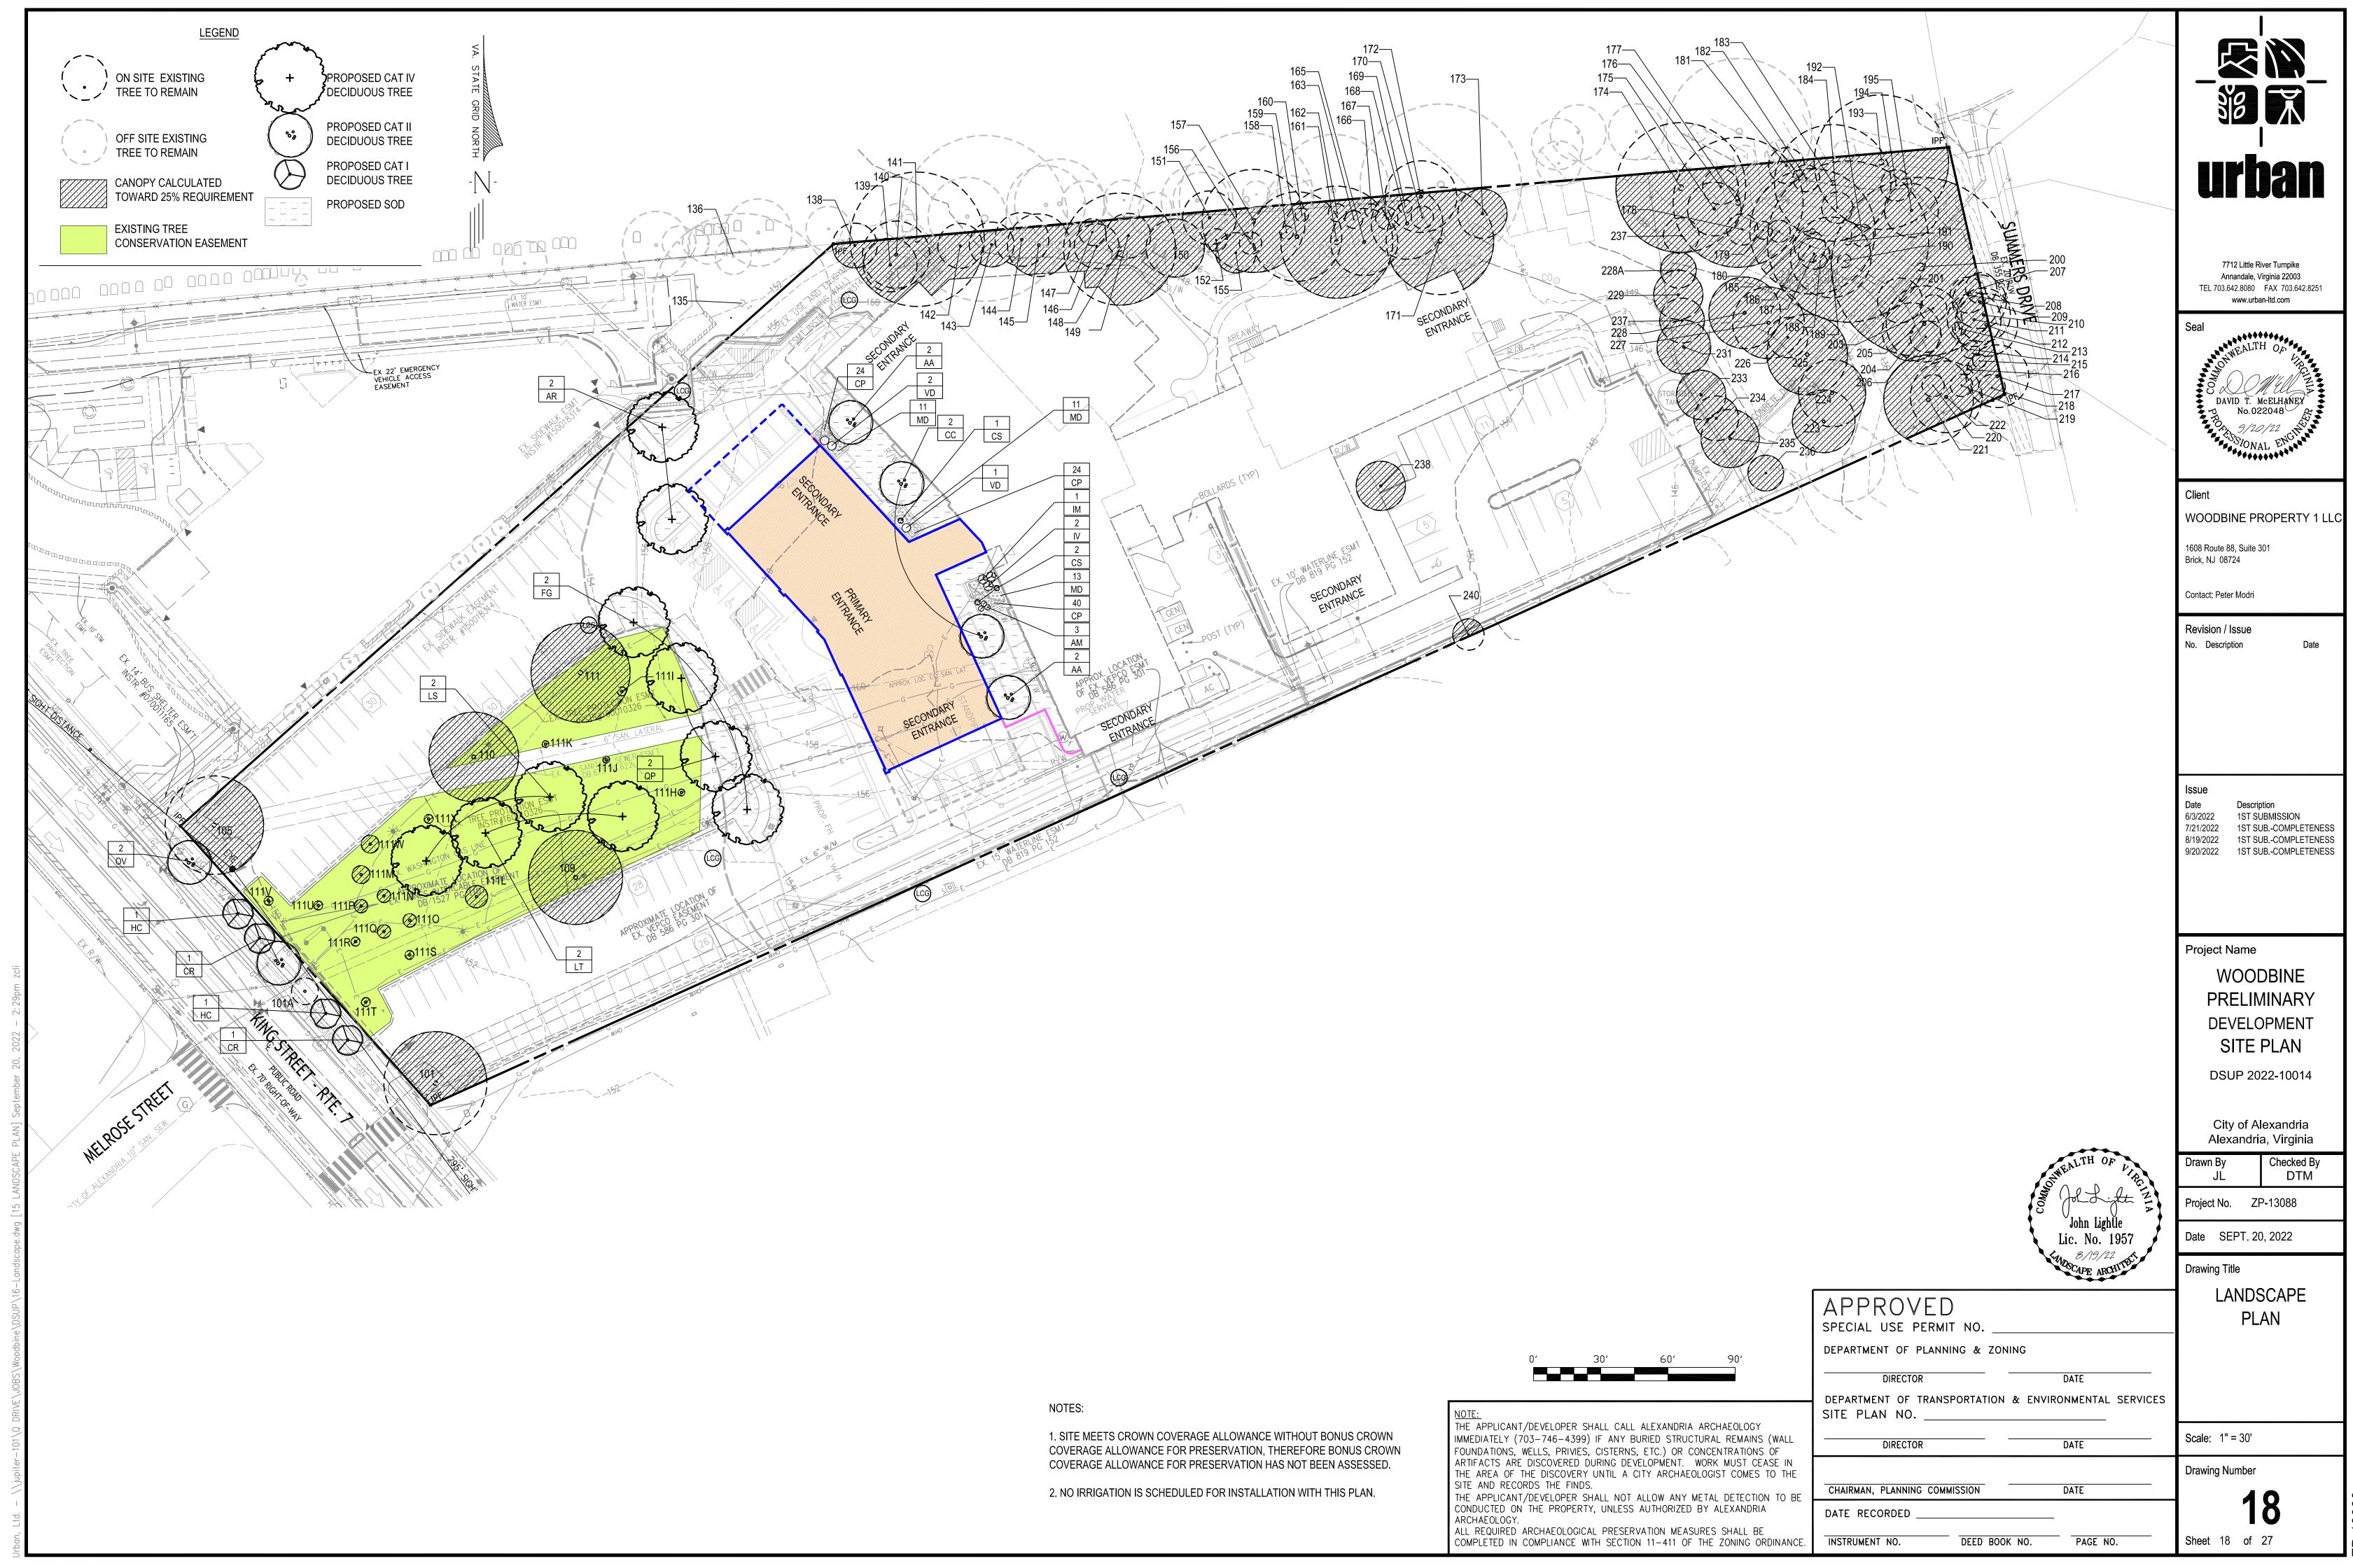
MASSING

ale: N.A.





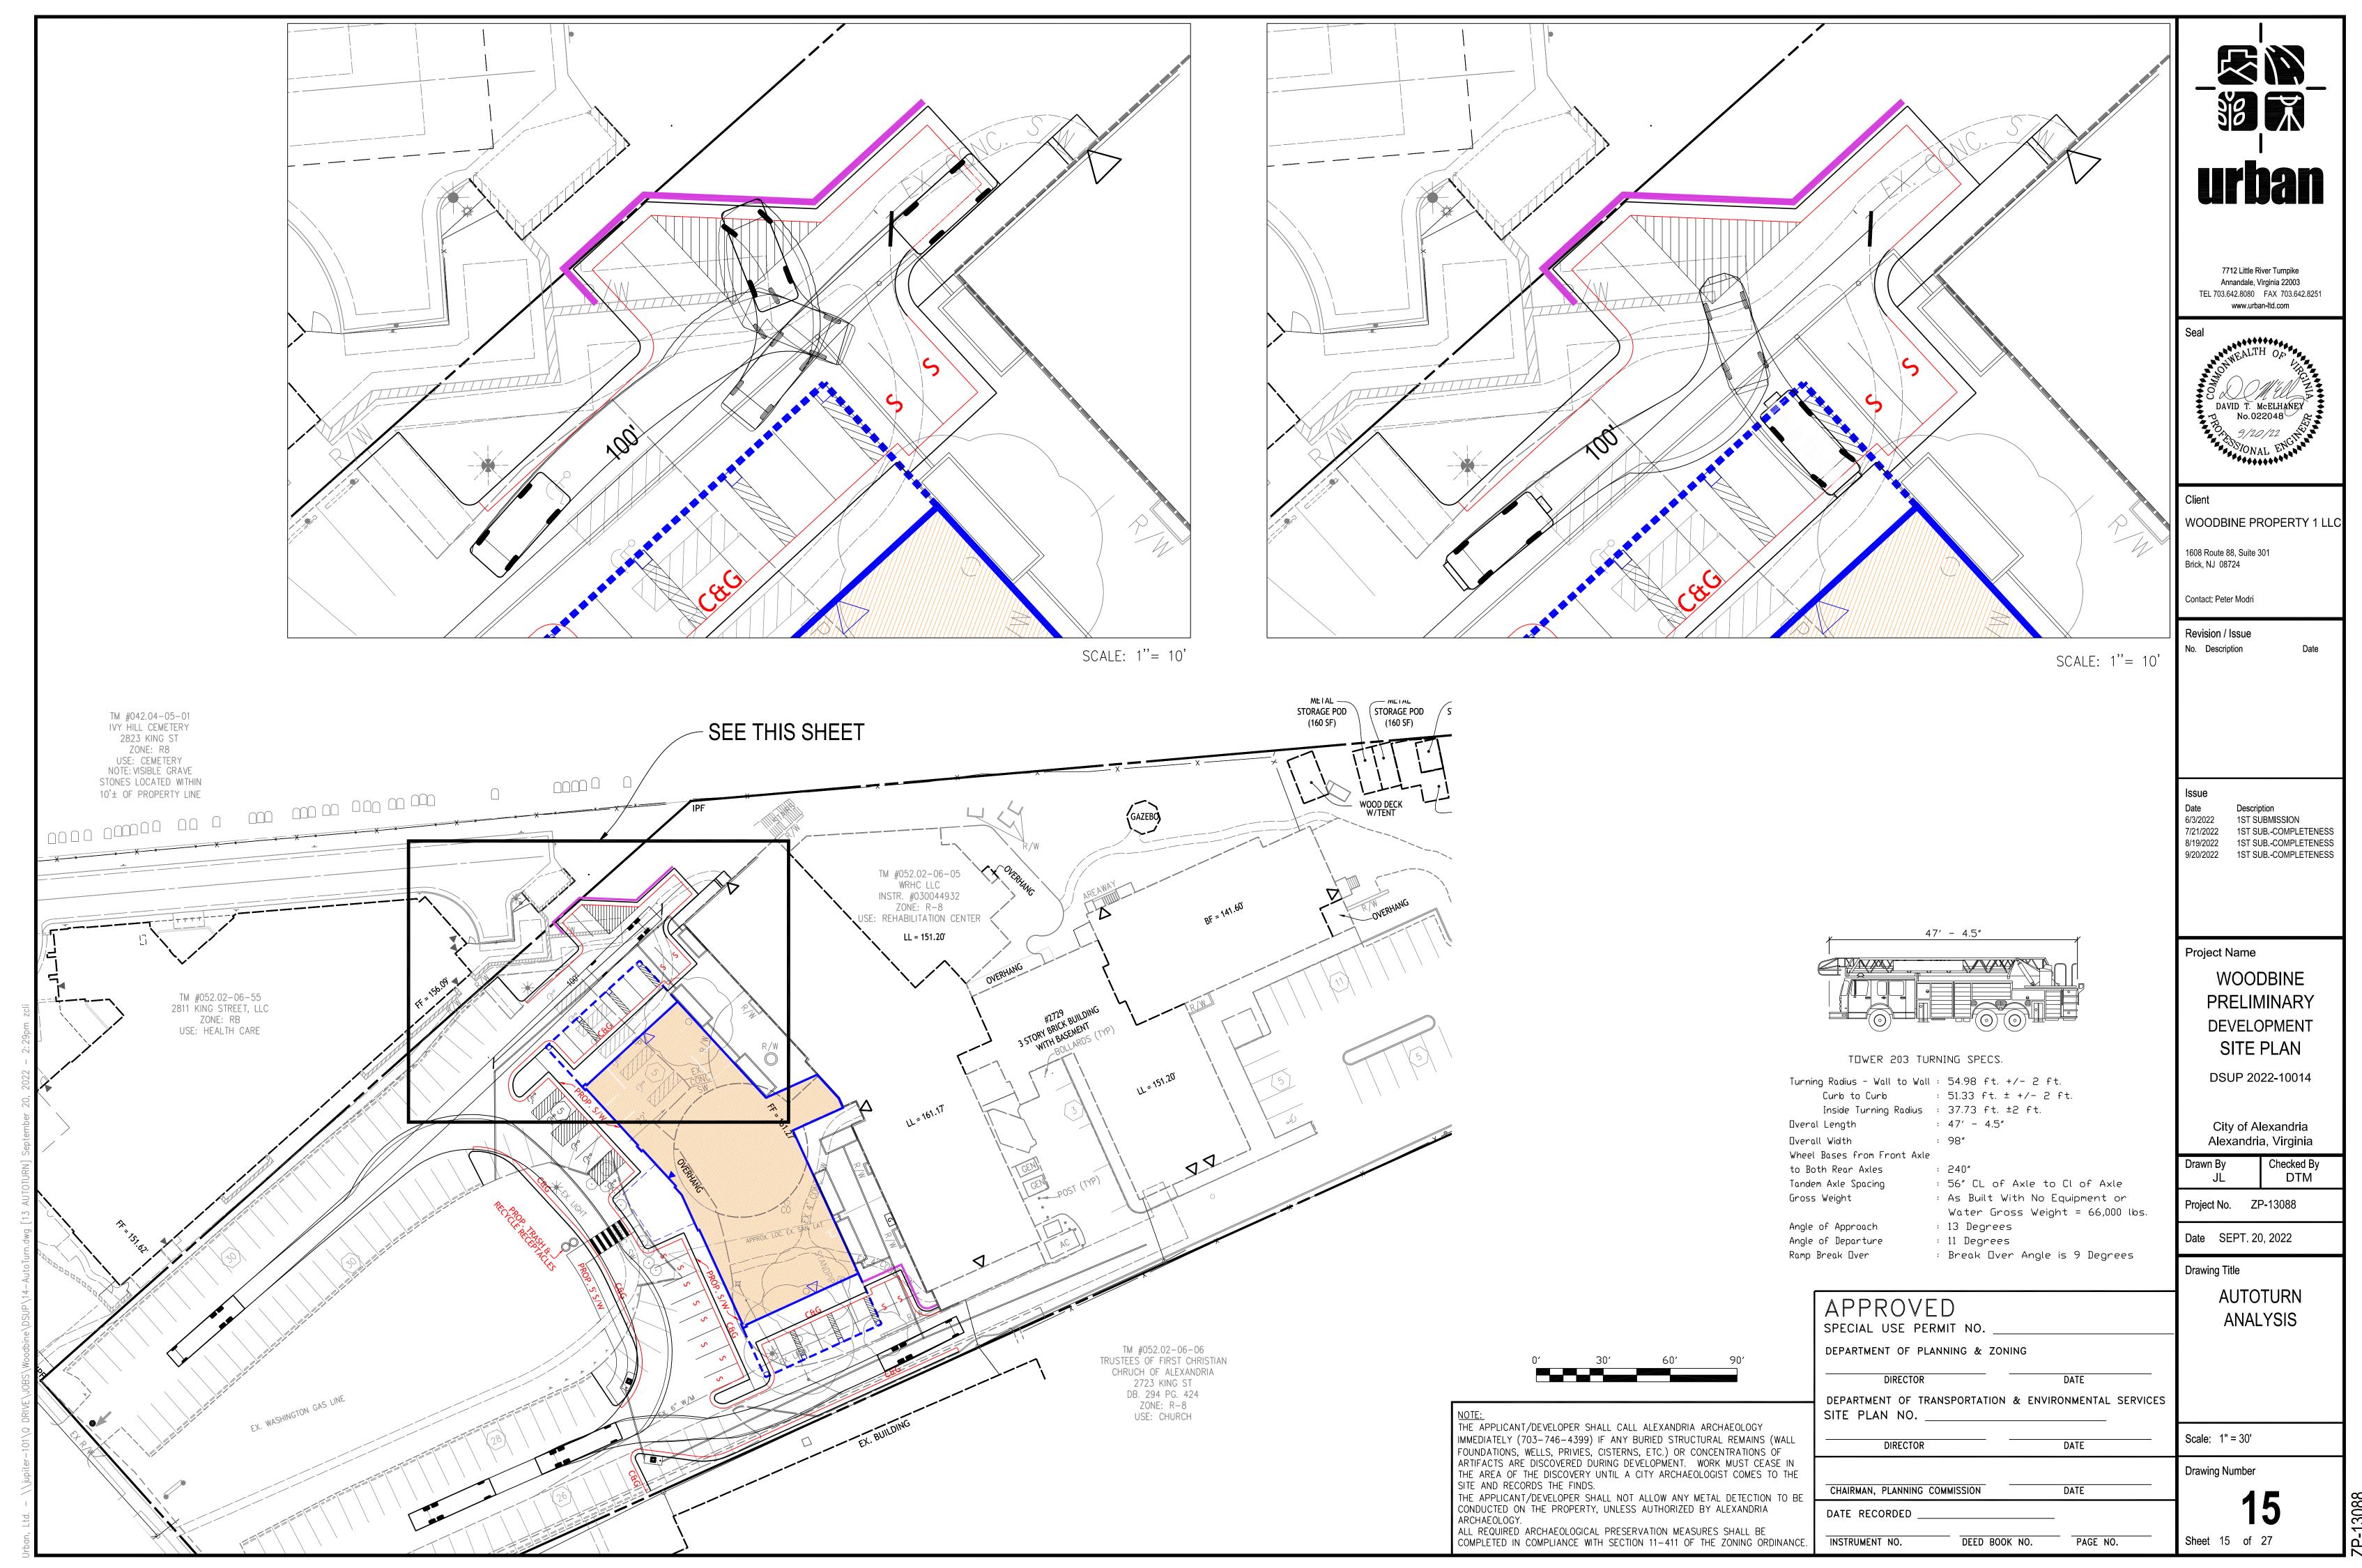

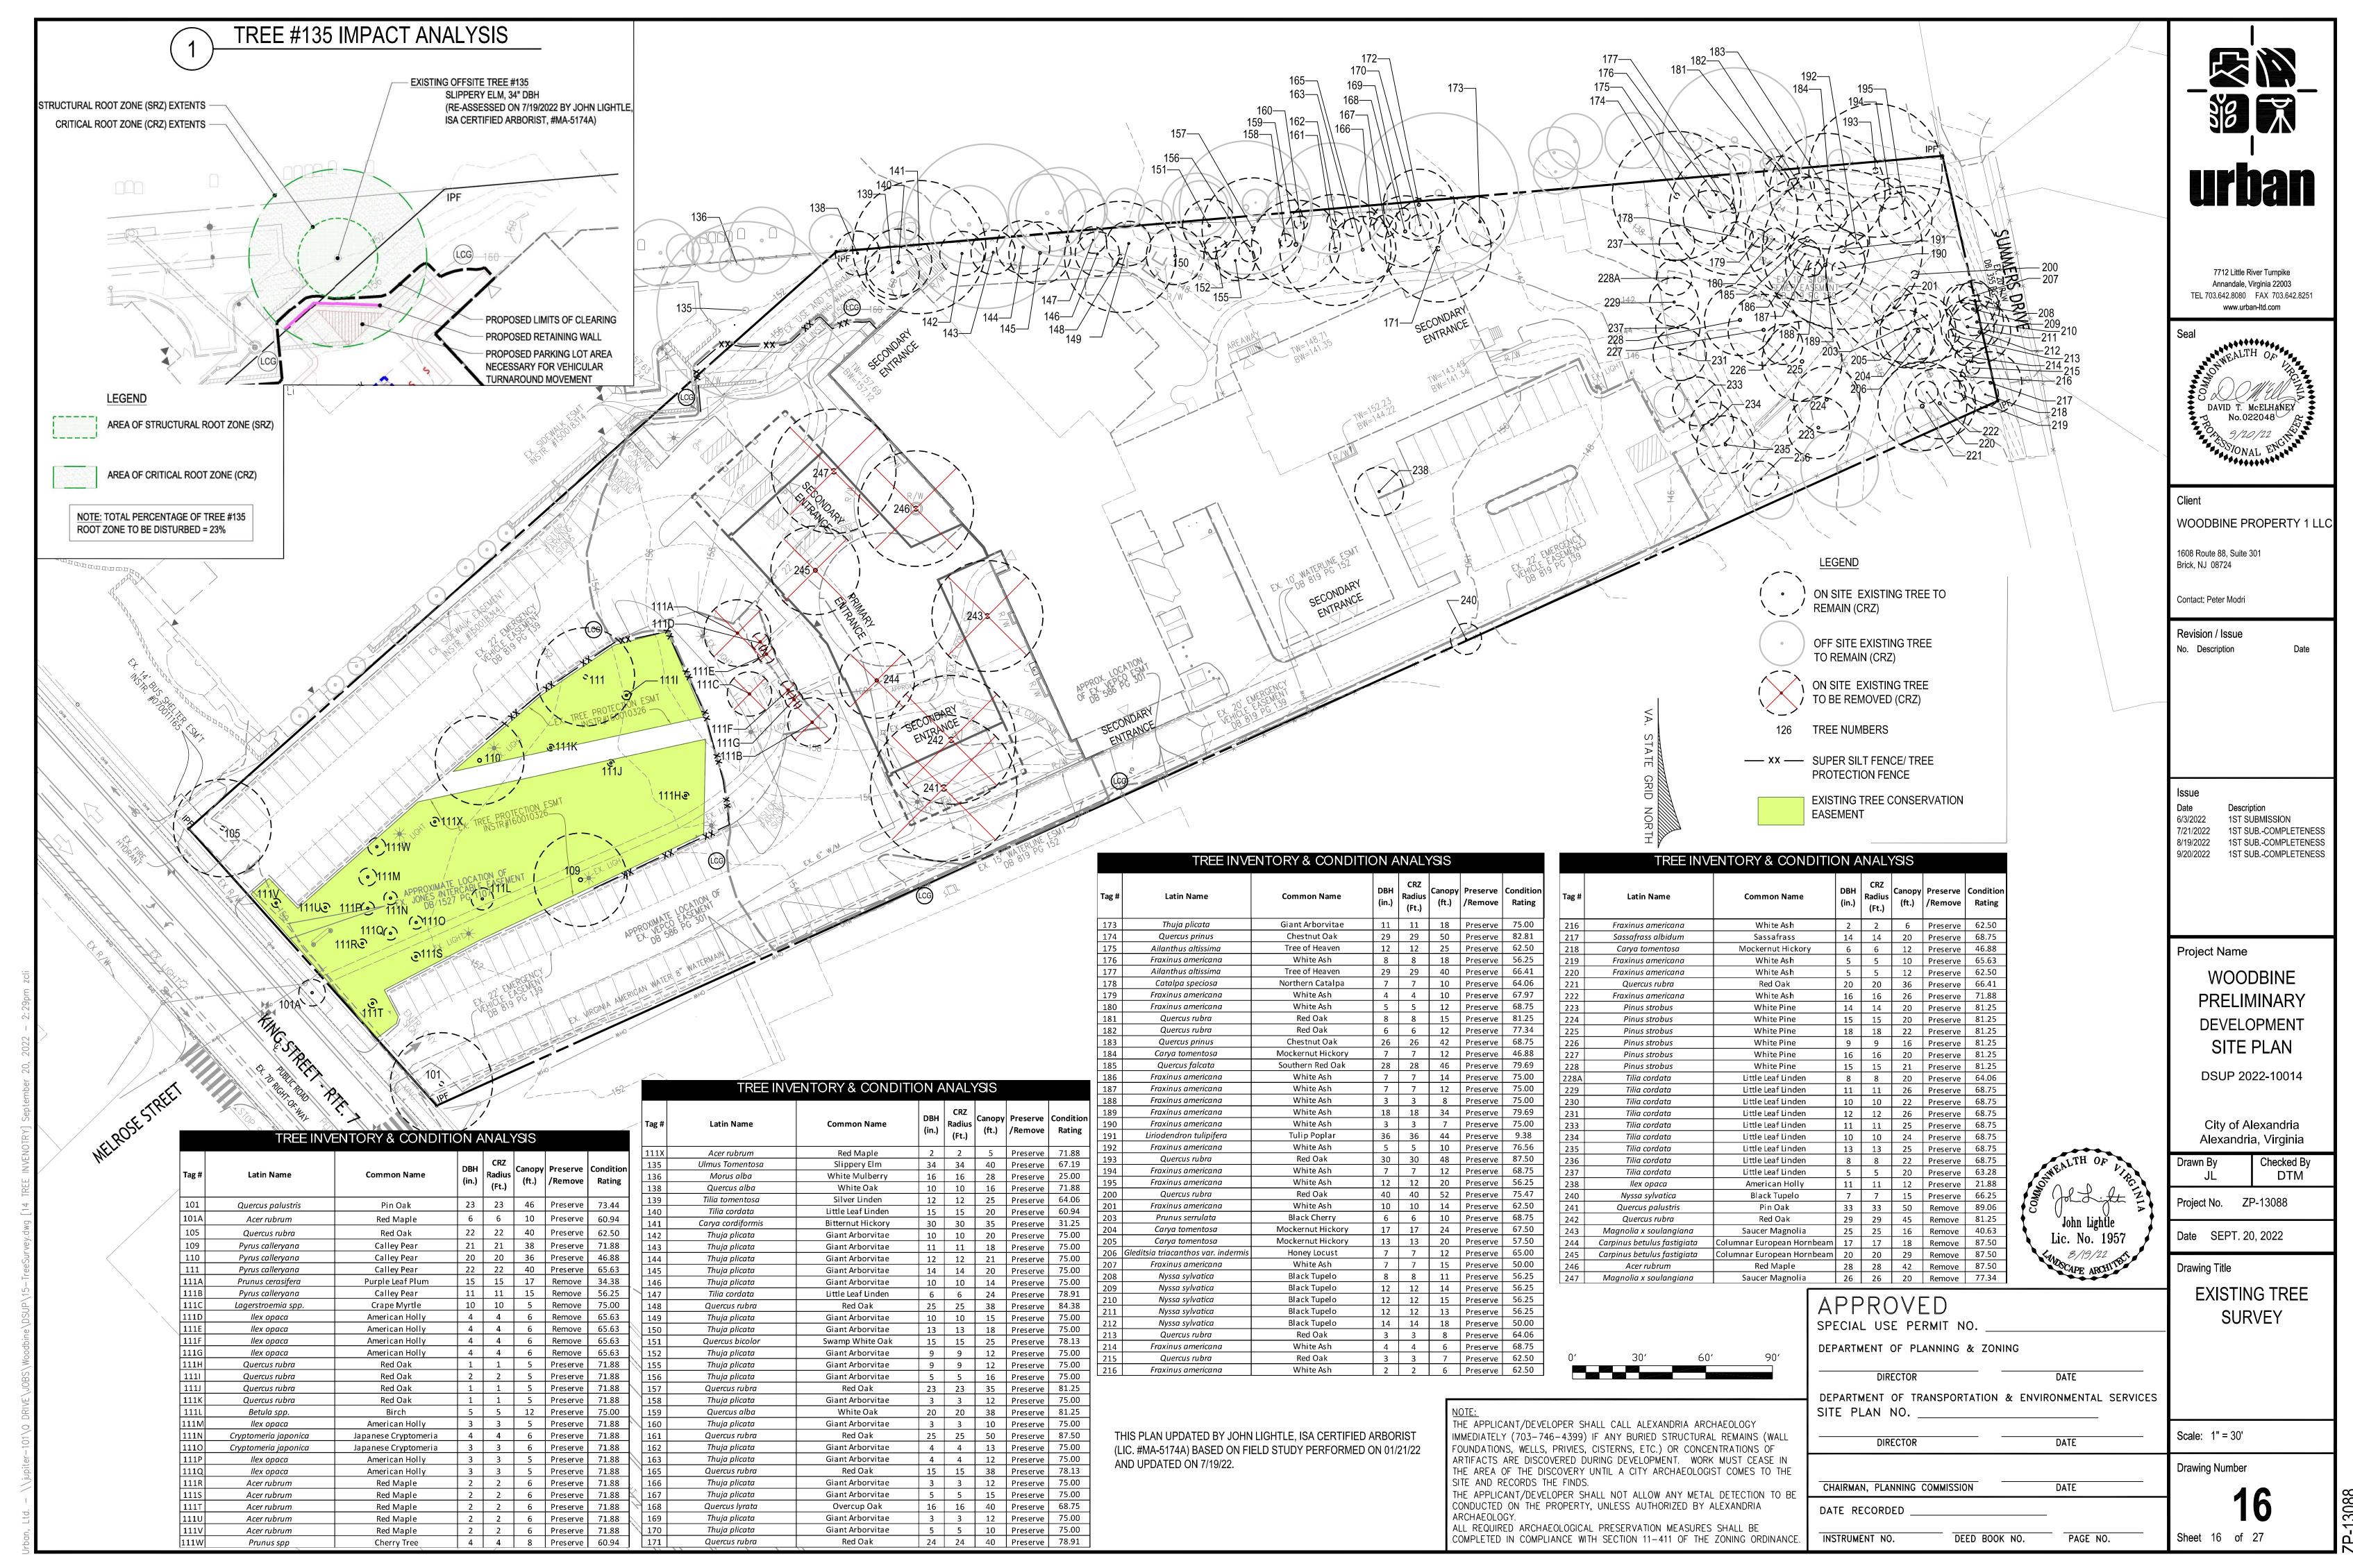

REQUIRED

10%

25%

15%

40%

5%

20%

10%

40%

10%

25%

80%

TOTAL SUM OF REGIONAL/LOCAL NATIVE PLANTS

28

87.5%

2) Total Natives is the sum of Eastern U.S. Native, Regionally Native, and Locally Native vegetation specifed on the plans for each plant type.

PLANT TYPE

Urban Trees

Standard Trees

Evergreen Shrubs

Deciduous Shrubs

Perennials, Ferns,

Ornamental Grasses

Vines

TOTAL PLANTS SPECIFIED

native species regardless of plant type.

Groundcovers

PERCENT OF

TOTAL PROPOSED

10.0%

10.0%

PERCENT OF

25%

25%

25%

TOTAL PROPOSED

SPECIES

x rutgersensis 2

SPECIES QTY.

melanocarpa

verticillata

rubrum

carolina

phellos

virginiana

grandifolia

styraciflua

carolina

arborea

MAXIMUM PERCENT

ALLOWED

10%

10%

MAXIMUM PERCEN

ALLOWED

N/A

N/A

N/A

N/A

QUANTITY

NATIVE TYPE

Regional/Loca

Total Native:

Total Native:

Regional/Loca

Regional/Loca

Total Native

Regional/Loca

Total Native

Regional/Local

Total Natives

Regional/Loca

Total Native:

Total Natives

PROVIDED

REQUIRED

15%

25%

25%

60%

8%

30%

15%

60%

10%

20%

15%

40%

100%

TOTALS

1) Percentages apply to the total quantity of each plant type specifed on Completeness/Preliminary Plans and Final #1 Grading Plans submitted during the listed time

3) Non-native vegetation for the purposes of providing edible fruits, seeds, or nuts may be planted and shall not be calculated in the above-stated requirements for

PROVIDED

4 50.0%

6 75.0%

12 | 100.0%

12 | 100.0%

100%

100%

12

12

REQUIRED

20%

50%

40%

80%

10%

40%

20%

80%

10%

20%

25% (perennials)

30% (ferns & grasses)

60% (perennials)

80% (ferns & grasses)

100%

TOTAL SUM OF NATIVE PLANTS

30

93.8%

PROVIDED

nsion Service		0.0%	0.0%	0.0%	
on Se	ervice				
		CROWN COVER	TARIHATIONS		
			TABULATIONS		
	TOTAL SITE AREA (S	F)		167,165	
	25% CROWN COVER		41,791		
	EXISTING CROWN C		45,500		
	REMOVED CROWN	COVER (SF)		14,231	
	PRESERVED CROWN	I COVER (SF)			
	Crown Cover fr		31,269		
	Crown Cover fro	m Preserved Shrubs		0	
	PROPOSED CROWN	COVER (SF)			
	Crown Cover f	rom Proposed Trees		14,000	
	Crown Cover fro	om Proposed Shrubs		255	
	TOTAL PROPOSED C	ROWN COVER (SF)		14,255	
				_	
	TOTAL CROWN COV	'ER PROVIDED (SF)		45,524	

27.2%

TOTAL CROWN COVER PROVIDED (%)

	URBAN TREE TABULATIONS						
	PLAN KEY	QUANTITY	PLAN LOCATION	PROJECTED 20 YR. CANOPY* (PER TREE)	IMPERVIOUS AREA UNDER CANOPY (PER TREE)	IMPERVIOUS AREA GREATER THAN 50% OF PROJECTED 20 YR CANOPY? (Y/N)	
	OV	2	STREET TREE	500 SF	290 SF	Υ	
	HC	2	STREET TREE	250 sf	136 SF	Υ	
	CR	2	STREET TREE	250 sf	136 SF	Υ	
	AA	2	COURTYARD	500 SF	79 SF	N	
	CC	2	COURTYARD	500 SF	25 SF	N	
	QP	2	FRONT LAWN	1,250 SF	247 SF	N	
	AR	2	PARKING ISLAND	1,250 SF	1103 SF	Υ	
	FG	2	PARKING ISLAND	1,250 SF	551 SF	N	
	LS	2	FRONT LAWN	1,250 SF	0	N	
	LT	2	FRONT LAWN	1,250 SF	0	N	
	TOTAL URBAN TREES						
				8			
_	*Refer to Lan	dscape Guidelir	nes Chapter 3 Canopy	Coverage			

Landscape Islands in Parking Areas Tabulation

Street Tree Tabulations: King Street

Street Trees Required: Lot Frontage= 167 LF

Note: Existing Tree 101A is less than 12' from the

existing utility pole to remain and has been excluded

15 Trees

9 Trees

Spaces to be counted =

Qty Provided=

Qty Required

Street Trees Provided:

Proposed Street Trees

from street tree computations.

Trees Required (1/10 Spaces) =

DAVID T. McELHANEY No.022048

7712 Little River Turnpike

Annandale, Virginia 22003

TEL 703.642.8080 FAX 703.642.8251

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WOODBINE PROPERTY 1 LLC

Date

1608 Route 88, Suite 301 Brick, NJ 08724

Contact: Peter Modri

Revision / Issue No. Description

Description 1ST SUB.-COMPLETENESS 7/21/2022 8/19/2022 1ST SUB.-COMPLETENESS

9/20/2022 1ST SUB.-COMPLETENESS

Project Name WOODBINE **PRELIMINARY** DEVELOPMENT

DSUP 2022-10014

SITE PLAN

City of Alexandria Alexandria, Virginia

Checked By DTM

Project No. ZP-13088

Date SEPT. 20, 2022

Drawing Title

Lic. No. 1957

PAGE NO.

LANDSCAPE **COMPUTATIONS**

APPROVED SPECIAL USE PERMIT NO.

DEPARTMENT OF PLANNING & ZONING

CHAIRMAN, PLANNING COMMISSION

DEPARTMENT OF TRANSPORTATION & ENVIRONMENTAL SERVICES SITE PLAN NO. __

DIRECTOR

DEED BOOK NO.

Drawing Number

Scale: 1" = 30'

Sheet 19 of 27

T	FS	

1. SITE MEETS CROWN COVERAGE ALLOWANCE WITHOUT BONUS CROWN COVERAGE ALLOWANCE FOR PRESERVATION, THEREFORE BONUS CROWN COVERAGE ALLOWANCE FOR PRESERVATION HAS NOT BEEN ASSESSED.

2. NO IRRIGATION IS SCHEDULED FOR INSTALLATION WITH THIS PLAN.

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TOTAL NUMBER OF TREES PROPOSED: 20

TOTAL NUMBER OF SHRUBS PROPOSED: 12

PROPOSED

10.0%

10.0%

GENUS

Quercus

Carpinus

SHRUBS

Liquidambar

Amelanchier 2

PERCENT OF TOTAL MAXIMUM PERCENT

PERCENT OF TOTAL MAXIMUM PERCENT

ALLOWED

33%

33%

33%

33%

33%

33%

33%

33%

ALLOWED

N/A

N/A

Note: All proposed shrubs are within urban bioretention planters and per Landscape Design Guidelines Chapter 3

PLANTING SPECIFICATIONS

- General Conditions: The intent of this landscape plan is to renovate / replace the existing landscape plantings on the office building property. The majority of the landscape plantings to be provided with this plan are to be installed in existing planting areas over an existing parking garage roof slab, which extends nearly to the property lines on all sides. Existing planting soil depths over the garage range from less than one foot to approximately three feet in depth. As such, Contractor shall:
- a. Take every precaution to prevent damage to the top of the existing roof slab and waterproofing.
- b. Motorized machinery shall not be operated across landscape and hardscape areas, except for on existing vehicular areas. Materials shall be hand carried or transported by non-mechanized carts or wheelbarrows across the rooftop or may be lifted over and in from vehicular access ways and non-roof areas to the planting locations.
- c. Excavation for planting shall be done by hand with care to prevent damage to the underlying rooftop slab, waterproofing and any subsurface utility lines including electrical conduits, irrigation lines, drains or other subsurface items.
- d. Should the waterproofing be damaged, cut or compromised, contractor shall provide repairs prior to covering or filling excavations or planting as directed by the architect.
- e. Planting soil depths shall not be increased beyond what is shown on the plans without confirmation of by a structural engineer that additional planting soil weight can be safely accommodated.
- Quality Assurance:
 - a. Landscape planting and related work shall be performed by a firm with a minimum of five years' experience specializing in this type and scale of work
 - b. Applicable Specifications and Standards:
 - City of Alexandria Zoning Ordinance,
 - City of Alexandria Landscape Guidelines, American Joint Committee on Horticultural Nomenclature
 - American Standard for Nursery Stock, ANSI-Z60.1, latest edition,
 - American Association of Nurserymen
 - Landscape Specification Guidelines for Baltimore Washington Metropolitan Areas, latest edition,
- Landscape Contractors Association.
- Submittals: Submit the following to the Owner's Representative prior to beginning work:
- Copies of manufacturer's data for all materials required.
- Samples of required mulch material.
- Chemical and mechanical analysis and samples of all existing soil, and proposed topsoil, organic matter, and soil mixes to be used. Analyses shall included recommended amendments for landscape tree and shrub plantings
- Planting schedule showing the dates (earliest and latest) proposed for each type of plant specified, schedule each type of planting within the normal planting seasons for such work. Include requests for any proposed changes in the approved planting season and a list of proposed sources for all plant materials.
- List of proposed sources for all plant material.
- Delivery, Storage, and Handling:
- a. Deliver packaged materials in manufacturer's unopened containers or bundles, fully identified with name, brand, type, weight, and analysis. Store packaged materials in such a manner as to prevent damage or intrusion of foreign matter.
- b. Dig balled and burlapped (B&B) plants with firm, natural balls of earth, of a diameter not less than that shown on the plant list nor less than recommended by the American Standard for Nursery Stock, and of sufficient depth to include the fibrous and feeding roots. B&B plants will not be accepted if the ball is cracked or broken before or during planting operation.
- c. Deliver trees and shrubs after preparations for planting have been completed. Do not bend, bind, or tie trees or shrubs in such a manner as to damage bark, break branches or destroy natural shape. If planting is delayed more than 6 hours after delivery, set trees and shrubs in shade, protect from weather and mechanical damage, and keep roots moist by heeling-in bare root stock and covering plant balls with soil, peat moss or other acceptable material for balled stock. Plants shall be kept well watered and shall not remain unplanted for longer than ten (10) days after delivery.
- d. Plants shall be lifted and handled from the bottom of the ball only.
- e. Do not remove container-grown stock from containers until planting time.
- Planting shall be done only within the following dates except as approved by Owner.
- a. Deciduous trees and shrubs: March 1 to June 15 and September 15 to November 15.
- b. Evergreen trees, shrubs, and vines: March 1 to June 15 and September 15 to November 15.
- c. All plant material shall be guaranteed by the Contractor for a period of 1 year from the date of final acceptance to be in good, healthy, and flourishing condition.
- Materials for Planting:
- a. Mulch shall be double shredded hardwood bark. Submit sample for approval. Material shall be mulching grade, uniform in size and free from foreign matter.
- b. Leaf compost shall be screened and free of trash.
- Coir Mesh (geo-textile blanket) shall be natural fiber geo-textile woven mesh composed of 100% coir (spun from coconut fiber) yarn containing 45% lignin and 55% cellulose. Opening in the mesh shall be 1 inch square (nominal) by .3 inches thick. Yarn count per yard 10. Installation of Planting Soil Mix Over Structure
- shall be 42 warp x 37 weft. Fabric tensile strength shall be 432 lb/ft x 138 lb/ft. d. 12 inch hardwood stakes shall be Eco-STAKES by North American Green or equal.
- e. Fertilizer shall be commercial fertilizer for ornamental trees, shrubs, and ground cover. Fertilizer shall be provided in accordance with the recommendations of the soil tests. As a basis for bidding, Contractors shall assume a fertilizer with an analysis of 10% Nitrogen.

6% Phosphorus, and 4% Potassium. This fertilizer shall be granular with a minimum of 50% of the total Nitrogen in organic form.

- f. Topsoil: If required, shall be a fertile, friable natural loam, uniform in composition, free of stones, lumps, plants and their root debris and other extraneous matter of 1 inch in diameter, and capable of sustaining vigorous plant growth. Topsoil shall have a pH range of 6.0 to 6.5, with a pH range of 5.0 to 5.5 for plants requiring acid soils. Contractor shall have soil tested at an approved agricultural
- laboratory, and submit results and recommendations for acceptance by the Owner before providing topsoil for use. g. Composted pine bark fines shall be approved composted ground pine bark, having no particle with a dimension greater than ¾ inch.
- h. Soil mix shall consist of ¾ existing soil and ¼ composted pine bark fines or other approved organic matter, by volume. Lightweight soil mix for areas over the roof structure shall consist of 32% Topsoil, 25% Composted Pine Bark Fines, 12% Perlite, 12% Sand and 12% Humus. Mix shall have a pH of 5.5 to 6.5, and an organic matter content of between 3 and 5%. Mix shall contain a maximum of 55% sand. The maximum saturated density of the mix shall be 92 lbs./cubic foot, with testing done in accordance with
- Plant Materials (Refer to the PLANT LIST on the drawings for specific types and quantities of plants):
- a. Plants shall be nursery grown in accordance with good horticultural practices. Plants shall either be obtained from local nurseries and/or others, which have soil (heavy clay) and climatic conditions similar to those in the locality of the project. Provenance of plant material must be from within the following states: Virginia, Maryland, District of Columbia, Pennsylvania, Delaware, New Jersey,

- West Virginia, North Carolin, and/or eastern Tennessee. Plant material grown in sandy, well-drained soil will not be approved for this project. Wild-collected plant material is not acceptable except in the case of transplanted material within the project site
- Plants shall be true to species and variety and unless specifically noted otherwise, all plants shall be of specimen quality, exceptionally heavy, symmetrical, tightly-knit plants, so trained or favored in their development and appearance as to be superior in form. number of branches, compactness, and symmetry.
- Plants shall be sound, healthy, and vigorous, well branched and densely foliated when in leaf, free of disease, insect pests, eggs or larvae and shall have healthy, well-developed root systems. They shall be free from physical damage or any conditions that would prevent thriving health and the desired appearance
- d. Trees which have a damaged or crooked leader, or multiple leaders, unless specified in the plant list, will be rejected. Trees with abrasion of the bark, sun scald, disfiguring knots, or pruning cuts more than 1 ¼ inch diameter which have not completely callused
- Plants shall conform to measurements specified in the plant schedules except that plants larger than specified may be used if acceptable to the Landscape Architect or owner. Use of such plants shall not increase the contract price. If larger plants are accepted.
- f. Caliper Measurement: Shall be taken at a point on the trunk 6 inches above the natural ground line for trees up to 4 inches diameter, and at a point 12 inches above the natural ground line for trees over 4 inches diameter.
- Plants shall be measured when branches are in the normal position. Height and spread dimensions specified refer to the main body of the plant and not from branch tip to tip.

Preparation of Areas for Planting:

- a. Stake out all plant material beds and tree locations for approval of Landscape Architect or owner prior to any bed preparation.
- b. Shrubs, Shrub Beds, and Hedges on slopes of 3:1 or less: Loosen soil in the area of entire plant bed or hedgerow to a depth of 6 inches minimum with a rototiller. Add soil amendments and rototill again to a depth of 6 inches. Excavate plant pit and hedge trenches a minimum of 12 inches wider than the root ball or bare root on all sides. The depth shall be sufficient to allow shrub to sit 2 inches above finished grade.
- c. Shrub Beds on Slopes of greater than 3:1: Amend soil as above. Spread coir mesh across entire area of shrub bed in steep slope area per manufacturer's specifications. Excavate plant pit through coir mesh a minimum of 12 inches wider than the root ball or bare root on all sides. The depth shall be sufficient to allow shrub to sit 2 inches above finished grade.
- d. Ground Covers and Seasonal Plantings: Loosen soil to a depth of 4 inches minimum with a rototiller. Add amendments to the soil and/or specified planting soil mix and rototill again to a depth of 6 inches. Install plants directly into prepared bed, and firm the soil mix around them.
- e. Groundcover on Slopes of greater than 3:1: Amend soil as above or by hand as required. Spread leaf compost to 2 inches in depth immediately prior to placing coir mesh. Spread coir mesh across entire area of groundcover bed in steep slope area per manufacturer's specifications. Each ground cover shall be placed in an individual planting pit planted through the biodegradable
- Trees: Excavate plant pit walls vertical and scarify sides. Plant pit depth shall be sufficient to allow 2 inch maximum of root ball to be above finished grade. Tree pit shall be 12 inches wider than the ball on all sides.
- 8. Erosion Control Material and Planting on Steep Slopes:
- a. Material meeting the requirements of the specifications shall be installed and maintained on the designated areas as shown and specified. The areas to be covered shall be prepared and fertilized as specified before the erosion material is placed. Immediately prior to the planting operations, the material shall be laid evenly, smoothly, and in contact with the soil throughout.
- b. Lay erosion control materials with 1 inch nominal openings in accordance with manufacturer's instructions. Unroll in direction of water flow. Overlap sheets by at least 6 inches. Where strips are to be spliced lengthwise, overlap strips by 8 inches. Upgrade section shall be on top of all splices.
- c. The Contractor shall maintain and protect the erosion control material until the final inspection. Maintenance shall consist of repairs made necessary by erosion, wind, or any other cause. Following the restoration of damaged areas under plant and turf guarantee and establishment requirements for applicable underlying items, the erosion control material shall be repaired or replaced to meet the original requirements and maintained until the final inspection.

Plant Installation:

- a. Excavation: Excavate all tree pits and planting areas to the width and depth shown in the planting details.
- b. Center plant in pit and orient for the best visual effect. Set plants plumb and hold rigidly in position until soil has been tamped firmly
- c. Mix any soil amendments and fertilizers with existing soil in accordance with soil recommendations for plant type based upon soil test results as approved by Owner. Delay mixing of fertilizer if planting will not occur within a few days.
- d. Backfill pit with planting soil mix, consisting of 2/3 existing soil and 1/3 organic material, and fertilizer, until two-thirds full. Tamp and water each layer thoroughly to settle soil. After soil settles, fill pit with remaining planting soil mix, water and shape surface so that it slopes to drain from trunk and matches ground at edge of planting pit.
- f. Mulch within 48 hours after planting and after applying a pre-emergent herbicide, except ground cover areas (which shall have organic material placed before planting) with a 3 inch layer of mulch immediately after planting. Keep mulch out of the crowns of shrubs and off buildings, sidewalks, light standards, and other structures.
- g. All planting areas shall conform to specified grades after full settlement has occurred and mulch has been applied. Provide saucers around tree pits as shown on planting details. Remove all tags, labels, strings, etc. from all plants.

- a. Coordinate installation of lightweight planting soil mix with the installation of drains, drain pipes, waterproofing, protection board, drainage board and filter fabric. Do not begin any planting soil backfilling operations until irrigation system specified elsewhere is installed. Do not place landscapefill until planters have been approved by Owner and authorization to proceed has been given. Do not damage drainage system and ensure drains are covered with filter fabric when placing soil mix so they do not become clogged.
- Install specified soil in 12" 18" maximum lifts. Compact each lift sufficiently to prevent settling but not enough to prevent the movement of water and feeder roots through the soil. The soils in each lift should feel firm to the foot in all areas and only make
- c. During placement of lightweight planting soil mix over structure, contractor shall take great care to ensure proper drainage with said soil after placement and compaction
- When new lightweight planting soil is added to areas of existing soil, contractor shall ensure that new soil is progressively mixed to existing soil so as not have distinct separate/divided soil lenses.


Permanent Sodding for Grass Lawn Areas:

- a. Unless otherwise specified by these plans, all disturbed areas within the limits of clearing and grading shall be planted as lawn with
- b. Lawn sod varieties shall be an improved variety turf-type tall fescue blend. The Landscape Contractor shall select from varieties approved by the Maryland or Virginia Department of Agriculture. c. Refer to the Virginia Erosion and Sediment Control Handbook for guidelines, specifications, and installation techniques of sod
- d. Maintenance shall begin immediately after each lawn area is installed and shall continue until 90 days after final acceptance of the last section.

HARDWOOD STAKE - STAKE ATTACHMENT - ROOT BALL TREE PLANTING WELL PLAN VIEW N.T.S. STAKE ATTACHMENT METHOD ACCEPTED PER LANDSCAPE CONTRACTORS ASSOCIATION OR 2"X2"X8' HARDWOOD STAKES SET OUTSIDE OF ROOTBALL SURVEYOR'S FLAG CENTER TREE IN WELL. MULCH RING TRUNK FLARE SHALL BE (6 FT.) Ø MIN. VISIBLE. 3 IN. MULCH; MULCH -MUST BE 6" AWAY 4 IN. HIGH EARTH FROM TREE TRUNK SAUCER BEYOND EDGE OF ROOT BALL ROUGHEN SIDES OF PLANTING HOLE AND - REMOVE ALL TWINE MIXTURE FOR ENTIRE BURLAP FROM THE TREE WELL AREA X ROOTBALL DEPTH ROOT BALL TAMP SOIL UNDER ROOT SOIL AMENDED BALL BASE: COMPACTED W/ORGANIC MATERIAL O 80% STD. PROCTOR FIRM IN 8" LIFTS MIN WIDTH OF TREE WELL 2 THAT ROOT BALL DOES NOT SINK TIMES ROOTBALL DIAMETER OR 5'-0", WHICHEVER IS GREATER - UNDISTURBED SUBGRADE **NOTES**

- 1. AT PLANTING PRUNE ONLY CROSSING LIMBS, BROKEN OR DEAD BRANCHES, AND ANY BRANCHES THAT POSE A HAZARD TO PEDESTRIANS PER ANSI STANDARDS A300. DO NOT PRUNE INTO OLD WOOD ON EVERGREENS.
- 2. CONTRACTOR SHALL MAXIMIZE EXCAVATED AREA FOR TREE WELL WITHOUT ADVERSELY IMPACTING ADJACENT SITE FEATURES
- 4. UNLESS OTHERWISE DIRECTED BY PROJECT SPECIFICATIONS OR CITY STAFF, SOIL MIXTURE SHALL BE CLEANED OF DEBRIS, AND MEET SOIL COMPOSITION REQUIREMENTS OF CITY OF ALEXANDRIA LANDSCAPE GUIDELINES. 5. TREES PLANTED WITHOUT THE TRUNK FLARE VISIBLE WILL BE REJECTED.
- 6. ALL PLANTS MUST BE WATERED AT INSTALLATION AND AGAIN WITHIN 48-HOURS OF INSTALLATION, ESTABLISHMENT WATERING SHALL BE PER THE SPECIFICATIONS ON ALL DETAILS.
- 7. STAKES WILL BE INSTALLED USING ARBORICULTURE PRACTICES, TREES SHALL STAND PLUM AFTER STAKING.
- 8. INSTALLATION WILL INCLUDE THE REMOVAL OF ALL STAKING MATERIAL ONE YEAR AFTER INSTALLATION. ANY HOLES LEFT BY REMOVING STAKING SHALL BE FILLED WITH APPROVED TOPSOIL / BACKFILL MIXTURE.
- CONTRACTOR SHALL USE GALVANIZED EYESCREW & TURNBUCKLE INSTEAD OF ARBOR TIE ONLY FOR TREES OF

DECIDUOUS TREE PLANTING

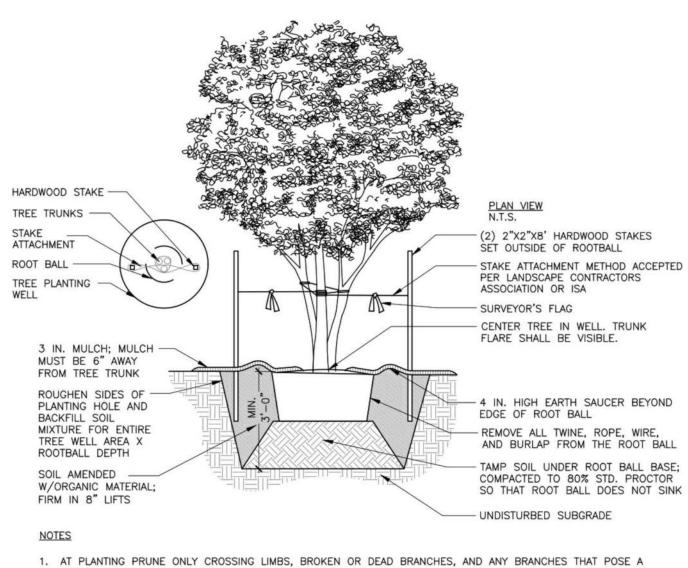

- HAZARD TO PEDESTRIANS PER ANSI STANDARDS A300. DO NOT PRUNE INTO OLD WOOD ON EVERGREENS.
- 2. CONTRACTOR SHALL MAXIMIZE EXCAVATED AREA FOR TREE WELL WITHOUT ADVERSELY IMPACTING ADJACENT SITE
- 4. UNLESS OTHERWISE DIRECTED BY PROJECT SPECIFICATIONS OR CITY STAFF, SOIL MIXTURE SHALL BE CLEANED OF DEBRIS, AND MEET SOIL COMPOSITION REQUIREMENTS OF CITY OF ALEXANDRIA LANDSCAPE GUIDELINES
- 6. ALL PLANTS MUST BE WATERED AT INSTALLATION AND AGAIN WITHIN 48-HOURS OF INSTALLATION, ESTABLISHMENT
- 7. STAKES WILL BE INSTALLED USING ARBORICULTURE PRACTICES, TREES SHALL STAND PLUM AFTER STAKING.
- 8. INSTALLATION WILL INCLUDE THE REMOVAL OF ALL STAKING MATERIAL ONE YEAR AFTER INSTALLATION. ANY HOLES LEFT BY REMOVING STAKING SHALL BE FILLED WITH APPROVED TOPSOIL / BACKFILL MIXTURE.
- 9. CONTRACTOR SHALL USE GALVANIZED EYESCREW & TURNBUCKLE INSTEAD OF ARBOR TIE ONLY FOR TREES OF SIGNIFICANT SIZE AS DIRECTED BY CITY STAFF.

MULTI-STEM TREE PLANTING

5. TREES PLANTED WITHOUT THE TRUNK FLARE VISIBLE WILL BE REJECTED.

WATERING SHALL BE PER THE SPECIFICATIONS ON ALL DETAILS.



7712 Little River Turnpike Annandale, Virginia 22003 TEL 703.642.8080 FAX 703.642.8251 www.urban-ltd.com



WOODBINE PROPERTY 1 LLC

Brick, NJ 08724

1608 Route 88, Suite 301

Contact: Peter Modri

Revision / Issue lo. Description

Description 1ST SUB.-COMPLETENESS 7/21/2022 8/19/2022 1ST SUB.-COMPLETENESS 9/20/2022 1ST SUB.-COMPLETENESS

Project Name

WOODBINE **PRELIMINARY** DEVELOPMENT SITE PLAN

DSUP 2022-10014

Checked By

City of Alexandria Alexandria, Virginia

> DTM Project No. ZP-13088

Date SEPT. 20, 2022

Drawing Title

Lic. No. 1957

LANDSCAPE DETAILS

Scale: N/A

Drawing Number

Sheet 20

- LANDSCAPE PLAN NOTES The property owner and/or applicant, specifier, contractor and installer of plant material are responsible for understanding and adhering to the standards set forth in the most recent version of the city of Alexandria Landscape Guidelines and applicable conditions of approval. All questions regarding application of, or adherence to, the standards and/or conditions of approval shall be directed to the city prior to commencement of demolition, construction, or any land disturbing activity.
- The City-approved city-approved landscape plan submission, including plant schedule, notes and details shall be the document used for installation purposes and all procedures set forth in the landscape guidelines must be followed. The contractor contractor shall not interfere with any tree protection measures or impact any existing vegetation identified to be preserved per the
- approved tree and vegetation protection plan. 4. Any changes, alterations or modifications to the site conditions that affect vegetation protection zones will require an amendment to the approved tree and vegetation protection plan and/or details. Installation of plant material may only occur during the planting seasons identified in the landscape guidelines.
- In lieu of more strenuous specifications, all landscape related work shall be installed and maintained in accordance with the current and most up-to-date edition (at time of construction) of Landscape Specification Guidelines as produced by the Landscape Contractors Association of
- Maryland, District of Columbia and Virginia; Gaithersburg, Maryland. Substitutions to the approved plant material shall not occur until written approval is provided by the City. Maintenance for this project shall be performed by the owner, applicant, successor(s) and/or assign(s) in perpetuity and in compliance with City of
- Alexandria Landscape Guidelines and as conditioned by project approval, as applicable. The approved method(s) of protection must be in place for all vegetation to be preserved on-site and adjacent to the project site pursuant to the approved tree and vegetation protection plan and details prior to commencement of demolition, construction, or any land disturbance. The applicant shall notify the Planning & Zoning (P&Z) project manager once the tree protection methods are in place. No demolition, construction, or land
- disturbance may occur until an inspection is performed by the City and written confirmation is provided by the City which verifies correct installation of the tree protection measures 10. The applicant must contact the P&Z project manager prior to commencement of landscape installation/planting operation to schedule a
- pre-installation meeting. The meeting should be held between the applicant's general contractor, landscape contractor, landscape architect, the P&Z project manager and the City Arborist (as applicable) to review the scope of installation procedures and processes during and after installation. 11. The following information shall be provided to the P&Z project manager at least five (5) business days prior to the landscape pre-installation
- 1) a letter that certifies that the project landscape architect performed pre-selection tagging for all trees proposed within the public right of way and on public land prior to installation. This letter must be signed and sealed by the project landscape architect, and
- 2) a copy of the soil bulk density test report verifying that maximum compression rates are met. 12. All construction waste shall be removed prior to planting.
- 13. As-built drawings for this landscape and/or irrigation/water management system will be provided in compliance with City of Alexandria Landscape Guidelines, the City Code of Ordinances, and all applicable plan preparation checklists. As-built drawings shall include clear identification of all
- variation(s) and changes from approved drawings including location, quantity and specification of all project elements. 14. Areas of bare soil will not be accepted. Mulched areas and planting areas shall be weed free upon acceptance of the project by the City.

THE APPLICANT/DEVELOPER SHALL CALL ALEXANDRIA ARCHAEOLOGY IMMEDIATELY (703-746-4399) IF ANY BURIED STRUCTURAL REMAINS (WALL FOUNDATIONS, WELLS, PRIVIES, CISTERNS, ETC.) OR CONCENTRATIONS OF ARTIFACTS ARE DISCOVERED DURING DEVELOPMENT. WORK MUST CEASE IN THE AREA OF THE DISCOVERY UNTIL A CITY ARCHAEOLOGIST COMES TO THE SITE AND RECORDS THE FINDS. THE APPLICANT/DEVELOPER SHALL NOT ALLOW ANY METAL DETECTION TO B CONDUCTED ON THE PROPERTY, UNLESS AUTHORIZED BY ALEXANDRIA

ALL REQUIRED ARCHAEOLOGICAL PRESERVATION MEASURES SHALL BE

COMPLETED IN COMPLIANCE WITH SECTION 11-411 OF THE ZONING ORDINANCE

ARCHAEOLOGY.


SITE PLAN NO. DIRECTOR CHAIRMAN, PLANNING COMMISSION DATE RECORDED INSTRUMENT NO. DEED BOOK NO. PAGE NO.

DEPARTMENT OF TRANSPORTATION & ENVIRONMENTAL SERVICES

APPROVED

SPECIAL USE PERMIT NO.

DEPARTMENT OF PLANNING & ZONING

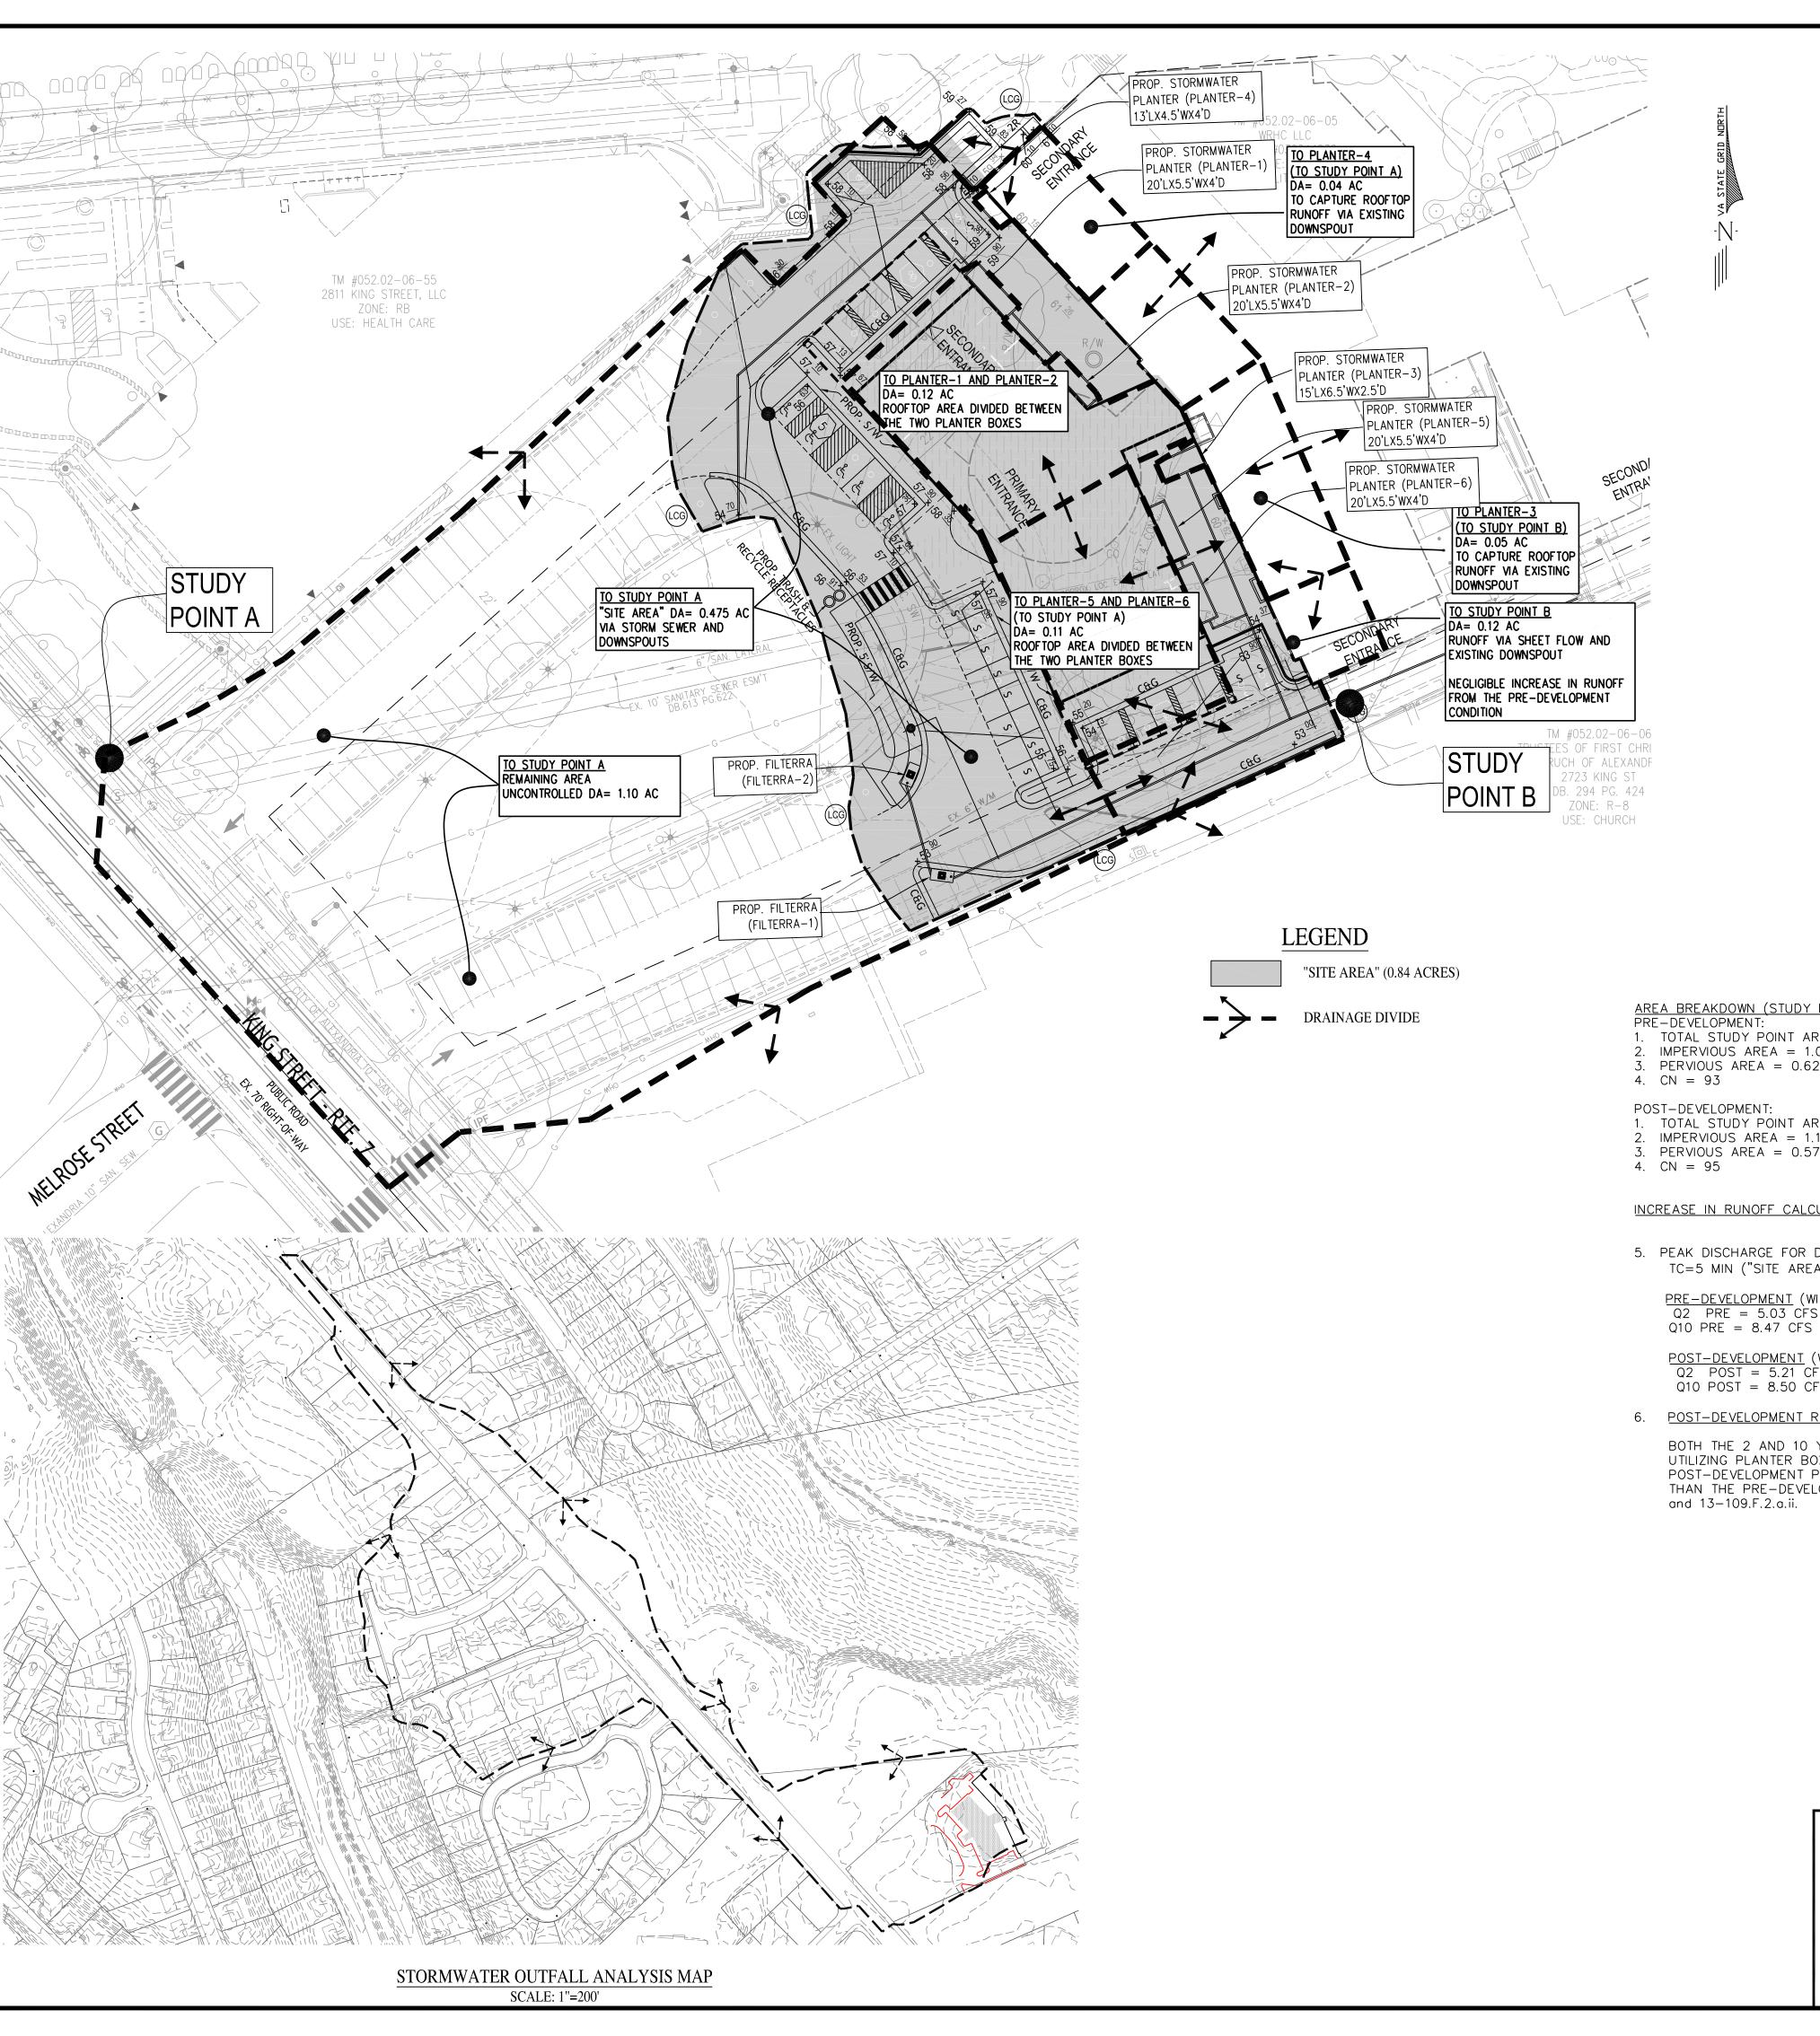

STORM WATER MANAGEMENT/BMP NARRATIVE

THE "SITE AREA", TO BE UTILIZED FOR WATER QUALITY PURPOSES, IS DEFINED AS THE DISTURBED AREA AS WELL AS THE FRONT SIDE OF THE EXISTING BUILDING TO THE NORTHEAST OF THE SITE AS SHOWN ON THE MAP ON THIS SHEET. THIS AREA IS CALCULATED TO BE 0.83 ACRES. FOR WATER QUANTITY PURPOSES, THE TOTAL DRAINAGE AREA TO THE RESPECTIVE STUDY POINT IS ANALYZED IN THE PRE- AND POST-DEVELOPMENT CONDITION.

THE 0.83 AC SITE IS LOCATED ON THE EAST SIDE OF KING STREET ABOUT 750' NORTH OF ITS INTERSECTION WITH JANNEY'S LANE. THE SITE IS LOCATED IN TAYLOR RUN WATERSHED AND HAS THE HYDROLOGIC SOIL GROUP D. SITE RUNOFF FROM THE PROPOSED IMPROVEMENTS WILL FOLLOW THE EXISTING DRAINAGE DIVIDES OF THE SITE. RESULTING IN TWO (2) CONCENTRATED OUTFALL POINTS (STUDY POINT A AND STUDY POINT B). THIS CONCEPT PLAN PROPOSES CONSTRUCTION OF A THREE STORY REHABILITATION FACILITY, PARKING AND DRIVE AISLES. THE PROPOSED IMPROVEMENTS RESULT IN A SLIGHT INCREASE IN IMPERVIOUS AREA AS WELL AS OUTFALLS INTO A MANMADE SYSTEM AT BOTH STUDY POINTS. THEREFORE, CHANNEL PROTECTION WILL BE ACHIEVED PER 13-109.F.1.a.i AND FLOOD PROTECTION PER 13-109.F.2.a.i/ii.

STUDY POINT A:

A PORTION OF THE RUNOFF TO STUDY POINT A WILL BE COLLECTED INTO THREE (3) BMP PLANTER BOX FACILITIES (PLANTER-1 AND PLANTER-2, AND PLANTER-3) TO CAPTURE A LARGE PORTION OF THE ROOF RUNOFF FROM THE PROPOSED BUILDING, AS SHOWN ON THE MAP ON THIS SHEET. THE PLANTER BOX FACILITIES WILL OUTFALL VIA UNDERDRAIN TO THE EXISTING GRASS AREA TO THE WEST OF THE PROPOSED IMPROVEMENTS. THE THREE (3) PLANTER BOX FACILITIES ARE DESIGNED TO MEET WATER QUALITY REQUIREMENTS FOR THE "SITE AREA" AS WELL AS PROVIDE DETENTION CAPABILITIES TO ACHIEVE THE CHANNEL AND FLOOD PROTECTION REQUIREMENTS. FURTHERMORE, TWO (2) FILTERRA DEVICES (FILTERRA-1 AND -2) ARE PROPOSED TO MEET ADDITIONAL WATER QUALITY REQUIREMENTS. THE FINAL ANALYSIS WILL RESULT IN A DECREASED RUNOFF OF THE 10-YEAR STORM FROM THE PRE-DEVELOPMENT CONDITION PER 13-109.F.1.a.i. ONCE THE RUNOFF REACHES STUDY POINT A, THE RUNOFF TRAVELS VIA MAN-MADE CONVEYANCE SYSTEMS AND ULTIMATELY ENTERS THE TAYLOR RUN FLOODPLAIN. AT THIS POINT IS THE LIMIT OF ANALYSIS PER 13-109.F.1.d.i, WHERE THE SITE'S CONTRIBUTING DRAINAGE AREA IS LESS THAN OR EQUAL TO 1% OF THE TOTAL WATERSHED. THIS CRITERIA FOR THE LIMIT OF ANALYSIS IS THE SAME FOR BOTH CHANNEL AND FLOOD PROTECTION.

STUDY POINT B:

THE RUNOFF TO STUDY POINT B HAS A SLIGHT INCREASE IN IMPERVIOUS AREA. TO ACCOMMODATE THIS INCREASED RUNOFF THREE (3) PLANTER BOX FACILITIES (PLANTER-4, -5, AND -6) ARE PROPOSED TO CAPTURE A PORTION OF THE ROOF RUNOFF OF THE EXISTING BUILDING, AS WELL AS THE EASTERN HALF OF THE PROPOSED BUILDING, AS SHOWN ON THE MAP ON THIS SHEET. PLANTER-4, -5, AND-6 WILL OUTFALL VIA UNDERDRAIN AND CONNECT INTO THE EXISTING STORM SEWER SYSTEM THAT OUTFALLS TO THE EAST OF THE PROPOSED IMPROVEMENTS TO AN EXISTING EXTENDED DETENTION POND. PLANTER-4, -5, AND -6 IS DESIGNED TO MEET WATER QUALITY REQUIREMENTS FOR THE "SITE AREA" AS WELL AS PROVIDE DETENTION CAPABILITIES TO ACHIEVE A NO/NEGLIGIBLE INCREASE IN RUNOFF TO STUDY POINT B. STUDY POINT B ULTIMATELY OUTFALLS INTO AN EXISTING DETENTION POND THAT HAS BEEN DESIGNED TO CONVEY THE DEVELOPED SITE, IT IS THE OPINION OF THE SIGNING ENGINEER THAT THE ANALYSIS IS COMPLETE DUE TO NO INCREASE

PRELIMINARY WATER QUALITY COMPUTATIONS ARE PREPARED BASED ON THE NEW STORMWATER REGULATIONS PER THE CITY'S ENVIRONMENTAL MANAGEMENT ORDINANCE EFFECTIVE JULY 1, 2014. THE VIRGINIA RUNOFF REDUCTION METHOD COMPLIANCE SPREAD SHEET WAS USED TO DETERMINE THE PHOSPHOROUS REMOVAL AND RUNOFF VOLUME REQUIREMENTS OF THE SITE SWM/BMP DRAINAGE AREA MAP ARE SHOWN SHEET 22A AND COMPUTATIONS AND DETAILS ARE SHOWN ON SHEETS 23-24.

AS SHOWN IN THE COMPUTATIONS ON SHEET 23, THE PROPOSED WATER QUALITY DEVICES ACHIEVE 100% AND EXCEED THE REQUIRED PHOSPHORUS REMOVAL (0.64 LB/YR OF THE 0.38 LBS/YR). FURTHERMORE, THE ALEXANDRIA WATER QUALITY VOLUME DEFAULT COMPUTATIONS ARE PROVIDED ON SHEET 22A CONFIRMING THE REQUIREMENTS ARE MET PER 13-109.E.9. A CONTRIBUTION TO THE CITY'S WATER QUALITY IMPROVEMENT FUNDS WILL BE PAID.

STORMWATER RUNOFF CALCULATIONS

AREA BREAKDOWN (STUDY POINT A)

- 1. TOTAL STUDY POINT AREA = 73.877.76 SQ.FT. OR 1.696 ACRES
- IMPERVIOUS AREA = 1.07 ACRES
- PERVIOUS AREA = 0.626

POST-DEVELOPMENT:

- 1. TOTAL STUDY POINT AREA = 75,751 SQ.FT. OR 1,739 ACRES
- IMPERVIOUS AREA = 1.164 ACRES 3. PERVIOUS AREA = 0.575

INCREASE IN RUNOFF CALCULATION FOR THIS APPLICATION

5. PEAK DISCHARGE FOR DESIGN STORMS PER SCS METHOD TC=5 MIN ("SITE AREA"), TC=10 MIN (PASS-THRU)

PRE-DEVELOPMENT (WITHOUT DETENTION)
Q2 PRE = 5.03 CFS

POST-DEVELOPMENT (WITHOUT DETENTION)
Q2 POST = 5.21 CFS Q10 POST = 8.50 CFS

POST-DEVELOPMENT RUNOFF (WITH DETENTION)

BOTH THE 2 AND 10 YEAR STORMS WILL BE DETAINED UTILIZING PLANTER BOX FACILITIES SUCH THAT THE POST-DEVELOPMENT PEAK FLOWS ARE EQUAL TO OR LESS THAN THE PRE-DEVELOPMENT PEAK FLOWS PER 13-109.F.1.a.i and 13-109.F.2.a.ii.

THE APPLICANT/DEVELOPER SHALL CALL ALEXANDRIA ARCHAEOLOGY

SITE AND RECORDS THE FINDS.

ARCHAEOLOGY.

IMMEDIATELY (703-746-4399) IF ANY BURIED STRUCTURAL REMAINS (WALL

THE AREA OF THE DISCOVERY UNTIL A CITY ARCHAEOLOGIST COMES TO THE

THE APPLICANT/DEVELOPER SHALL NOT ALLOW ANY METAL DETECTION TO BE

COMPLETED IN COMPLIANCE WITH SECTION 11-411 OF THE ZONING ORDINANCE

CONDUCTED ON THE PROPERTY, UNLESS AUTHORIZED BY ALEXANDRIA

ALL REQUIRED ARCHAEOLOGICAL PRESERVATION MEASURES SHALL BE

FOUNDATIONS, WELLS, PRIVIES, CISTERNS, ETC.) OR CONCENTRATIONS OF ARTIFACTS ARE DISCOVERED DURING DEVELOPMENT. WORK MUST CEASE IN

AREA BREAKDOWN (STUDY POINT B)

- PRE-DEVELOPMENT: TOTAL STUDY POINT AREA = 6,316 SQ.FT. OR 0.145 ACRES IMPERVIOUS AREA = 0.084 ACRES PERVIOUS AREA = 0.061
- POST-DEVELOPMENT:

4. CN = 90

- TOTAL STUDY POINT AREA = 12,458.16 SQ.FT. OR 0.286 ACRES
- IMPERVIOUS AREA = 0.24 ACRES PERVIOUS AREA = 0.046
- 4. CN = 96

Q2 PRE = 0.48 CFS

INCREASE IN RUNOFF CALCULATION FOR THIS APPLICATION

1. PEAK DISCHARGE FOR DESIGN STORMS PER SCS METHOD

(ASSUME TC=5 MIN) PRE-DEVELOPMENT (WITHOUT DETENTION)

> Q10 PRE = 0.82 CFS POST-DEVELOPMENT (WITHOUT DETENTION) Q2 POST = 0.80 CFS

Q10 POST = 1.25 CFS

POST-DEVELOPMENT RUNOFF (WITH DETENTION)

APPROVED

SITE PLAN NO.

DATE RECORDED

INSTRUMENT NO.

SPECIAL USE PERMIT NO.

DIRECTOR

CHAIRMAN, PLANNING COMMISSION

DEPARTMENT OF PLANNING & ZONING

DEPARTMENT OF TRANSPORTATION & ENVIRONMENTAL SERVICES

DEED BOOK NO.

PAGE NO.

BOTH THE 2 AND 10 YEAR STORMS WILL BE DETAINED UTILIZING A PLANTER BOX FACILITY SUCH THAT THE POST-DEVELOPMENT PEAK FLOWS HAVE A NEGLIGIBLE INCREASE OR DO NOT EXCEED PRE-DEVELOPMENT PEAK FLOWS PER 13-109.F.1.a.i and 13-109.F.2.a.ii..

7712 Little River Turnpike Annandale, Virginia 22003 TEL 703.642.8080 FAX 703.642.825 www.urban-ltd.com



WOODBINE PROPERTY 1 LLC

1608 Route 88, Suite 301 Brick, NJ 08724

Contact: Peter Modri

Revision / Issue

No. Description

Description 1ST SUBMISSION 6/3/2022 1ST SUB.-COMPLETENESS 8/19/2022 1ST SUB.-COMPLETENESS 9/20/2022 1ST SUB.-COMPLETENESS

Project Name

WOODBINE **PRELIMINARY** DEVELOPMENT SITE PLAN

DSUP 2022-10014

City of Alexandria Alexandria, Virginia

Drawn By Checked By DTM

Project No. ZP-13088

Date SEPT. 20, 2022


Drawing Title **ENVIRONMENTAL**


STORMWATER PLAN

Scale: 1" = 30'

Drawing Number


Sheet 21 of 27

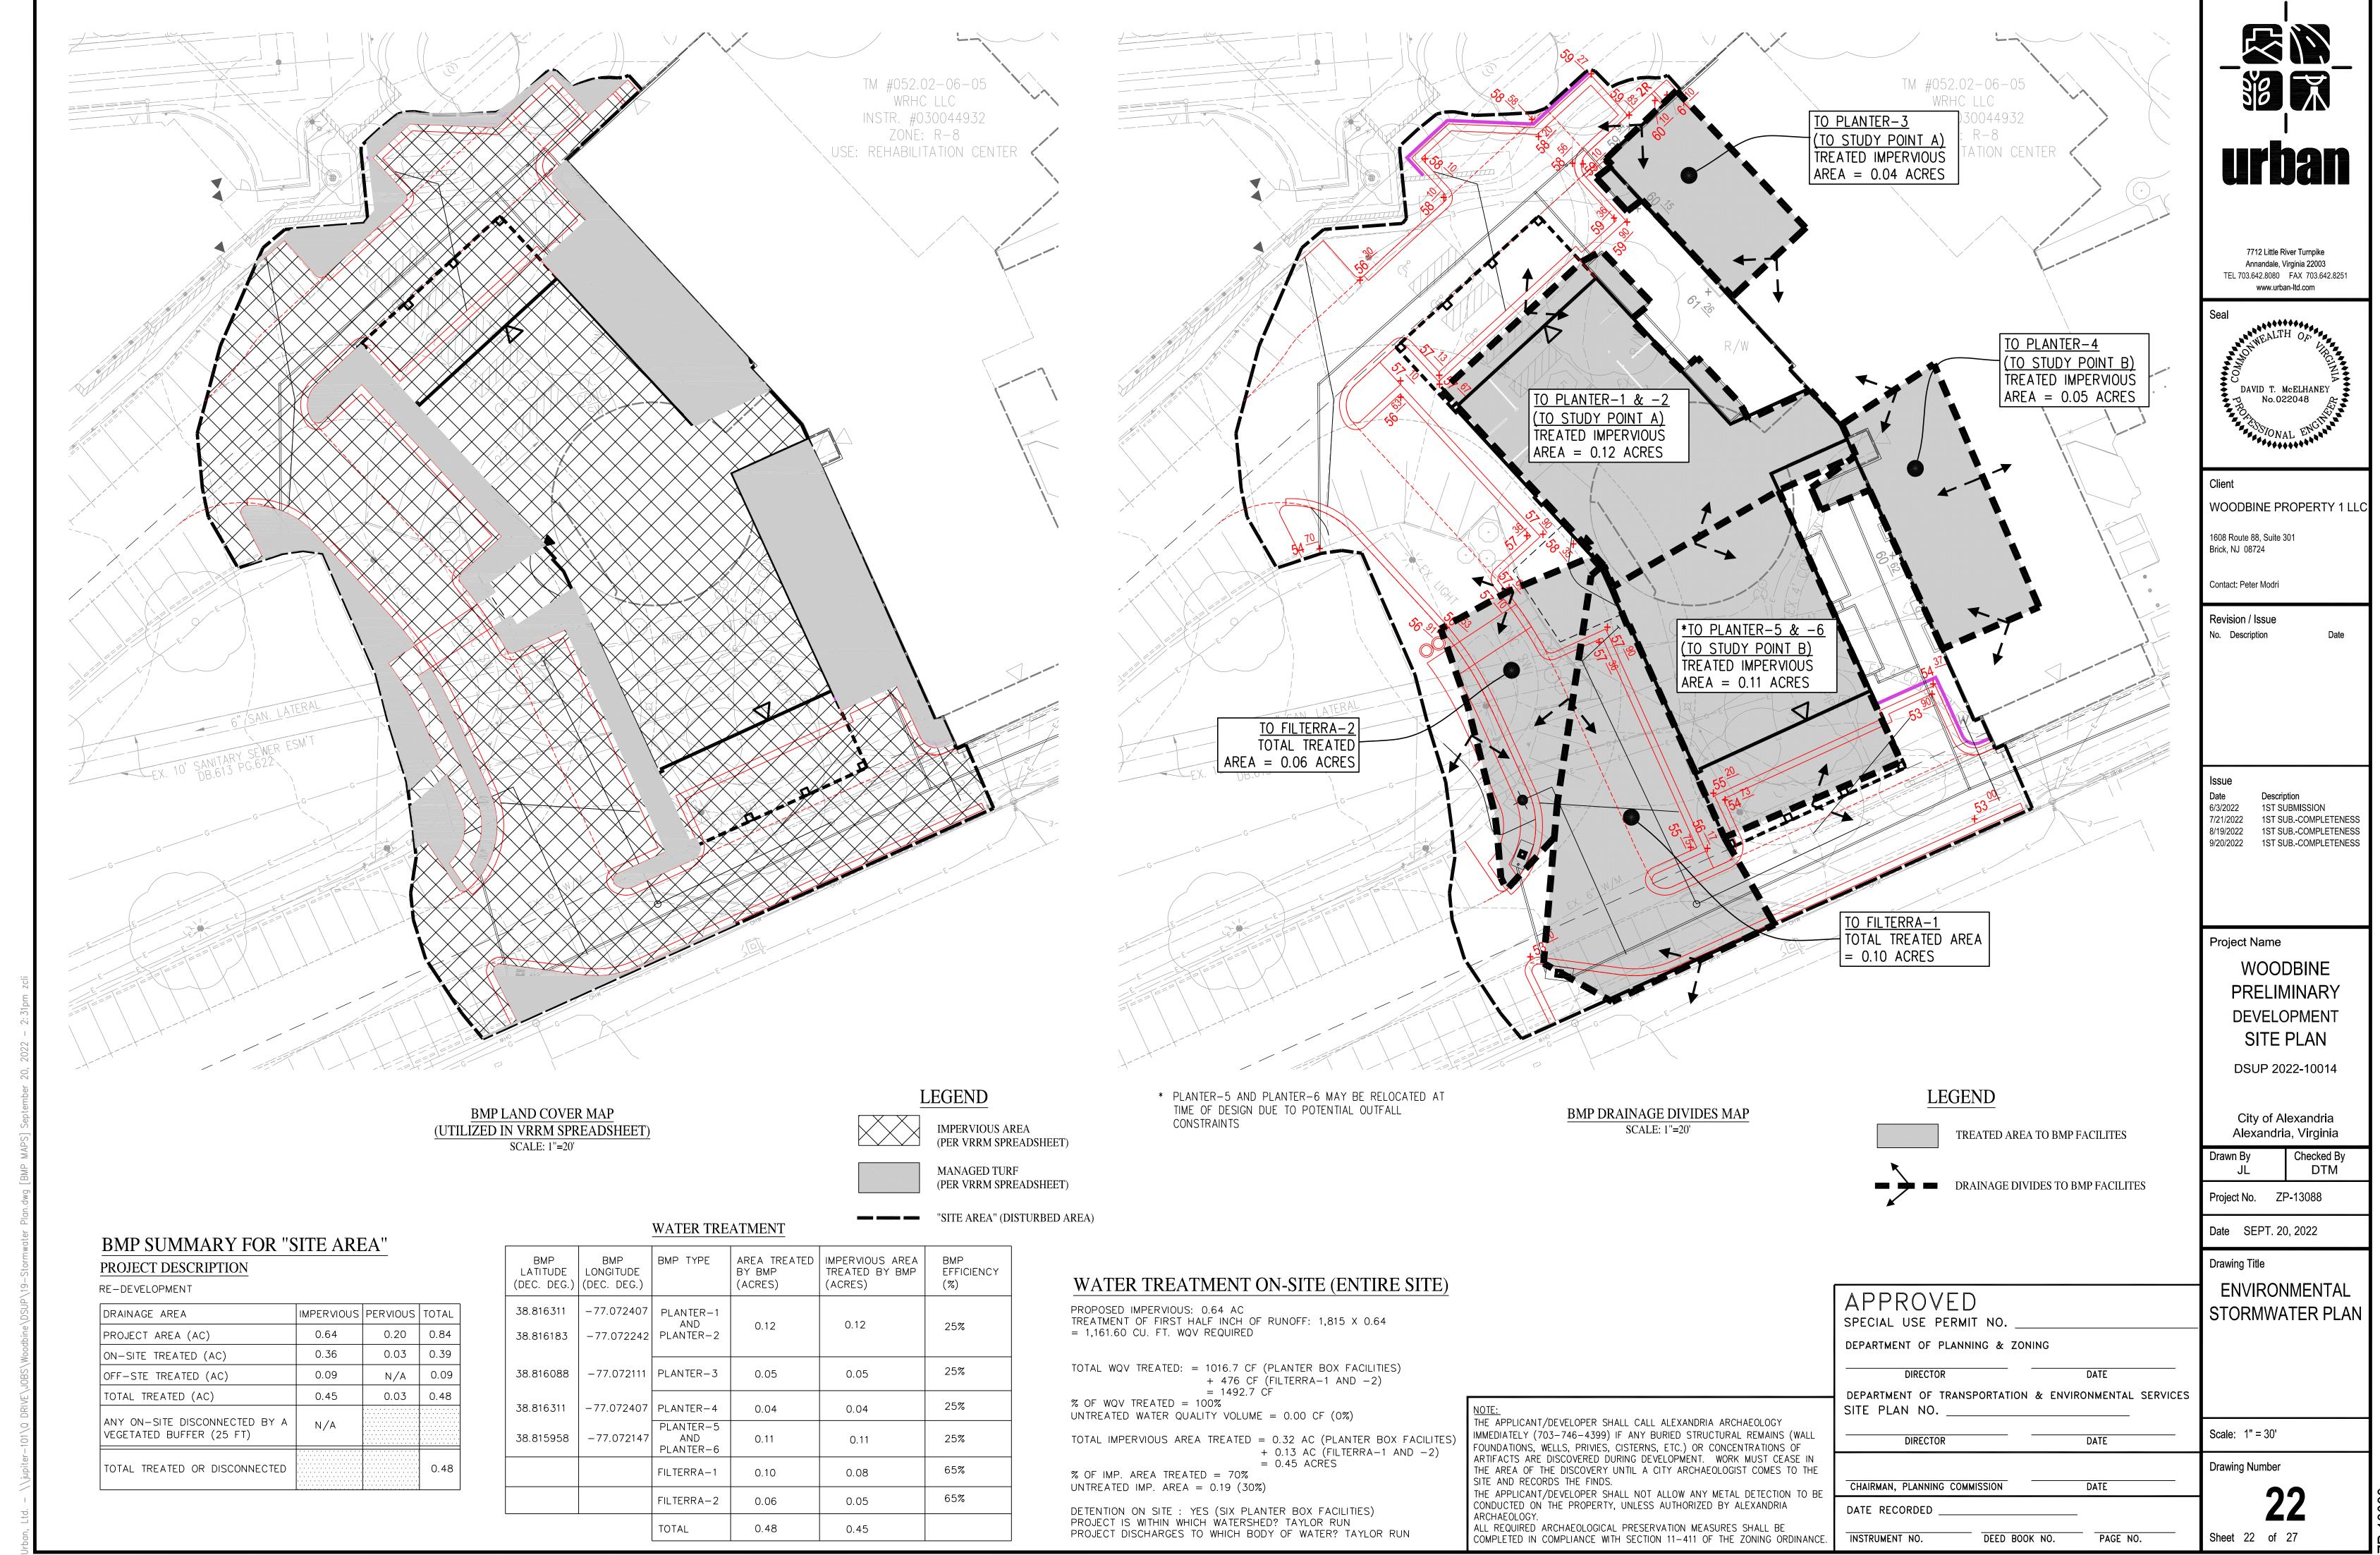

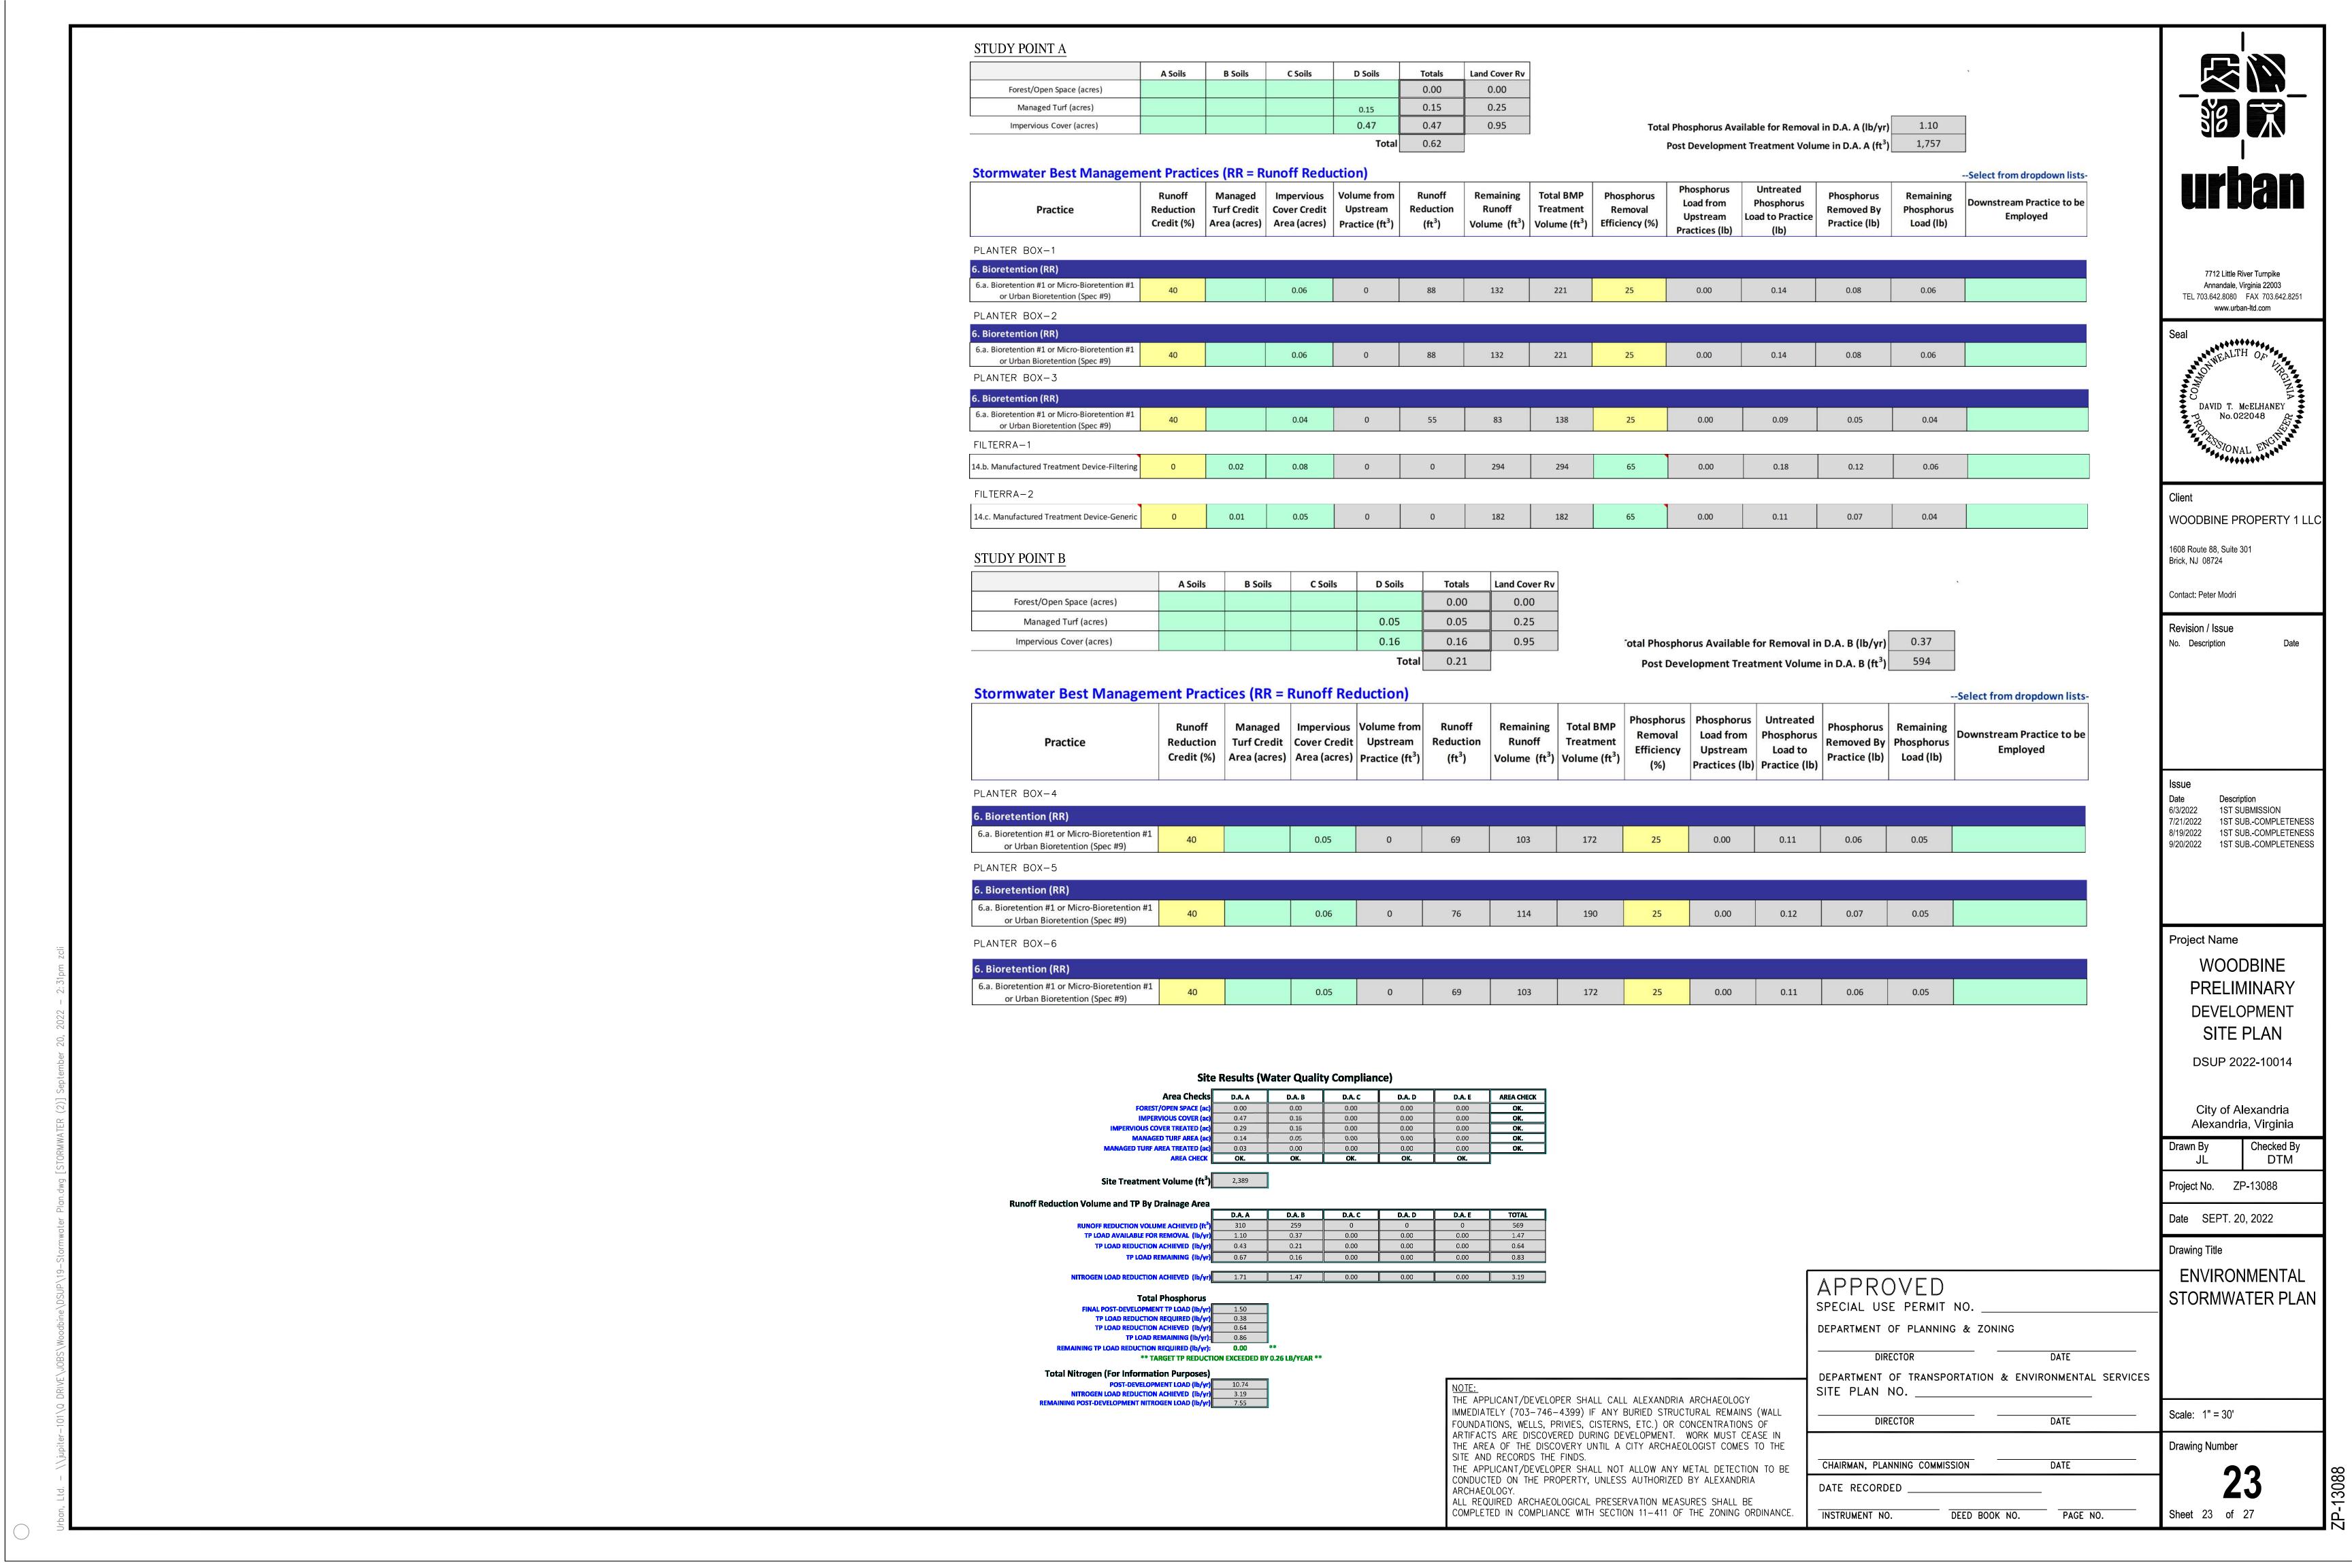


PROPOSED FILTERRA DETAIL


(FILTERRA-1 AND FILTERRA-2)

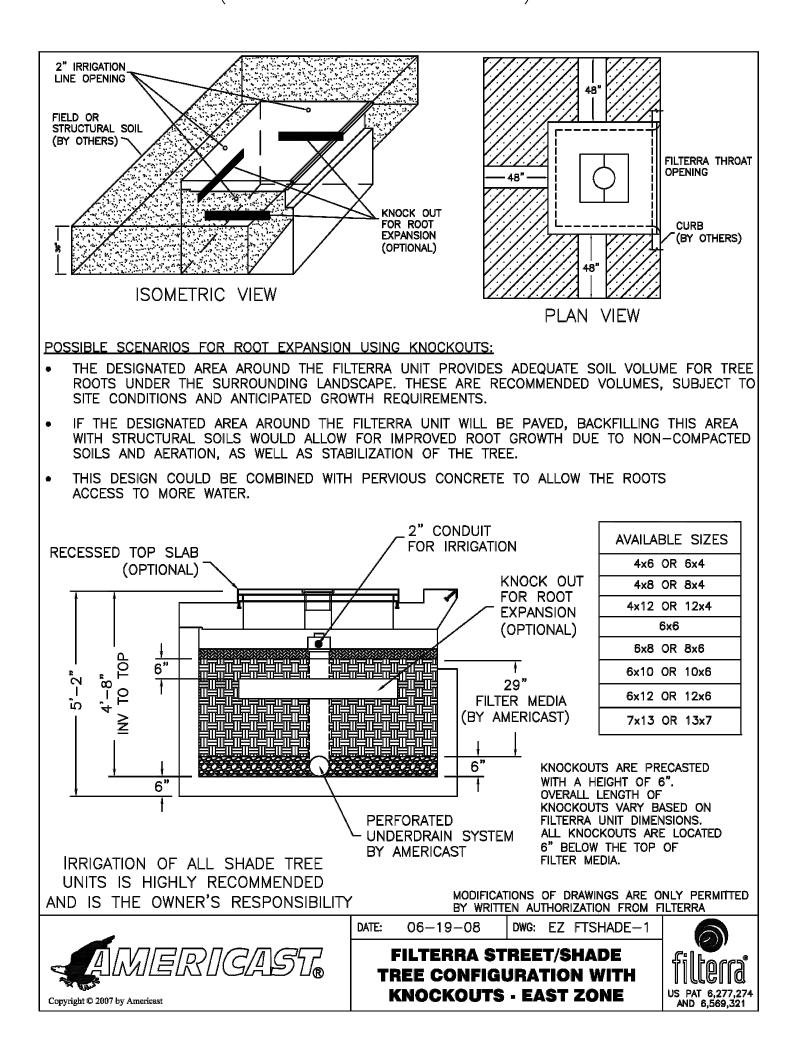

PROPOSED PLANTER BOX DETAIL (TYP.)

(PLANTER-1 THRU PLANTER-6)

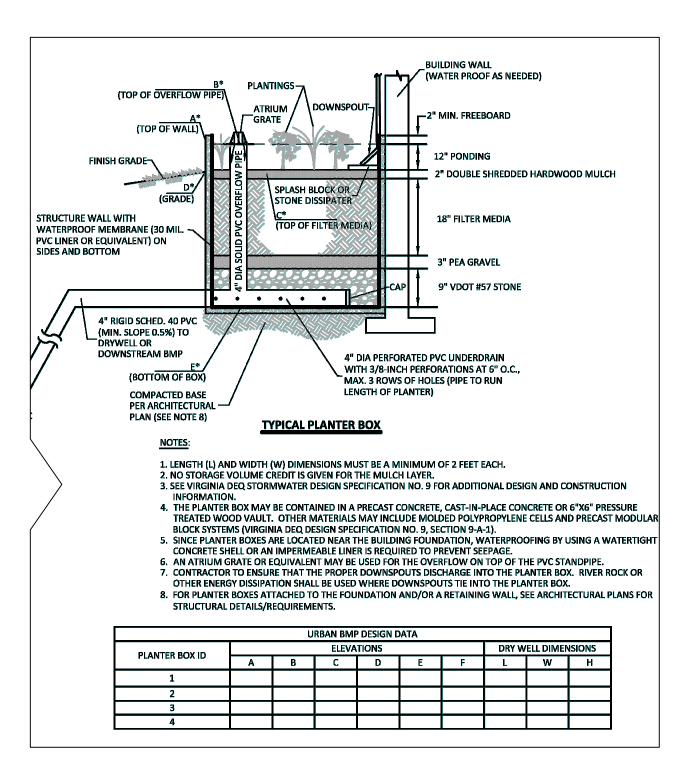

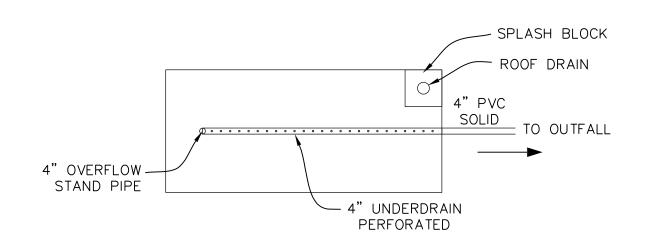

PLANTER BOX TOP VIEW
(NTS)

THE APPLICANT/DEVELOPER SHALL CALL ALEXANDRIA ARCHAEOLOGY

CONDUCTED ON THE PROPERTY, UNLESS AUTHORIZED BY ALEXANDRIA

ALL REQUIRED ARCHAEOLOGICAL PRESERVATION MEASURES SHALL BE

SITE AND RECORDS THE FINDS.

ARCHAEOLOGY.

IMMEDIATELY (703-746-4399) IF ANY BURIED STRUCTURAL REMAINS (WALL

THE AREA OF THE DISCOVERY UNTIL A CITY ARCHAEOLOGIST COMES TO THE

THE APPLICANT/DEVELOPER SHALL NOT ALLOW ANY METAL DETECTION TO BE

COMPLETED IN COMPLIANCE WITH SECTION 11-411 OF THE ZONING ORDINANCE.

FOUNDATIONS, WELLS, PRIVIES, CISTERNS, ETC.) OR CONCENTRATIONS OF ARTIFACTS ARE DISCOVERED DURING DEVELOPMENT. WORK MUST CEASE IN

7712 Little River Turnpike Annandale, Virginia 22003 TEL 703.642.8080 FAX 703.642.8251 www.urban-ltd.com



Client

WOODBINE PROPERTY 1 LLC

1608 Route 88, Suite 301 Brick, NJ 08724

Contact: Peter Modri

Revision / Issue

No. Description

Issue

 Date
 Description

 6/3/2022
 1ST SUBMISSION

 7/21/2022
 1ST SUB.-COMPLETENESS

 8/19/2022
 1ST SUB.-COMPLETENESS

 9/20/2022
 1ST SUB.-COMPLETENESS

Project Name

WOODBINE PRELIMINARY DEVELOPMENT SITE PLAN

DSUP 2022-10014

City of Alexandria

DTM

Alexandria, Virginia

Drawn By

Checked By

Project No. ZP-13088

Date SEPT. 20, 2022

Drawing Title

ENVIRONMENTAL STORMWATER PLAN

DIRECTOR DATE

APPROVED

SPECIAL USE PERMIT NO.

CHAIRMAN, PLANNING COMMISSION

DATE RECORDED

INSTRUMENT NO.

DEPARTMENT OF PLANNING & ZONING

DEPARTMENT OF TRANSPORTATION & ENVIRONMENTAL SERVICES SITE PLAN NO. _____

DEED BOOK NO.


DIRECTOR DATE


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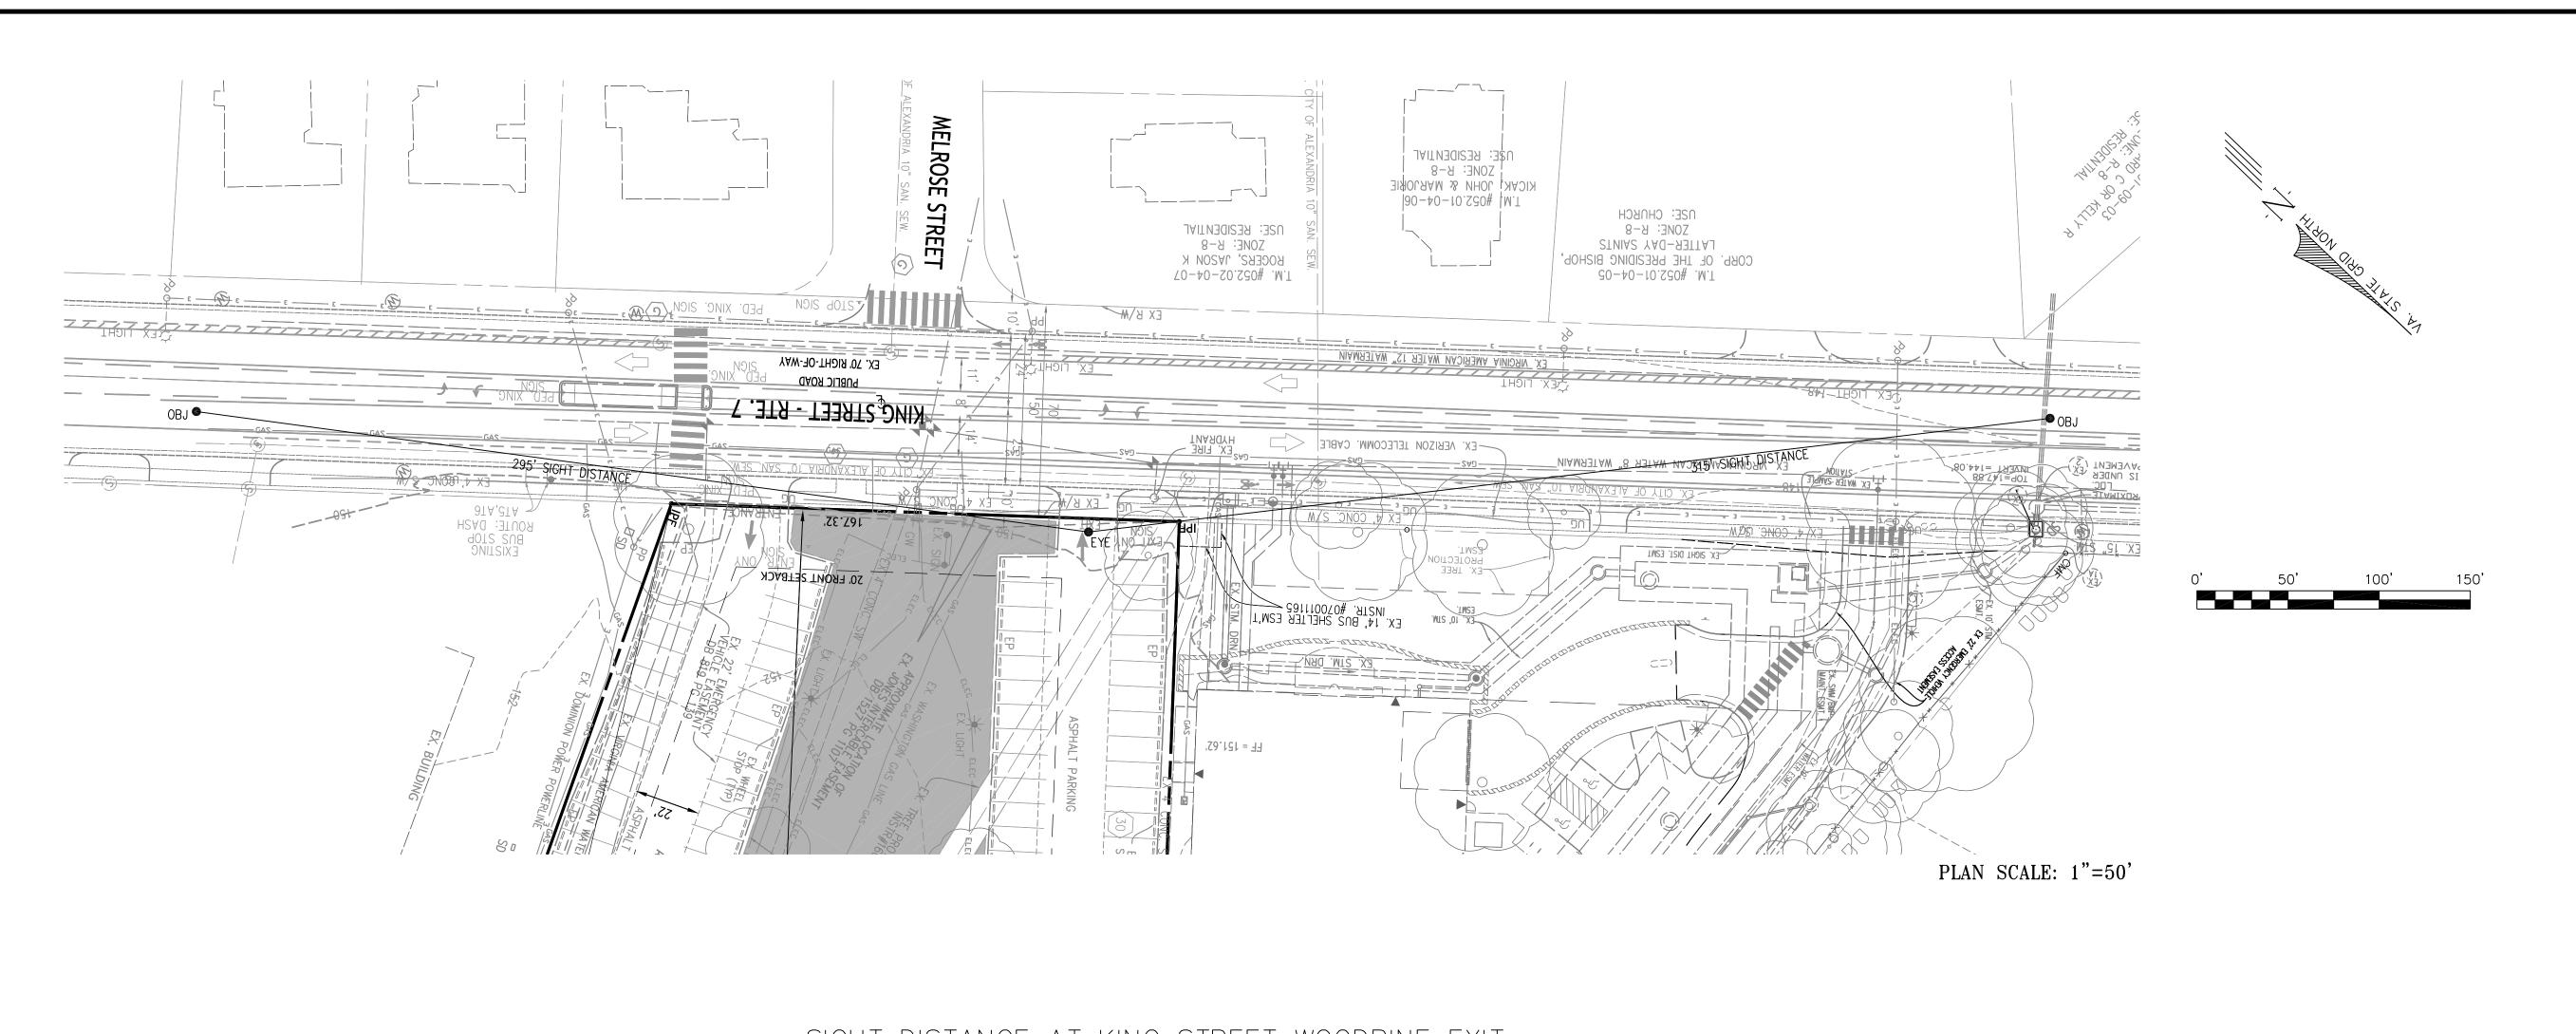
Drawing Number

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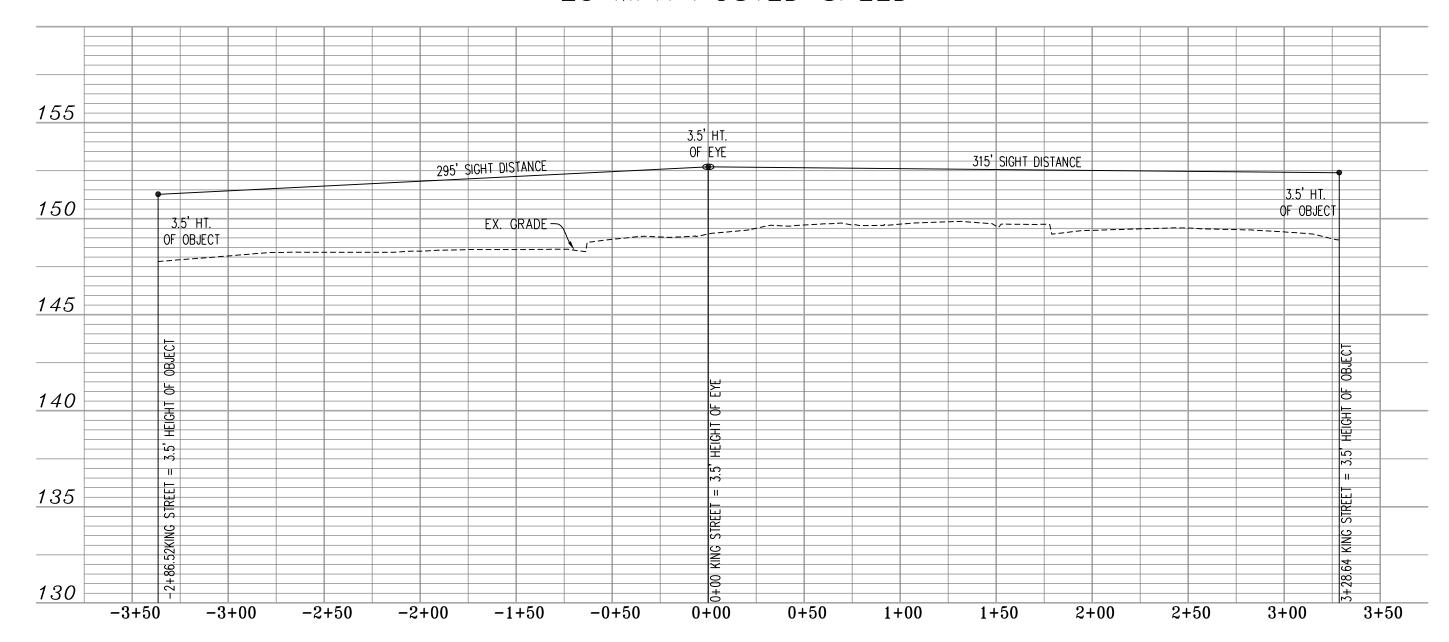
24Sheet 24 of 27





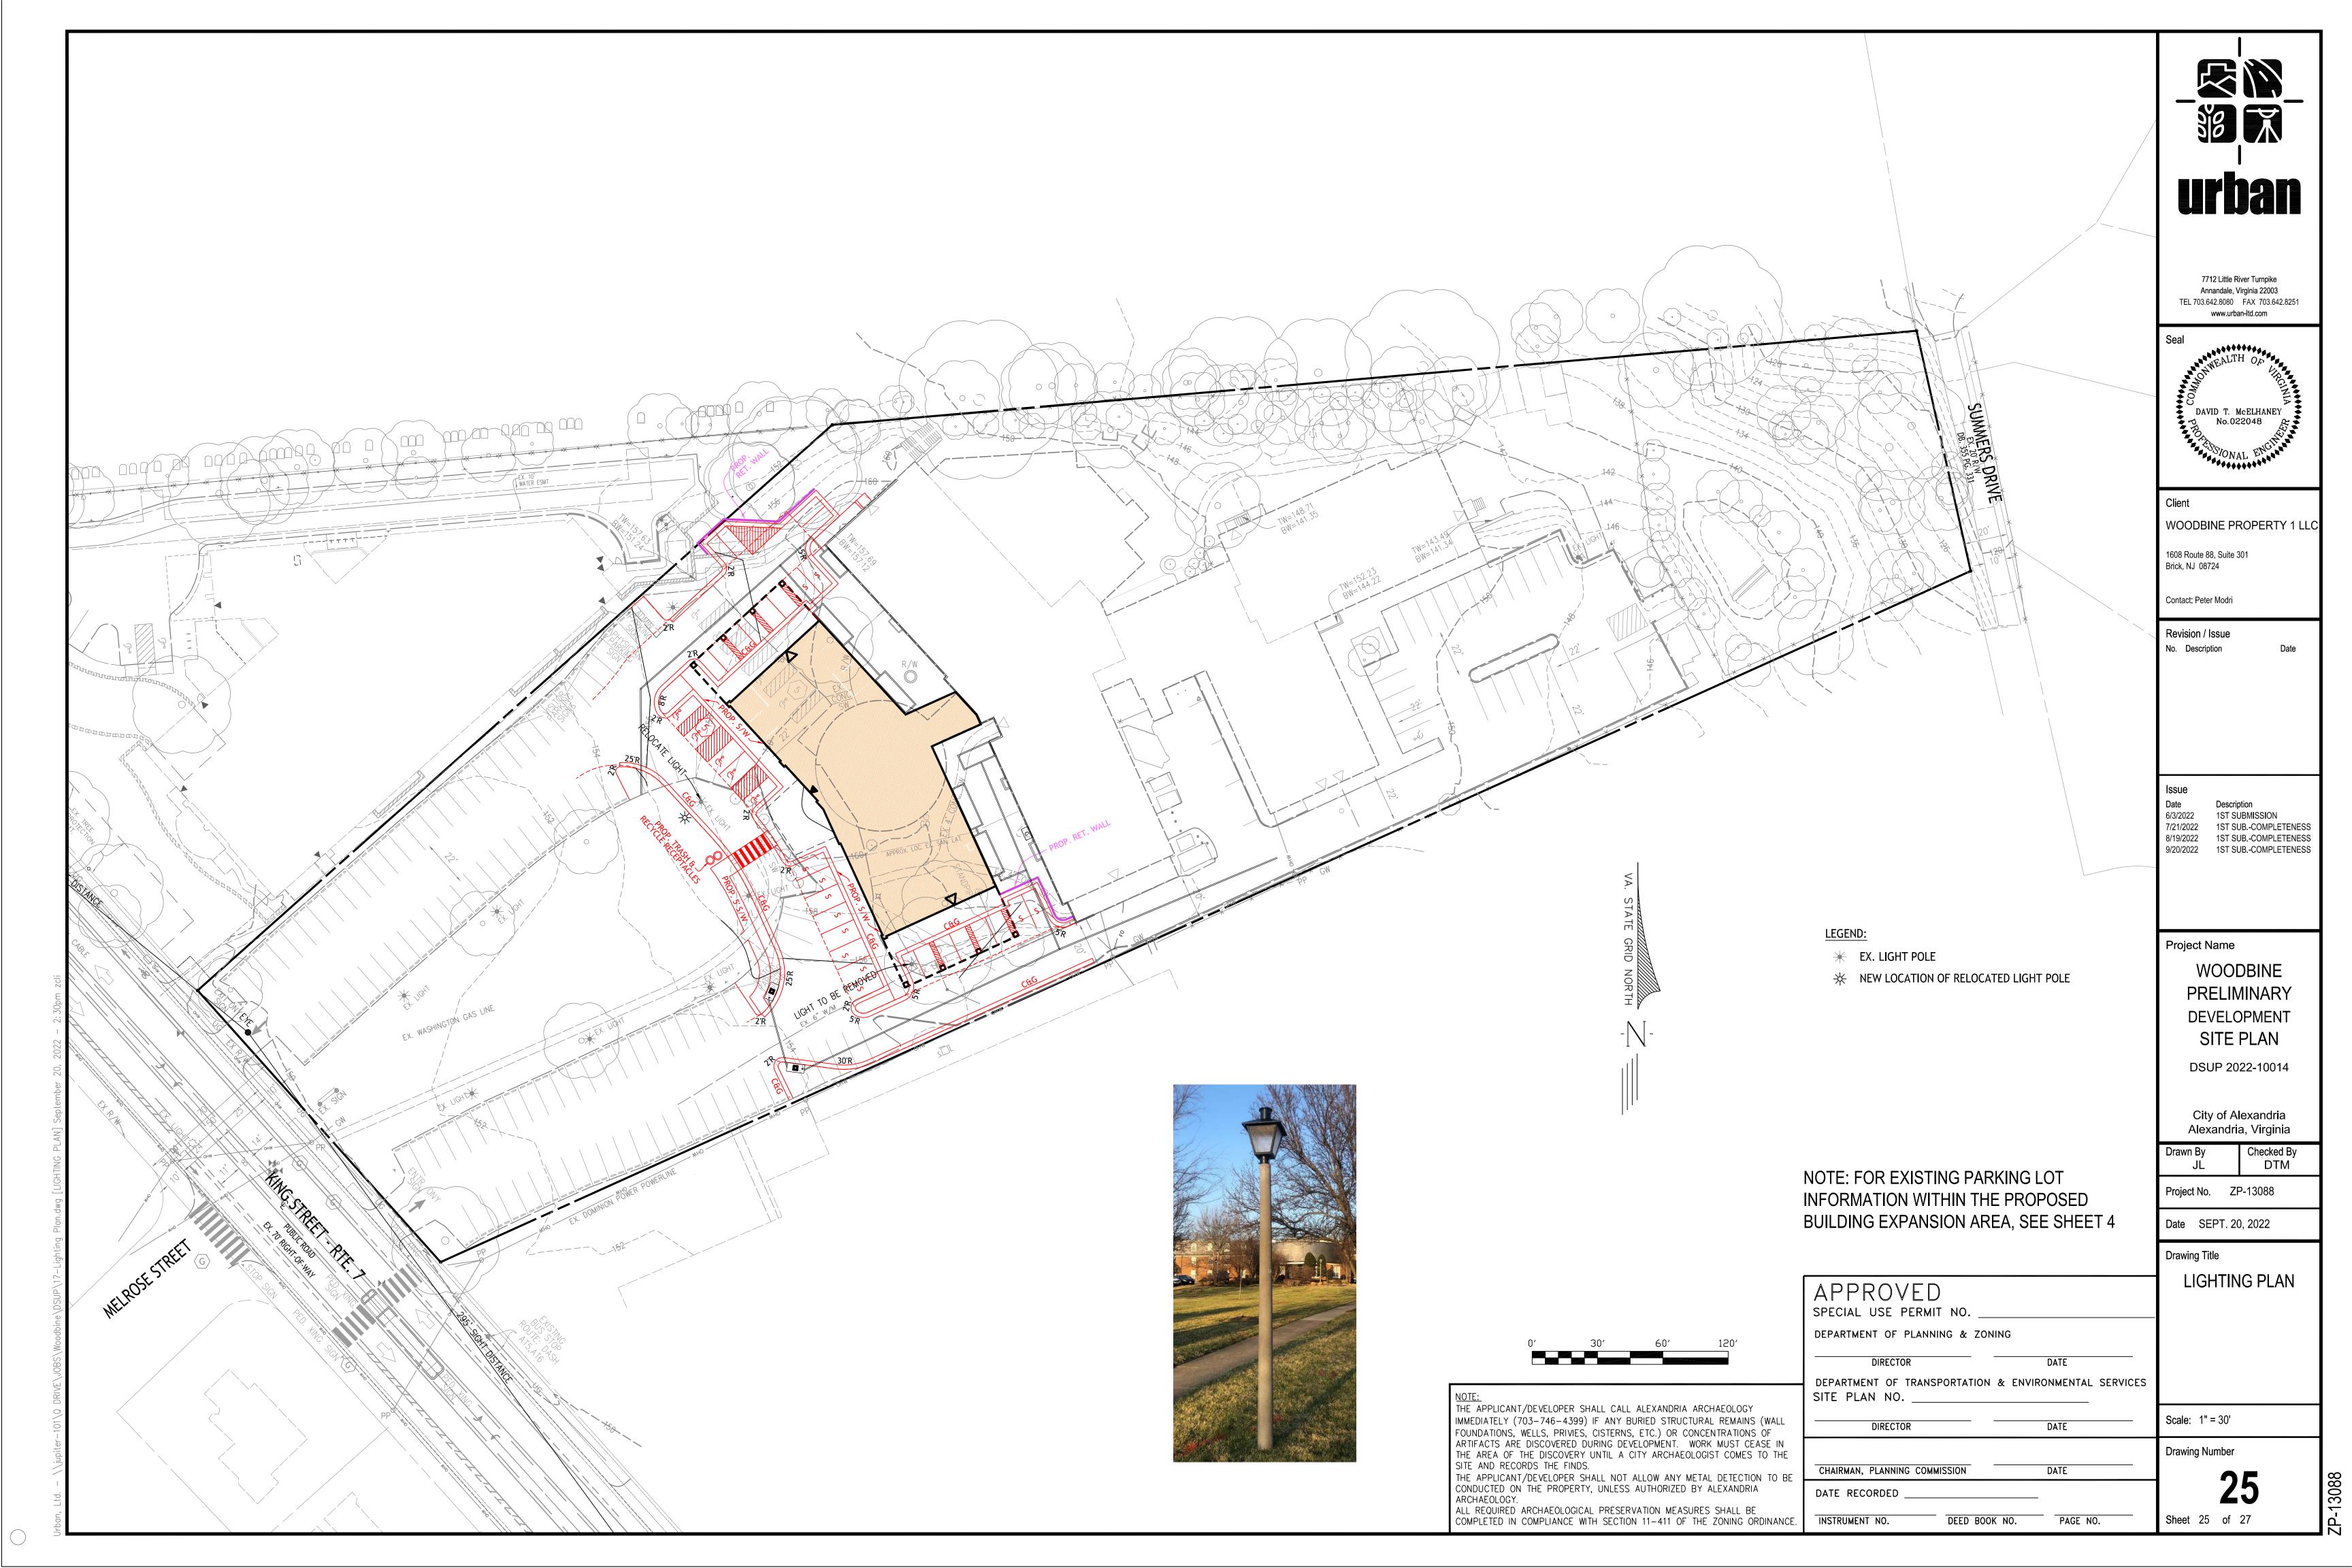

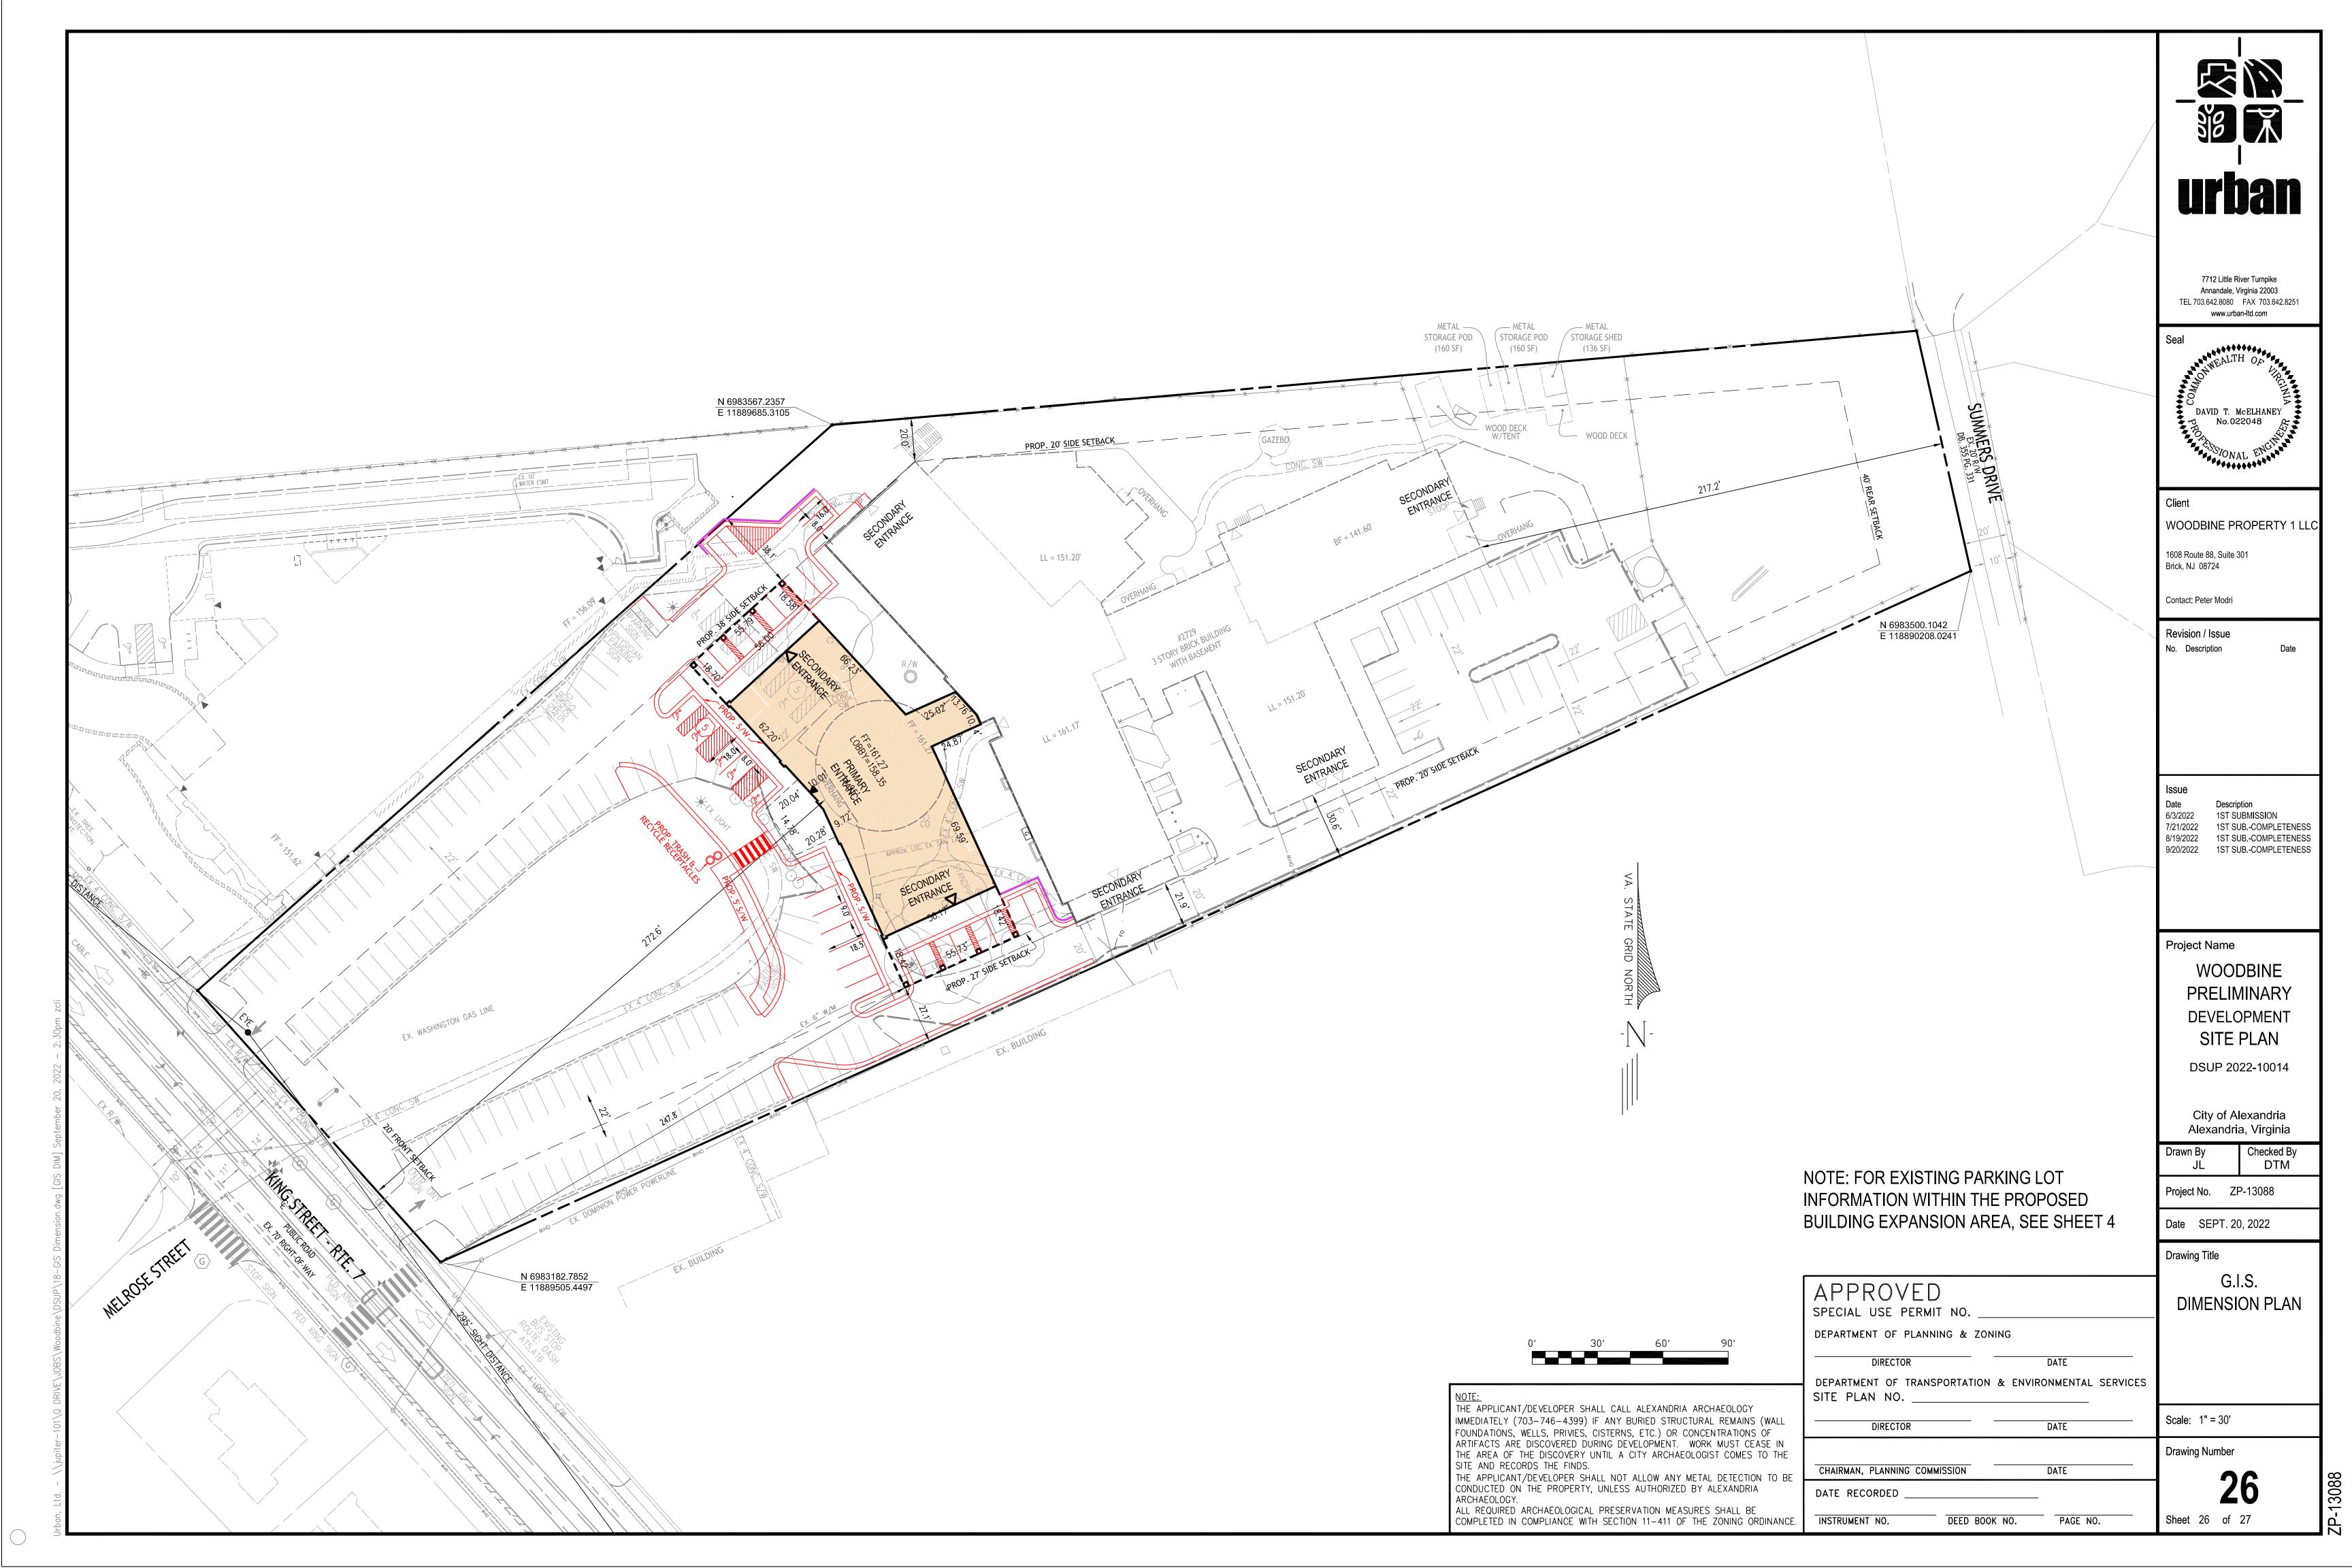SIGHT DISTANCE AT KING STREET WOODBINE EXIT 25 MPH POSTED SPEED



APPROVED SPECIAL USE PERMIT NO.

DEPARTMENT OF PLANNING & ZONING

DEPARTMENT OF TRANSPORTATION & ENVIRONMENTAL SERVICES SITE PLAN NO.

DIRECTOR

CHAIRMAN, PLANNING COMMISSION DATE

DATE RECORDED DEED BOOK NO. PAGE NO. INSTRUMENT NO.

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WOODBINE PRELIMINARY DEVELOPMENT SITE PLAN

DSUP 2022-10014

City of Alexandria Alexandria, Virginia

Checked By DTM

Project No. ZP-13088

Date SEPT. 20, 2022

Drawing Title

SIGHT DISTANCE

Scale: H: 1"=50'; V: =1"=5'

Drawing Number

Sheet 27 of 27

THE APPLICANT/DEVELOPER SHALL CALL ALEXANDRIA ARCHAEOLOGY IMMEDIATELY (703-746-4399) IF ANY BURIED STRUCTURAL REMAINS (WALL FOUNDATIONS, WELLS, PRIVIES, CISTERNS, ETC.) OR CONCENTRATIONS OF ARTIFACTS ARE DISCOVERED DURING DEVELOPMENT. WORK MUST CEASE IN THE AREA OF THE DISCOVERY UNTIL A CITY ARCHAEOLOGIST COMES TO THE

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