BAR Case # BAR2025-00291 & BAR2025-00293

ADDRESS OF PROJECT:820 South Lee St					
DISTRICT: MOId & Historic Alexandria ☐ Parker – Gray ☐ 100 Year Old Building					
TAX MAP AND PARCEL: 081 03 02 10- LOT 507 ZONING: RM					
APPLICATION FOR: (Please check all that apply)					
☑ CERTIFICATE OF APPROPRIATENESS					
PERMIT TO MOVE, REMOVE, ENCAPSULATE OR DEMOLISH (Required if more than 25 square feet of a structure is to be demolished/impacted)					
WAIVER OF VISION CLEARANCE REQUIREMENT and/or YARD REQUIREMENTS IN A VISION CLEARANCE AREA (Section 7-802, Alexandria 1992 Zoning Ordinance)					
WAIVER OF ROOFTOP HVAC SCREENING REQUIREMENT (Section 6-403(B)(3), Alexandria 1992 Zoning Ordinance)					
Applicant: Property Owner Susiness (Please provide business name & contact person)					
Name: Marks-woods Construction services					
Address:					
City: Zip: Zip:					
Phone: E-mail:					
Authorized Agent (if applicable): Attorney Architect 💢 Contractor					
Name: Grea Marks Phone:					
E-mail:					
Legal Property Owner:					
Name: Erica Rossi + John Medici					
Address:					
City: Zip: Zip:					
Phone:E-mail:					
Yes No Is there an historic preservation easement on this property? Yes No If yes, has the easement holder agreed to the proposed alterations? Is there a homeowner's association for this property? Yes No If yes, has the homeowner's association approved the proposed alterations?					

If you answered yes to any of the above, please attach a copy of the letter approving the project.

BAR	Case #	BAR2025-00291 &	
		BAR2025-00293	

NATURE OF PROPOSED WORK: Please check all that apply

NEW CONSTRUCTION EXTERIOR ALTERATION: Please check all that apply. awning fence, gate or garden wall HVAC equipment shutters doors windows siding shed lighting pergola/trellis painting unpainted masonry other ADDITION DEMOLITION/ENCAPSULATION SIGNAGE
DESCRIPTION OF PROPOSED WORK: Please describe the proposed work in detail (Additional pages may be attached).
Removing existing roof and adding third story. Adding open deck at first floor Replacing front fencing Replacement of windows and door at rear and replacement of basement door at front
SUBMITTAL REQUIREMENTS:
Items listed below comprise the minimum supporting materials for BAR applications. Staff may request additional information during application review. Please refer to the relevant section of the <i>Design Guidelines</i> for further information on appropriate treatments.
Applicants must use the checklist below to ensure the application is complete. Include all information and material that are necessary to thoroughly describe the project. Incomplete applications will delay the docketing of the application for review. Pre-application meetings are required for all proposed additions. All applicants are encouraged to meet with staff prior to submission of a completed application.
Electronic copies of submission materials should be submitted whenever possible.
Demolition/Encapsulation : All applicants requesting 25 square feet or more of demolition/encapsulation must complete this section. Check N/A if an item in this section does not apply to your project.
N/A Survey plat showing the extent of the proposed demolition/encapsulation. Existing elevation drawings clearly showing all elements proposed for demolition/encapsulation. Clear and labeled photographs of all elevations of the building if the entire structure is proposed to be demolished. Description of the reason for demolition/encapsulation. Description of the alternatives to demolition/encapsulation and why such alternatives are not considered feasible.

BAR Case #	BAR2025-00291 &
	BAR2025-00293

Additions & New Construction: Drawings must be to scale and should not exceed 11" x 17" unless approved by staff. All plans must be folded and collated into 3 complete 8 1/2" x 11" sets. Additional copies may be requested by staff for large-scale development projects or projects fronting Washington Street. Check N/A if an item in this section does not apply to your project.

V	1 1 1	
		and the place of t
		of dotal of the lot, location of proposed structure or addition, dimensions of suitable
_		structure(s), proposed addition or new construction, and all exterior, ground and roof mounted equipment.
	H	FAR & Open Space calculation form.
	ш	Clear and labeled photographs of the site, surrounding properties and existing structures, if applicable.
\sim		Existing elevations must be scaled and include dimensions
\smile		Proposed elevations must be scaled and include dimensions. Include the relationship to adjacent structures in plan and elevations.
		Materials and colors to be used must be specified and delineated on the drawings. Actual
V		anniples may be provided of recolled
		Manufacturer's specifications for materials to include, but not limited to: roofing, siding, windows, doors, lighting, fencing, HVAC equipment and walls.
Ш		For development site plan projects, a model showing mass relationships to adjacent properties and structures.
	apply	& Awnings: One sign per building under one square foot does not require BAR approval unless ed. All other signs including window signs require BAR approval. Check N/A if an item in this section does y to your project.
		Linear feet of building: Front:Secondary front (if corner lot): Square feet of existing signs to remain:
		Photograph of building about a sixty
	Ħ	Photograph of building showing existing conditions
		Photograph of building showing existing conditions. Dimensioned drawings of proposed sign identifying materials, color, lettering style and text. Location of sign (show exact location on building including the height above sidewalk). Means of attachment (drawing or manufacturer's cut sheet of brocket if applicable).
		Photograph of building showing existing conditions. Dimensioned drawings of proposed sign identifying materials, color lettering at the
Alto		Photograph of building showing existing conditions. Dimensioned drawings of proposed sign identifying materials, color, lettering style and text. Location of sign (show exact location on building including the height above sidewalk). Means of attachment (drawing or manufacturer's cut sheet of bracket if applicable). Description of lighting (if applicable), Include manufacturer's cut sheet for any particular.
_	erati	Photograph of building showing existing conditions. Dimensioned drawings of proposed sign identifying materials, color, lettering style and text. Location of sign (show exact location on building including the height above sidewalk). Means of attachment (drawing or manufacturer's cut sheet of bracket if applicable). Description of lighting (if applicable). Include manufacturer's cut sheet for any new lighting fixtures and information detailing how it will be attached to the building's facade. ions: Check N/A if an item in this section does not apply to your project.
V	erati	Photograph of building showing existing conditions. Dimensioned drawings of proposed sign identifying materials, color, lettering style and text. Location of sign (show exact location on building including the height above sidewalk). Means of attachment (drawing or manufacturer's cut sheet of bracket if applicable). Description of lighting (if applicable). Include manufacturer's cut sheet for any new lighting fixtures and information detailing how it will be attached to the building's facade. ions: Check N/A if an item in this section does not apply to your project. Clear and labeled photographs of the site, especially the area being impacted by the alterations, all sides of the building and any pertinent details.
V	erati	Photograph of building showing existing conditions. Dimensioned drawings of proposed sign identifying materials, color, lettering style and text. Location of sign (show exact location on building including the height above sidewalk). Means of attachment (drawing or manufacturer's cut sheet of bracket if applicable). Description of lighting (if applicable). Include manufacturer's cut sheet for any new lighting fixtures and information detailing how it will be attached to the building's facade. ions: Check N/A if an item in this section does not apply to your project. Clear and labeled photographs of the site, especially the area being impacted by the alterations, all sides of the building and any pertinent details. Manufacturer's specifications for materials to include but not limited to reading additional to reading a siding and any pertinent details.
∀	erati	Photograph of building showing existing conditions. Dimensioned drawings of proposed sign identifying materials, color, lettering style and text. Location of sign (show exact location on building including the height above sidewalk). Means of attachment (drawing or manufacturer's cut sheet of bracket if applicable). Description of lighting (if applicable). Include manufacturer's cut sheet for any new lighting fixtures and information detailing how it will be attached to the building's facade. ions: Check N/A if an item in this section does not apply to your project. Clear and labeled photographs of the site, especially the area being impacted by the alterations, all sides of the building and any pertinent details. Manufacturer's specifications for materials to include, but not limited to: roofing, siding, windows, doors, lighting, fencing, HVAC equipment and walls
V	erati	Photograph of building showing existing conditions. Dimensioned drawings of proposed sign identifying materials, color, lettering style and text. Location of sign (show exact location on building including the height above sidewalk). Means of attachment (drawing or manufacturer's cut sheet of bracket if applicable). Description of lighting (if applicable). Include manufacturer's cut sheet for any new lighting fixtures and information detailing how it will be attached to the building's facade. ions: Check N/A if an item in this section does not apply to your project. Clear and labeled photographs of the site, especially the area being impacted by the alterations, all sides of the building and any pertinent details. Manufacturer's specifications for materials to include but not limited to reading additional to reading a siding and any pertinent details.

ALL APPLICATIONS: Please read and check that you have read and understand the following items:

- I have submitted a filing fee with this application. (Checks should be made payable to the City of Alexandria. Please contact staff for assistance in determining the appropriate fee.)
- I understand the notice requirements and will return a copy of the three respective notice forms to BAR staff at least five days prior to the hearing. If I am unsure to whom I should send notice I will contact Planning and Zoning staff for assistance in identifying adjacent parcels.
- I, the applicant, or an authorized representative will be present at the public hearing.
- I understand that any revisions to this initial application submission (including applications deferred for restudy) must be accompanied by the BAR Supplemental form and 3 sets of revised materials.

The undersigned hereby attests that all of the information herein provided including the site plan, building elevations, prospective drawings of the project, and written descriptive information are true, correct and accurate. The undersigned further understands that, should such information be found incorrect, any action taken by the Board based on such information may be invalidated. The undersigned also hereby grants the City of Alexandria permission to post placard notice as required by Article XI, Division A, Section 11-301(B) of the 1992 Alexandria City Zoning Ordinance, on the property which is the subject of this application. The undersigned also hereby authorizes the City staff and members of the BAR to inspect this site as necessary in the course of research and evaluating the application. The applicant, if other than the property owner, also attests that he/she has obtained permission from the property owner to make this application.

APPLICANT OR AUTHORIZED AGENT:

Signature:

Printed Name: Gregory T. Marks

Date: 7/21/2025

OWNERSHIP AND DISCLOSURE STATEMENT Use additional sheets if necessary

1. Applicant. State the name, address and percent of ownership of any person or entity owning
an interest in the applicant, unless the entity is a corporation or partnership, in which
case identify each owner of more than three percent. The term ownership interest shall
include any legal or equitable interest held at the time of the application in the real property
which is the subject of the application.

Name	Address	Percent of Ownership
1. Gregory Marks		100%
2.	•	
3.		

2. Property. State the name, address and percent of ownership of any person or entity owning an interest in the property located at 820 S Lee (address), unless the entity is a corporation or partnership, in which case identify each owner of more than three percent. The term ownership interest shall include any legal or equitable interest held at the time of the application in the real property which is the subject of the application.

Name	Address	Percent of Ownership		
1. Erica + John Russi - Medici	A	100%		
2.				
3.				

3. Business or Financial Relationships. Each person or entity listed above (1 and 2), with an ownership interest in the applicant or in the subject property is required to disclose **any** business or financial relationship, as defined by Section 11-350 of the Zoning Ordinance, existing at the time of this application, or within the12-month period prior to the submission of this application with any member of the Alexandria City Council, Planning Commission, Board of Zoning Appeals or either Boards of Architectural Review.

Name of person or entity	Relationship as defined by Section 11-350 of the Zoning Ordinance	Member of the Approving Body (i.e. City Council, Planning Commission, etc.)
1.	_	
2.		
3.		

NOTE: Business or financial relationships of the type described in Sec. 11-350 that arise after the filing of this application and before each public hearing must be disclosed prior to the public hearings.

As the applicant or the applicant's authorized agent, I hereby attest to the best of my ability that the information provided above is true and correct.

8/6/25 Gregory T. Marks
Printed Name

Signature


Department of Planning & Zoning Floor Area Ratio and Open Space Calculations

В

A.	Property Information				
A1.	Street Address			7	one
40	Street Address	v		20	one
A2.	Total Lot Area	X	Floor Area Ratio Allowed by Zone	М	aximum Allowable Floor Area
В.	Existing Gross Floor Area Existing Gross Area		Allowable Exclusions**		
	Basement		Basement**	В	
	First Floor		Stairways**		Existing Gross Floor Area*
	Second Floor		Mechanical**	В	
	Third Floor		Attic less than 7'**		Allowable Floor Exclusions**
	Attic		Porches**	В	Sq. Ft. Existing Floor Area Minus Exclusions
	Porches		Balcony/Deck**		(subtract B2 from B1)
	Balcony/Deck		Lavatory***	С	comments for Existing Gross Floor Area
	Lavatory***		Other**		
	Other covered patio		Other**		
B1.	Total Gross	B2.	Total Exclusions		
C.	Proposed Gross Floor Area Proposed Gross Area Basement First Floor Second Floor Third Floor Attic Porches Balcony/Deck Lavatory***		Allowable Exclusions** Basement** Stairways** Mechanical** Attic less than 7'** Porches** Balcony/Deck** Lavatory*** Other**	c: c:	Proposed Gross Floor Area* 2. Allowable Floor Exclusions**
	Other		Other**		Notes
C1.	<u>Total Gross</u>	C2.	Total Exclusions		*Gross floor area is the sum of <u>all areas</u> <u>under roof of a lot</u> , measured from the face of exterior walls, including basements,
D.	Total Floor Area		E. Open Space (RA & RB Zones)		garages, sheds, gazebos, guest buildings and other accessory buildings.
D1.	Sq. Ft.		E1. Sq. Ft.		** Refer to the Zoning Ordinance (Section 2-145(B)) and consult with Zoning Staff for
	Total Floor Area (add B3 and C3)		Existing Open Space		information regarding allowable exclusions. Sections may also be required for some
D2.	Sq. Ft. Total Floor Area Allowed by Zone (A2)		E2. Sq. Ft. Required Open Space E3. Sq. Ft. Proposed Open Space		exclusions. ***Lavatories may be excluded up to a maximum of 50 square feet, per lavatory. The maximum total of excludable area for lavatories shall be no greater than 10% of gross floor area.
	The state of the s		41 - 4 - 4 - 41 - 1 4 - 61 - 4 1 1 - 1		

The undersigned hereby certification and attests that, to the best of his/her knowledge, the above computations are true and correct.

Signature: _____ Date: _____

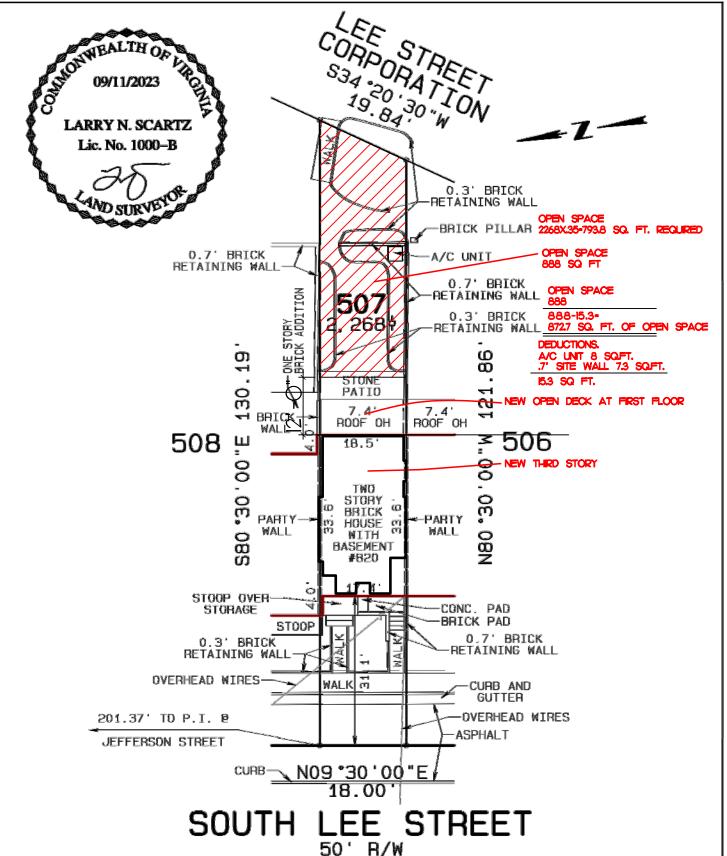

PHYSICAL IMPROVEMENTS SURVEY

LOT 507, BLOCK 7

CITY OF ALEXANDRIA, VIRGINIA

SCALE: 1"=20' DATE: SEPTEMBER 11, 2023

NO TITLE REPORT FURNISHED.

PLAT SUBJECT TO RESTRICTIONS & EASEMENTS OF RECORD OR OTHERWISE.

FENCE LOCATIONS, IF SHOWN, ARE APPROXIMATE ONLY AND DO NOT CERTIFY AS TO OWNERSHIP.


CASE NAME: ROSSI / MEDICI

SURVEYS SCARTZ

LARRY N. SCARTZ CERTIFIED LAND SURVEYOR WOODBRIDGE, VIRGINIA

LOCAL (703) 494-4181 FAX (703) 494-3330 LARRY.SCARTZ@SCARTZ.COM



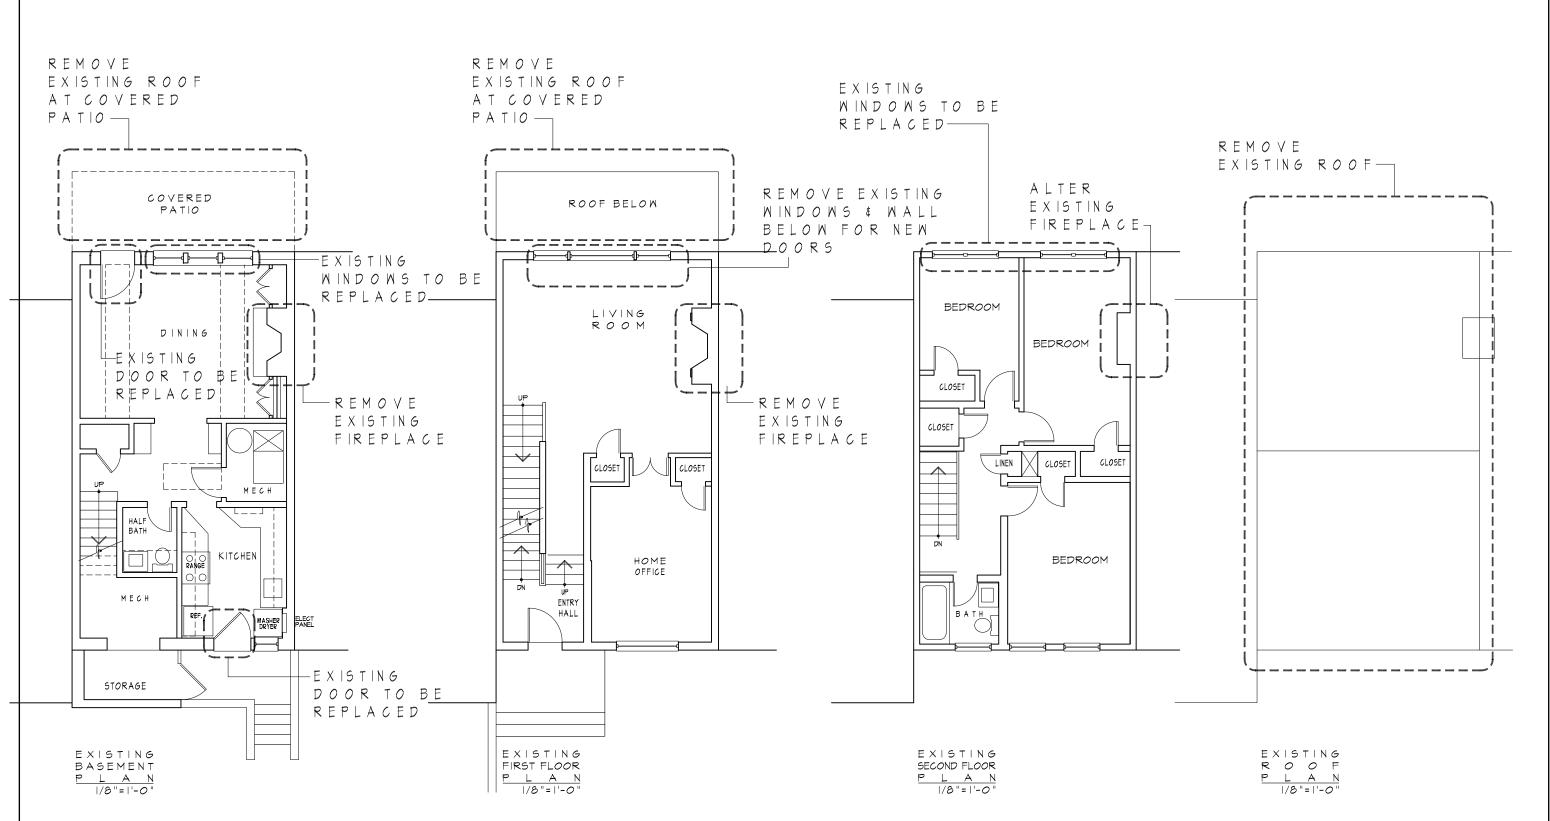

PASTEUR

O

DESIGNS

9303 IRVING STREET M A N A S S A S V A 2 0 1 1 0 · 5 1 1 0

E MAIL-lucy@pesteurdesigns.com IELEPHONE -703 472 4172 FACSIMILE -703 393 8706

MARKS-WOODS

CONSTRICTION SERVICES

DICI RESIDENCE SLEE STREET DRIA VIRGINIA

മ_{് Z}

I M 2 0 X X A A

 $^{\mathrm{S}}_{^{\mathrm{B}}}$

R 0

COPPRISHT 2025, UCLE P.
ADNAS, ARCHTECT, THEE
ADNAS, ARCHTECT, THEE
BURGET RE PHO ARCHTECHEN
MORS SCOPPRISH PROTECTION
ACT. AN' UNUMPRIZED USE.
COPPING OR MODIFICATION OF
THE ORIGINAL IS PROMBITED


IS SUE DATE
DESIGN
09/07/23

O9/O7/23 11/O3/23 11/O8/23 12/O5/23 O6/12/25 B A R 12/27/23

07/21/25

EXISTING PLANS

SHEET NUMBER

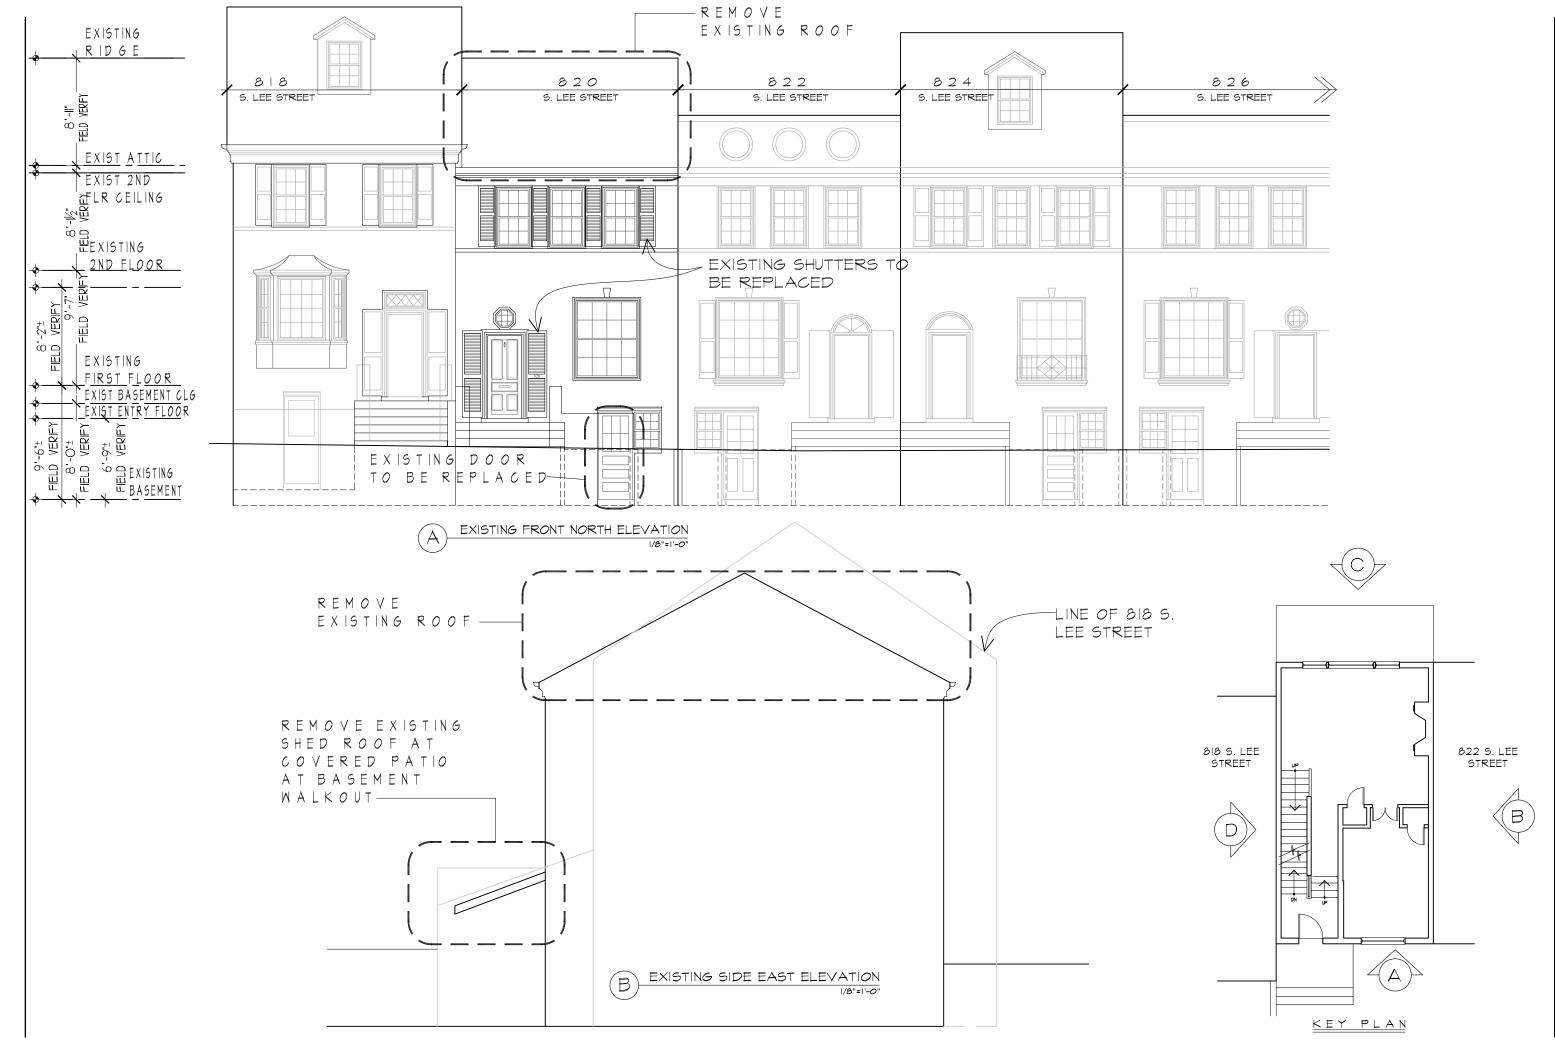

PASTEUR

O

DESIGNS

9303 IRVING STREET MANASSAS-VA 2 0 1 1 0 · 5 1 1 0

ELEPHONE - 703 472 4172
ACSIMILE - 703 393 8706

MARKS-WOODS

CONSTAINT ON SERVICES

EDICI RESIDENCE SLEE STREET NDRIA VIRGINIA

COPTRONI DOS DUCLE P.
ADMA, MONTECT TERE
DE REMO MONITORIA

OFFICE HIPO MONITORIA

ON MONITORIA

OFFICE OF MONITORIA

OFFICE ON MONITORIA

OFFICE ON MONITORIA

OFFICE ON MONITORIA

OFFICE ORGANIA SPONSITION

OFFICE OFFICE OFFICE OFFI

DE S | G N


S I M E 8 2 0 E X A N

D E S I G N 09/07/23 11/03/23 11/08/23 12/05/23 06/12/25 B A R 12/27/23

12/27/23 07/21/25

EXISTING ELEVATIONS

A-2

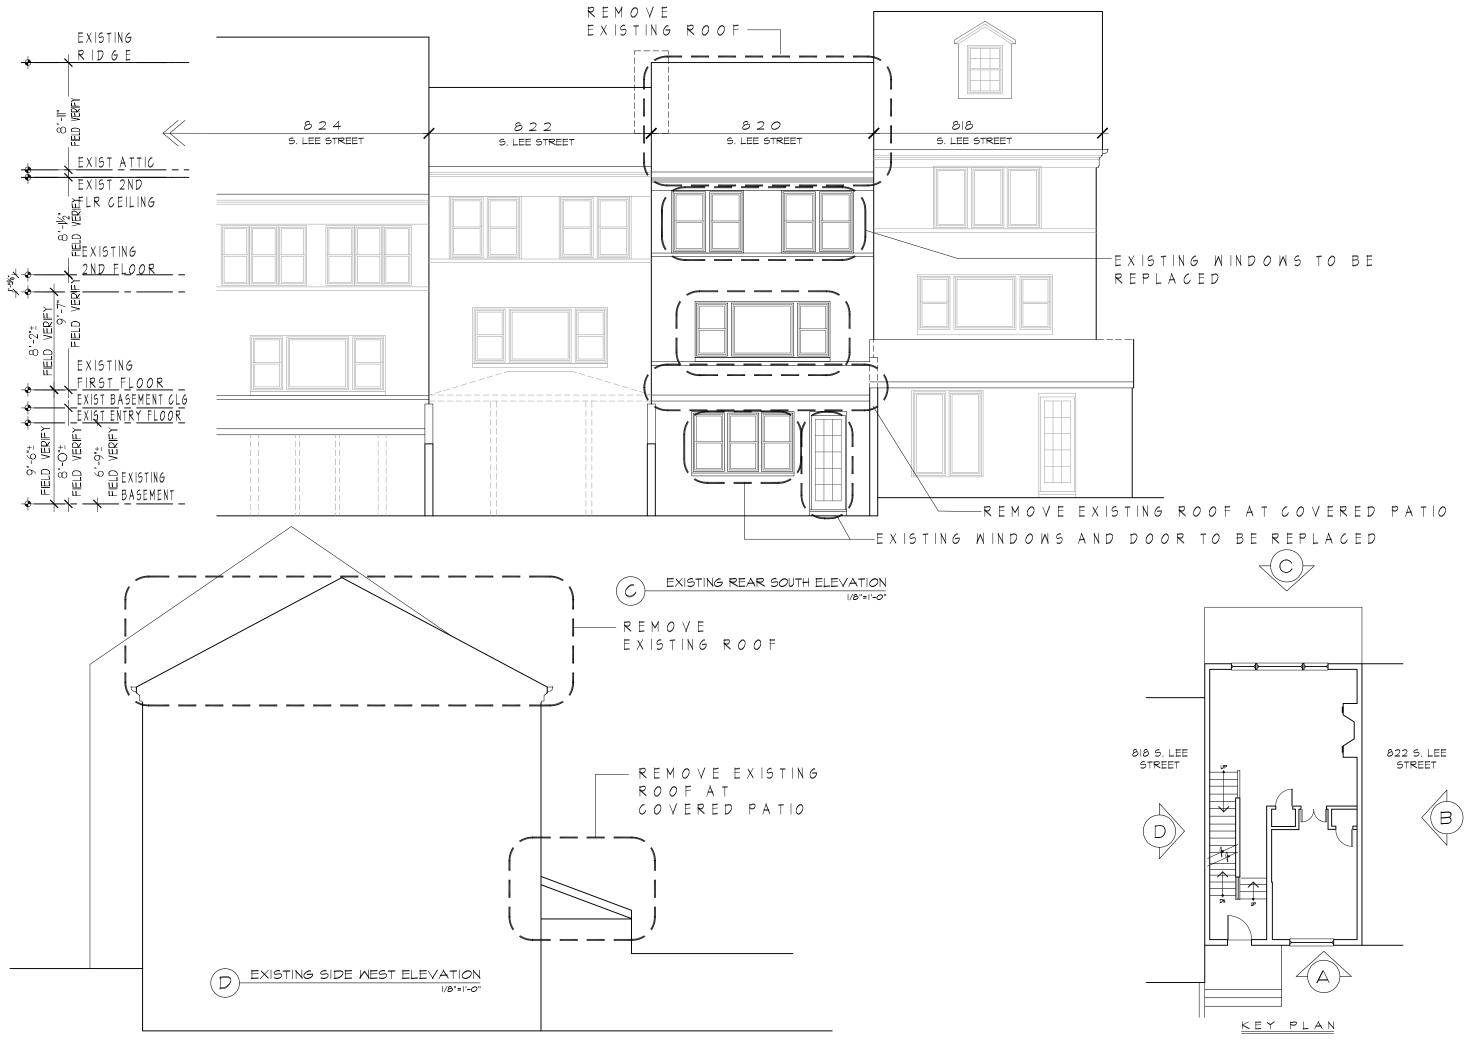

9303 IRVING STREET MANASSAS VA 2 0 1 1 0 · 5 1 1 0

MARKS-WOODS
CONSTRICTION SERVICES

CI RESIDENCE LEE STREET IA VIRGINIA

0 s 0


TE STUE DATE
DESIGN
09/07/23
11/08/23
11/08/23
06/12/25
BARR

B A R 12/27/23 07/21/25

SHEET TITLE EXISTING ELEVATIONS

SHEET NUMBER

A-3

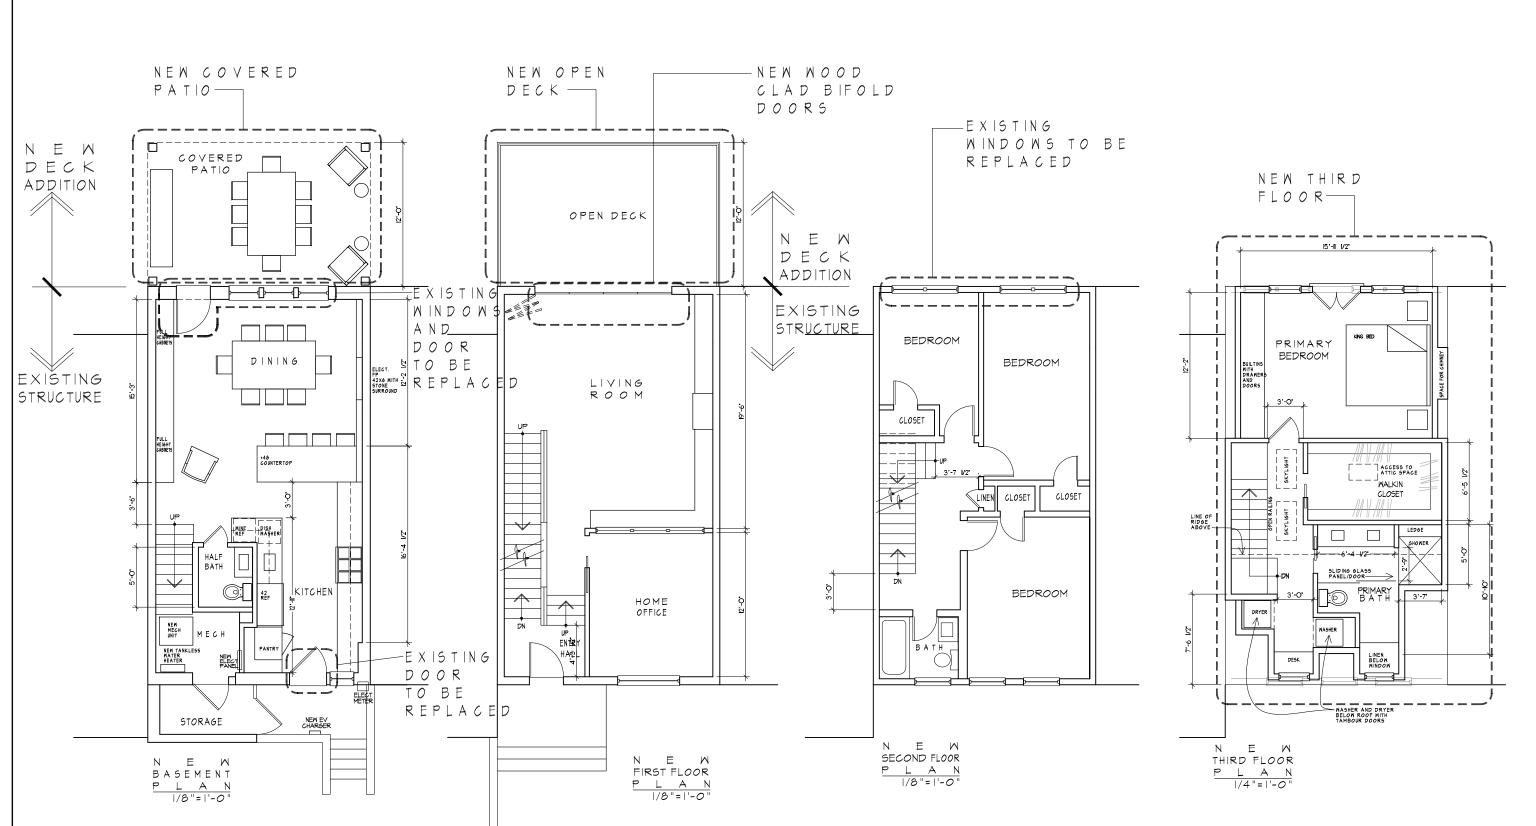

PASTEUR

O

DESIGNS

9303 IRVING STREET M A N A S S A S V A 2 0 1 1 0 · 5 1 1 0

MAIL-luy@pesteurdesigns.com ELEPHONE · 703 472 4172 ACSIMILE · 703 393 8706

MARKS-WOODS

CONSTRUCTION SERVICES

I RESIDENCE EESTREET AVIRGINIA

MED OS AND

 $\mathop{\mathrm{S}}_{\stackrel{\mathrm{R}}{\times}}^{\mathrm{I}}$

 $^{\circ}$


COPPRIGHT 2025 LIDELE F ADMS, ARCHITECT THE REPORT ADMS ARCHITECT THE REPORT ADMS ARCHITECTURA ACT. ART MANIFEMENT ACT. ARCHITECTURA ACT. ART MANIFEMENT ACT. ART MANIFEMENT ACT. ART MANIFEMENT ACT. ARCHITECTURA ACT. ARCH


O9/O7/23 11/O3/23 11/O5/23 12/O5/23 O6/12/25 B A R 12/27/23 O7/21/25


N E W PLANS

SHEET NUMBER

A-4

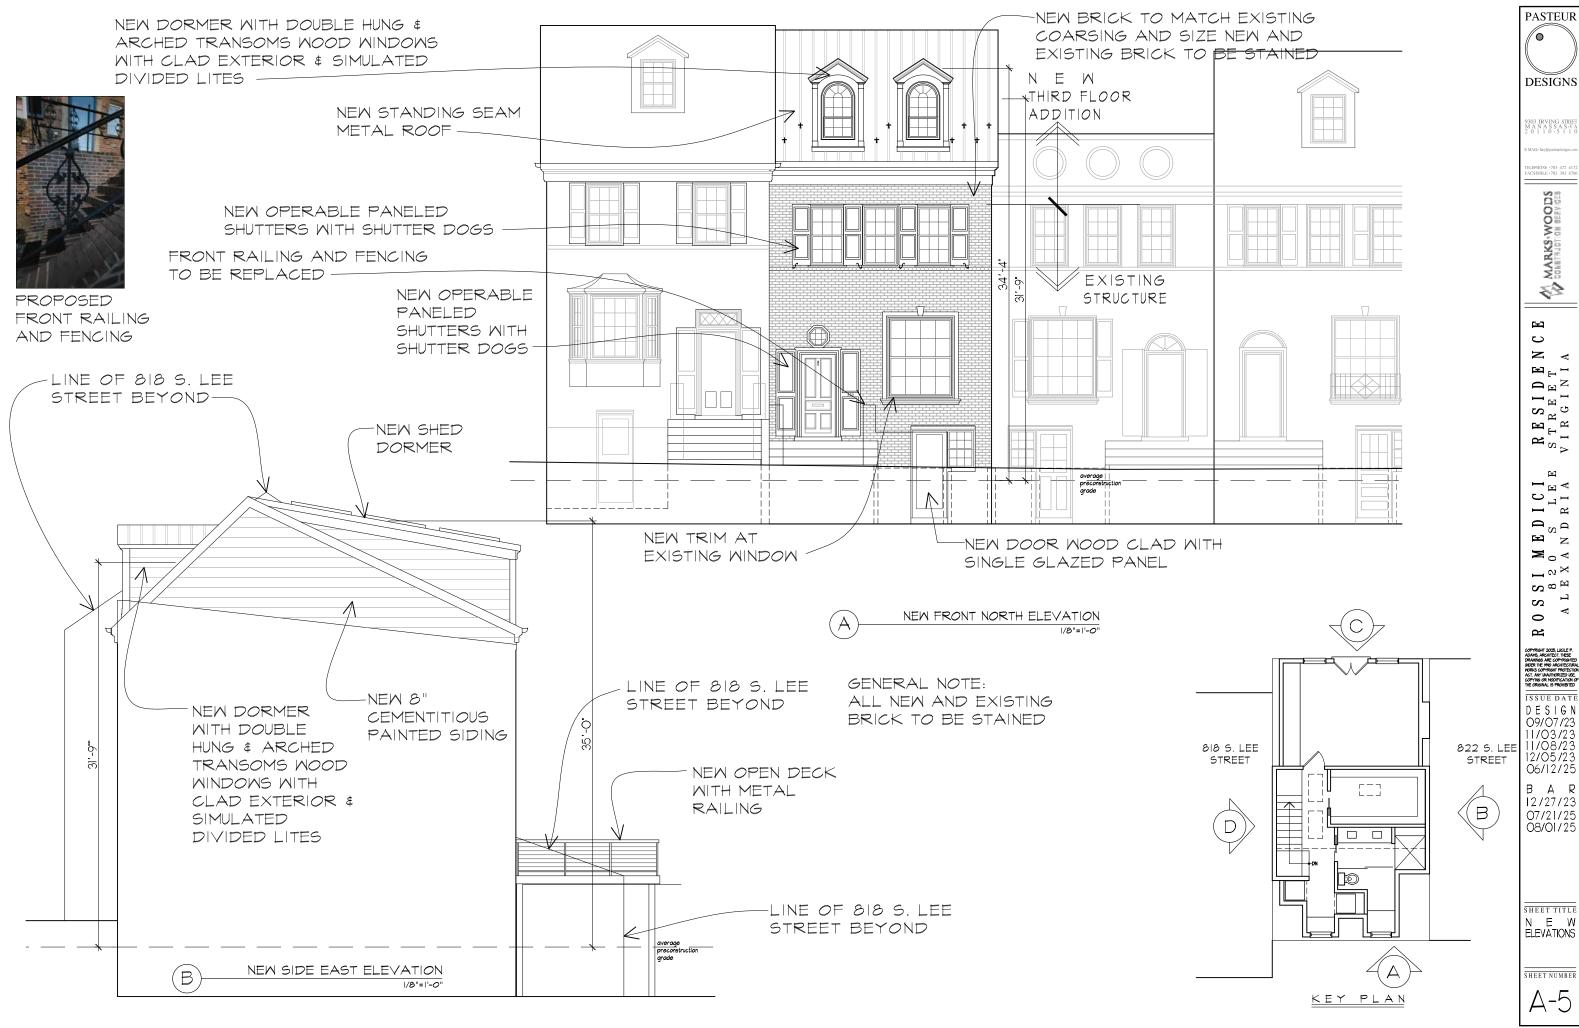

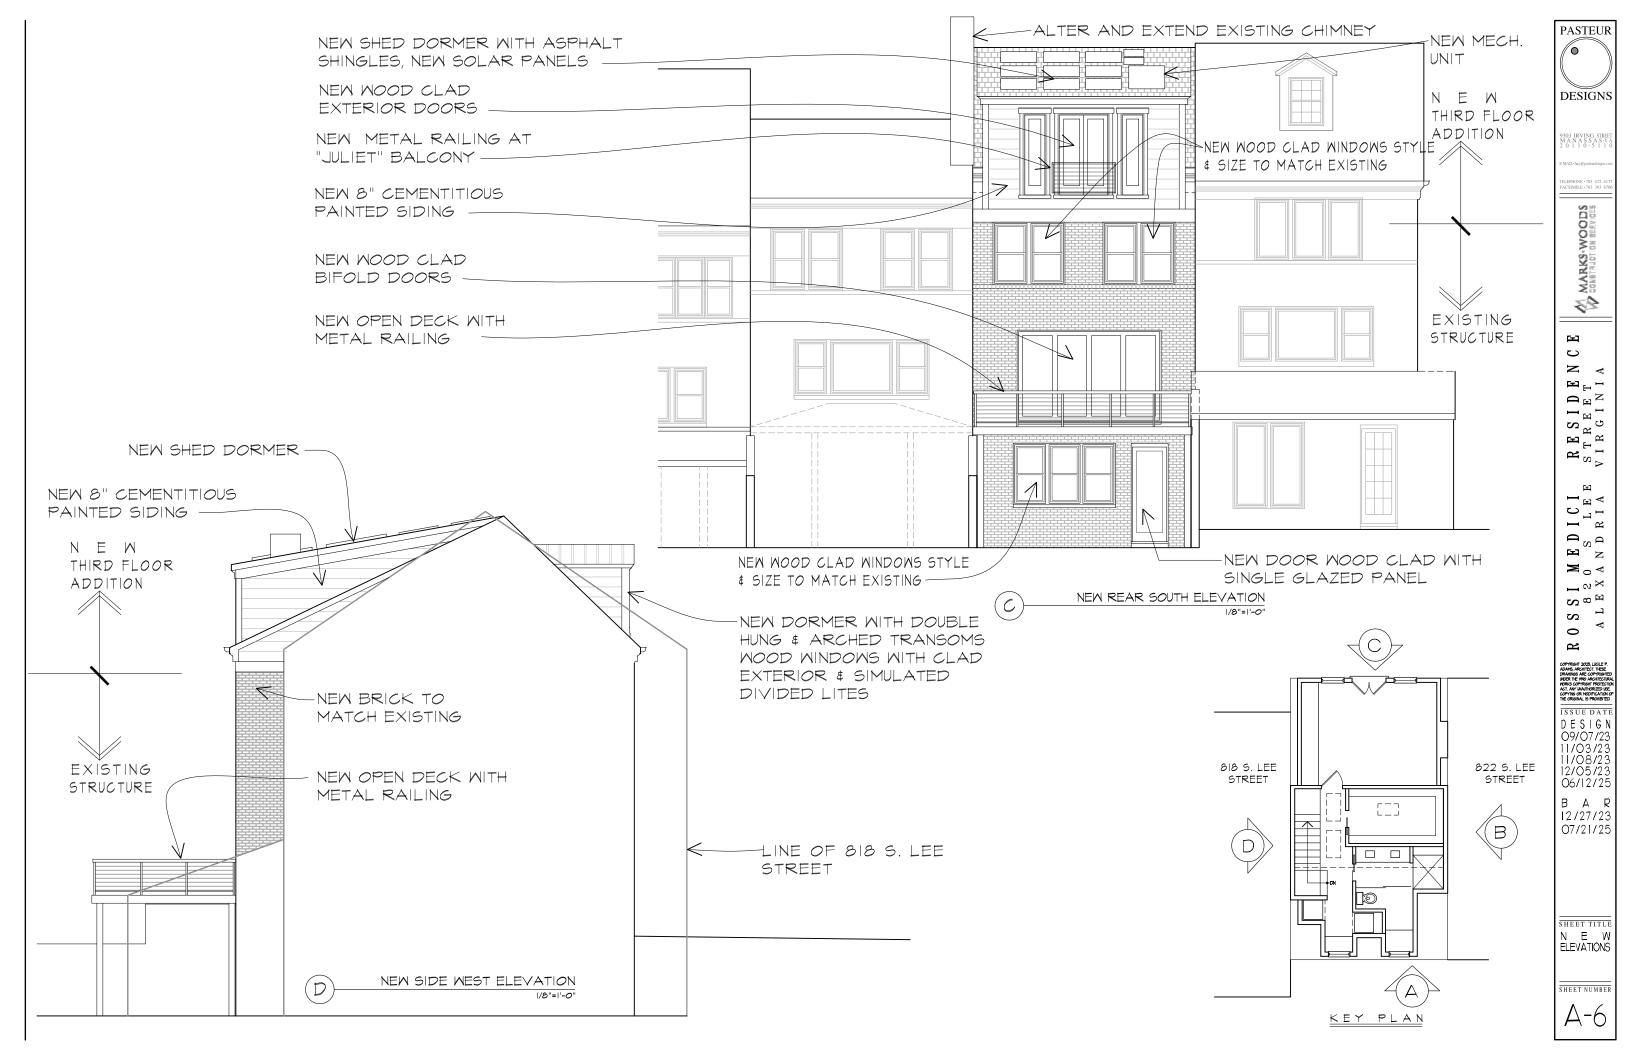


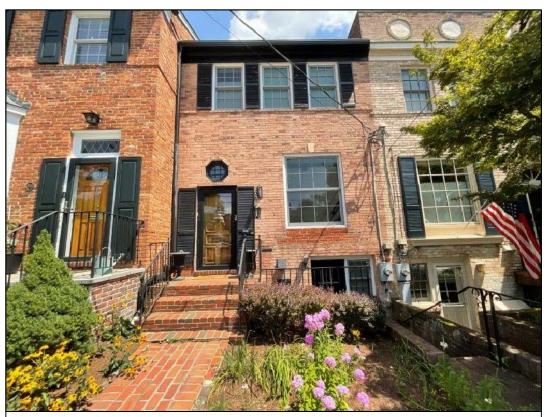

WEST ELEVATION FRONT 820 SOUTH LEE STREET



820 SOUTH LEE STREET

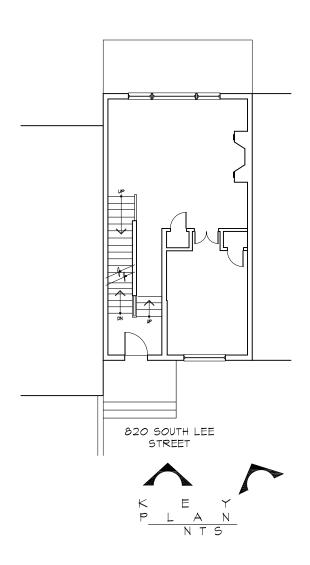

PASTEUR **DESIGNS**

9303 IRVING STREI M A N A S S A S · V 2 0 1 1 0 · 5 1 1

MARKS-WOODS

CONSTRUCTION SERVICES

Œ Ç RESIDEN (STREET VIRGINIA

囝 MEDICI OSLEE GANDRIA Γ^{\otimes} $\mathbf{c}_{\mathbf{g}}$ \mathbf{S}^{Γ} 0 R

ISSUE DATE D E S I G N O9/O7/23 II/O3/23 II/O8/23 I2/O5/23 O6/I2/25

B A R 12/27/23 07/21/25

SHEET TITLE PHOTOS

SHEET NUMBER A-7




REAR EAST ELEVATION 820 SOUTH LEE STREET



REAR EAST ELEVATION 818 SOUTH LEE STREET





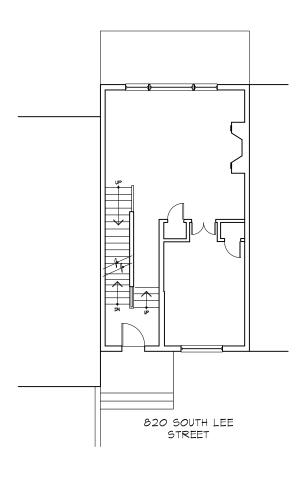



PASTEUR **DESIGNS**

9303 IRVING STRE M A N A S S A S V 2 0 1 1 0 · 5 1 1

MARKS-WOODS
W CONSTRUCTION SERVICES

田 ၁ RESIDEN (STREET VIRGINIA

压 EDICI SLEI NDRIA **W** 0 4 $rac{1}{2}$ $^{\circ}$ 8 $_{\odot}$ \mathbf{S} 0 \mathbf{R}

ISSUE DATE D E S I G N O9/O7/23 11/O3/23 11/O8/23 12/O5/23 O6/12/25


B A R 12/27/23 07/21/25

SHEET TITLE PHOTOS

SHEET NUMBER 8-4



Architect Series* Reserve™

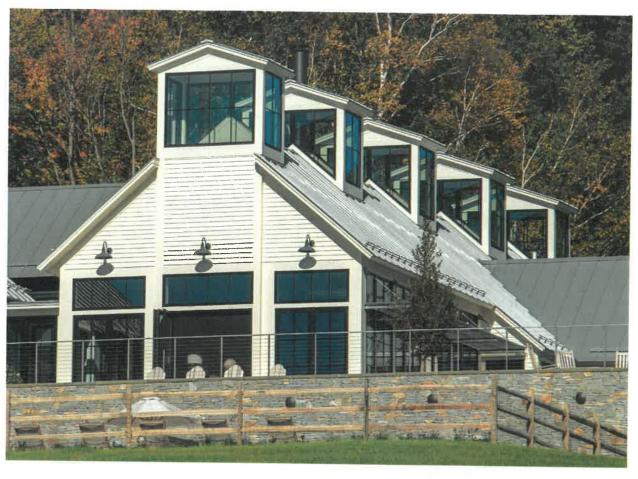

Photograph(s) © Scott Barrow Photography



Authentically Detailed.

Meticulously designed to replicate the historical millwork process, Pella® Architect Series® Reserve™ offers unparalleled authenticity. Each piece is original, featuring excellent craftsmanship to reflect your project's unique personality and customized to fit your vision.

- A wide range of glazing options as well as HurricaneShield* impact-resistant.
- Divided light options available in Integral Light Technology*
 grilles, grilles-between-the-glass or wood removable grilles in
 standard and custom patterns.
- Wide range of historically authentic features and attributes including butt joinery and through stiles
- Two exterior sash profiles are available: Ogee and Putty Glaze.
- Virtually unlimited exterior color options, EnduraClad® protective finish in 27 standard colors plus nearly unlimited custom colors and Anodized finishes.



Available with factory-installed integrated security sensors.

Wood Windows and Patio Doors


Grilles

For a full list of grille size and pattern availability contact your local Pella sales representative.

Integral Light Technology® Grilles

Grille Profile


- Extruded aluminum or wood grilles are adhered to the exterior face
- Wood grilles are adhered to the interior face
- Between-the-glass foam spacers, which are aligned with the interior and exterior grilles, replicate the appearance of true divided lights
- Typical grilles are 7/8" wide putty glazed or ogee profile, other standard and custom widths are available
- Custom grille patterns are available

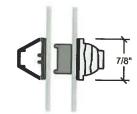

7/8", 1-1/4", and 2" widths

Roomside Removable Grilles

- Roomside wood grilles are securely attached to the interior, but can be removed for glass cleaning
- Typical grilles are 3/4" wide, other standard and custom widths and profiles are available

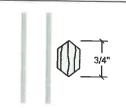

3/4", 1-1/4", and 2" widths

Grilles-Between-the-Glass

Grille Profile

Grille Profile

- Permanent aluminum grilles are factory-installed inside the airspace of insulating glass
- White, Tan2, Brown, Putty2, Black, Morning Sky Gray, Ivory, Sand Dune, Harvest, Cordovan or Brickstone interior.
- Grilles are 3/4" wide
- Interior colors complements today's most popular interior finishes; choose a color to coordinate with the window or door frame, or select a contrasting grille color for a one-of-a-kind look



Interior GBG Colors




Available Patterns

Traditional	9-Lite Prairie	Top Row	Cross	Custom Equally Divided	
	\$#####################################	I _{NA}	NO.		Pattern availability may vary depending on size of unit. Custom configurations are also available, for details contact your local Pella sales representative.


1) Appearance of exterior grille color may vary depending on the Low-E insulating glass selection.

(2) Tan or Putty Interior GBG colors are available in single-tone (Tan/Tan or Putty/Putty).


Pella 7/8 grille BAR

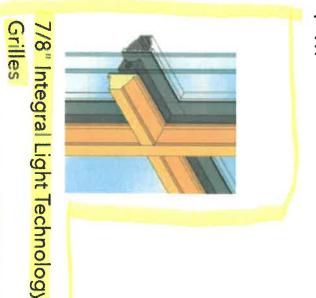

7/8" Integral Light Technology

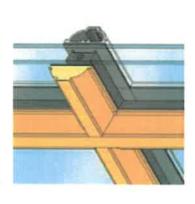

Grilles 1-1/4" Integral Light Technology

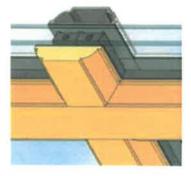


Grilles 2" Integral Light Technology

SIMULATED-DIVIDED-LIGHT GRILLES

- Grilles are permanently bonded to the inside and outside of the glass
- No spacer between the grilles

BEST USE: When you want the traditional look of divided-light windowpanes.

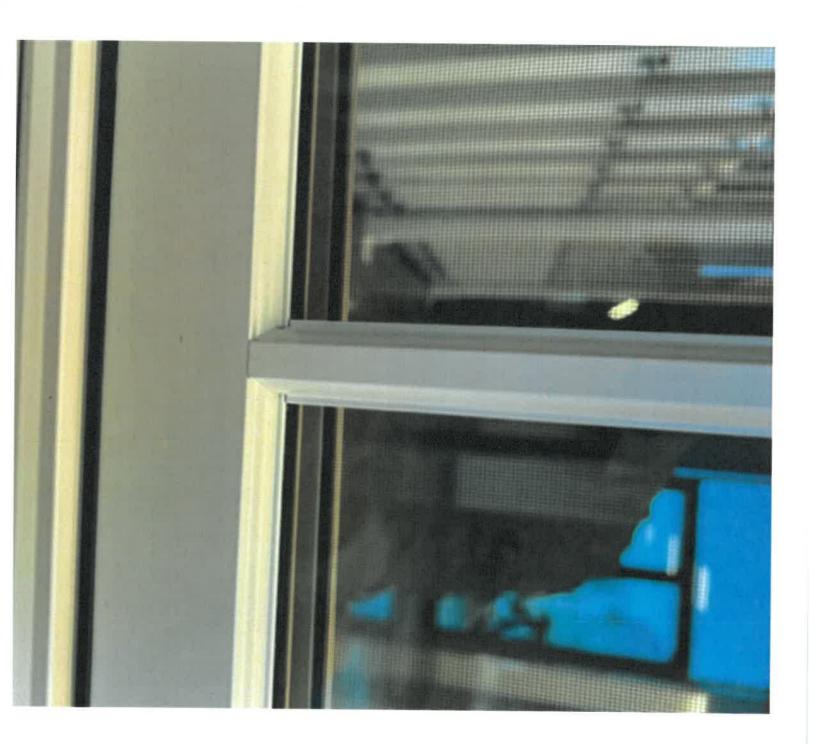


Exterior




Side View

Interior

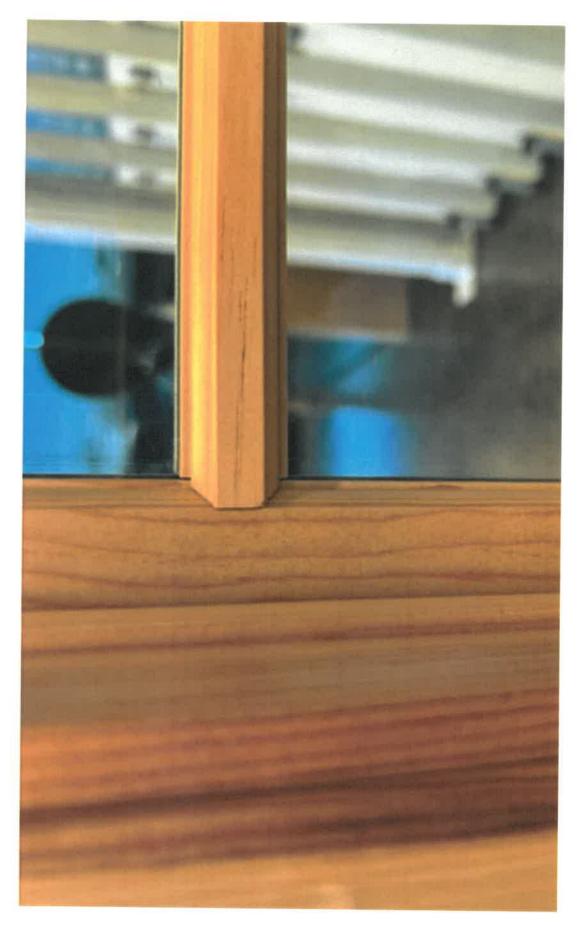

Finishes

EnduraClad® Protective Finish Standard Colors + Virtually Unlimited Custom Colors and Wood Options

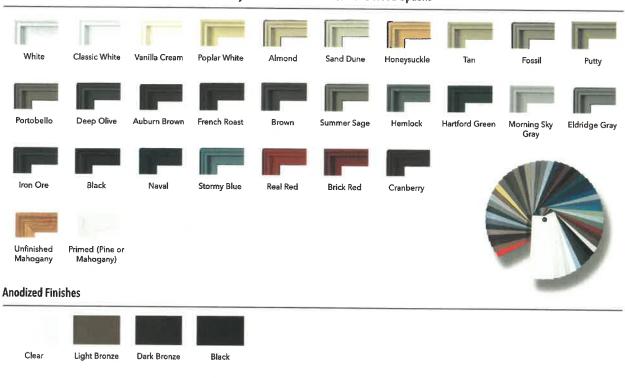

Interior Prefinished Colors



Screens



Vivid View* Screen

Provides the sharpest view and available as an upgrade on Pella wood windows and patio doors. Allows in 29% more light and is 21% more open to airflow compared to conventional screen.

PVDF 21/17 mesh, 78% light transmissive.

InView[™] Screen

Standard screen on Pella wood windows and patio doors, as well as Rolscreen* retractable screens on wood casement windows and Integrated Rolscreen* on Architect Series* Reserve™ single- and double-hung windows.

More transparent than conventional fiberglass, allows 14% more light and is 8% more open to airflow than conventional screen.

Vinyl coated 18/18 mesh fiberglass, Complies with performance requirements of SMA 1201.

Conventional Screen

Standard on Rolscreen* retractable screens on patio doors.

Black vinyl coated 18/14 mesh fiberglass, Complies with ASTM D 3656 and SMA 1201.

Improved airflow is based on calculated screen cloth openness. Screen cloth transmittance was measured using an integrated sphere spectrophotometer.

Because of printing and display limitations, actual colors may vary from those shown.

Hardware

Consult your local Pella Sales Representative for a full list of available hardware options.





Casement/Awning Window



Double-Hung Window



Hinged Patio Door Bifold Door,



Sliding Patio Door, Multi-slide Door,

Finishes



Distressed Nickel



Distressed Bronze

Classic Collection



Casement/Awning Window



Double-Hung Window



Hinged Patio Door Bifold Door,



Sliding Patio Door Multi-slide Door₂

Finishes



Antique Brass





Bright Brass



Satin Nickel



Oil-Rubbed Bronze

Matte Black

Essential Collection



Casement/Awning Window



Double-Hung Window



Hinged Patio Door Bifold Door,



Sliding Patio Door

Finishes



White



Champagne

Satin Nickel



Brown



Oil-Rubbed Bronze

Matte Black

Bronze

Finishes

Bright Brass



Multi-slide Door

Bright Brass

White Brown





Satin Nickel Oil-Rubbed

Polished

Custom Capabilities

Consult your local Pella Sales Representative for available options.









(1) Only available on Bifold configurations with a passage door. (2) Will not allow lead panel to stack completely Because of printing and display limitations, actual colors may vary from those shown.





PRODUCTS

CONTACT US



Order Sample

- · See Full Base Colour Chart
- ► See Full Design Colour Chart

1020 SiLazur

Semi-Transparent Mineral Stain

1020 SiLazur is a highly durable, semi-transparent mineral stain for interior and exterior use. It is designed to appear completely natural on the surface and can be diluted to any degree with 1050 PrimaSil in order to increase transparency and allow variation to show in the finish.

PRODUCT INFO:

- · Semi-transparent silicate dispersion stain for interior or exterior use
- For use on absorbent mineral based surfaces such as brick, stone, concrete, block, mortar
 joints and other masonry substrates
- Can be diluted to any degree with 1050 PrimaSil to increase transparency and allow variation to show in the finish promoting a natural appearance
- · Available in over 150 standard colors custom color matching available
- Dry to touch in approx. 2 hours, wait a minimum of 12 hours before re-coating although 24 hours is ideal
- Covers approx. 200 240 sq ft per gallon (varies on surface absorbency)
- · Fully breathable, anti-microbial, mildew resistant
- . 100% Non-Hazardous, allow to dry out and dispose of with regular garbage
- · Non-Flammable, 0 VOC
- . Non-Film forming, bonds by chemical reaction on the inside of the substrate
- Will never blister or peel
- · Apply with brush, roller or sprayer (back roll if spraying)
- · Apply an even coat and allow to absorb into surface soak up excess
- · Wash tools with water
- · Minimum application temperature is 5 C or 40 F and above
- · 10 year product replacement warranty 30-40 year lifespan





PRODUCTS





PERMA INT®

Order Sample

- See Full Base Color Chart
- See Full Design Color Chart

1010 QuartzGuard

Opaque Mineral Stain

1010 QuartzGuard is a highly durable, opaque mineral paint for interior and exterior use. 1010 QuartzGuard is designed to produce a completely uniform finish and hide background variation. It is highly effective at blending out previous repairs/discolorations/stains and producing a clean, uniform result. It can be diluted up to a maximum of 20% with 1050 PrimaSil in order to increase fluidity if desired.


PRODUCT INFO:

- Opaque silicate dispersion stain for interior or exterior use
- For use on absorbent mineral based surfaces such as brick, stone, concrete, block, mortar joints and other masonry substrates
- Excellent hiding capabilities produces a completely uniform finish
- Can be diluted up to 20% with 1050 PrimaSil to lower viscosity
- · Available in over 150 standard colors custom color matching available
- Dry to touch in approx. 2 hours, wait a minimum of 12 hours before re-coating although 24 hours is ideal
- Covers approx. 300 sq ft per gallon (varies on surface absorbency)
- Fully breathable, anti-microbial, mildew resistant
- 100% Non-Hazardous, allow to dry out and dispose of with regular garbage
- Non-Flammable, 0 VOC
- Non-Film forming, bonds by chemical reaction on the inside of the substrate
- Will never blister or peel
- . Apply with brush, roller or sprayer (back roll if spraying) dilute 20% with 1050 PrimaSil if
- Apply an even coat and allow to absorb into surface soak up excess
- Wash tools with water
- Minimum application temperature is 5 C or 40 F and above
- 10 year product replacement warranty 30-40 year lifespan





BASE COLORS

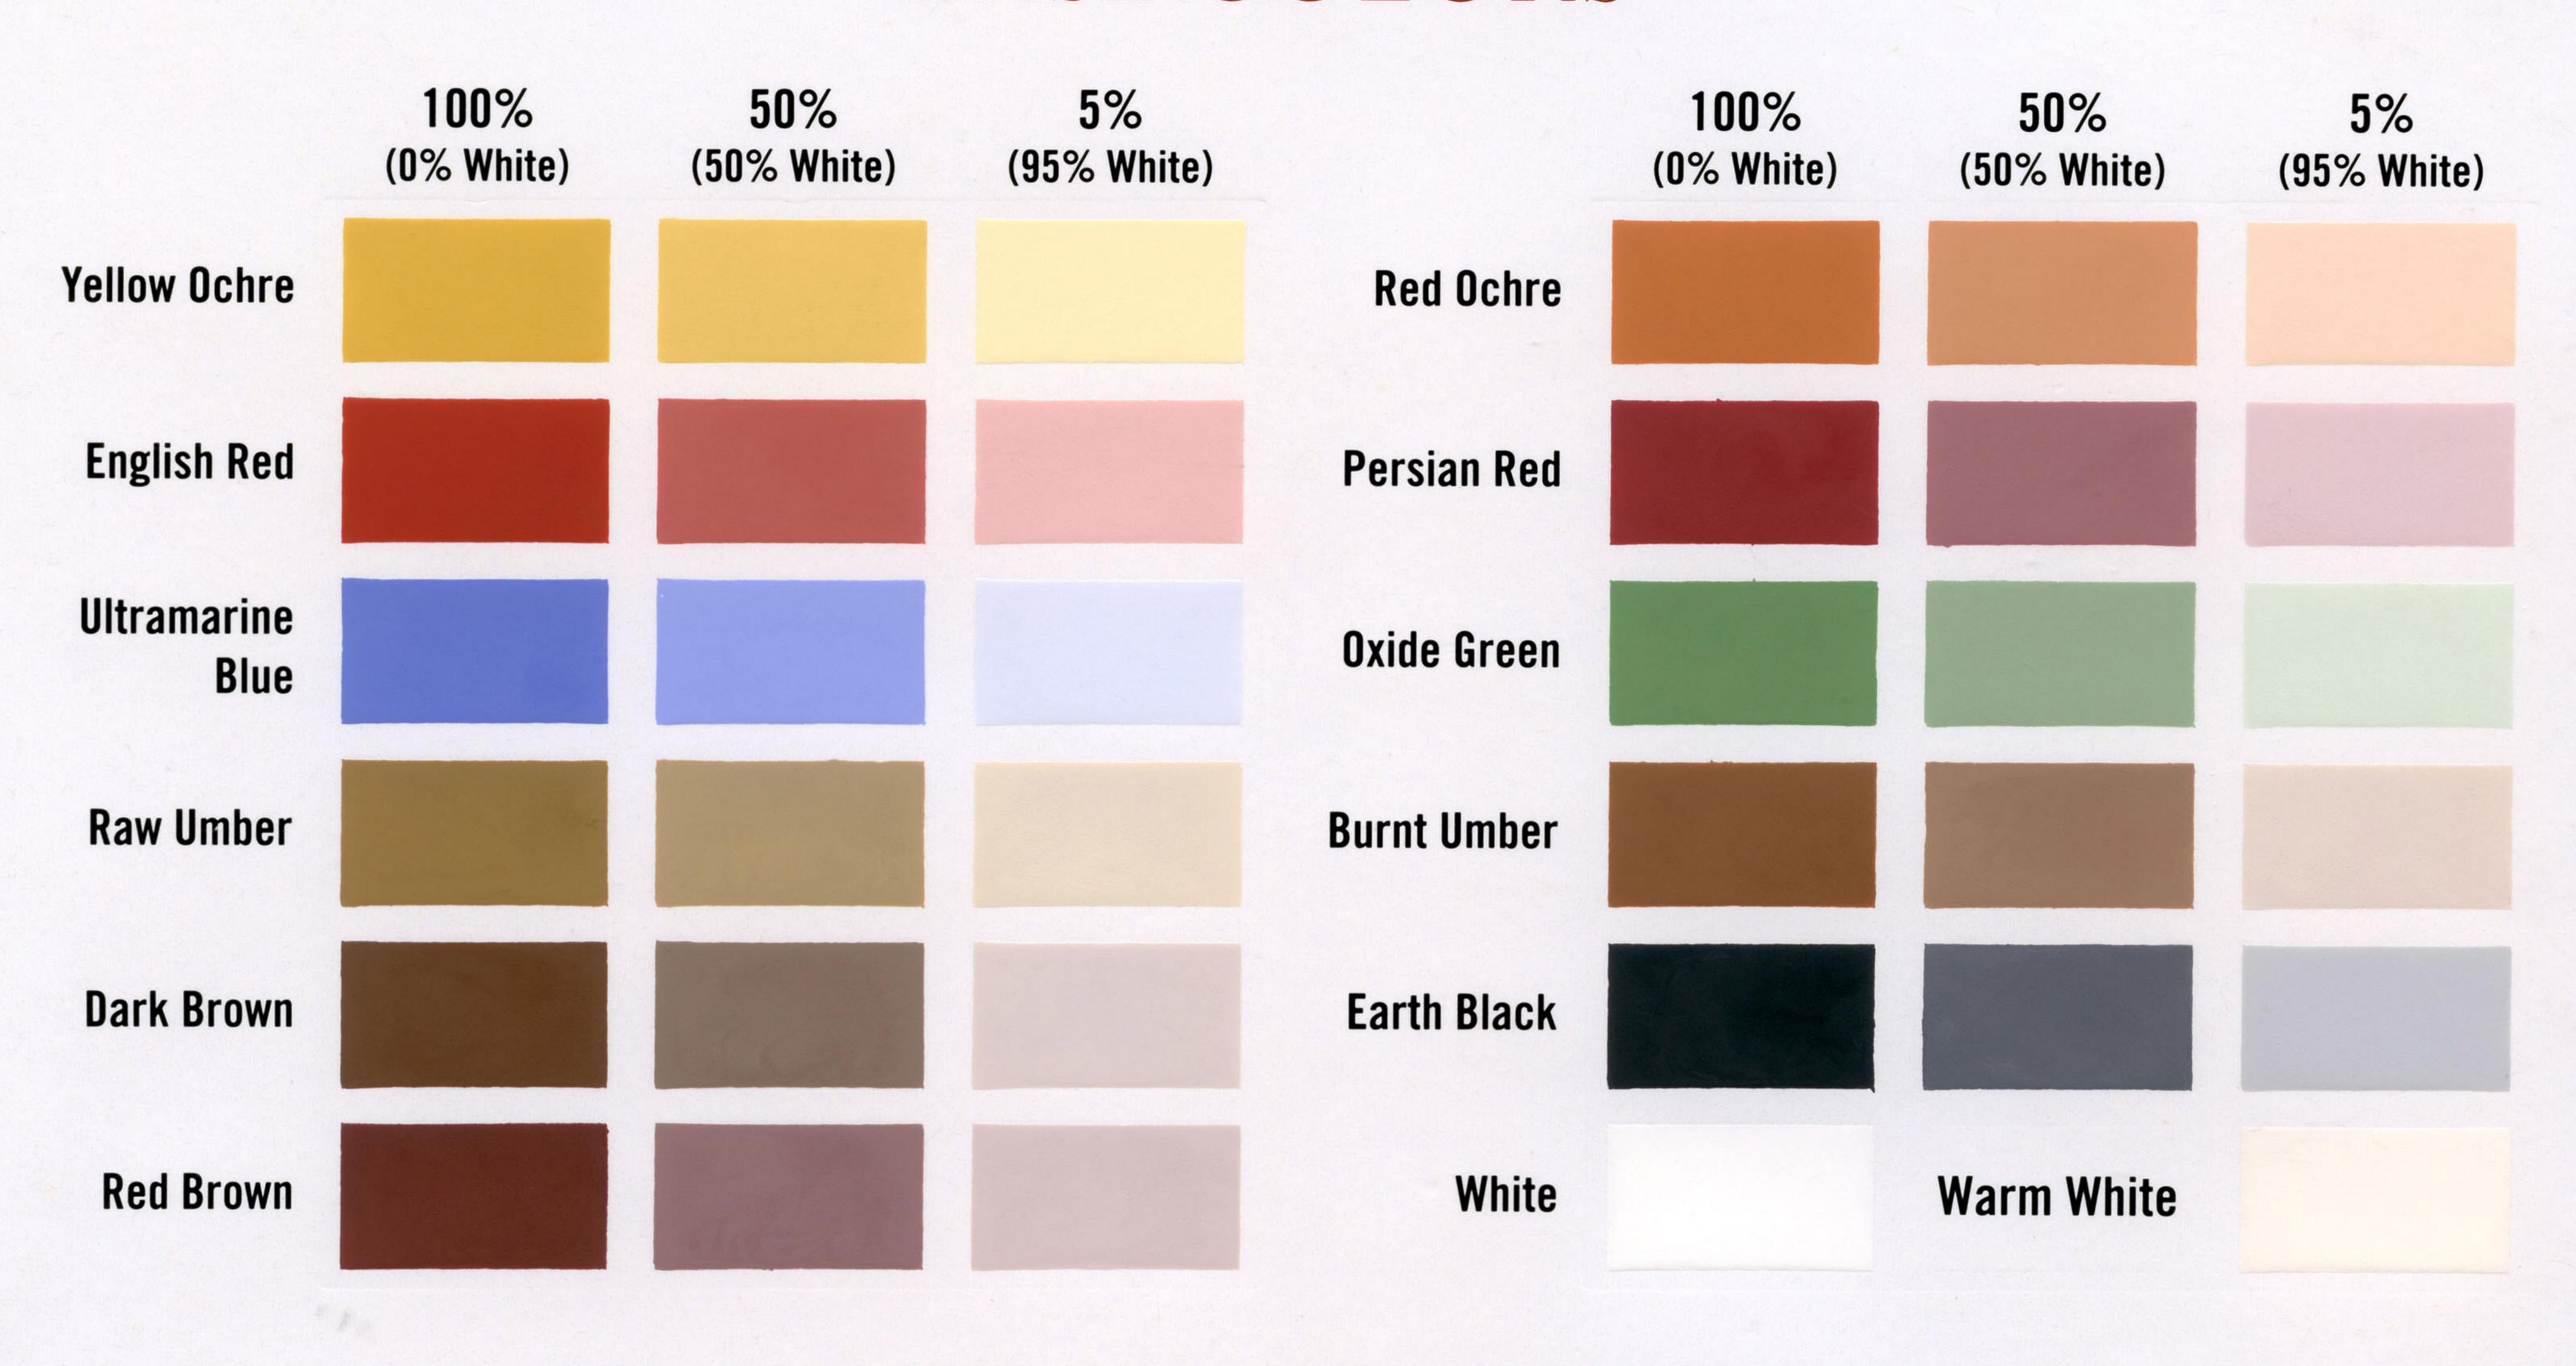

DESIGNER COLORS

BRICK STAIN

PT 5000 Coin Grey	PT 5005 Mysterious Sea	PT 5010 Twilight Blue	PT 5015 Lucky Clover	PT 5020 Sunrise	PT 5025 Autumn Gold	PT 5030 Red Grapefruit	PT 5035 Robin Red
PT 5001	PT 5006	PT 5011	PT 5016	PT 5021	PT 5026	PT 5031	PT 5036
Crystal Moon	Maya Blue	Benjamin Blue	Pacific Green	May Flowers	Flame	Rose	Remington
PT 5002	PT 5007	PT 5012	PT 5017	PT 5022	PT 5027	PT 5032	PT 5037
Enchantment	Slate Grey	Sea Breeze	Wilderness	Canary Yellow	Harvest Red	Marigold Red	Rust Red
PT 5003	PT 5008	PT 5013	PT 5018	PT 5023	PT 5028	PT 5033	PT 5038
Lilac Purple	Midnight Sky	Tea Leaf	Earth Green	Peach Yellow	Poppy	Cardinal Red	Crimson
PT 5004	PT 5009	PT 5014	PT 5019	PT 5024	PT 5029	PT 5034	PT 5039
Blue Jay	Deep Blue	Mint Green	Black Bark	Creamsicle	Ancient Artifact	Firebrick	Rhode Island Red

Custom color matching available on request to any manufacturer's samples.

*Due to limitations in color reproduction and print process, color swatches may vary from the actual product.





Phone: 540-437-2324 Fax: 540-437-9399 www.marcometals.com








VINYL SHUTTERS COMPOSITE WOOD SHUTTERS ALUMINUM HARDWARE VENTS CUPOLAS HOME

Home / Wood Shutters / PlacerCraft Wood Shutters / PlacerCraf...

Photo is a stock image and will not represent the options you choose.

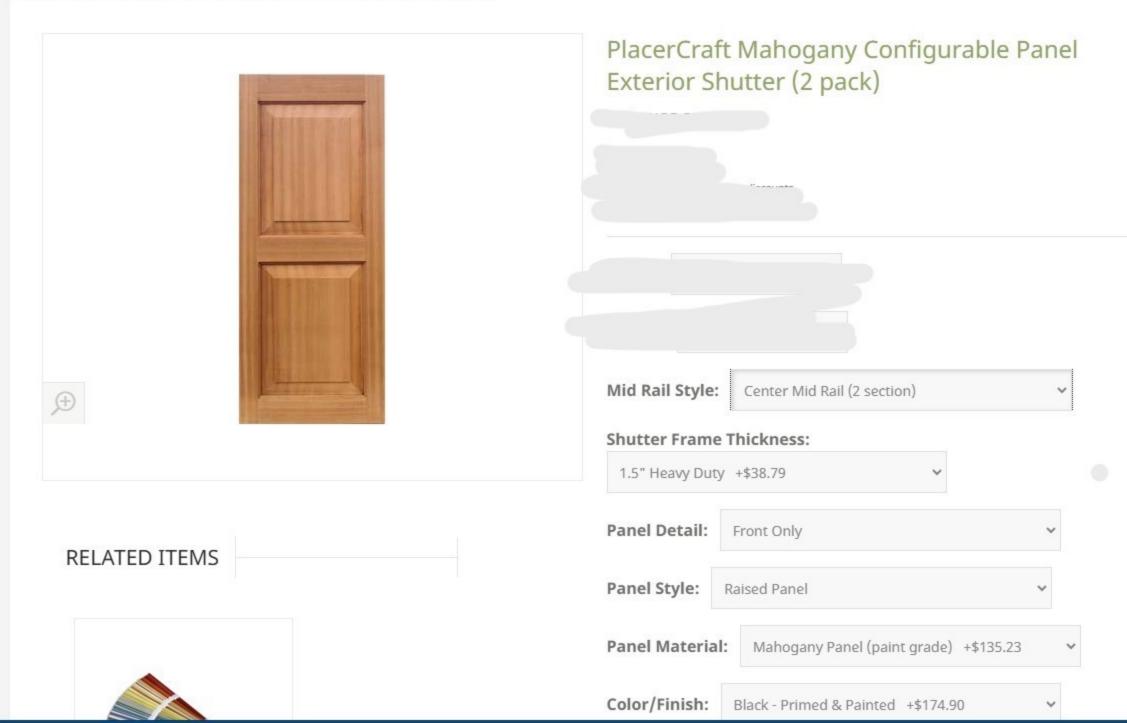

Before adding the paint color, your PlacerCraft wood shutters will be primed with acrylic primer/sealer. The Rockbridge Composite Shutters are primed with oil-based primer. The finish coats are in a satin sheen. The top coat paint colors for feature water-borne acrylic.

<Back To Previous Page

Chack to Frevious rage

