

600 DULANY ST SOUTH LATERAL PROPOSED FIBER ROUTE CITY OF ALEXANDRIA, VA ZAYO JOB# ISO-0400904


CITY OF ALEXANDRIA PERMIT


OCTOBER 03, 2023

ISSUED FOR CONSTRUCTION



# **SITE MAP** CITY OF ALEXANDRIA, VA

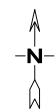

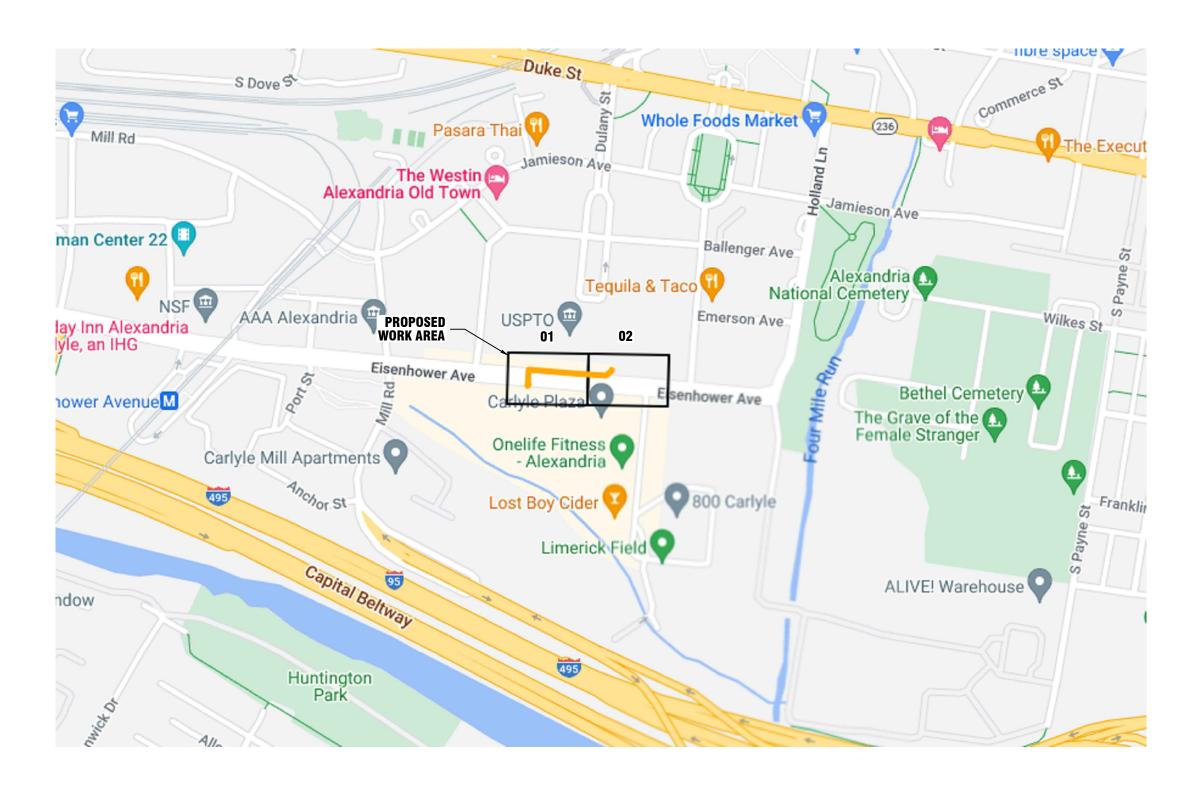

DISCLAIMER:
UTILITY LOCATIONS SHOWN ON THIS
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UNDERGROUND FACILITIES. THE
CONTRACTOR SHALL BE FULLY
RESPONSIBLE FOR COMPLIANCE WITH STATEWIDE AND/OR LOCAL AREA "ONE CALL" PROGRAMS AND REQUIREMENTS.



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	ISSUE DATE: 10.3.2023				SCALE:	N.T.S.	1
REVISION	DATE	INITIAL	DRAWN BY: JUSTIN MURPHY				ı
			ENGINEERED BY: KCI				
			ZAYO PROJECT NO: ISO-0400904				
			KCI PROJECT NO: 0223076962	SHEET NO. TO1 OF	TO1 OF TO	T06	
			EST NO:		IUI OF IU		
			APPROVED BY:				

ZAYO:

**UTILITIES:** 

MIKE GATES 571-244-8204 PROJECT MANAGER

MISS UTILITY (VA)

24 HOUR NUMBER

1-800-552-7001

# **PERMITTING AGENCIES:**

ALEXANDRIA PERMIT & PLAN KIMBERLY MERRITT 703-746-4056

KCI:

PETER MILEWSKI (540) 220-6319 SR. PROJECT MANAGER


SANDRA JOHNSON PERMIT SPECIALIST (540) 895-2194

JUSTIN MURPHY

(540) 710-5416

DESIGNER IV

NOTE: THIS INFORMATION IS OR WILL BE BASED ON AREA OF WORK

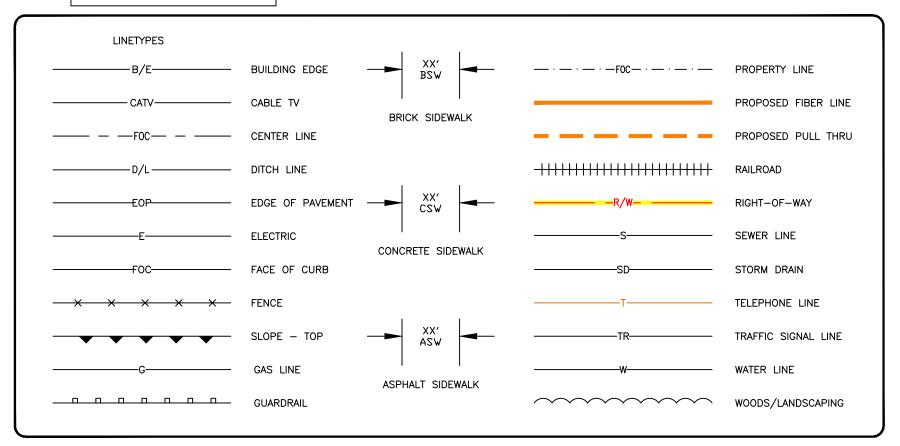

### **ELECTRIC** (E) ELECTRIC MANHOLE $\boxtimes$ ELECTRIC TRANSFORMER POWER POLE PARKING METER Δ 0-STREET LIGHT $\boxtimes$ TRAFFIC CONTROL BOX 0 TRAFFIC POLE TRAFFIC SIGNAL

SYMBOLS

SE	WER/STORM
©	SEWER MANHOLE
©	STORM DRAIN MANHOLE
	GRATE INLET
<del></del>	CATCH BASIN

GAS

(E)

GAS MANHOLE

GAS VALVE

	WATER					
©	WATER MANHOLE					
त्रं	WATER VALVE					
	WATER METER					
<b>-</b> ∳-	FIRE HYDRANT					
त्रं	IRRIGATION VALVE					

	GENERAL
<del>0</del>	SIGN
0	STEEL POLE
0	STEEL POST
•	PROPERTY PIN
⊞	CONCRETE POLE
•	TEST PIT
۵	MAILBOX
$\odot$	TREE

	TELEPHONE	
©	TELEPHONE MANHOLE	
	TELEPHONE HH	
	PROPOSED HH	
<u> </u>	PROPOSED MANHOLE	
X	ANCHOR	
$\boxtimes$	TELEPHONE PEDESTAL	
×	PROPOSED PEDESTAL	
$\otimes$	TELEPHONE POLE	
0	VERIZON MANHOLE	
C⇒	FIBER MARKER TUBE	
X	PROPOSED ANCHOR	
??'L-6.6M 5/8"	PROPOSED ANCHOR TEXT	
	PROPOSED AERIAL SLACK COIL	
	PROP AERIAL SPLICE	
8	PROPOSED POLE	

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			KCI PROJECT NO: 0223076962	SHEET NO. TO2 OF TO6
			EST NO:	SHEET NO. 102 OF 106
	·		APPROVED BY:	

#### **GENERAL NOTES:**

- ALL WORK WILL COMPLY WITH APPLICABLE LOCAL, STATE, AND FEDERAL REGULATORY AGENCIES, INCLUDING, BUT NOT LIMITED TO, OSHA, NESC, DOT, RPA, ETC. GENERAL NOTES WILL APPLY TO ALL DRAWINGS.
- 2. THE CONTRACTOR WILL NOTIFY (IF APPLICABLE) THE ADJACENT PROPERTY OWNERS A MINIMUM OF 24 HOURS IN ADVANCE OF CONSTRUCTION.
- 3. ALL TRAFFIC CONTROL DEVICES WILL BE IN PLACE PRIOR TO CONSTRUCTION. DEVICES NO LONGER NEEDED WILL BE REMOVED AS QUICKLY AS POSSIBLE
- 4. PEDESTRIAN TRAFFIC AREAS MUST BE MAINTAINED AT ALL TIMES.
  PEDESTRIANS WILL NOT BE ROUTED ON TO PRIVATE PROPERTY.
- NO MATERIALS OR EQUIPMENT WILL BE STORED OR ALLOWED TO STAND UNPROTECTED WHERE PEDESTRIAN OR VEHICULAR TRAFFIC IS PRESENT.
- NO EQUIPMENT OR MATERIALS WILL BE STORED ON ROAD SURFACE DURING NON-WORK PERIODS.
- 7. NO EQUIPMENT OR MATERIALS MAY BE STORED ON THE SIDEWALK.
- 8. EXCAVATION MATERIAL WILL BE STORED AWAY FROM THE PAVED ROADWAY. ALL SPILLED MATERIAL WILL BE PICKED UP
- 9. MUNICIPAL ROAD SIGNS, DELINEATORS, GUARDRAILS, ETC. WILL NOT BE REMOVED WITHOUT PRIOR WRITTEN PERMISSION FROM THE APPROVING ALITHOPITY
- ALL WORK WILL BE PERFORMED IN ACCORDANCE WITH THE CITY, COUNTY, AND STATE SPECIFICATIONS AND STANDARDS.

## **DATES OF CONSTRUCTION:**

CONSTRUCTION ON THE RIGHT OF WAY IS PLANNED TO BE A YEAR ROUND ACTIVITY. SOILS DATA FOR SOILS MAP AND SOILS INFORMATION PROVIDED.

# **EROSION SEDIMENTATION CONTROL PROGRAM:**

EROSION AND SEDIMENTATION CONTROLS SHOWN ARE PROVIDED TO ACCOMMODATE ONSITE DRAINAGE AREAS DURING THE CONSTRUCTION PHASE. ADDITIONAL OR REVISED CONTROLS MAY BE INSTALLED AS DETERMINED NECESSARY. EROSION AND SEDIMENTATION CONTROL MEASURES SHALL BE CONSTRUCTED AND MAINTAINED ACCORDING TO THE STANDARDS AND SPECIFICATIONS IN THE CURRENT VIRGINIA EROSION AND SEDIMENT CONTROL HANDBOOK.

### **PHASE OF LAND DISTURBING ACTIVITIES:**

CONTROLS SHOWN SHALL BE INSTALLED AS THE FIRST ITEM OF CONSTRUCTION AND MAINTAINED FOR CONSTRUCTION ACTIVITIES LASTING MORE THAN A ONE DAY SCHEDULE. ALL AREAS NOT TO BE IMMEDIATELY BUILT UPON SHALL BE SEEDED FOR TEMPORARY VEGETATION. ALL CONTROLS ARE TO REMAIN IN PLACE FOR THE DURATION OF THE JOB. REMOVAL, REGRADING AND SEEDING OF THE TEMPORARY DIVERSION DIKES WILL BE THE FINAL ACT OF GRADING IF REQUIRED.

#### **SEQUENCE OF CONSTRUCTION:**

- 1. PLACEMENT OF EROSION AND SEDIMENTATION CONTROLS
- 2. TRENCHING AND/OR DIRECTIONAL BORING
- 3. UTILITY INSTALLATION
- 4. FINAL GRADING AND VEGETATION
- 5. REMOVAL OF CONTROLS

#### **GENERAL LAND CONSERVATION NOTES:**

- NO DISTURBED AREA WILL BE DENUDED FOR MORE THAN SEVEN (7) CALENDAR DAYS UNLESS AUTHORIZED BY CITY OF ALEXANDRIA, VA.
- 2. ALL EROSION AND SEDIMENTATION CONTROL MEASURES SHALL BE PLACED AS THE FIRST STEP IN GRADING.
- 3. ELECTRIC POWER, TELEPHONE AND GAS SUPPLY TRENCHES SHALL BE COMPACTED, SEEDED AND MULCHED. WITHIN FIVE (5) DAYS OF BACKFILL.
- 4. ALL TEMPORARY EARTH BERMS, DIVERSION DIKES, SILT DAMS, AND SOIL STOCKPILES SHALL BE SEEDED AND MULCHED FOR TEMPORARY VEGETATIVE COVER IMMEDIATELY AFTER GRADING. STRAW OR HAY IS REQUIRED.
- 5. DURING CONSTRUCTION, ALL STORM SEWER INLETS SHALL BE PROTECTED BY SILT TRAPS MAINTAINED AND MODIFIED AS REQUIRED DURING CONSTRUCTION PROGRESS.
- 6. ANY DISTURBED AREA NOT COVERED BY NOTE 1 ABOVE AND NOT PAVED, SODDED, OR BUILT UPON BY NOVEMBER 1, OR DISTURBED AFTER THAT DATE, SHALL BE MULCHED WITH HAY OR STRAW MULCH AT THE RATE OF TWO (2) TONS PER ACRE AND OVER—SEEDED BY MARCH 15.
- 7. AT THE COMPLETION OF THE CONSTRUCTION PROJECT AND PRIOR TO RELEASE OF THE BOND, ALL TEMPORARY SILTATION AND EROSION CONTROLS SHALL BE REMOVED UPON THE APPROVAL OF CITY OF ALEXANDRIA, AND ALL DENUDED AREAS SHALL BE STABILIZED WITH VEGETATION.
- ALL EROSION AND SEDIMENTATION CONTROL MEASURES SHALL MEET THE STANDARDS AND SPECIFICATIONS OF THE CURRENT VIRGINIA EROSION AND SEDIMENT CONTROL HANDBOOK.
- NO MORE THAN 500 LINEAR FEET OF TRENCH MAY BE OPENED AT ONE TIME.
- EXCAVATION MATERIAL SHALL BE PLACED ON THE UPHILL SIDE OF THE TRENCH.
- 11. EFFLUENT FROM THE DEWATERING OPERATIONS SHALL BE FILTERED OR PASSED THROUGH AN APPROVED SEDIMENT TRAPPING DEVICE, OR BOTH, AND DISCHARGED IN A MANNER THAT DOES NOT ADVERSELY AFFECT FLOWING STREAMS OR OFF—SITE PROPERTY.
- MATERIAL USED FOR BACKFILLING TRENCHES SHALL BE PROPERLY COMPACTED IN ORDER TO MINIMIZE EROSION AND PROMOTE STABILIZATION.
- 13. RESTABILIZATION SHALL BE ACCOMPLISHED IN ACCORDANCE WITH THESE REGULATIONS.
- 14. APPLICABLE SAFETY REGULATIONS SHALL BE COMPLIED WITH.
- 15. WHERE CONSTRUCTION VEHICLE ACCESS ROUTES INTERSECT PAVED OR PUBLIC ROADS, PROVISIONS SHALL BE MADE TO MINIMIZE THE TRANSPORT OF SEDIMENT BY VEHICULAR TRACKING ONTO THE PAVED SURFACE. WHERE SEDIMENT IS TRANSPORTED ONTO A PAVED OR PUBLIC ROAD SURFACE, THE ROAD SURFACE SHALL BE CLEANED THOROUGHLY AT THE END OF EACH DAY. SEDIMENT SHALL BE REMOVED FROM THE ROADS BY SHOVELING OR SWEEPING AND TRANSPORTED TO A SEDIMENT CONTROL DISPOSAL AREA. STREET WASHING SHALL BE ALLOWED ONLY AFTER SEDIMENT IS REMOVED IN THIS MANNER.

#### **CONSTRUCTION NOTES:**

- 1. FIBER OPTIC WARNING TAPE WILL BE PLACED 12" BELOW THE EXISTING GRADE IN ALL EXCAVATIONS.
- VERIFICATION OF THE LOCATION OF EXISTING UTILITY CROSSINGS IS THE RESPONSIBILITY OF THE CONTRACTOR. HAND DIGGING WILL BE UTILIZED WHERE REQUIRED.
- 3. CALL THE LOCAL UTILITY ONE-CALL AT LEAST 72 HOURS IN ADVANCE OF ANY CONSTRUCTION. 1-800-552-7001
- A 12" SEPARATION BETWEEN PROPOSED CONDUIT AND OTHER UTILITIES WILL BE MAINTAINED.
- CONDUIT CAPS WILL BE PLACED ON THE ENDS OF ALL VACANT DUCTS DURING CONSTRUCTION, UPON COMPLETION, AND WHILE AWAITING FIBER INSTALLATION.
- ALL INSTALL DUCTS WILL BE PROOFED USING A MANDRILL 1/4" SMALLER THAN THE PIPE ID PVC AS SHOWN ON DRAWING.
- 7. THE MINIMUM BENDING RADIUS FOR FIBER CABLE WILL BE 36".
- MAXIMUM CABLE INSTALLATION TENSION WILL NOT EXCEED 600 POUNDS. A 600 POUND BREAKAWAY SWIVEL WILL BE USED DURING PULLING.
- 9. THE REMOVAL AND STORAGE OF ALL SHRUBBERY TO BE REPLACED IS THE RESPONSIBILITY OF THE CONTRACTOR.
- 10. THE CONTRACTOR WILL RESTORE ALL DISTURBED AREAS TO THEIR ORIGINAL OR BETTER CONDITION.
- 11. IT IS THE RESPONSIBILITY OF THE CONTRACTOR TO MAINTAIN CONSTRUCTION AS—BUILT DRAWINGS AND PRESENT A COMPLETE SET OF RED—LINED DRAWINGS TO ZAYO WITHIN 14 DAYS OF COMPLETION OF THE WORK.
- 12. CONDUITS WILL BE TERMINATED ABOVE THE MIDPOINT OF MANHOLE.
- 13. PLACE 100 FEET FIBER SLACK COIL IN EACH HANDHOLE/MANHOLE.
- 14. HAND DIG UNDER ANY BURIED UTILITY CABLES AS REQUIRED.
- 15. ALL CONDUITS WILL BE PLACED AT A MINIMUM OF 36" COVER UNLESS ROCK IS ENCOUNTERED. IN CASE OF ROCK, CONDUIT MAY BE PLACED AT A MINIMUM OF 36" INCHES AND ENCASED IN STEEL PIPE SIZED APPROPRIATELY. IF 36" COVER IS NOT ACHIEVABLE THE ROCK MUST BE EXCAVATED TO A MINIMUM DEPTH OF 24" INCHES AND THE CONDUIT MUST BE ENCASED IN CONCRETE.

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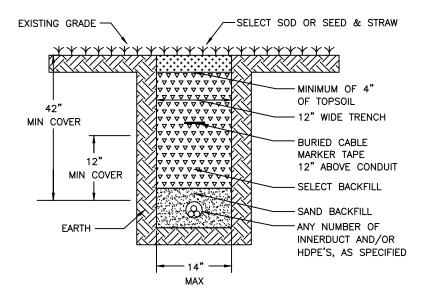
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# SOD/UNIMPROVED AREA TRENCH RESTORATION TYPICAL



- 1. ALL BACKFILL MUST BE APPROVED BY ENGINEER OR PERMITTING AUTHORITY INSPECTOR.
- 2. EXCAVATED MATERIAL MAY BE DEEMED SUITABLE BACKFILL BY ENGINEER, AND/OR PERMITTING AUTHORITY.
- 3. A MAXIMUM OF EIGHT (8) INCH LIFTS OF BACKFILL MATERIAL WILL BE ALLOWED. FOUR (4) INCHES OF CLEAN SAND SHALL BE PLACED ABOVE THE CONDUIT.
- 4. THE BOTTOM OF THE TRENCH SHALL BE LEVEL, FLAT, AND NOT HAVE ANY ROCK DEBRIS.
- 5. ALL DISTURBED GRASS AREAS ARE TO BE SEEDED WITH KENTUCKY 31 FESCUE WITH NUTRIENTS APPLIED AND MAINTAINED TO ACHIEVE A SATISFACTORY GRASS COVER TO CONTROL EROSION.


# **HDPE CONDUIT CONFIGURATION**


# TYPICAL "C"

# CABLE IN CONDUIT

# TYPICAL "D"

MULTIPLE CABLE IN

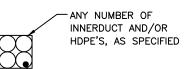

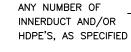


OUTSOURCE NAME "OWNER OF FIBER" FIBER CABLE

FIBER CABLE

## **PLACEMENT - TYPICALS**


# TYPICAL "A"

PLACE CONDUIT CROSS SECTION

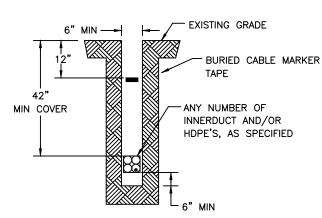

# TYPICAL "B"

PLACE HDPE (DIRECTIONAL BORE) CROSS SECTION

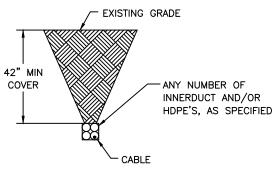

BACKFILL MUST BE MADE WITH ROCK FREE MATERIAL

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MICROTRENCH PROFILE TYPICAL

9" COVER

1" TRENCH

DEPTH OF ASPHALT

**ASPHALT** 

FIBER OPTIC

MICRO DUCTS




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# 2' x 3' x 3' HANDHOLE

# **COVER FEATURES:**


- \* STANDARD LOAD RATING: 20,800 LBS. WHEEL LOAD ON 10" X 20" PLATE
- \* 2 BOLT DOWN LOCATIONS
- \* STAINLESS STEEL BOX INSERTS
- \* POLYMER CONCRETE CONSTRUCTION
- \* NON-SKID SURFACE (STANDARD)
- \* 20K TO BE EMBOSSED ON TOP
- \* APPROX. WEIGHT 120 LBS.

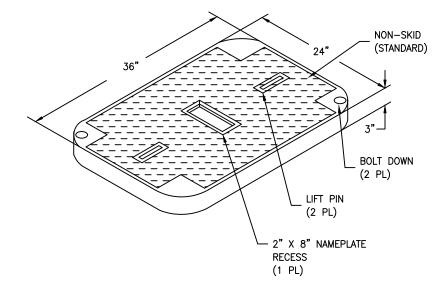

# **BOX FEATURES:**

POLYMER CONCRETE CONSTRUCTION

- \* LIGHTWEIGHT
- \* STACKABLE
- \* APPROX. WEIGHT 300 LBS.

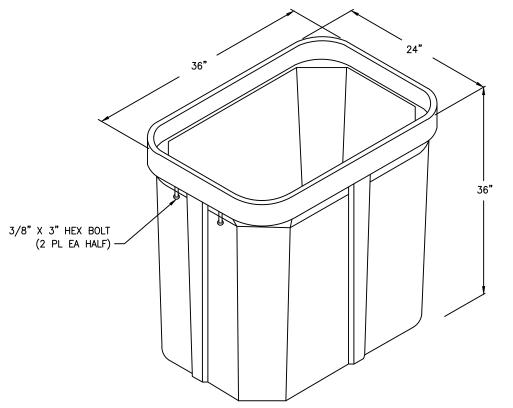

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PROJECT SUMMARY FOR 600 DULANY ST SOUTH LATERAL				
DESCRIPTION	QUANTITY	UNIT		
72 FIBER (INCLUDES SLACK SOILS + 5%)	869	FT		
1.25" HDPE + 10%	17	FT		
2'X3'X3' HANDHOLE	1	EA		
SPLICE CASE	1	EA		

FIBER REEL LENGTHS +5%

REEL #1 (72 FIBER) = 869'

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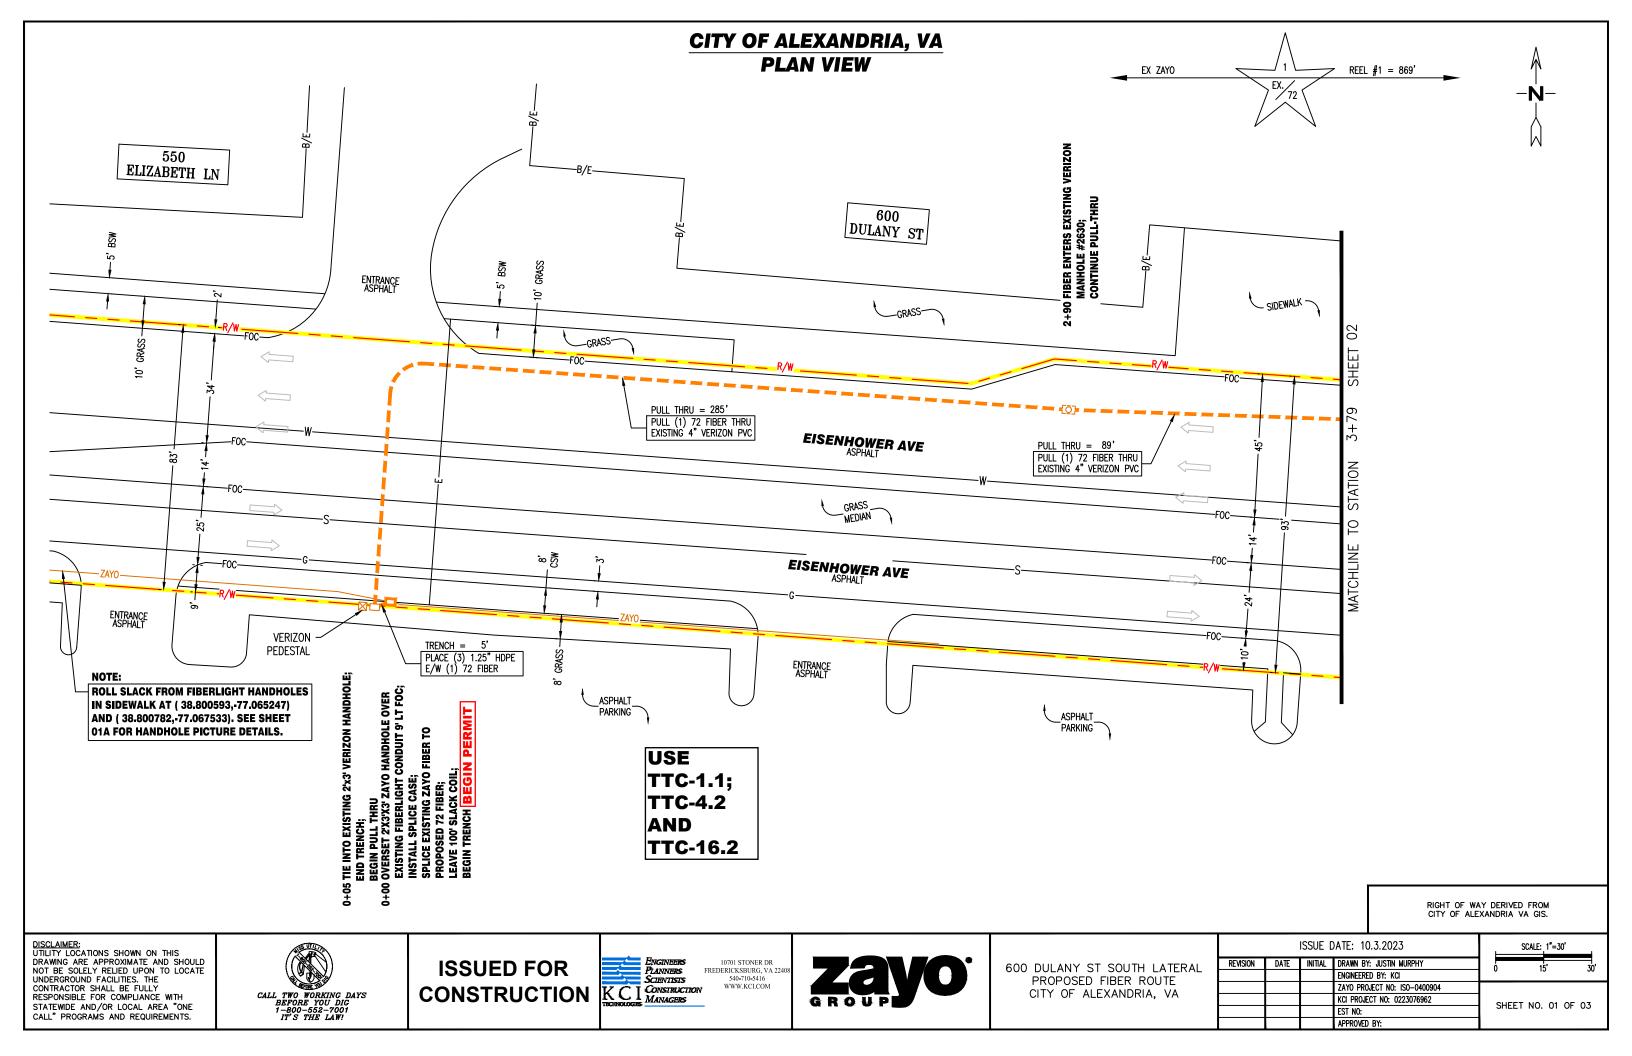


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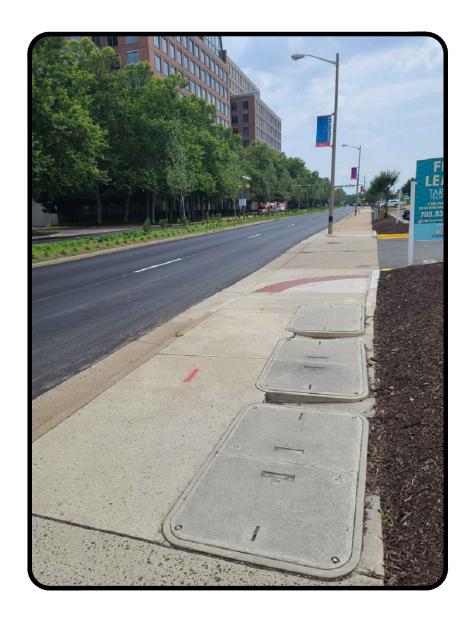
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# CITY OF ALEXANDRIA, VA HANDHOLE PICTURES



PICTURE '1'
FIBERLIGHT HANDHOLE AT
MILLS RD INTERSECTION
SCALE: N.T.S.



<u>PICTURE '2'</u> FIBERLIGHT HANDHOLE EAST OF ELIZABETH LN INTERSECTION

SCALE: N.T.S.

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MANAGERS

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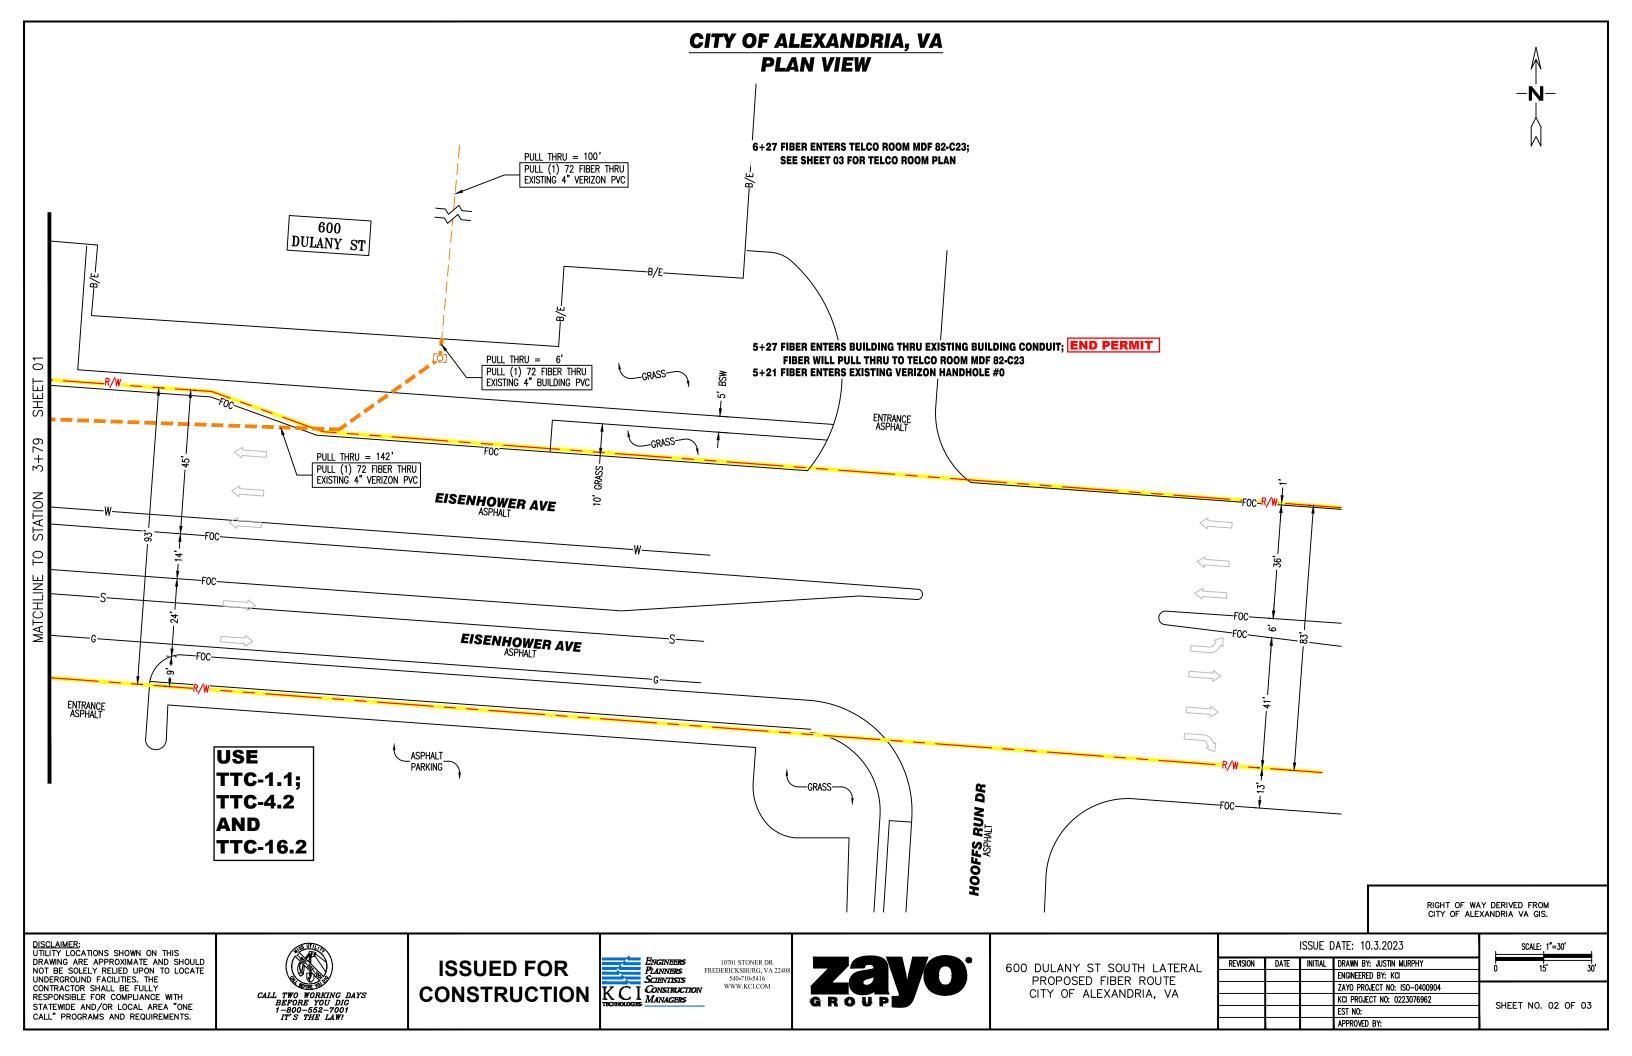
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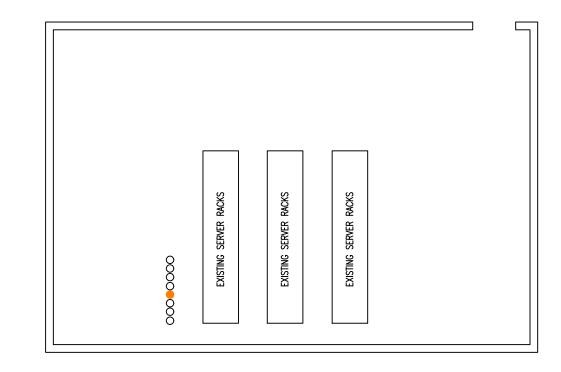




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# 600 DULANY STREET TELCO ROOM MDF 82-C23



ZAYO TO CUT INTO EXISTING (1) SPARE CRANCE CONDUIT INSIDE EXISTING COMMUNICATION MANHOLE TO UTILIZE IT TO GET TO TELCO ROOM MDF 82-C23

STA. 3+20
DOSTING 4\* CONDUIT STUB-UP WITH
DOSTING (1) SPACE ORANGE COMOUNT
FROM DOSTING COMMUNICATION MANHOLE

6+27 FIBER ENTERS TELCO ROOM MDF 82-C23 THRU EXISTING 4" PVC STUB-UP; LEAVE 100' SLACK COIL FOR TERMINATION

CALL TWO WORKING DAYS
BEFORE YOU DIG
1-800-552-7001
IT'S THE LAW!

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