

# Docket Item# 3 Special Use Permit # 2023-00107 1508 Mount Vernon Avenue Junction Bakery & Bistro – Increase in Permitted Floor Area Ratio


\_\_\_\_\_\_

Application	General Data		
<b>Request:</b> Public hearing and	<b>Planning Commission</b>	March 5, 2024	
consideration of a Special Use	Hearing:		
Permit to increase FAR up to	City Council	March 16, 2024	
.75	Hearing:		
Address: 1508 Mount Vernon	Zone:	CL/Commercial Low	
Avenue			
Applicant: Noe Landini	Small Area Plan:	Potomac West	

**Staff Recommendation:** APPROVAL subject to compliance with all applicable codes and ordinances and the recommended permit conditions found in Section III of this report.

#### **Staff Reviewers:**

Patrick Silva, Urban Planner, <a href="mailto:patrick.silva@alexandriava.gov">patrick.silva@alexandriava.gov</a>
Ann Horowitz, Principal Planner, <a href="mailto:ann.horowitz@alexandriava.gov">ann.horowitz@alexandriava.gov</a>

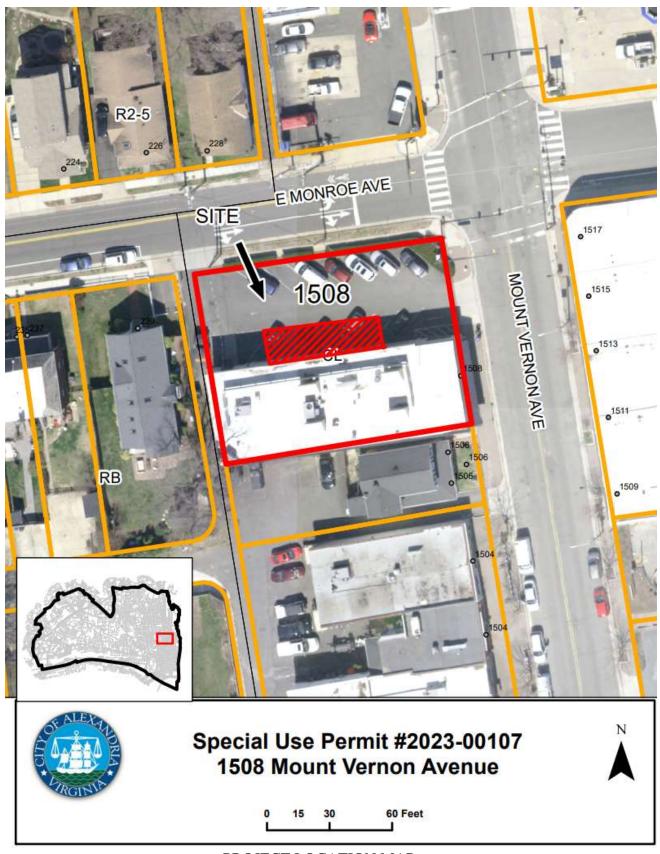

PROJECT LOCATION MAP

#### I. DISCUSSION

The applicant, Noe Landini, requests Special Use Permit approval for an increase in the permitted floor area ratio, pursuant to Section 4-106(B)(1) of the Zoning Ordinance, to accommodate the construction of a new 720 square foot covered outdoor dining patio at Junction Bakery & Bistro located at 1508 Mount Vernon Avenue.

#### SITE DESCRIPTION

The subject site is located on one corner parcel of record. The parcel has 90 feet of frontage on Mount Vernon Avenue, 120 feet of frontage on East Monroe Avenue, and a lot area of 11,244 square feet. It is developed with a one-story 5,348 square foot commercial building with an eight-space surface parking lot, including one loading space located on-site (Figure 1).

A mix of commercial uses — personal service, restaurant, retail, and automobile service stations — surround the restaurant to the east, north, and south while single family dwellings and townhouses are located to the west.



Figure 1: Site Context

#### **BACKGROUND**

In February 1996, City Council first approved Special Use Permit #1995-00205 for a restaurant use, known as Mancini's Restaurant, at the subject site. In November 1996, City Council approved both Special Use Permit #1996-00156 for additional seating, outdoor dining, and an increase in the hours of operation for the business as well as Encroachment #1996-00005 to permit eight seats of outdoor dining in the public right of way along Mount Vernon Avenue located in front of the

business and for an awning. In November 1998, City Council approved Special Use Permit #1998-00119 which authorized live entertainment and on-premises alcohol sales. In March 1999, City Council approved Encroachment #1999-00001 to permit the use of the public alleyway at the rear of the restaurant for customer and employee parking. In May 2001, City Council approved Special Use Permit #2001-00020 to allow extended hours of operation. In June 2002, City Council approved Special Use Permit #2002-00024, a one-year review of the previous approval, which also addressed resident concerns related to noise from supply deliveries and employees parking on nearby streets. In November 2015, staff administratively approved Special Use Permit #2015-00102 for a change of ownership for the existing restaurant, which included a retail bakery and accessory catering, from Barbara Mancini to Noe Landini who began operating the business as Junction Bakery & Bistro. In January 2016, City Council approved Special Use Permit #2016-00077 which allowed the business to begin selling off-premises beer and wine. Most recently, in April 2023, staff administratively approved Special Use Permit #2023-00012 for a minor amendment to Special Use Permit #2016-00077 to allow the applicant to add 32 additional seats of outdoor dining in the on-site surface parking lot reducing the total amount of available off-street spaces from twelve to nine.



Figure 2: Junction Bakery from Mt. Vernon Ave.

#### **PROPOSAL**

The applicant requests Special Use Permit approval to increase FAR up to .75 at the subject site. The applicant's proposal would add a new 720 square foot covered outdoor dining patio, as an addition to the north side of the building and in the on-site surface parking lot, where the 32 outdoor dining seats now exist. A Special Use Permit is required to approve the proposed covered patio as the 720 square feet of floor area would result in a floor area ratio of .53, whereas Section 4-106(B)(1) of the Zoning Ordinance states that the maximum floor area ratio permitted for a nonresidential property by right is 0.5. Pursuant to Section 4-106(B)(1) of the Zoning Ordinance,

the floor area ratio for a nonresidential property in the CL/Commercial Low zone may be increased to an amount not to exceed .75 with approval of a Special Use Permit.

The proposed covered patio would occupy one parking space in the on-site lot, bringing the available off-street parking total to seven spaces.

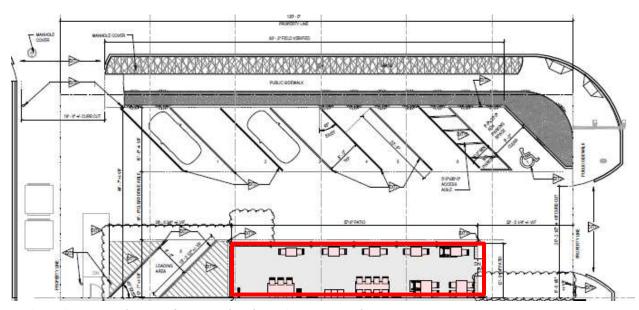


Figure 3: Proposed area to be covered and a patio constructed

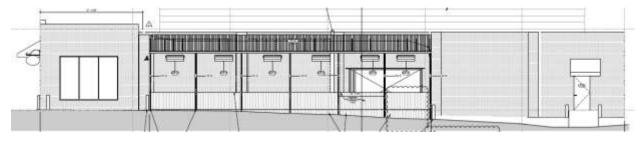


Figure 4: South facing patio elevation

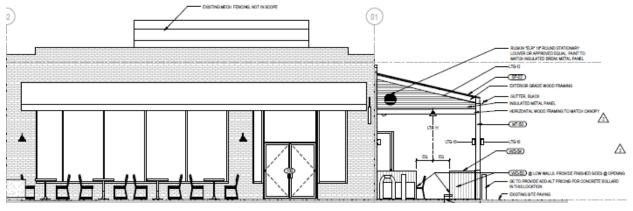


Figure 5: West facing patio elevation

**PARKING** 

The business currently occupies 5,348 square feet of floor area for a restaurant and is approved to operate up to 40 seats of outdoor dining. Pursuant to Section 8-200(A)(17)(a) of the Zoning Ordinance, a restaurant located within the City's Enhanced Transit Area is required to provide a minimum of one off-street parking space for every 1,000 square feet of floor area. Pursuant to Section 8-200(A)(17)(c) of the Zoning Ordinance, the first 20 outdoor seats are exempt from being factored into parking requirements, and the area occupied by each seat over 20 seats is calculated as 15 square feet per seat. With a maximum of 40 outdoor seats approved, this would constitute an additional 300 square feet for purposes of off-street parking requirement calculations. The existing 5,348 square foot indoor restaurant and the 300 square feet for outdoor dining, totaling 5,648 square feet, results in a parking requirement of six off-street spaces. The applicant meets this requirement via the seven off-street parking spaces which will be provided in their on-site surface parking lot.



Figure 6: Future patio designated with barriers (left) and existing parking area (right)

#### ZONING/MASTER PLAN DESIGNATION

The subject property is located within the CL/Commercial Low zone and the Mount Vernon Urban Overlay zone. Section 4-102.1 (B) of the Zoning Ordinance allows for a restaurant with outdoor dining up to 40 seats with approval of an Administrative Special Use Permit. Section 4-106(B)(1) states that the floor area ratio of a nonresidential property located within the CL/Commercial Low zone may be increased to an amount not to exceed .75 with Special Use Permit approval.

The proposed use is consistent with the Potomac West chapter of the Master Plan which designates the property for commercial use. It also complies with the Mount Vernon Avenue Business Area

Plan, which establishes a mix of residential, retail, and commercial uses in the Monroe Avenue Gateway area, promoting neighborhood-oriented restaurants.

#### II. STAFF ANALYSIS

Staff supports the applicant's request for an increase in the permitted floor area ratio to .53 to accommodate the construction of a new covered outdoor dining patio addition at 1508 Mount Vernon Avenue. Staff finds that Special Use Permit criteria, as outlined in Section 11-504(A) of the Zoning Ordinance, are satisfied to allow the minor increase in FAR. The Special Use Permit request:

1. Will not adversely affect the health or safety of persons residing or working in the neighborhood of the proposed use;

The increased floor area and construction of a covered patio would have no adverse effects on the health and safety of adjacent residents and employees as the proposed use would not adversely affect the safety of the motoring public and of pedestrians using the facility and the area immediately surrounding the site. The new construction of a covered patio would be contained well within the property line and would be located away from adjacent residential uses. In addition, no aspect of the patio's construction would result in inadequate pedestrian and/or vehicular access. All required entrance and exit drives would be provided and designed so as to prevent traffic hazards. Furthermore, all aspects of the covered patio construction would need to comply with applicable building and fire codes, ensuring the safety of patrons, employees, and neighboring properties.

2. Will not be detrimental to the public welfare or injurious to property or improvements in the neighborhood; and

Increasing the allowable floor area ratio to allow for the construction of the proposed covered patio would not adversely impact neighboring properties, and in fact, benefit the neighborhood by maintaining street vitality and providing outdoor dining along the Mount Vernon Avenue corridor year-round. Staff finds that the proposed increase in floor area ratio of 0.03 is quite modest and would not contribute to an overall appearance of excessive density at the site or otherwise adversely impact light conditions and air quality for neighboring properties. Furthermore, the proposed use will be constructed, arranged, and operated in such a way so as not to dominate the immediate vicinity or interfere with the development and use of neighboring properties as the covered patio's highest point would be below that of the roofline of the existing building and would be screened from nearby residential properties by both fencing and landscape elements.

3. Will substantially conform to the master plan of the city.

The Special Use Permit request is consistent with the recommended use of the site as a commercial property as envisioned in the Potomac West Small Area Plan and the

Mount Vernon Avenue Business Area Plan. The configuration of the proposed covered patio is in keeping with the building form and design approach recommendations for new construction as recommended in Section 6.2 of the Mount Vernon Business Area Plan, including the focus on new construction which reflects the scale of existing buildings, appropriate building setbacks to minimize impacts on adjacent residential properties, and ground level commercial storefronts which contribute to the vitality of the streetscape and the pedestrian experience.

Subject to the conditions stated in Section III of this report, staff recommends approval of the Special Use Permit request.

#### III. RECOMMENDED CONDITIONS

Staff recommends **approval** subject to compliance with all applicable codes and ordinances and the following conditions:

- 1. The Special Use Permit shall be granted to the applicant only or to any business or entity in which the applicant has a controlling interest. (P&Z)
- 2. The roof and patio construction shall be consistent with the application materials submitted on January 25, 2024.
- 3. The Director of Planning and Zoning shall review the Special Use Permit one year after approval and shall docket the matter for consideration by the Planning Commission and City Council if (a) there have been documented violations of the permit conditions which were not corrected immediately, constitute repeat violations or which create a direct and immediate adverse zoning impact on the surrounding community; (b) the Director has received a request from any person to docket the permit for review as a result of a complaint that rises to the level of a violation; or (c) the Director has determined that there are problems with the operation of the use and that new or revised conditions are needed. (P&Z)

<u>Staff Note:</u> In accordance with section 11-506(c) of the zoning ordinance, construction or operation shall be commenced and diligently and substantially pursued within 18 months of the date of granting of a Special Use Permit by City Council or the special use permit shall become void.

#### IV. CITY DEPARTMENT COMMENTS

Legend: C - code requirement R - recommendation S - suggestion F - finding

#### <u>Transportation & Environmental Services:</u>

- C-1 The applicant shall comply with the City of Alexandria's Solid Waste Control, Title 5, Chapter 1, which sets forth the requirements for the recycling of materials (Sec. 5-1-99). In order to comply with this code requirement, the applicant shall provide a completed Recycling Implementation Plan (RIP) Form within 60 days of SUP approval. Contact the City's Recycling Program Coordinator at (703) 746-4410, or via e-mail at <a href="mailto:commercialrecycling@alexandriava.gov">commercialrecycling@alexandriava.gov</a>, for information about completing this form. (T&ES-DROW)
- C-2 The applicant shall comply with the City of Alexandria's Noise Control Code, Title 11, Chapter 5, which sets the maximum permissible noise level as measured at the property line. (T&ES-DROW)
- C-3 Section 5-1-42- Collection by Private collectors. (c) Time of collection. Solid waste shall be collected from all premises not serviced by the city at least once each week. No collections may be made between the hours of 11:00 p.m. and 7:00 a.m. (6:00 a.m. from May 1, through September 30) if the collection area is less than 500 feet from a residential area. (T&ES-DROW)

#### Code Enforcement:

F-1 Building permit is required.

#### Fire:

No comments or concerns.

#### Parks and Recreation:

No comments or concerns.

#### Police Department:

No comments or concerns.

#### Health Department:

No comments or concerns.

STAFF: Tony LaColla, Division Chief, Land Use Services

Ann Horowitz, Principal Planner Patrick Silva, Urban Planner



# **APPLICATION** SPECIAL USE PERMIT

SPECIAL U	SE PERMIT #	_
PROPERTY LOCATION:		
TAX MAP REFERENCE:	ZONE:	
APPLICANT:		
Name:		
Address:		
PROPOSED USE:		
THE LINDERSIGNED, hereby ann	lies for a Special Use Permit in accordance w	with the provisions of
	1992 Zoning Ordinance of the City of Alexand	
permission to the City of Alexa	btained permission from the property own indria staff and Commission Members to land etc., connected with the application.	
permission to the City of Alexandri	obtained permission from the property ow a to post placard notice on the property for w /, Section 4-1404(D)(7) of the 1992 Zoning O	hich this application
including all surveys, drawings, etc accurate to the best of their knowled materials, drawings or illustrations representations made to the Direct the applicant unless those material illustrative of general plans and in	ests that all of the information herein provided, required to be furnished by the applicant and edge and belief. The applicant is hereby noting a submitted in support of this application are tor of Planning and Zoning on this applicationials or representations are clearly stated to intentions, subject to substantial revision, pure Zoning Ordinance of the City of Alexandria,	are true, correct and fied that any written and any specific oral in will be binding on the be non-binding or resuant to Article XI,
	Noe Landini	;
Print Name of Applicant or Agent	Signature	Date
Mailing/Street Address	Telephone #	Fax#
City and State Zip Code	Email address	<u> </u>

PROPI	ERTY OWNER'S AUTHORIZATION		
As the	property owner of		, I hereby
	(Property Address)		
grant tl	ne applicant authorization to apply for the		_ use as
	(use)		
describ	ped in this application.		
Name:_		Phone	
	Please Print		
	3:	Email:	
Signat	ure: Noe Landini	Date:	
1.	Floor Plan and Plot Plan. As a part of this application, site plan with the parking layout of the proposed use. floor and site plans. The Planning Director may waive request which adequately justifies a waiver.  [] Required floor plan and plot/site plan attached.  [] Requesting a waiver. See attached written requests.	The SUP application checklist requirements for plan submis	t lists the requirements of the
2.	The applicant is the <i>(check one):</i>		
۷.	[ ] Owner		
	[ ] Contract Purchaser		
	[ ] Lessee or		
	[ ] Other: of the subj	ect property.	
	he name, address and percent of ownership of any per the entity is a corporation or partnership, in which case in	, ,	• • • • • • • • • • • • • • • • • • • •

#### OWNERSHIP AND DISCLOSURE STATEMENT

Use additional sheets if necessary

interest in the applic owner of more than	cant, unless the three percent.	e entity is a corporation or partne	of any person or entity owning an ership, in which case identify each clude any legal or equitable interest of the application.
Name		Address	Percent of Ownership
1.			
2.			
3.			
interest in the property unless the entity is a opercent. The term ow	y located at corporation or p nership interest	ess and percent of ownership of an partnership, in which case identify east shall include any legal or equitable is the subject of the application.	(address), ach owner of more than three
Name		Address	Percent of Ownership
1.		7 15151.	T O COM CT COM CT COM P
3.			
an ownership interestinancial relationship, application, or within the Alexandria City Carchitectural Review. relationships please.  For a list of current and financial relationships	t in the applicar as defined by the 12-month producil, Plannin All fields must indicated each council, comminship, click her		uire to disclose any business or nance, existing at the time of this application with any member of opeals or either Boards of ot leave blank. (If there are no n the corresponding fields).
Name of person	or entity	Relationship as defined by	Member of the Approving
		Section 11-350 of the Zoning Ordinance	Body (i.e. City Council, Planning Commission, etc.)
1.		Cidilalio	- idining commoder, etc.)
2.			
3.			
this application and b	efore each publ the applicant'	ships of the type described in Sec. 1 ic hearing must be disclosed prior to sauthorized agent, I hereby attest true and correct.	est to the best of my ability that
		N	oe Landini
Date	Printed		Signature

If property owner or applicant is being represented by an authorized agent such as an attorney, realtor, or which there is some form of compensation, does this agent or the business in which the agent is employed business license to operate in the City of Alexandria, Virginia?	
[ ] <b>Yes.</b> Provide proof of current City business license	
[ ] <b>No.</b> The agent shall obtain a business license prior to filing application, if required by the City Code.	
NARRATIVE DESCRIPTION	
<b>3.</b> The applicant shall describe below the nature of the request <b>in detail</b> so that the Planning Common Council can understand the nature of the operation and the use. The description should fully discuss that activity. (Attach additional sheets if necessary.)	

#### **USE CHARACTERISTICS**

4.	[] a no [] an o [] an o	oposed special use permit request is for <i>(check one):</i> ew use requiring a special use permit,  expansion or change to an existing use without a special use permit,  expansion or change to an existing use with a special use permit,  er. Please describe:
5.	Please	describe the capacity of the proposed use:
	A.	How many patrons, clients, pupils and other such users do you expect?  Specify time period (i.e., day, hour, or shift).
	В.	How many employees, staff and other personnel do you expect?  Specify time period (i.e., day, hour, or shift).
6.	Please	describe the proposed hours and days of operation of the proposed use:
	Day:	Hours:
7.	Please	describe any potential noise emanating from the proposed use.
	A.	Describe the noise levels anticipated from all mechanical equipment and patrons.
	B.	How will the noise be controlled?

Pleas	se provide information regarding trash and litter generated by the use.
Α.	What type of trash and garbage will be generated by the use? (i.e. office paper, food wrappers)
В.	How much trash and garbage will be generated by the use? (i.e. # of bags or pounds per day or p week)
C.	How often will trash be collected?
D.	How will you prevent littering on the property, streets and nearby properties?
	iny hazardous materials, as defined by the state or federal government, be handled, stored, or general roperty?

	ca, storea, or g	enerated on the property?	
[] Ye	es. []	No.	
If yes,		ame, monthly quantity, and specific disposal method below:	
			_
What	methods are p	roposed to ensure the safety of nearby residents, employees and patrons?	_
			-
			_
OHOL			
	L SALES		
A.		osed use include the sale of beer, wine, or mixed drinks?	
		osed use include the sale of beer, wine, or mixed drinks?	
	Will the prop [ ] Yes If yes, descri		ABC license
	Will the prop [ ] Yes If yes, descri	[] No libe existing (if applicable) and proposed alcohol sales below, including if the	ABC license
	Will the prop [ ] Yes If yes, descri	[] No libe existing (if applicable) and proposed alcohol sales below, including if the	ABC license



#### **PARKING AND ACCESS REQUIREMENTS**

14.	A.	How many parking spaces of each type are provided for the proposed use:
		Standard spaces
		Compact spaces
		Handicapped accessible spaces.
		Other.
		Planning and Zoning Staff Only
	Req	uired number of spaces for use per Zoning Ordinance Section 8-200A
	Doe	es the application meet the requirement?  [ ] Yes [ ] No
	B.	Where is required parking located? <i>(check one)</i> [ ] on-site [ ] off-site
		TE: Pursuant to Section 8-200 (C) of the Zoning Ordinance, commercial and industrial uses may provide off within 500 feet of the proposed use, provided that the off-site parking is located on land zoned for commercia
		uses. All other uses must provide parking on-site, except that off-street parking may be provided within 300 e with a special use permit.
	C.	If a reduction in the required parking is requested, pursuant to Section 8-100 (A) (4) or (5) of the Zoning Ordinance, complete the PARKING REDUCTION SUPPLEMENTAL APPLICATION.
		[ ] Parking reduction requested; see attached supplemental form
15.	Pleas	se provide information regarding loading and unloading facilities for the use:
	A.	How many loading spaces are available for the use?
		Planning and Zoning Staff Only
	R	required number of loading spaces for use per Zoning Ordinance Section 8-200
	Е	Does the application meet the requirement?
		[]Yes []No

B.	Where are off-street loading facilities located?		<u>-</u>	
C.	During what hours of the day do you expect loading/u	• ,		
D.	How frequently are loading/unloading operations expe			— pro
	reet access to the subject property adequate or are any st ssary to minimize impacts on traffic flow?			— g la
CHA	ARACTERISTICS			
Will t	the proposed uses be located in an existing building?	[] Yes	[] No	
Do yo	ou propose to construct an addition to the building?	[] Yes	[] No	
How	large will the addition be? square feet.			
What	t will the total area occupied by the proposed use be?			
	sq. ft. (existing) + sq. ft. (addition if any)	) =sq	ft. (total)	
[]a []a []a	proposed use is located in: (check one) stand alone building house located in a residential zone warehouse			
[ ] ar	shopping center. Please provide name of the center: n office building. Please provide name of the building: ther. Please describe:			

**End of Application** 

#### Supplemental application for the following uses:

Automobil	e Or	ient	ted

Parking Reduction

Signs

Substandard Lot

Lot modifications requested with SUP use

#### **Interior Floor Plan**

Include labels to indicate the use of the space (doors, windows, seats, tables, counters, equipment)

#### If Applicable

Plan for outdoor uses

#### Contextual site image

Show subject site, on-site parking area, surrounding buildings, cross streets

## Department of Planning and Zoning Floor Area Ratio and Open Space Calculations

A.	Property Info	rmation							
<b>A</b> 1.		Ave, Alexandria, VA	2230	)1			CL		
	Street Address						Zon		
A2.	11,040.00 Total Lot Area		X	0.50 Floor Area Ratio A	llowed by Zone	=	5,520 Max	0.00 imum Allowable Floor Area	
В.	<b>Existing Gross Existing Gross</b>			Allowable Exclu	cione**				
	Basement	0,00		Basement**	0.00			5,348.00 Sq. Et	
	First Floor	5,155.00		Stairways**	0.00		B1.	Sq. Ft. Existing Gross Floor Area*	
	Second Floor	0.00		Mechanical**	57.00		B2.	207.00 Sq. Ft.	
	Third Floor	0.00		Attic less than 7'**			<b></b> .	Allowable Floor Exclusions**	
	Attic	0.00		Porches**	0.00		В3.	5,141.00 Sq. Ft.	
		0.00			0.00			Existing Floor Area Minus Exclusions (subtract B2 from B1)	
	Porches	0.00		Balcony/Deck**	150.00		Cor	nments for Existing Gross Floor Area	
	Balcony/Deck	193.00		Lavatory***	0.00			initiative for Existing Gross (1991) 4.00	
	Lavatory***			Other**					
	Other**	0.00	)	2	0.00				
B1.	Total Gross	5,348.00	B2.	Total Exclusions	207.00				
C.	Proposed Gro	oss Floor Area							
	Proposed Gross			Allowable Exclu	sions**				
	Basement				<del></del>				
		0.00		Basement**	0.00		C1.	720.00 Sq. Ft.	
	First Floor	0.00 720.00		Basement** Stairways**			C1.	Proposed Gross Floor Area*	
	First Floor Second Floor				0.00		C1.	Proposed Gross Floor Area*  0.00  Sq. Ft.	
		720.00		Stairways**	0.00 0.00 0.00		C2.	Proposed Gross Floor Area*  0.00  Allowable Floor Exclusions**  720.00	
	Second Floor	720.00 0.00		Stairways** Mechanical**	0.00 0.00 0.00			Proposed Gross Floor Area*  0.00  Allowable Floor Exclusions**  720.00  Sq. Ft.  Proposed Floor Area Minus Exclusions	
	Second Floor Third Floor	720.00 0.00 0.00		Stairways**  Mechanical**  Attic less than 7'**	0.00 0.00 0.00 0.00		C2.	Proposed Gross Floor Area*  0.00  Allowable Floor Exclusions**  720.00  Sq. Ft.  Sq. Ft.	
	Second Floor Third Floor Attic	720.00 0.00 0.00 0.00		Stairways** Mechanical** Attic less than 7'** Porches**	0.00 0.00 0.00 0.00 0.00		C2.	Proposed Gross Floor Area*  0.00  Allowable Floor Exclusions**  720.00  Sq. Ft.  Proposed Floor Area Minus Exclusions	
	Second Floor Third Floor Attic Porches	720.00 0.00 0.00 0.00		Stairways** Mechanical** Attic less than 7'** Porches** Balcony/Deck**	0.00 0.00 0.00 0.00 0.00		C2.	Proposed Gross Floor Area*  0.00  Allowable Floor Exclusions**  720.00  Sq. Ft.  Proposed Floor Area Minus Exclusions	
	Second Floor Third Floor Attic Porches Balcony/Deck	720.00 0.00 0.00 0.00 0.00		Stairways** Mechanical** Attic less than 7'** Porches** Balcony/Deck** Lavatory***	0.00 0.00 0.00 0.00 0.00		C2.	Proposed Gross Floor Area*  0.00  Allowable Floor Exclusions**  720.00  Sq. Ft.  Proposed Floor Area Minus Exclusions	
C1.	Second Floor Third Floor Attic Porches Balcony/Deck Lavatory***	720.00 0.00 0.00 0.00 0.00	) c2	Stairways** Mechanical** Attic less than 7'** Porches** Balcony/Deck** Lavatory*** Other**	0.00 0.00 0.00 0.00 0.00 0.00 0.00		C2.	Proposed Gross Floor Area*  0.00  Allowable Floor Exclusions**  720.00  Sq. Ft.  Proposed Floor Area Minus Exclusions (subtract C2 from C1)	
C1.	Second Floor Third Floor Attic Porches Balcony/Deck Lavatory*** Other	720.00 0.00 0.00 0.00 0.00 0.00	) c2	Stairways** Mechanical** Attic less than 7'** Porches** Balcony/Deck** Lavatory*** Other**	0.00 0.00 0.00 0.00 0.00 0.00 0.00		C2.	Proposed Gross Floor Area*  0.00  Sq. Ft.  Allowable Floor Exclusions**  720.00  Sq. Ft.  Proposed Floor Area Minus Exclusions (subtract C2 from C1)  Notes  *Gross floor area is the sum of all areas	
	Second Floor Third Floor Attic Porches Balcony/Deck Lavatory*** Other	720.00 0.00 0.00 0.00 0.00 0.00 720.00	) c2	Stairways** Mechanical** Attic less than 7'** Porches** Balcony/Deck** Lavatory*** Other** Other**	0.00 0.00 0.00 0.00 0.00 0.00 0.00	)	C2.	Proposed Gross Floor Area*  0.00 Sq. Ft.  Allowable Floor Exclusions**  720.00 Sq. Ft.  Proposed Floor Area Minus Exclusions (subtract C2 from C1)  Notes  *Gross floor area is the sum of all areas under roof of a lot, measured from the face of exterior walls, including basements, garages, sheds, gazebos, guest buildings and other accessory buildings.	
	Second Floor Third Floor Attic Porches Balcony/Deck Lavatory*** Other Total Gross  Total Floor A  5,861.00	720.00 0.00 0.00 0.00 0.00 0.00 0.00 720.00 rea	) c2	Stairways** Mechanical** Attic less than 7'** Porches** Balcony/Deck** Lavatory*** Other** Other** . Total Exclusions  E. Open Spa E1.	0.00 0.00 0.00 0.00 0.00 0.00 0.00 0.0		C2.	Proposed Gross Floor Area*  0.00  Sq. Ft.  Allowable Floor Exclusions**  720.00  Sq. Ft.  Proposed Floor Area Minus Exclusions (subtract C2 from C1)  Notes  *Gross floor area is the sum of all areas under roof of a lot, measured from the face of exterior walls, including basements, garages, sheds, gazebos, guest buildings and other accessory buildings.  ** Refer to the Zoning Ordinance (Section 2-145(B)) and consult with Zoning Staff for	
D.	Second Floor Third Floor Attic Porches Balcony/Deck Lavatory*** Other Total Gross Total Floor A	720.00 0.00 0.00 0.00 0.00 0.00 0.00 720.00 rea	) C2	Stairways** Mechanical** Attic less than 7'** Porches** Balcony/Deck** Lavatory*** Other** Other** . Total Exclusions  E. Open Spa	0.00 0.00 0.00 0.00 0.00 0.00 0.00 0.0		C2.	Proposed Gross Floor Area*  0.00  Sq. Ft.  Allowable Floor Exclusions**  720.00  Sq. Ft.  Proposed Floor Area Minus Exclusions (subtract C2 from C1)  Notes  *Gross floor area is the sum of all areas under roof of a lot, measured from the face of exterior walls, including basements, garages, sheds, gazebos, guest buildings and other accessory buildings.  ** Refer to the Zoning Ordinance (Section 2-145(B)) and consult with Zoning Staff for information regarding allowable exclusions. Sections may also be required for some	
D.	Second Floor Third Floor Attic Porches Balcony/Deck Lavatory*** Other Total Gross  Total Floor A  5,861.00 Total Floor Area (	720.00 0.00 0.00 0.00 0.00 0.00 0.00 720.00  rea Sq. Ft. (add B3 and C3) Sq. Ft.	) C2	Stairways** Mechanical** Attic less than 7'** Porches** Balcony/Deck** Lavatory*** Other** Other** . Total Exclusions  E. Open Spa E1.	0.00 0.00 0.00 0.00 0.00 0.00 0.00 0.0	Ft.	C2.	Proposed Gross Floor Area*  0.00  Sq. Ft.  Allowable Floor Exclusions**  720.00  Sq. Ft.  Proposed Floor Area Minus Exclusions (subtract C2 from C1)  Notes  *Gross floor area is the sum of all areas under roof of a lot, measured from the face of exterior walls, including basements, garages, sheds, gazebos, guest buildings and other accessory buildings.  ** Refer to the Zoning Ordinance (Section 2-145(B)) and consult with Zoning Staff for information regarding allowable exclusions.	

The undersigned hereby certifies and attests that, to the best of his/her knowledge, the above computations are true and correct.

Proposed Open Space


E3.


Signature:


maximum of 50 square feet, per lavatory. The maximum total of excludable area for

lavatories shall be no greater than 10% of

Sq. Ft.

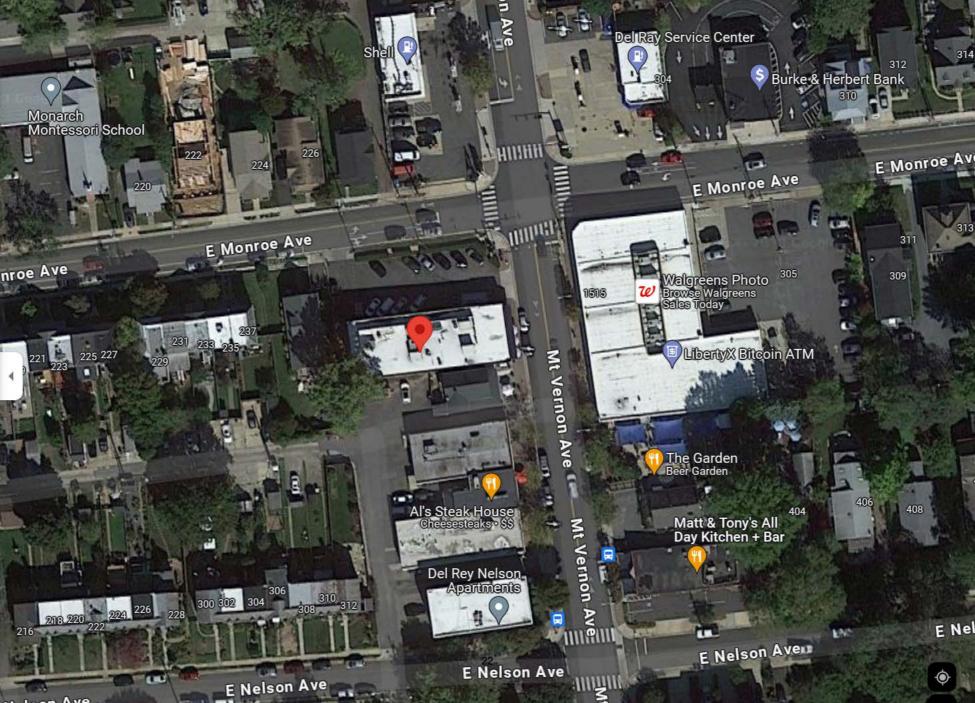

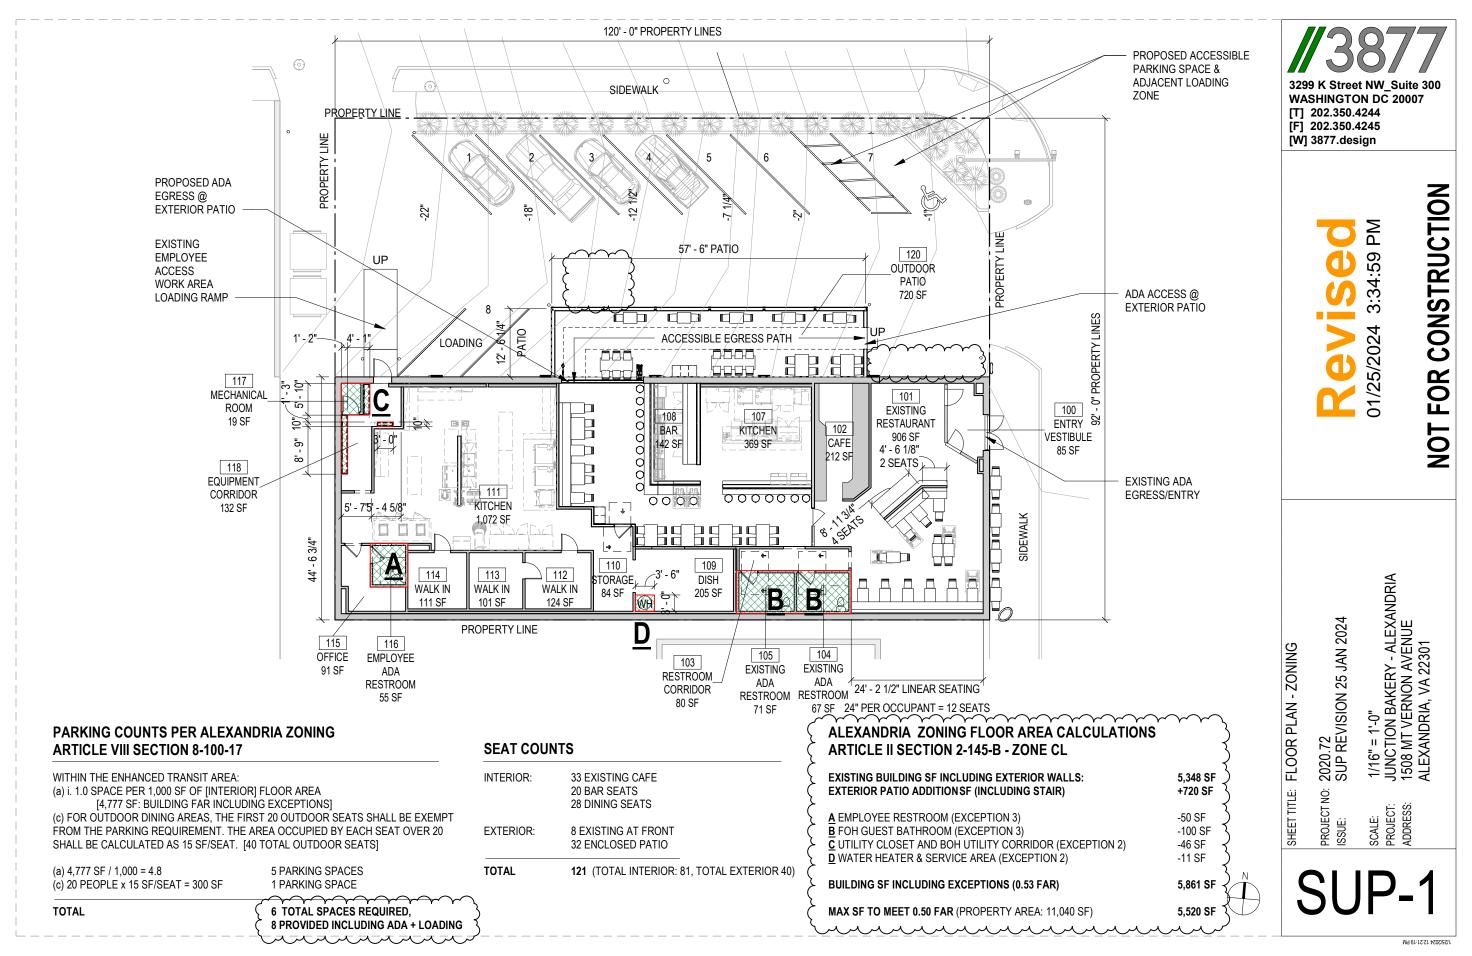

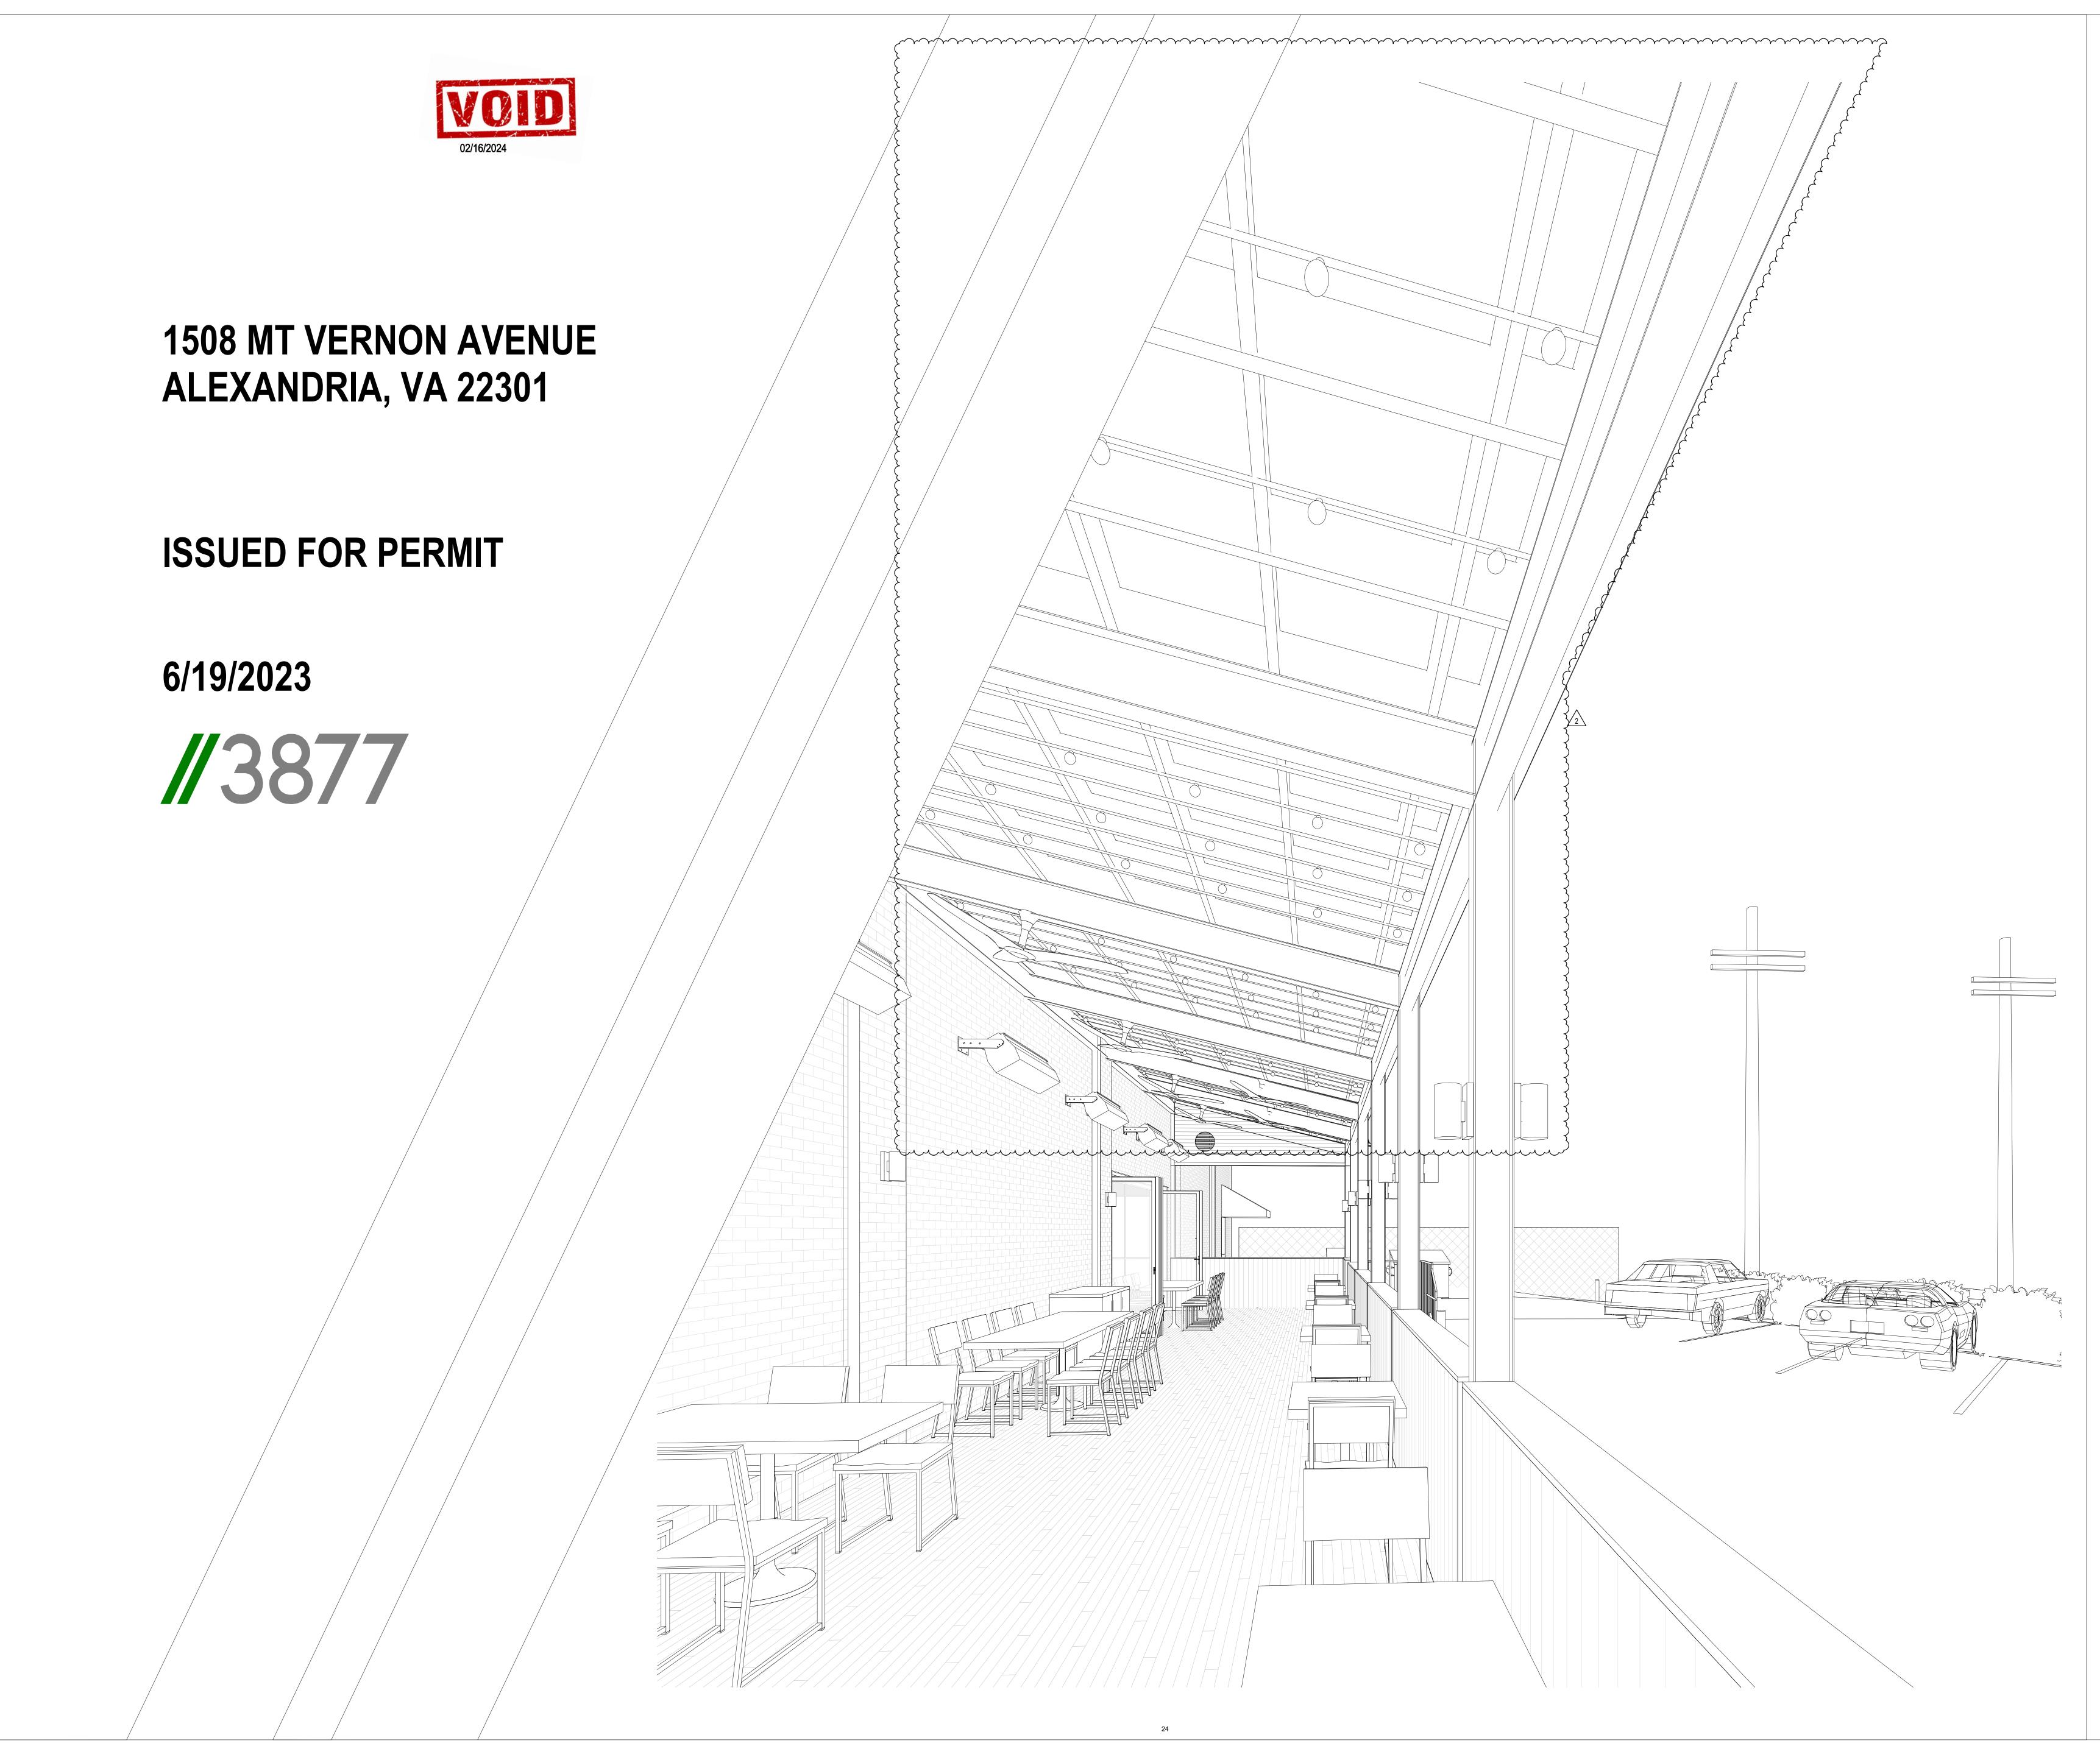

COPYRIGHT NOTICE:

OWNER : BAKER'S BREAD LLC 115 KING STREET ALEXANDRIA, VA 22314 TECH 24 5256 EISENHOWER AVE ALEXANDRIA, VA 22304

3333 K STREET NW, SUITE 60 WASHINGTON DC 20007 [T] 202.350.4244

[W] WWW.3877.DESIGN

6861 ELM STREET SUITE 2D MCLEAN, VA 22101

[W] WWW.BEENGRS.COM

TYSONS, VA 22182 [T] 703.854.1028 [W] WWW.EHLERT-BRYAN.COM



# **ISSUED FOR PERMIT**

DRAWING DATA

PROJECT: JUNCTION BAKERY -**ALEXANDRIA** 

ADDRESS: 1508 MT VERNON AVENUE **ALEXANDRIA, VA 22301** 


 INTERIOR PERMIT - 3.31.2023 EXTERIOR PERMIT - 3.31.2023

EXTERIOR PERMIT REVISION



SHEET TITLE: COVER SHEET

DATE ISSUED: 02/08/23

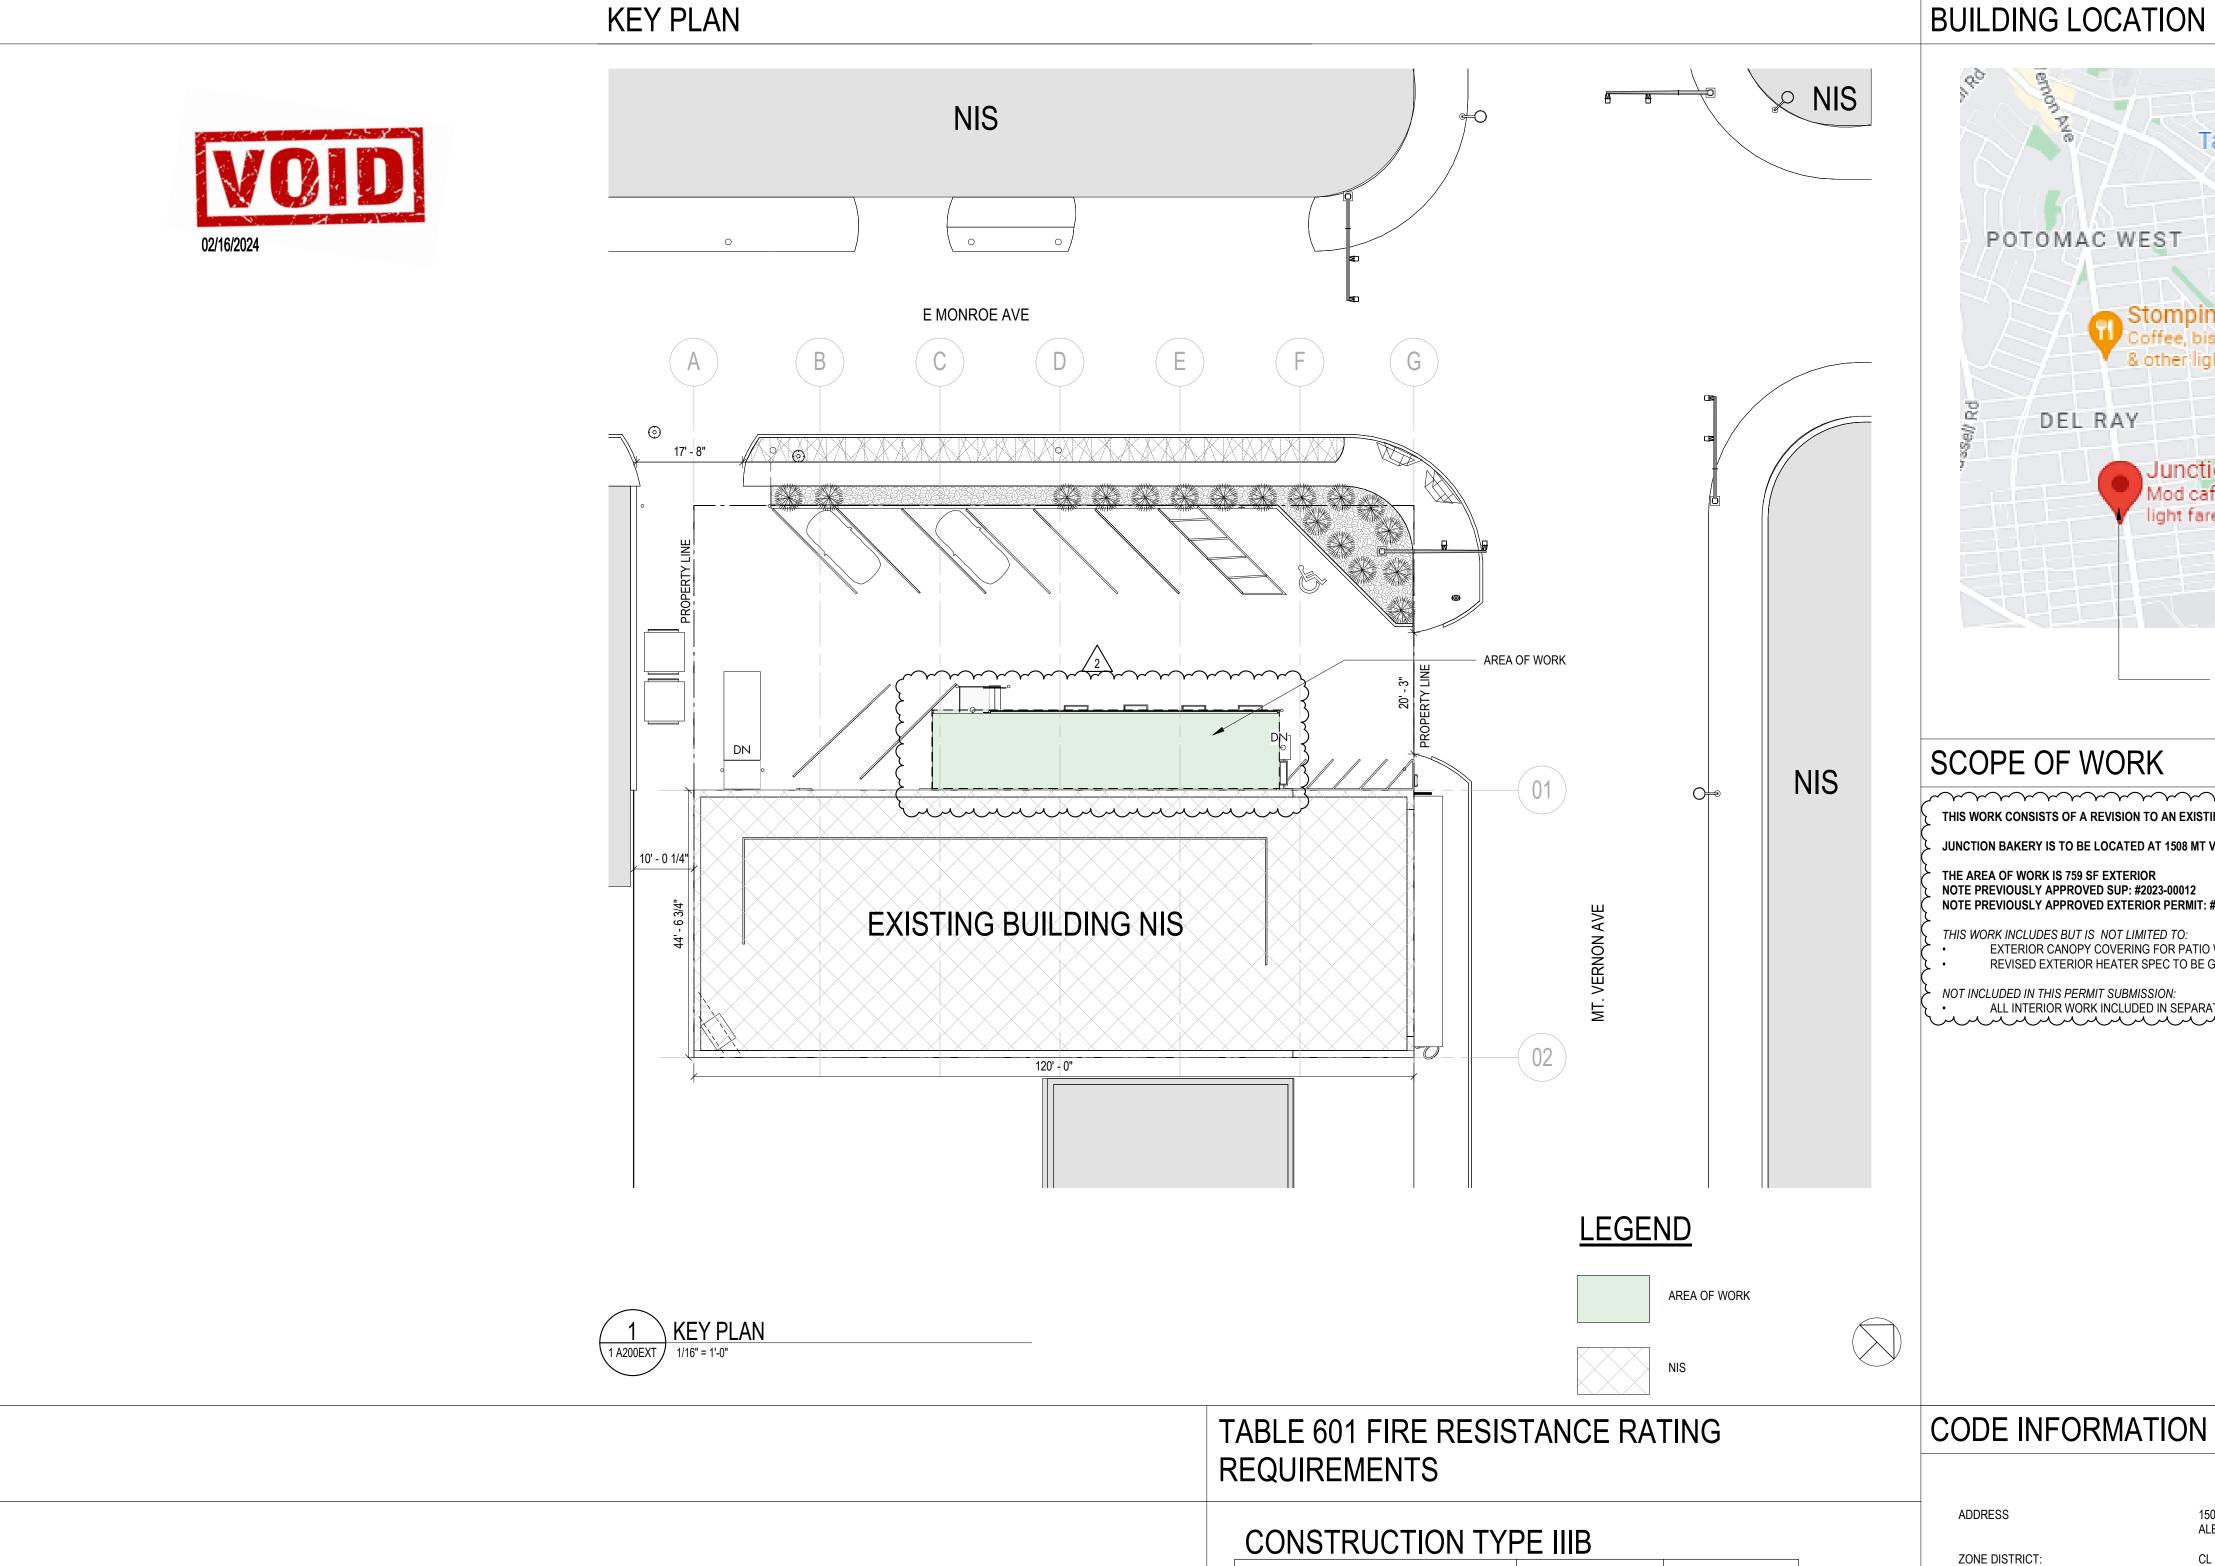

POTOMAC YARD POTOMAC WEST Barkhaus DEL RAY Junction Bakery & Bistro Mod cafe/bakery for light fare & dinner NORTHEAST ALEXANDRIA 1508 MT VERNON AVE #1718,

ALEXANDRIA, VA 22301

# SCOPE OF WORK

THIS WORK CONSISTS OF A REVISION TO AN EXISTING BAKERY/RESTAURANT AND CONTAINS EXTERIOR WORK ONLY. JUNCTION BAKERY IS TO BE LOCATED AT 1508 MT VERNON AVE, ALEXANDRIA VA 22301 THE AREA OF WORK IS 759 SF EXTERIOR NOTE PREVIOUSLY APPROVED SUP: #2023-00012 NOTE PREVIOUSLY APPROVED EXTERIOR PERMIT: #BLDC2023-00284 THIS WORK INCLUDES BUT IS NOT LIMITED TO: EXTERIOR CANOPY COVERING FOR PATIO WITH CORRESPONDING OVERHEAD FANS AND LIGHTING • REVISED EXTERIOR HEATER SPEC TO BE GAS POWERED NOT INCLUDED IN THIS PERMIT SUBMISSION: • ALL INTERIOR WORK INCLUDED IN SEPARATE INTERIOR PERMIT SUBMISSION

> 1508 MOUNT VERNON AVE ALEXANDRIA, VA 22301

# SHEET INDEX

PROJECT DIRECTORY

JUNCTION BAKERY

1508 MT VERNON AVE

**MEP ENGINEER:** BUILT ENVIRONMENT

ENGINEERS

MILTON IRIARTE

MCLEAN, VA 22131

[T] 703.888.0649

6861 ELM STREET, SUITE 2D

ALEXANDRIA, VA 22301

NOE LANDINI

**BUILDING OWNER:** 

JUNCTION BAKERY

115 KING STREET

ALEXANDRIA, VA 22314

**GENERAL CONTRACTOR:** 

5256 EISENHOWER AVE

ALEXANDRIA, VA 22304

[W] WWW.TECH24CONSTRUCTION.COM [T] 703.749.7941

NOE LANDINI

VIC BONOMI

[T] 571.233.8585

**ARCHITECT:** 

DAVID SHOVE BROWN, AIA

WASHINGTON, DC 20007

STRUCTURAL ENGINEER:

BENJAMIN GUNDEN, PE, SE

8609 WESTWOOD CENTER DRIVE

[W] WWW.EHLERT-BRYAN.COM

3333 K STREET NW

//3877


SUITE 60

[T] 202.350.4244 [W] 3877.DESIGN

ELHERT BRYAN

TYSONS VA 22182

SUITE 800

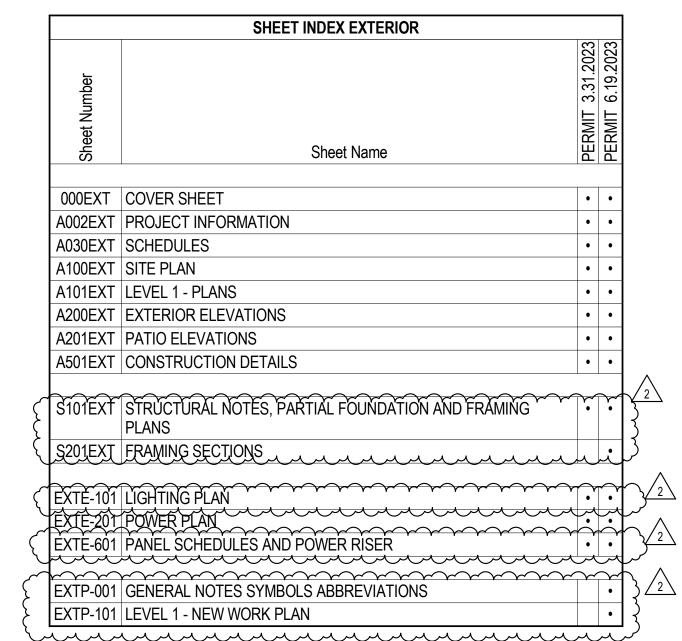

# 

# CODE INFORMATION

2018 VIRGINIA FUEL GAS CODE

2018 VIRGINIA MECHANICAL CODE 2018 VIRGINIA PLUMBING CODE 2018 INTERNATIONAL FIRE CODE

BLOCK:

BUILDING ELEMENT	REQUIRED	PROVIDED
PRIMARY STRUCTURAL FRAME (*g)	0	0 ETR
EXTERIOR BEARING WALLS (*f, *g) INTERIOR BEARING WALLS	2 0	2 ETR 0 ETR
EXTERIOR NONBEARING WALLS/PARTITIONS INTERIOR NONBEARING WALLS/PARTITIONS (*e)	Per Table 602	0 ETR 0 ETR
FLOOR CONSTRUCTION AND ASSOC. SECONDARY MEMBERS (See Section 202)	0	0 ETR
ROOF CONSTRUCTION AND ASSOC. SECONDARY MEMBERS (See Section 202)	0	0 ETR

a. Roof supports: Fire-resistance ratings of primary structural frame and bearing walls are permitted to be reduced by 1 hour where supporting a roof only.

b. Except in Group F-1, H, M and S-1 occupancies, fire protection of structural members shall not be required, including protection of roof framing and decking where every part of the roof construction is 20 feet or more above any floor immediately below. Fire-retardant-treated wood members shall be allowed to be used for such unprotected members.

c. In all occupancies, heavy timber shall be allowed where a 1-hour or less fire-resistance rating is

d. Not less than the fire-resistance rating required by other sections of this code.

e. Not less than the fire-resistance rating based on fire separation distance (see Table 602). f. Not less than the fire-resistance rating as referenced in Section 704.10

**USE GROUP** ASSEMBLY A-2 CONSTRUCTION TYPE ALTERATION LEVEL LEVEL 2 **EXISTING** NUMBER OF STORIES 1 ABOVE GRADE PROJECT STORIES 1 ABOVE GRADE **GROSS SF** BUSINESS (ASSEMBLY WITH OCCUPANCY LESS THAN 50 PEOPLE) F-1 BAKERY OCCUPANCY SEPARATION NOTE: PER §508.3, THE BUILDING IS DEFINED AS A NON SEPARATED OCCUPANCY. PER TABLE 508.4 NO SEPARATION IS REQUIRED BETWEEN USE GROUPS B (BUSINESS) AND F-1 (FACTORY) FIRE SEPARATION REQUIREMENT PROPOSED NUMBER OF STORIES 1 ABOVE GRADE (NO CHANGE) 1 ABOVE GRADE (NO CHANGE) PROJECT STORIES **GROSS SF** 5368 SF (INTERIOR) (NO CHANGE) A-2 RESTAURANT NONE NEEDED, ALL A-2 USE OCCUPANCY SEPARATION FIRE SEPARATION REQUIREMENT 0 HOURS AREA OF WORK 1280 SF EXTERIOR AUTOMATIC SPRINKLER NO (NO CHANGE) **APPLICABLE CODES:** 2018 VIRGINIA BUILDING AND FIRE CODE RELATED REGULATIONS 2018 VIRGINIA CONSTRUCTION CODE 2018 VIRGINIA STATEWIDE FIRE PREVENTION CODE 2018 VIRGINIA ENERGY CONSERVATION CODE 2018 VIRGINIA EXISTING BUILDING CODE

NATIONAL ELECTRICAL CODE 2017 OF VIRGINIA, NFPA 70, 2017 WITH AMENDMENTS

w w w . 3 8 7 7 . d e s i g n

COPYRIGHT NOTICE:

STUDIO3877 EXPRESSLY RESERVES ITS COMMON LAW COPYRIGHT AND OTHER PROPERTY RIGHTS TO THESE PLANS. THESE PLANS ARE NOT TO BE REPRODUCED, CHANGED, OR COPIED IN ANY FORM OR MANNER WHATSOEVER, NOR ARE THEY TO BE ASSIGNED TO ANY THIRD PARTY WITHOUT OBTAINING THE EXPRESS WRITTEN PERMISSION AND CONSENT OF STUDIO3877.

BAKER'S BREAD LLC 115 KING STREET ALEXANDRIA, VA 22314 **GENERAL CONTRACTOR:** 5256 EISENHOWER AVE ALEXANDRIA, VA 22304 [T] 571.233.8585 [W] WWW.TECH24CONSTRUCTION.COM **ARCHITECT:** 3333 K STREET NW, SUITE 60 WASHINGTON DC 20007 [T] 202.350.4244 [W] WWW.3877.DESIGN **MEP ENGINEER:** BUILT ENVIRONMENT ENGINEERS 6861 ELM STREET SUITE 2D MCLEAN, VA 22101 [T] 703.888.0649 [W] WWW.BEENGRS.COM **STRUCTURAL ENGINEER:** EHLERT BRYAN 8609 WESTWOOD CENTER DRIVE



# **ISSUED FOR PERMIT**

DRAWING DATA

**TYSONS, VA 22182** 

[W] WWW.EHLERT-BRYAN.COM

[T] 703.854.1028

PROJECT: JUNCTION BAKERY -**ALEXANDRIA** 

ADDRESS: 1508 MT VERNON AVENUE **ALEXANDRIA, VA 22301** 

SHEET SUBMISSION INDEX ○ EXTERIOR PERMIT - 3.31.2023

EXTERIOR PERMIT REVISION

REVISION

DATE

SIGNATURE:


REV NO.




PROFESSIONAL CERTIFICATION: I HEREBY CERTIFY THAT THESE DOCUMENTS WERE PREPARED OR APPROVED BY ME, AND THAT I AM A DULY LICENSED PROFESSIONAL ARCHITECT UNDER THE LAWS OF THE STATE OF VIRGINIA, LICENSE No: 11843


SHEET TITLE: PROJECT INFORMATION

PROJECT NO: 2020.72 DATE ISSUED: 02/08/23 SCALE: As indicated

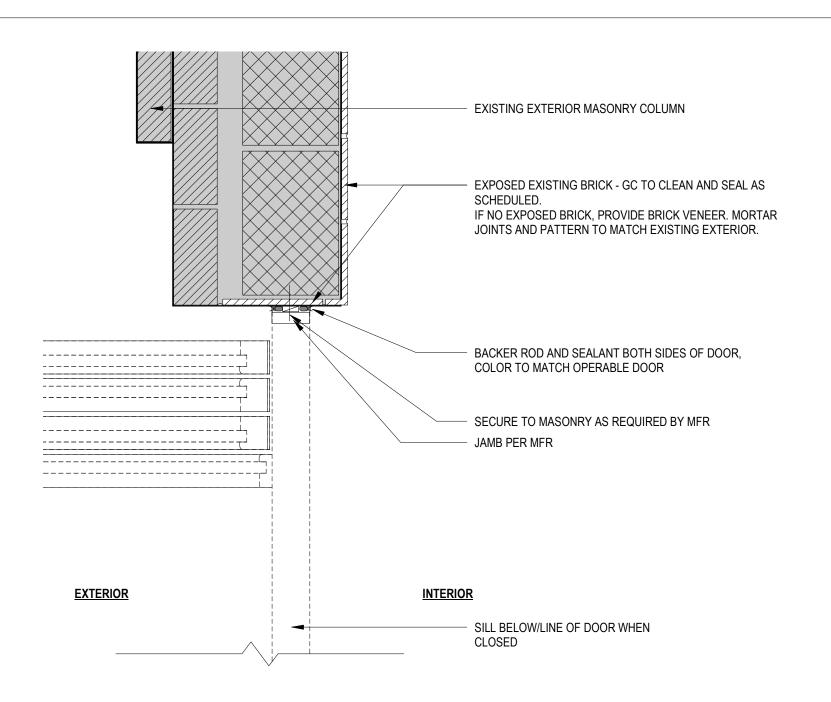


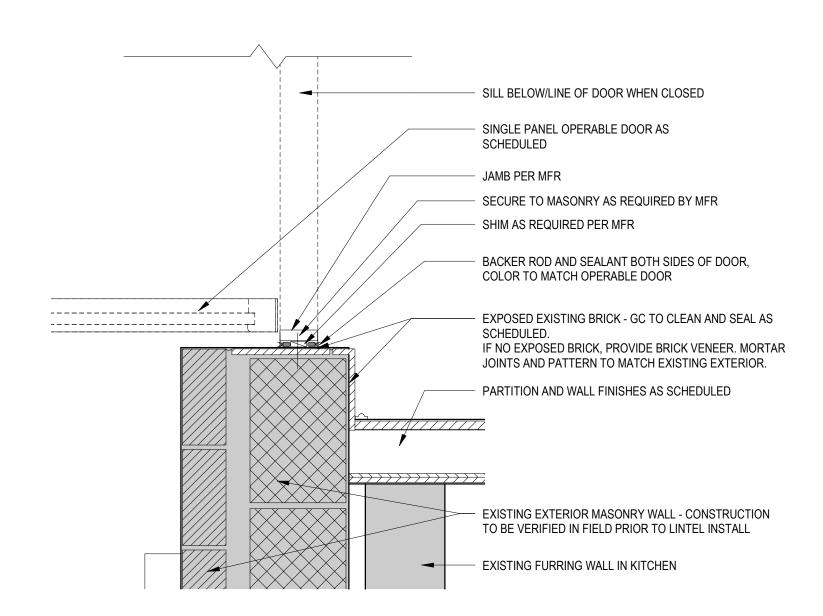


# 2 EXTERIOR OPERABLE DOOR JAMB

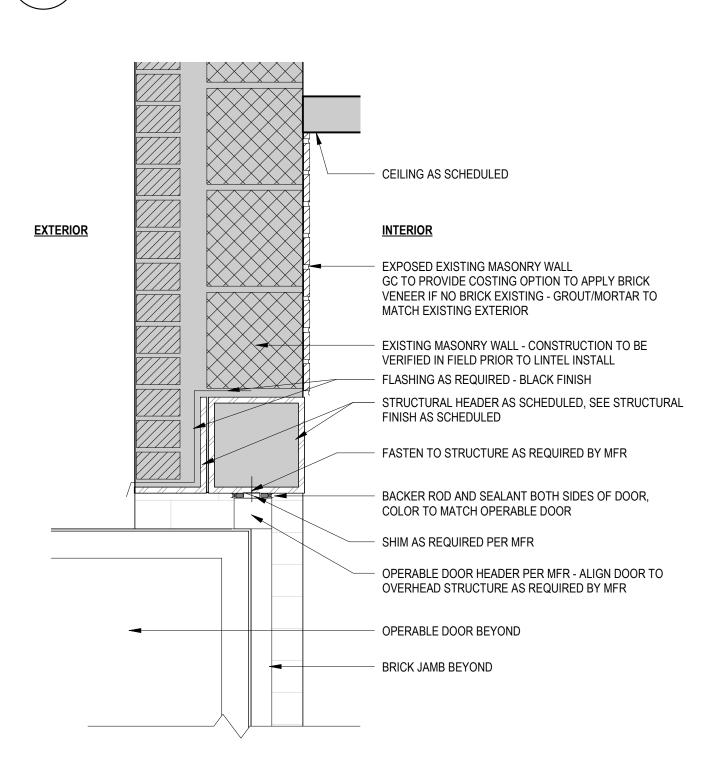

# 3 EXTERIOR OPERABLE DOOR HEADER

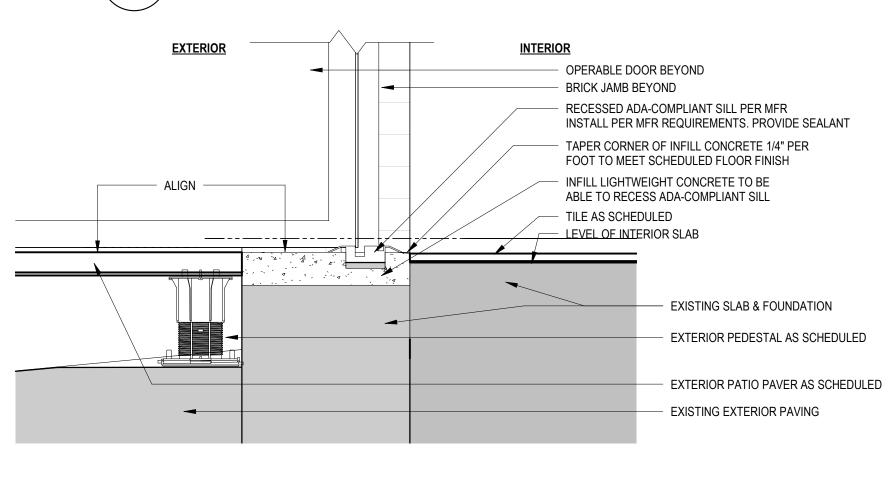

1 EXTERIOR OPERABLE DOOR SILL

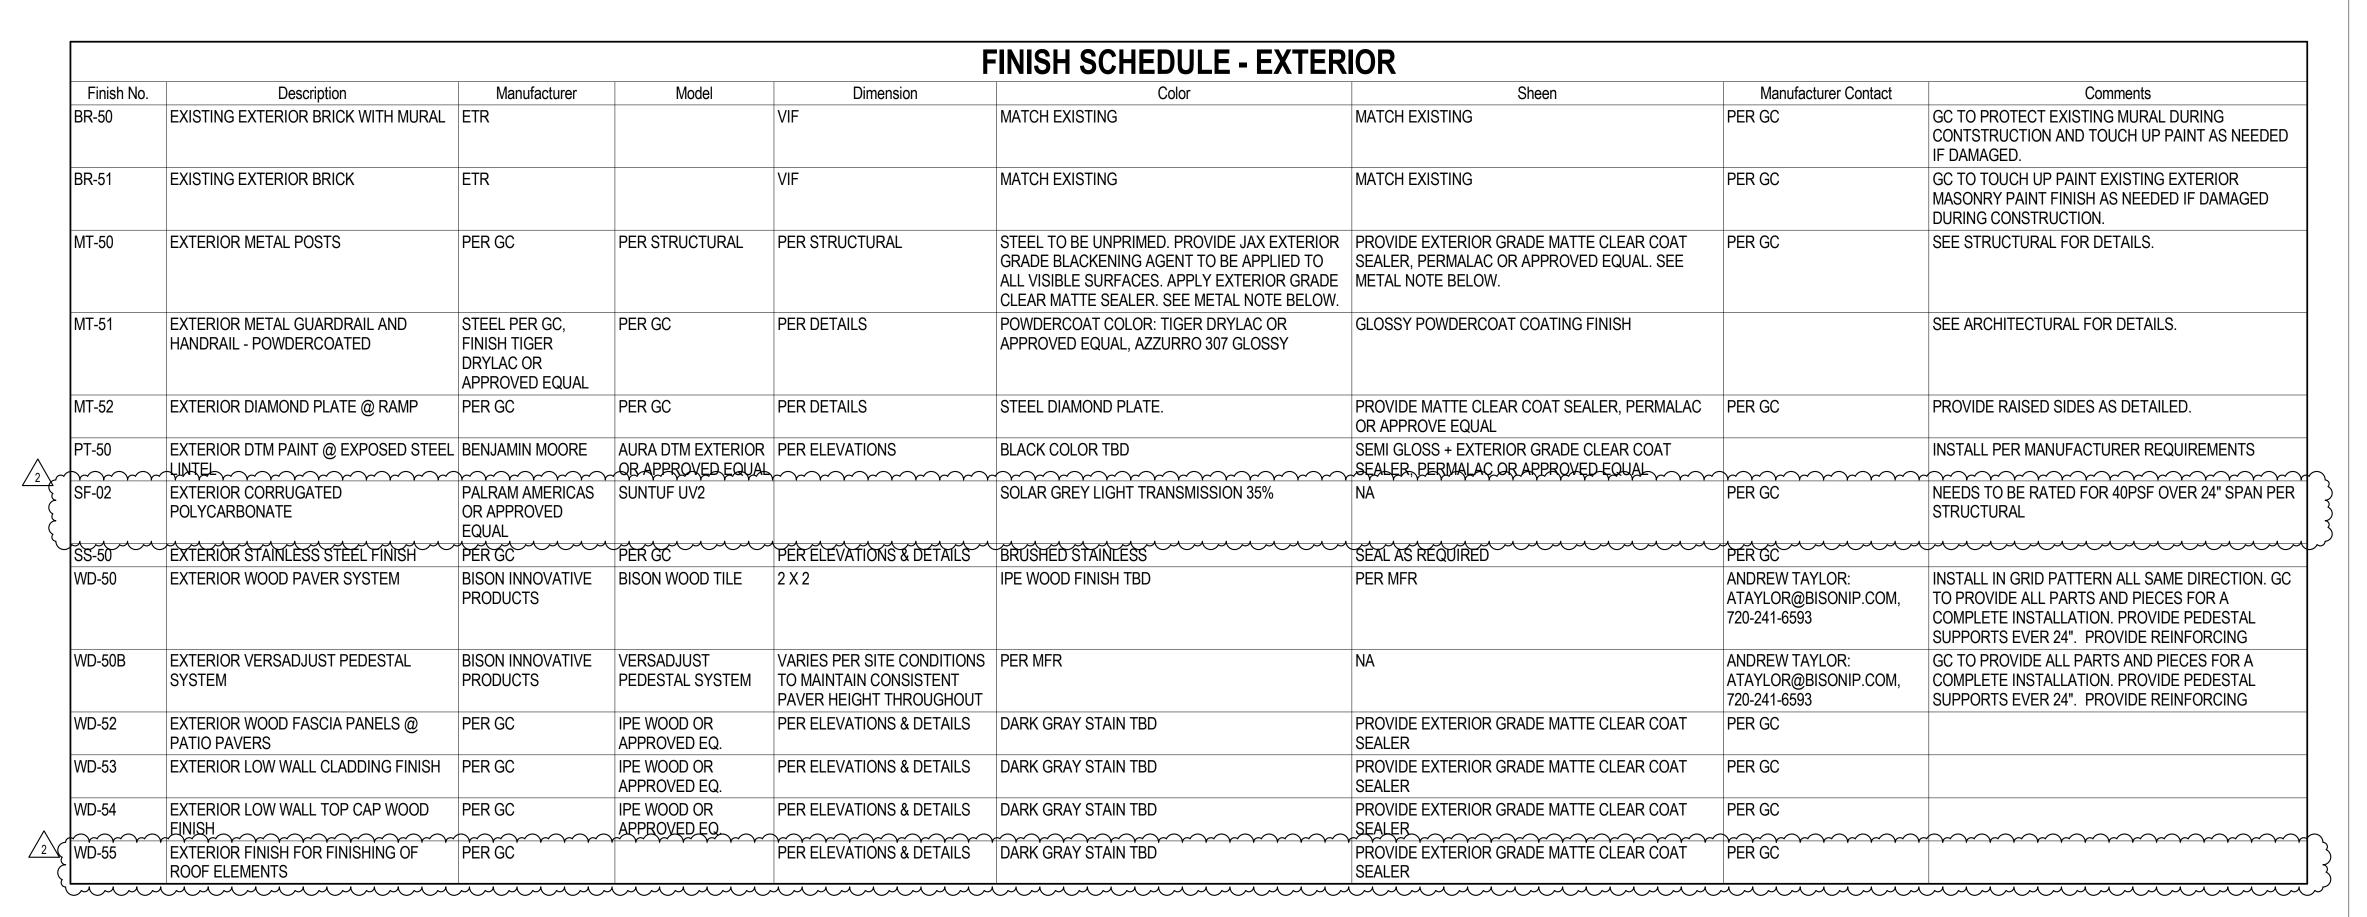

FINISH SAMPLE NOTE:

GC TO PROVIDE MIN (3) SAMPLES OF EACH FINISH LISTED FOR REVIEW BY OWNER AND ARCHITECT PRIOR TO ORDERING AND FABRICATION.

METAL BLACKENING NOTE:

FOR METAL FINISHES RECEIVING BLACKENING AGENT, USE JAX IRON/STEEL/NICKEL BLACKENER OR APPROVED EQUAL. PRIOR TO APPLYING, METAL MUST BE CLEAN, FREE OF LACQUER, OIL, GREASE, AND WAX. APPLY BLACKENER PER MFR INSTRUCTIONS PRIOR TO MECHANICALLY DRYING AND APPLYING CLEAR COAT SEALER AS SCHEDULED. SUGGESTED SEALER BRAND: PERMALAC. GC TO TEST BOTH BLACKENING AGENT AND SEALER ON METAL SAMPLE PRIOR TO FINISHING MATERIAL TO BE INSTALLED.

MFR CONTACT: ANTHONY NAPPY, 914-668-1818, ANTHONY@JAXCHEMICAL.COM


			LIGHTING FIXT	URE SC	HEDUL	E - EXTERIOR		
TYPI	E DESCRIPTION	MANUFACTURER	MODEL	Phase Created	COMMENTS	FINISH	LAMPING	COMMENTS
LTG-10		REJUVENATION OR APPROVED ALTERNATE	THORBURN NARROW WALL SCONCE #A7004, WET RATED	New Construction			MAX WATTAGE 40W, LED LAMP TBD	FIXTURE TO BE DIMMABLE AND HARDWIRED. PROVIDE ALL PARTS AND ACCESSORIES FOR COMPLETE INSTALLATION
2 \ LTG-11	EXTERIOR CAGE LIGHT SCONCE	SCHOOLHOUSE LIGHTING OR APPROVED ALTERNATE	FACTORY 4 OUTDOOR SCONCE, WET RATED. PROVIDE CAGE	New Construction		BLACK BK	MAX WATTAGE 100W, LED LAMP TBD	FIXTURE TO BE DIMMABLE AND HARDWIRED. PROVIDE ALL PARTS AND ACCESSORIES FOR COMPLETE INSTALLATION
LTG-12	STRING LIGHTS	AMERICAN LIGHTING OR APPROVED ALTERNATE	LS/LS2 SERIES, NON-SUSPENDED E26 STRING LIGHTS 24" O.C. SOCKETS, WET RATED. FIXTURE IS CUTTABLE IN FIELD.	New Construction		BLACK	MAX WATTAGE PER SOCKET 25W, LED LAMP TBD	FIXTURE TO BE DIMMABLE AND HARDWIRED. PROVIDE ALL PARTS AND ACCESSORIES FOR COMPLETE INSTALLATION. GC TO VERIFY LENGTHS IN FIELD PRIOR TO ORDERING FIXTURE.

			EQUIPMENT SCH	HEDULE	- EXTERIOR		
Type Mark	Description	Manufacturer — — — — — — — — — — — — — — — — — —	Model O O O O O O O O O O O O O O O O O O O	FINISH	INPUT BTUH GAS	WEIGHT (LBS.)	Comments
EQP-01	OUTDOOR WALL HEATERS	SCHWANK	2152-N	BLACK	50,000/36,500 NAT	44	GC TO PRÓVIDE: (6) 2152 TWO STAGE HEATERS, 30 DEGREE MOUNTING AND WALL MOUNTING BRACKET; (2)  JM-0203-TS 3-GANG SCHWANK 2-STAGE SWITCHES, (ADJACENT TO LIGHTING CONTROLS); (1) MULTI MOUNT  150VA TRANSFORMER FOR ALL 6 HEATERS - MOUNTED WITHIN THE SPACE IN A CONCEALED, DRY AND  VENTILATED LOCATION. CONTACT: ERIC KAHN, E: ERIC@ALFRESCO-HEATING.COM, T: 415.884.2880
EQP-02	Haiku 60In Dia		60" inch MK-HK-4-05-2506-A258-F258. OMIT LIGHTS, COORDINATE DOWNROD ATTACHMENT WITH SLOPED CEILING. COORDINATE CONTROL SPEC WITH OWNER AND INCLUDE IN PURCHASE.				PROVIDE ALL PARTS AND PIECES REQUIRED FOR FULL AND COMPLETE INSTALLATION. PROVIDE STABILIZER KIT.

	DOOR SCHEDULE - EXTERIOR													
	Do	oor Doo								Frame			Fire	re
Level	No	о. Туре	Location	Description	Width	Height	Thickness	Construction	Door Finish	Frame Finish	Jamb Type	Glass Type	Rating	Comments - HARDWARE SET
LEVEL 01	100	) CC	ENTRY VESTIBULE	EXISTING STOREFRONT ENTRANCE	6' - 2"	6' - 8"		ETR - ALUM + INSULATED TEMPERED GLASS	ETR - BLACK	ETR - BLACK	ETR	ETR-TEMPERED	NA	HW-1
LEVEL 01	106	SA I	OUTDOOR PATIO	"Monumental Aluminum Framed Folding System"	15' - 0"	8' - 6"	1 99/128"	ALUM + INSULATED TEMPERED GLASS		BLACK	1/A030EXT, 2/A030EXT, 3/A030EXT	CLR TEMP INSUL.		HW-2: COORDINATE DOOR SIZE IN FIELD WITH DEMO CONDITIONS AND WITH PROPOSED STRUCTURAL HEADER SUPPORT.
LEVEL 01	118	3 A	EQUIPMENT CORRIDOR	EXISTING BOH DOOR	3' - 4"	7' - 0"	1 3/4"	ETR - SOLID CORE HM	ETR - PT	ETR - PT	ETR - HM	NA	NA	HW-3

CONTINUOUS AIR BARRIER REQUIRED, TYP. GC TO PROVIDE SEALED CONNECTIONS AT ALL JOINTS VIA

CAULK OR GASKETS, TYP.

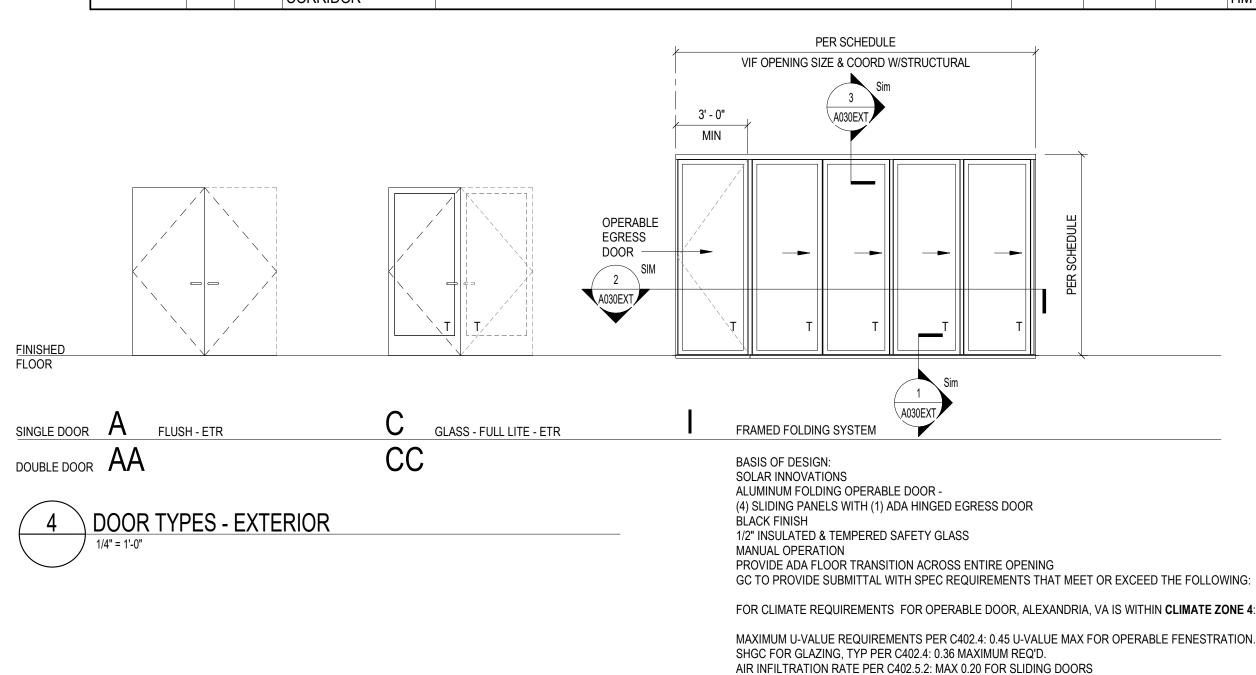

# DOOR HARDWARE SCHEDULE


HARDWARE SET	COMPONENT	COUNT	MANUFACTURER	MODEL	FINISH	COMMENTS				
	HINGES	6		EXISTING TO REMAIN						
	LOCK	1		EXISTING DEADBOLT						
	LEVER	2		EXISTING PUSH/PULL LEVER						
HW-1 EXISTING	CLOSER	2		EXISTING CLOSER		GC TO CONFIRM HARDWARE IS EXISTING AND				
ENTRY DOUBLE	SIGN	1		EXISTING		FUNCTIONING OR REPLACE AS NEEDED IF				
DOOR	DOOR SEALS	1		EXISTING - REPLACE IF MISSING		MISSING OR DAMAGED.				
D	DOOR SWEEP	1		EXISTING - REPLACE IF MISSING						
	ASTRAGAL	1		EXISTING - REPLACE IF MISSING						
	SILENCERS			EXISTING - REPLACE IF MISSING						
	HINGES	3	PER MFR	PER MFR	BLACK					
	LOCK	LOCK 1 PER MFR		PER MFR	BLACK					
	CLOSER 1 PER MFR		PER MFR	BLACK						
	PANIC DEVICE	DEVICE 1 PER MFR		PER MFR - MUST MEET ADA	BLACK	PROVIDE BLACK FINISH TYP. CLOSER TO BE ADA				
DOOR	DOOR SEAL	ALL PANELS	PER MFR	PER MFR	BLACK	COMPLIANT AND NOT REQUIRE MORE THAN 5LBS OF FORCE TO OPEN. LOCK @ SWING DOOR TO BE INTEGRATED ON PANIC DEVICE.				
IW-2 OPERABLE DOOR	BOTTOM SWEEP	ALL PANELS	PER MFR	PER MFR	BLACK					
	ADA SILL	1	PER MFR	PER MFR	ANOD					
	HINGES			EXISTING						
	LEVER			EXISTING						
LIM O EVICTINO	LATCH			EXISTING						
HW-3 EXISTING EMPLOYEE	CLOSER			EXISTING		GC TO CONFIRM HARDWARE IS EXISTING AND FUNCTIONING OR REPLACE AS NEEDED IF				
ACCESS DOOR	DOOR SEALS			EXISTING - REPLACE IF MISSING		MISSING OR DAMAGED.				
	DOORSWEEP			EXISTING - REPLACE IF MISSING						
	SILENCERS			EXISTING - REPLACE IF MISSING						
	SILL			EXISTING - REPLACE IF MISSING						

**38** 77. design

COPYRIGHT NOTICE:

STUDIO3877 EXPRESSLY RESERVES ITS COMMON LAW COPYRIGHT AND OTHER PROPERTY RIGHTS TO THESE PLANS. THESE PLANS ARE NOT TO BE REPRODUCED, CHANGED, OR COPIED IN ANY FORM OR MANNER WHATSOEVER, NOR ARE THEY TO BE ASSIGNED TO ANY THIRD PARTY WITHOUT OBTAINING THE EXPRESS WRITTEN PERMISSION AND CONSENT OF STUDIO3877.

BAKER'S BREAD LLC 115 KING STREET ALEXANDRIA, VA 22314 **GENERAL CONTRACTOR:** TECH 24 5256 EISENHOWER AVE ALEXANDRIA, VA 22304 [T] 571.233.8585 [W] WWW.TECH24CONSTRUCTION.COM **ARCHITECT:** 3333 K STREET NW, SUITE 60 WASHINGTON DC 20007 [T] 202.350.4244 [W] WWW.3877.DESIGN **MEP ENGINEER:** BUILT ENVIRONMENT ENGINEERS 6861 ELM STREET SUITE 2D MCLEAN, VA 22101 [T] 703.888.0649 [W] WWW.BEENGRS.COM STRUCTURAL ENGINEER: EHLERT BRYAN 8609 WESTWOOD CENTER DRIVE **TYSONS, VA 22182** 

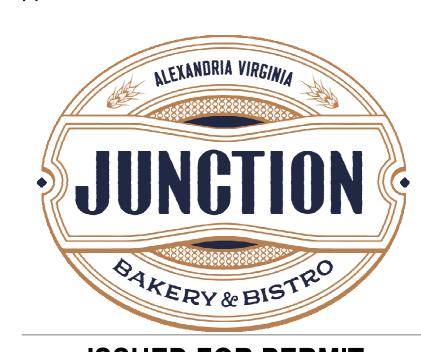

**ISSUED FOR PERMIT** 

DRAWING DATA

[T] 703.854.1028

[W] WWW.EHLERT-BRYAN.COM

PROJECT: JUNCTION BAKERY - ALEXANDRIA

ADDRESS: 1508 MT VERNON AVENUE ALEXANDRIA, VA 22301

SHEET SUBMISSION INDEX

• EXTERIOR PERMIT - 3.31.2023


2 EXTERIOR PERMIT REVISION 19 JUNE

REVISION

DATE

SEAL & SIGNATURE:

REV NO.

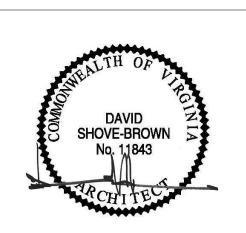


SHEET TITLE: SCHEDULES
PROJECT NO: 2020.72


DATE ISSUED: 02/08/23

SCALE: As indicated

A030EXT

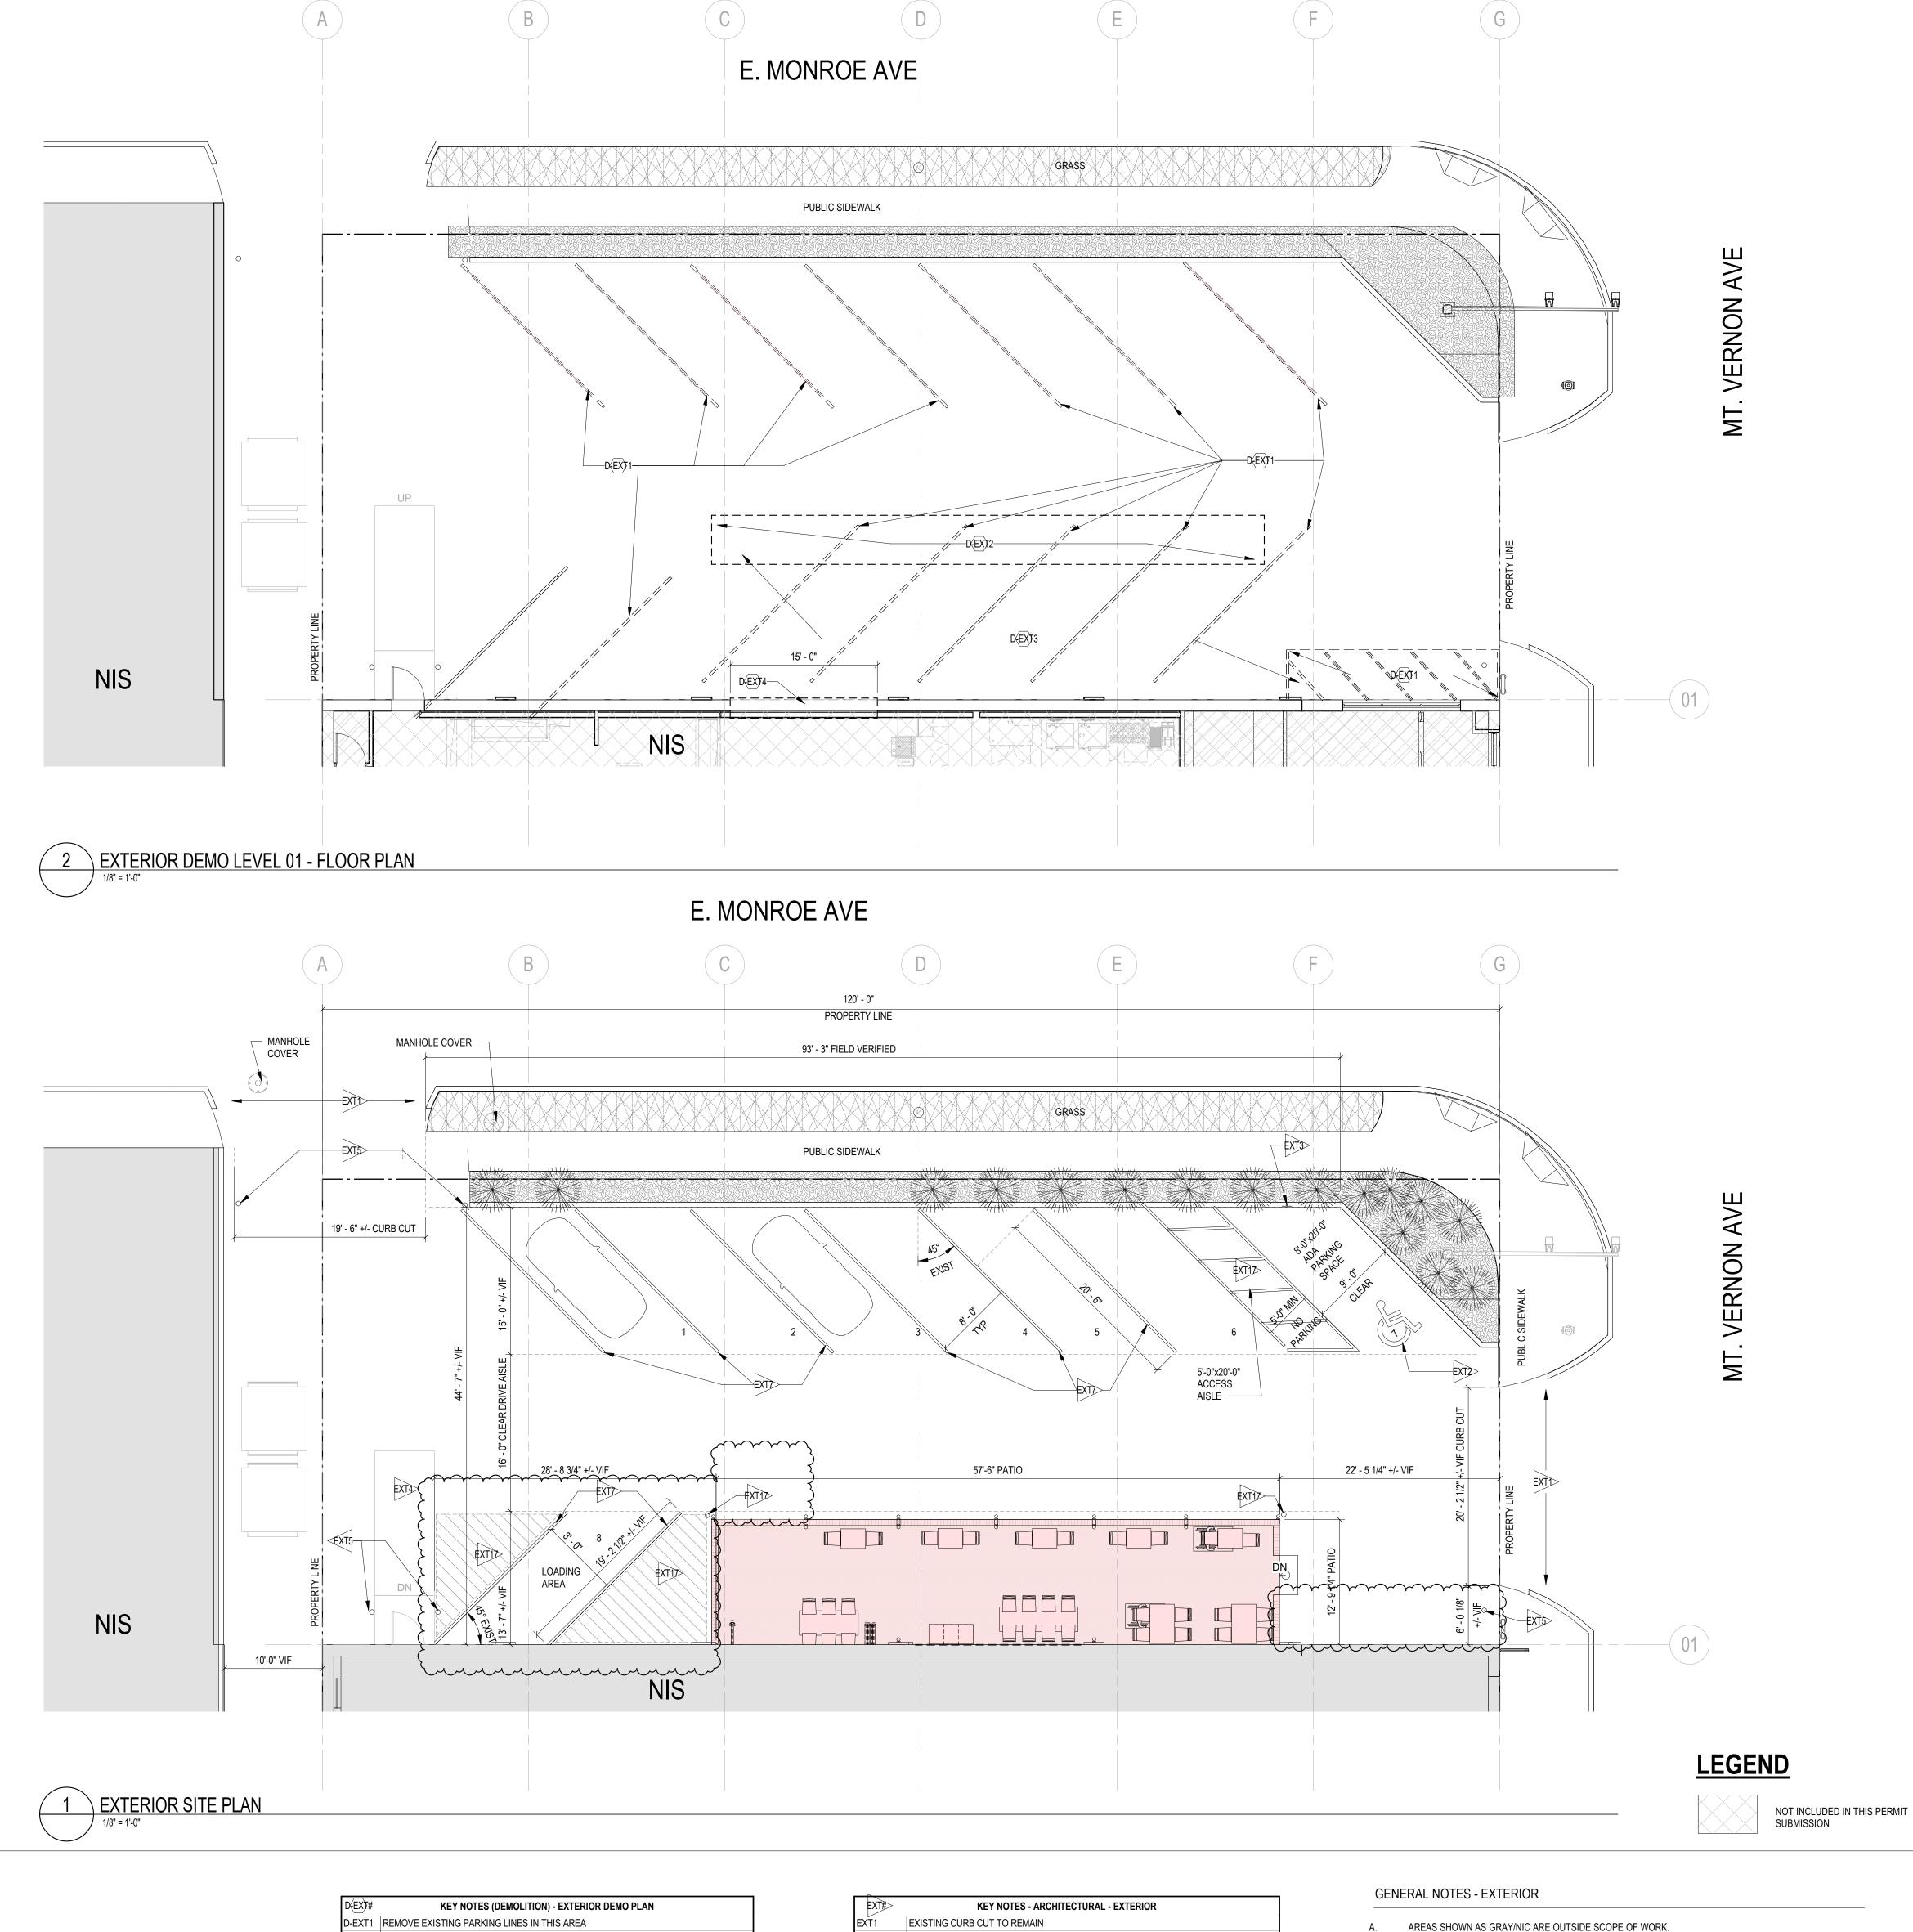

D-EXT2 COORDINATE SITE DEMO WITH STRUCTURAL D-EXT3 GC TO REMOVE AND SALVAGE EXISTING SITE FURNISHINGS. COORDINATE STORAGE WITH OWNER. PRESERVE AND PROTECT EXISTING PLANTERS FOR REINSTALLATION D-EXT4 REMOVE PORTION OF EXTERIOR MASONRY WALL. COORDINATE EXTENTS WITH NEW WORK. PROVIDE SHORING PER STRUCTURAL. SEE STRUCTURAL FOR MORE INFO.

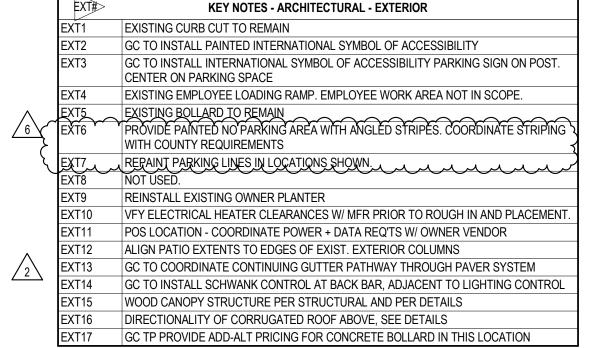

- ALL DIMS SHOWN ARE FROM FACE OF FINISH.
- ARCHITECTURAL ELEMENTS SHOWN IN GRAY ARE EXISTING TO REMAIN. ALL ELEMENTS NOTED AS EXISTING TO REMAIN SHALL BE PRESERVED AND PROTECTED BY THE GC BEFORE
- BEGINNING DEMOLITION. GC TO COORDINATE GUTTER EXTENSIONS BELOW PROPOSED PATIO WORK TO MAINTAIN ADEQUATE ROOF AND SIDE DRAINAGE.
- REFER TO FINISH SCHEDULE FOR MATERIAL SPECIFICATIONS. INSTALL PER MANUFACTURER RECOMMENDATIONS. REFER TO ELEVATIONS FOR ADDITIONAL WALL FINISHES AS TAGGED & SCHEDULED. SURFACES TO BE PAINTED MUST BE CLEAN. DRY. AND FREE OF DIRT DUST, GREASE, OIL, SOAP, WAX, SCALING PAINT, WATER SOLUBLE MATERIALS, AND MILDEW. REMOVE ANY PEELING OR SCALING PAINT AND SAND THESE AREAS TO FEATHER EDGES SMOOTH WITH ADJACENT SURFACES. GLOSSY AREAS SHOULD BE DULLED. DRYWALL SURFACES MUST BE FREE OF SANDING DUST.
- FINISH WALLS AS SPECIFIED IN PLAN AND ELEVATION. FURNISH AND INSTALL MILLWORK AS DETAILED, REFER TO MILLWORK DETAILS FOR MORE INFO. GC TO EVALUATE EXISTING SITE CONDITIONS PRIOR TO STARTING WORK. EXTERIOR SITE SLOPING SHOWN FOR REFERENCE ONLY, ALL SLOPPED AND HEIGHTS TO BE VERIFIED IN THE FILED BEFORE STARTING WORK.

w w w . 3 8 7 7 . d e s i g n

COPYRIGHT NOTICE:

STUDIO3877 EXPRESSLY RESERVES ITS COMMON LAW COPYRIGHT AND OTHER PROPERTY RIGHTS TO THESE PLANS. THESE PLANS ARE NOT TO BE REPRODUCED, CHANGED, OR COPIED IN ANY FORM OR MANNER WHATSOEVER, NOR ARE THEY TO BE ASSIGNED TO ANY THIRD PARTY WITHOUT OBTAINING THE EXPRESS WRITTEN PERMISSION AND CONSENT OF STUDIO3877.

BAKER'S BREAD LLC 115 KING STREET ALEXANDRIA, VA 22314 **GENERAL CONTRACTOR:** 5256 EISENHOWER AVE ALEXANDRIA, VA 22304 [T] 571.233.8585 [W] WWW.TECH24CONSTRUCTION.COM ARCHITECT: //3877 3333 K STREET NW, SUITE 60 WASHINGTON DC 20007 [T] 202.350.4244 [W] WWW.3877.DESIGN **MEP ENGINEER:** BUILT ENVIRONMENT ENGINEERS 6861 ELM STREET SUITE 2D MCLEAN, VA 22101 [T] 703.888.0649 [W] WWW.BEENGRS.COM

STRUCTURAL ENGINEER: EHLERT BRYAN 8609 WESTWOOD CENTER DRIVE TYSONS, VA 22182 [T] 703.854.1028 [W] WWW.EHLERT-BRYAN.COM



# **ISSUED FOR PERMIT**

DRAWING DATA

PROJECT: JUNCTION BAKERY -**ALEXANDRIA** 


ADDRESS: 1508 MT VERNON AVENUE **ALEXANDRIA, VA 22301** 

SHEET SUBMISSION INDEX O EXTERIOR PERMIT - 3.31.2023

DATE EXTERIOR PERMIT REVISION 19 JUNE 2023 SUP/EXTERIOR PERMIT REVISION 25 JAN 2024

# **REVISED 1/25/2024**

SEAL & SIGNATURE:

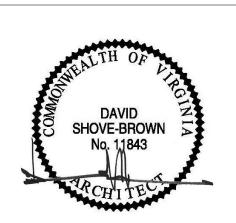



PROFESSIONAL CERTIFICATION: I HEREBY CERTIFY THAT THESE DOCUMENTS WERE PREPARED OR APPROVED BY ME, AND THAT I AM A DULY LICENSED PROFESSIONAL ARCHITECT UNDER THE LAWS OF THE STATE OF VIRGINIA, LICENSE No: 11843


SHEET TITLE: SITE PLAN

PROJECT NO: 2020.72 DATE ISSUED: 02/08/23

SCALE: As indicated

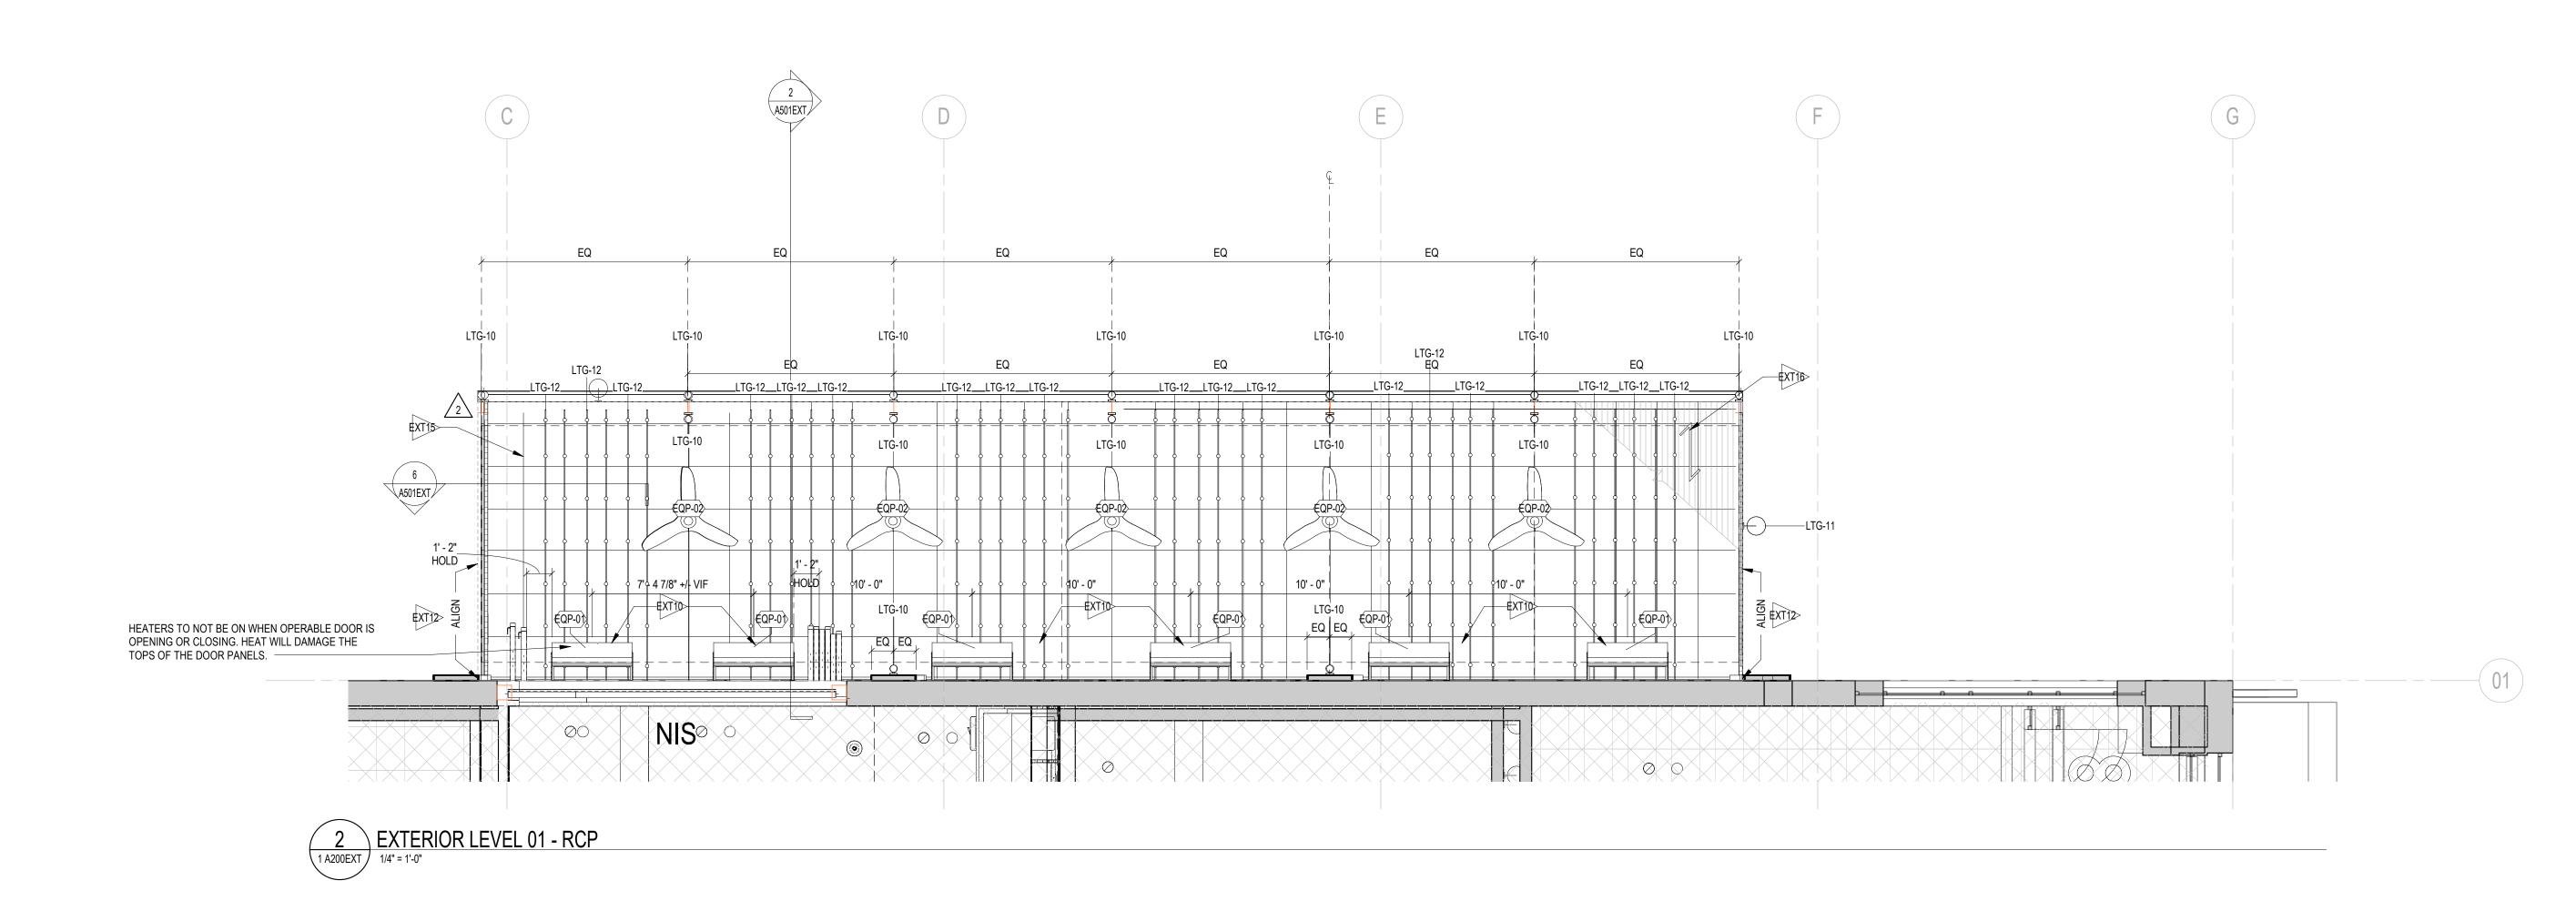

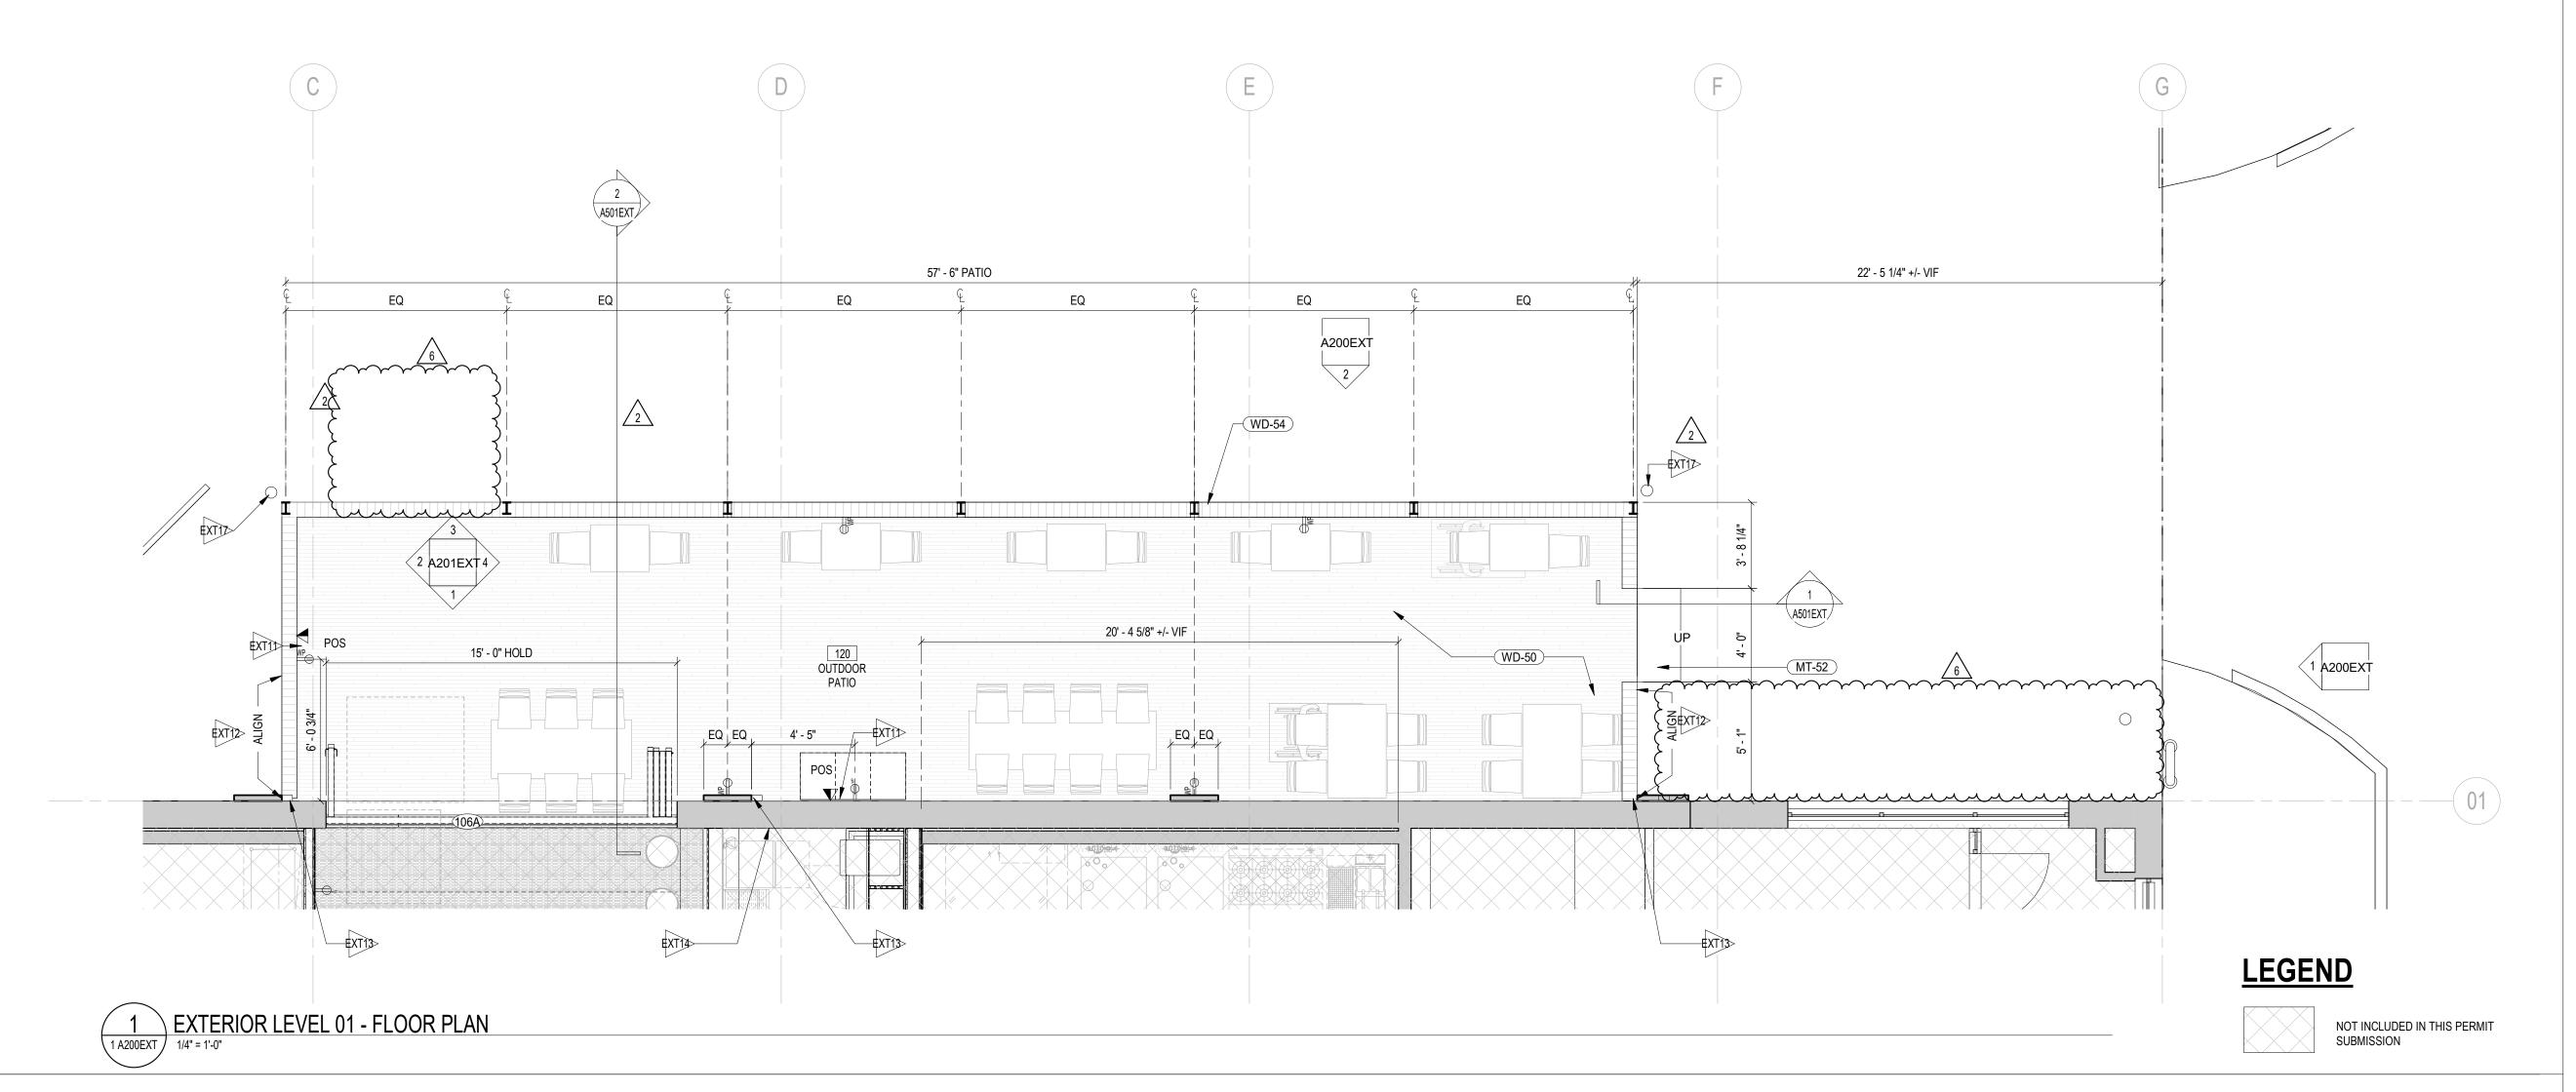

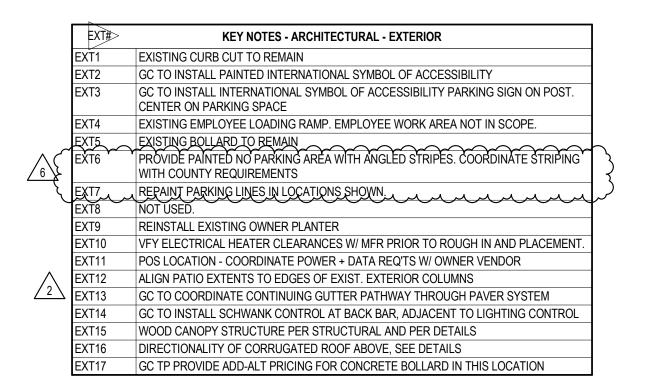

# GENERAL NOTES - EXTERIOR

- AREAS SHOWN AS GRAY/NIC ARE OUTSIDE SCOPE OF WORK. ALL DIMS SHOWN ARE FROM FACE OF FINISH.
- ARCHITECTURAL ELEMENTS SHOWN IN GRAY ARE EXISTING TO REMAIN. ALL ELEMENTS NOTED AS EXISTING TO REMAIN SHALL BE PRESERVED AND PROTECTED BY THE GC BEFORE
- BEGINNING DEMOLITION. GC TO COORDINATE GUTTER EXTENSIONS BELOW PROPOSED PATIO WORK TO MAINTAIN ADEQUATE ROOF AND SIDE DRAINAGE.
- REFER TO FINISH SCHEDULE FOR MATERIAL SPECIFICATIONS. INSTALL PER MANUFACTURER RECOMMENDATIONS. REFER TO ELEVATIONS FOR ADDITIONAL WALL FINISHES AS TAGGED & SCHEDULED. SURFACES TO BE PAINTED MUST BE CLEAN. DRY. AND FREE OF DIRT DUST, GREASE, OIL, SOAP, WAX, SCALING PAINT, WATER SOLUBLE MATERIALS, AND MILDEW, REMOVE ANY PEELING OR SCALING PAINT AND SAND THESE AREAS TO FEATHER EDGES SMOOTH WITH ADJACENT SURFACES. GLOSSY AREAS SHOULD BE DULLED. DRYWALL SURFACES MUST BE FREE OF SANDING DUST. FINISH WALLS AS SPECIFIED IN PLAN AND ELEVATION.
- FURNISH AND INSTALL MILLWORK AS DETAILED, REFER TO MILLWORK DETAILS FOR MORE INFO. GC TO EVALUATE EXISTING SITE CONDITIONS PRIOR TO STARTING WORK. EXTERIOR SITE SLOPING SHOWN FOR REFERENCE ONLY, ALL SLOPPED AND HEIGHTS TO BE VERIFIED IN THE FILED BEFORE STARTING WORK.

w w w . 3 8 7 7 . d e s i g n

COPYRIGHT NOTICE:

STUDIO3877 EXPRESSLY RESERVES ITS COMMON LAW COPYRIGHT AND OTHER PROPERTY RIGHTS TO THESE PLANS. THESE PLANS ARE NOT TO BE REPRODUCED, CHANGED, OR COPIED IN ANY FORM OR MANNER WHATSOEVER, NOR ARE THEY TO BE ASSIGNED TO ANY THIRD PARTY WITHOUT OBTAINING THE EXPRESS WRITTEN PERMISSION AND CONSENT OF STUDIO3877.

BAKER'S BREAD LLC 115 KING STREET ALEXANDRIA, VA 22314 **GENERAL CONTRACTOR:** TECH 24 5256 EISENHOWER AVE ALEXANDRIA, VA 22304 [T] 571.233.8585 [W] WWW.TECH24CONSTRUCTION.COM ARCHITECT: //3877 3333 K STREET NW, SUITE 60 WASHINGTON DC 20007 [T] 202.350.4244 [W] WWW.3877.DESIGN **MEP ENGINEER:** BUILT ENVIRONMENT ENGINEERS 6861 ELM STREET SUITE 2D

MCLEAN, VA 22101 [T] 703.888.0649 [W] WWW.BEENGRS.COM **STRUCTURAL ENGINEER:** EHLERT BRYAN 8609 WESTWOOD CENTER DRIVE TYSONS, VA 22182 [T] 703.854.1028 [W] WWW.EHLERT-BRYAN.COM



# **ISSUED FOR PERMIT**

DRAWING DATA

PROJECT: JUNCTION BAKERY -**ALEXANDRIA** 

ADDRESS: 1508 MT VERNON AVENUE **ALEXANDRIA, VA 22301** 


SHEET SUBMISSION INDEX O EXTERIOR PERMIT - 3.31.2023

EXTERIOR PERMIT REVISION 19 JUNE 2023 SUP/EXTERIOR PERMIT REVISION 25 JAN 2024

# **REVISED 1/25/2024**

DATE

SEAL & SIGNATURE:

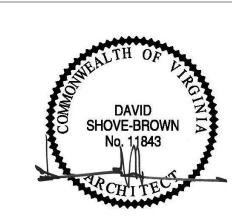


PROFESSIONAL CERTIFICATION: I HEREBY CERTIFY THAT THESE DOCUMENTS WERE PREPARED OR APPROVED BY ME, AND THAT I AM A DULY LICENSED PROFESSIONAL ARCHITECT UNDER THE LAWS OF THE STATE OF VIRGINIA, LICENSE No: 11843

SHEET TITLE: LEVEL 1 - PLANS


PROJECT NO: 2020.72 DATE ISSUED: 02/08/23

SCALE: As indicated

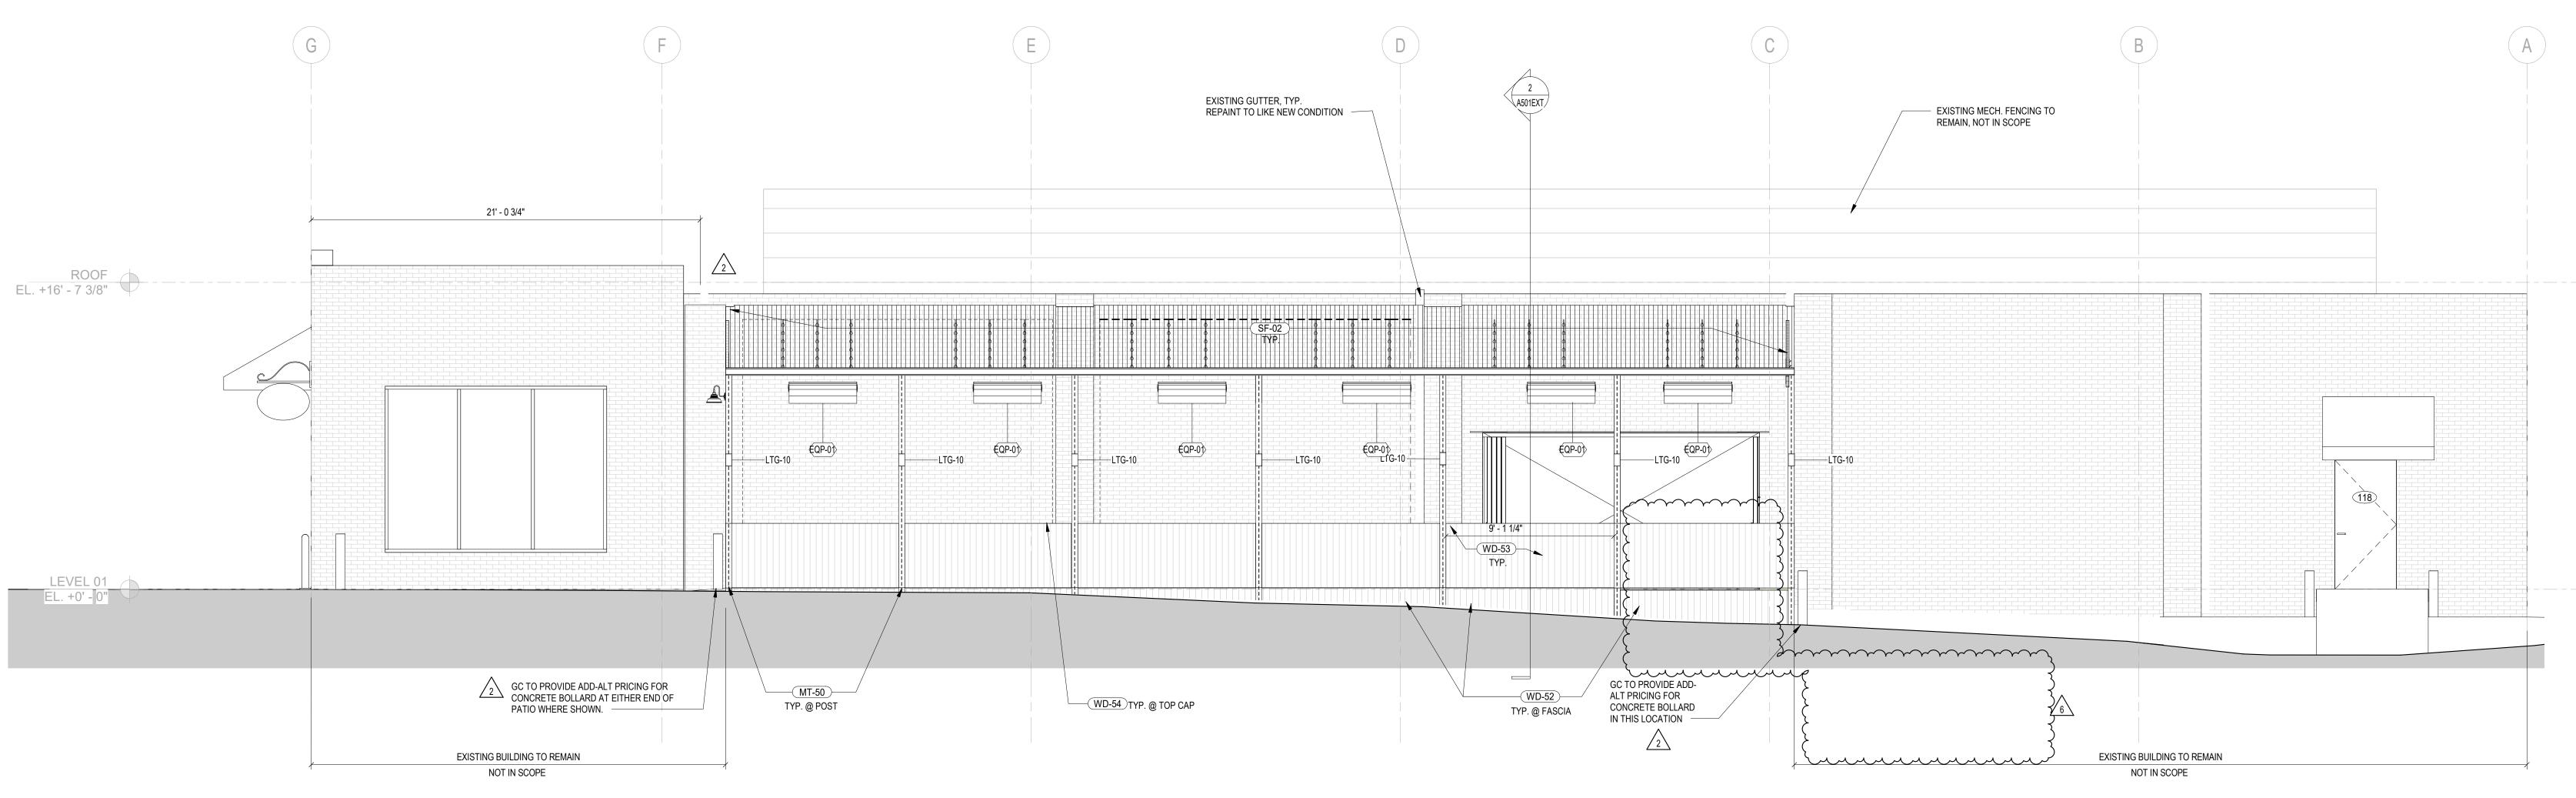

2 EXTERIOR ELEVATION - SIDE ELEVATION

1/4" = 1'-0"

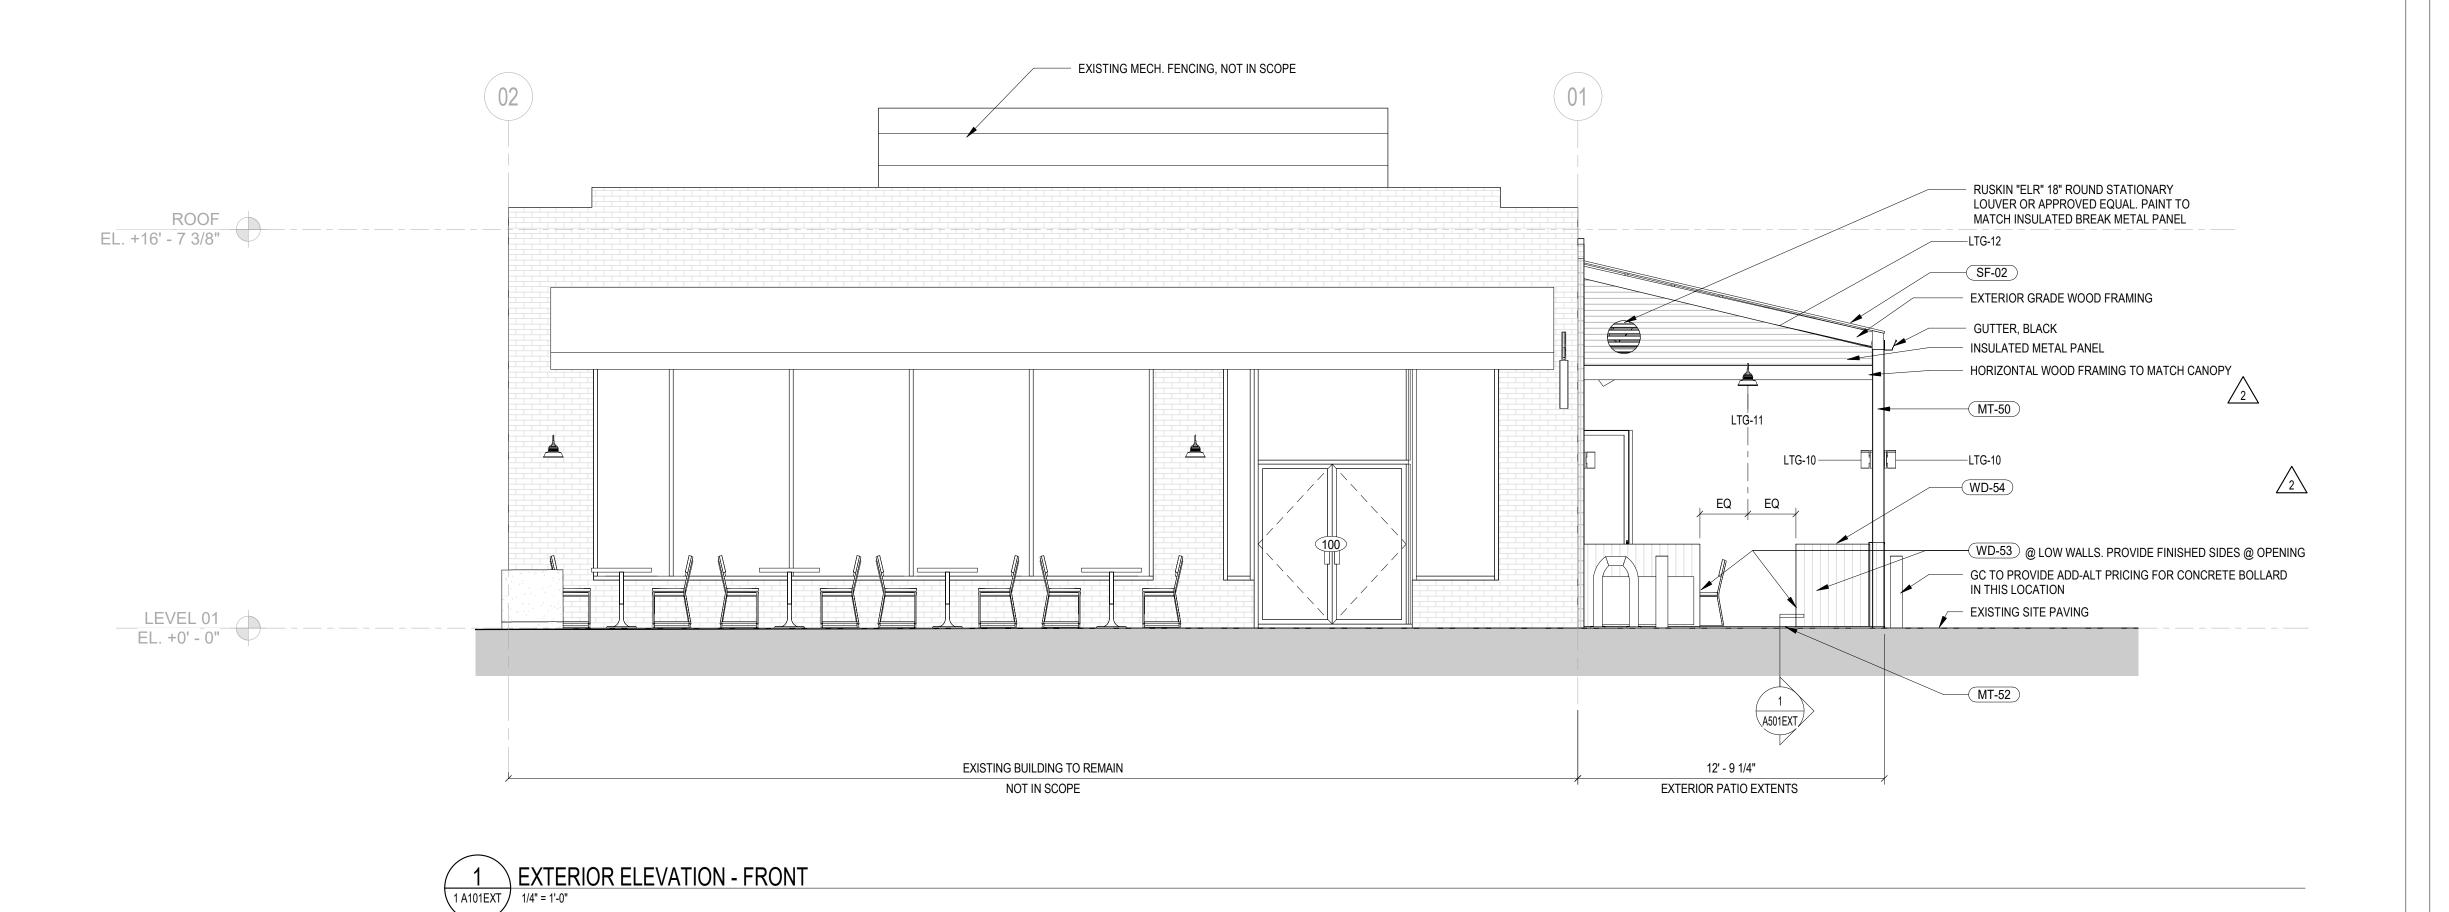

# GENERAL NOTES - EXTERIOR

- A. AREAS SHOWN AS GRAY/NIC ARE OUTSIDE SCOPE OF WORK.
  B. ALL DIMS SHOWN ARE FROM FACE OF FINISH.
- C. ARCHITECTURAL ELEMENTS SHOWN IN GRAY ARE EXISTING TO REMAIN.
  D. ALL ELEMENTS NOTED AS EXISTING TO REMAIN SHALL BE PRESERVED AND PROTECTED BY THE GC BEFORE
- BEGINNING DEMOLITION.
  GC TO COORDINATE GUTTER EXTENSIONS BELOW PROPOSED PATIO WORK TO MAINTAIN ADEQUATE ROOF AND SIDE DRAINAGE.
- REFER TO FINISH SCHEDULE FOR MATERIAL SPECIFICATIONS. INSTALL PER MANUFACTURER RECOMMENDATIONS.
  REFER TO ELEVATIONS FOR ADDITIONAL WALL FINISHES AS TAGGED & SCHEDULED.
  SURFACES TO BE PAINTED MUST BE CLEAN. DRY. AND FREE OF DIRT DUST, GREASE, OIL, SOAP, WAX, SCALING PAINT, WATER SOLUBLE MATERIALS, AND MILDEW. REMOVE ANY PEELING OR SCALING PAINT AND SAND THESE AREAS TO FEATHER EDGES SMOOTH WITH ADJACENT SURFACES. GLOSSY AREAS SHOULD BE DULLED. DRYWALL
- SURFACES MUST BE FREE OF SANDING DUST.

  I. FINISH WALLS AS SPECIFIED IN PLAN AND ELEVATION.

  J. FURNISH AND INSTALL MILLWORK AS DETAILED, REFER TO MILLWORK DETAILS FOR MORE INFO.

  K. GC TO EVALUATE EXISTING SITE CONDITIONS PRIOR TO STARTING WORK. EXTERIOR SITE SLOPING SHOWN FOR REFERENCE ONLY, ALL SLOPPED AND HEIGHTS TO BE VERIFIED IN THE FILED BEFORE STARTING WORK.

**3877. de sign** 

COPYRIGHT NOTICE:

STUDIO3877 EXPRESSLY RESERVES ITS COMMON LAW COPYRIGHT AND OTHER PROPERTY RIGHTS TO THESE PLANS. THESE PLANS ARE NOT TO BE REPRODUCED, CHANGED, OR COPIED IN ANY FORM OR MANNER WHATSOEVER, NOR ARE THEY TO BE ASSIGNED TO ANY THIRD PARTY WITHOUT OBTAINING THE EXPRESS WRITTEN PERMISSION AND CONSENT OF STUDIO3877.

BAKER'S BREAD LLC 115 KING STREET ALEXANDRIA, VA 22314 **GENERAL CONTRACTOR:** 5256 EISENHOWER AVE ALEXANDRIA, VA 22304 [T] 571.233.8585 [W] WWW.TECH24CONSTRUCTION.COM ARCHITECT: //3877 3333 K STREET NW, SUITE 60 WASHINGTON DC 20007 [T] 202.350.4244 [W] WWW.3877.DESIGN **MEP ENGINEER:** BUILT ENVIRONMENT ENGINEERS 6861 ELM STREET SUITE 2D MCLEAN, VA 22101 [T] 703.888.0649 [W] WWW.BEENGRS.COM <u>STRUCTURAL ENGINEER :</u> EHLERT BRYAN 8609 WESTWOOD CENTER DRIVE

TYSONS, VA 22182

[T] 703.854.1028 [W] WWW.EHLERT-BRYAN.COM



# **ISSUED FOR PERMIT**

DRAWING DATA

PROJECT: JUNCTION BAKERY - ALEXANDRIA

ADDRESS: 1508 MT VERNON AVENUE ALEXANDRIA, VA 22301

SHEET SUBMISSION INDEX


© EXTERIOR PERMIT - 3.31.2023

REV NO. REVISION DATE

2 EXTERIOR PERMIT REVISION 19 JUNE 2023
6 SUP/EXTERIOR PERMIT REVISION 25 JAN 2024

# **REVISED 1/25/2024**

SEAL & SIGNATURE:

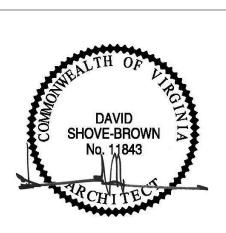

PROFESSIONAL CERTIFICATION: I HEREBY CERTIFY THAT THESE
DOCUMENTS WERE PREPARED OR APPROVED BY ME, AND THAT I
AM A DULY LICENSED PROFESSIONAL ARCHITECT UNDER THE LAWS
OF THE STATE OF VIRGINIA, LICENSE No: 11843

SHEET TITLE: EXTERIOR ELEVATIONS


PROJECT NO: 2020.72


DATE ISSUED: 02/08/23


SCALE: As indicated


A200EXT



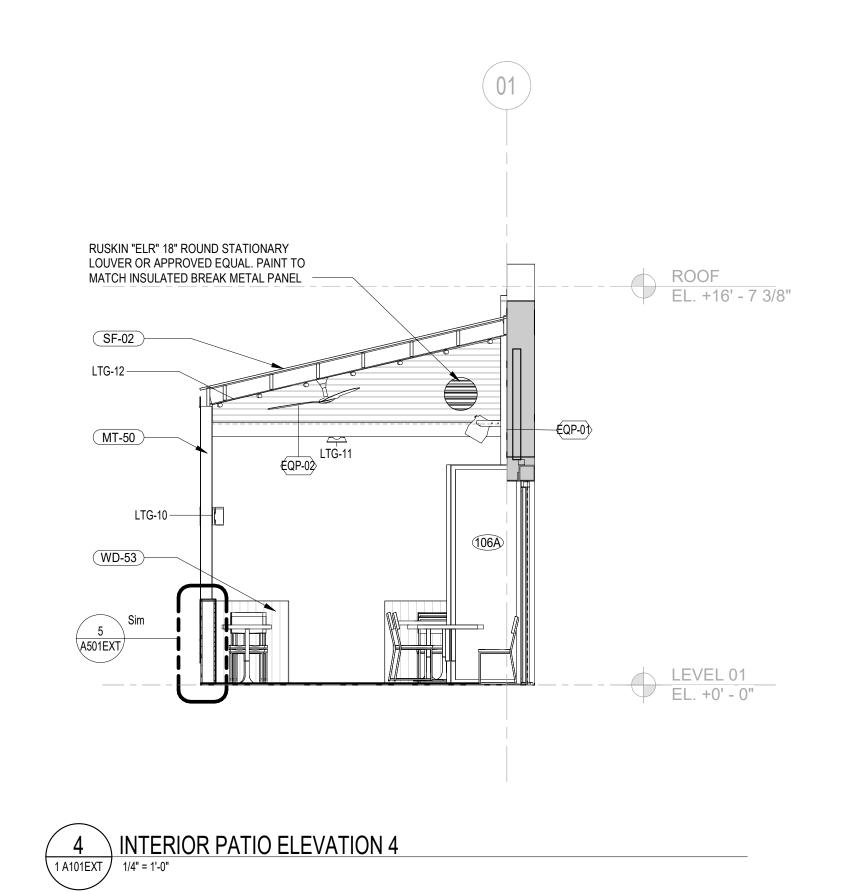

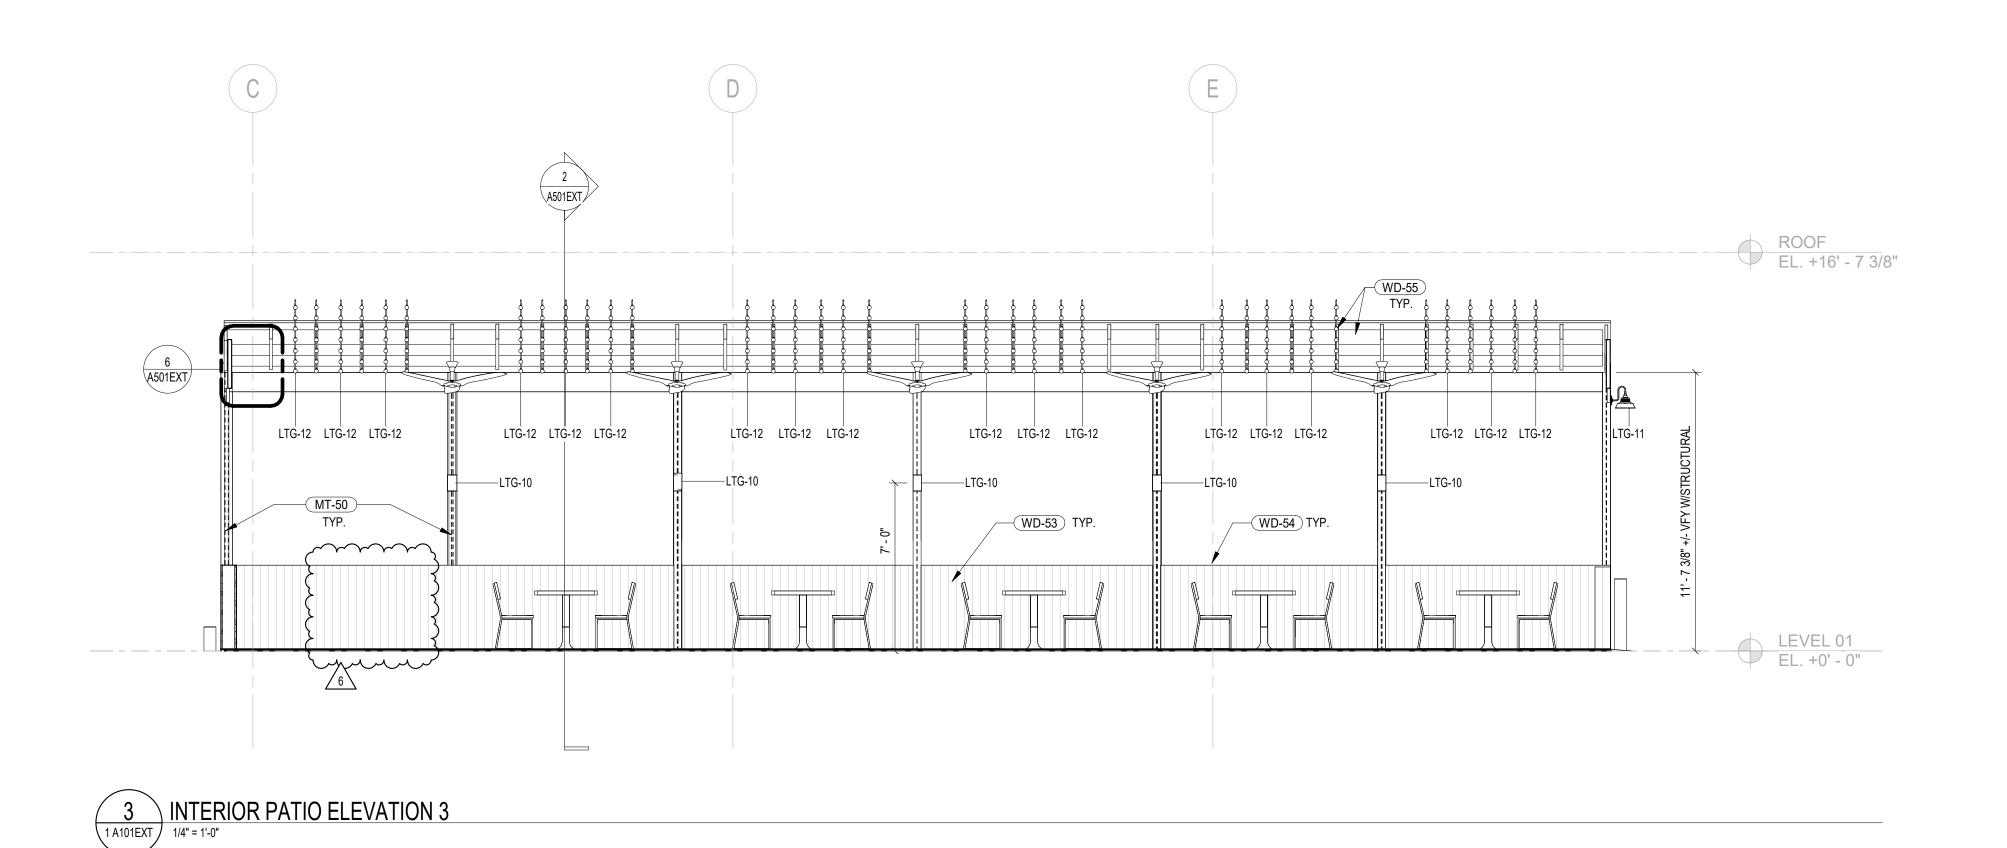

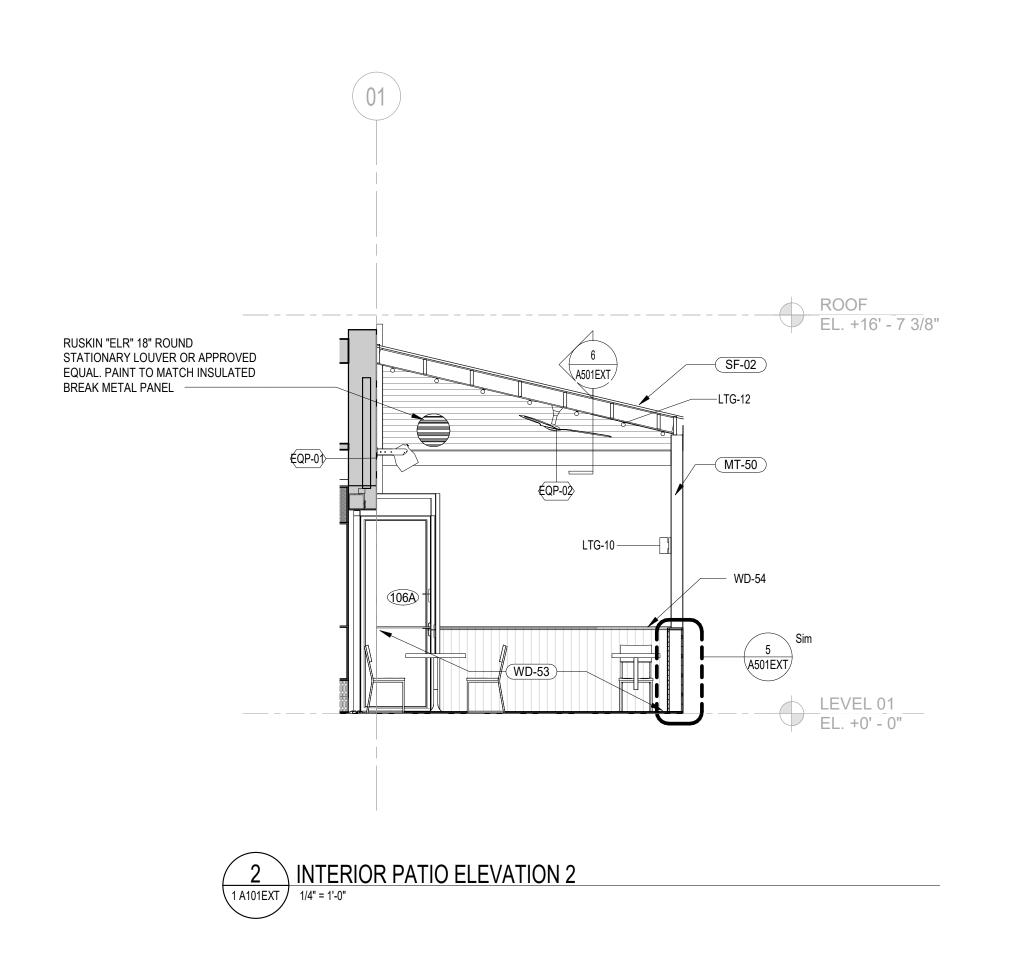

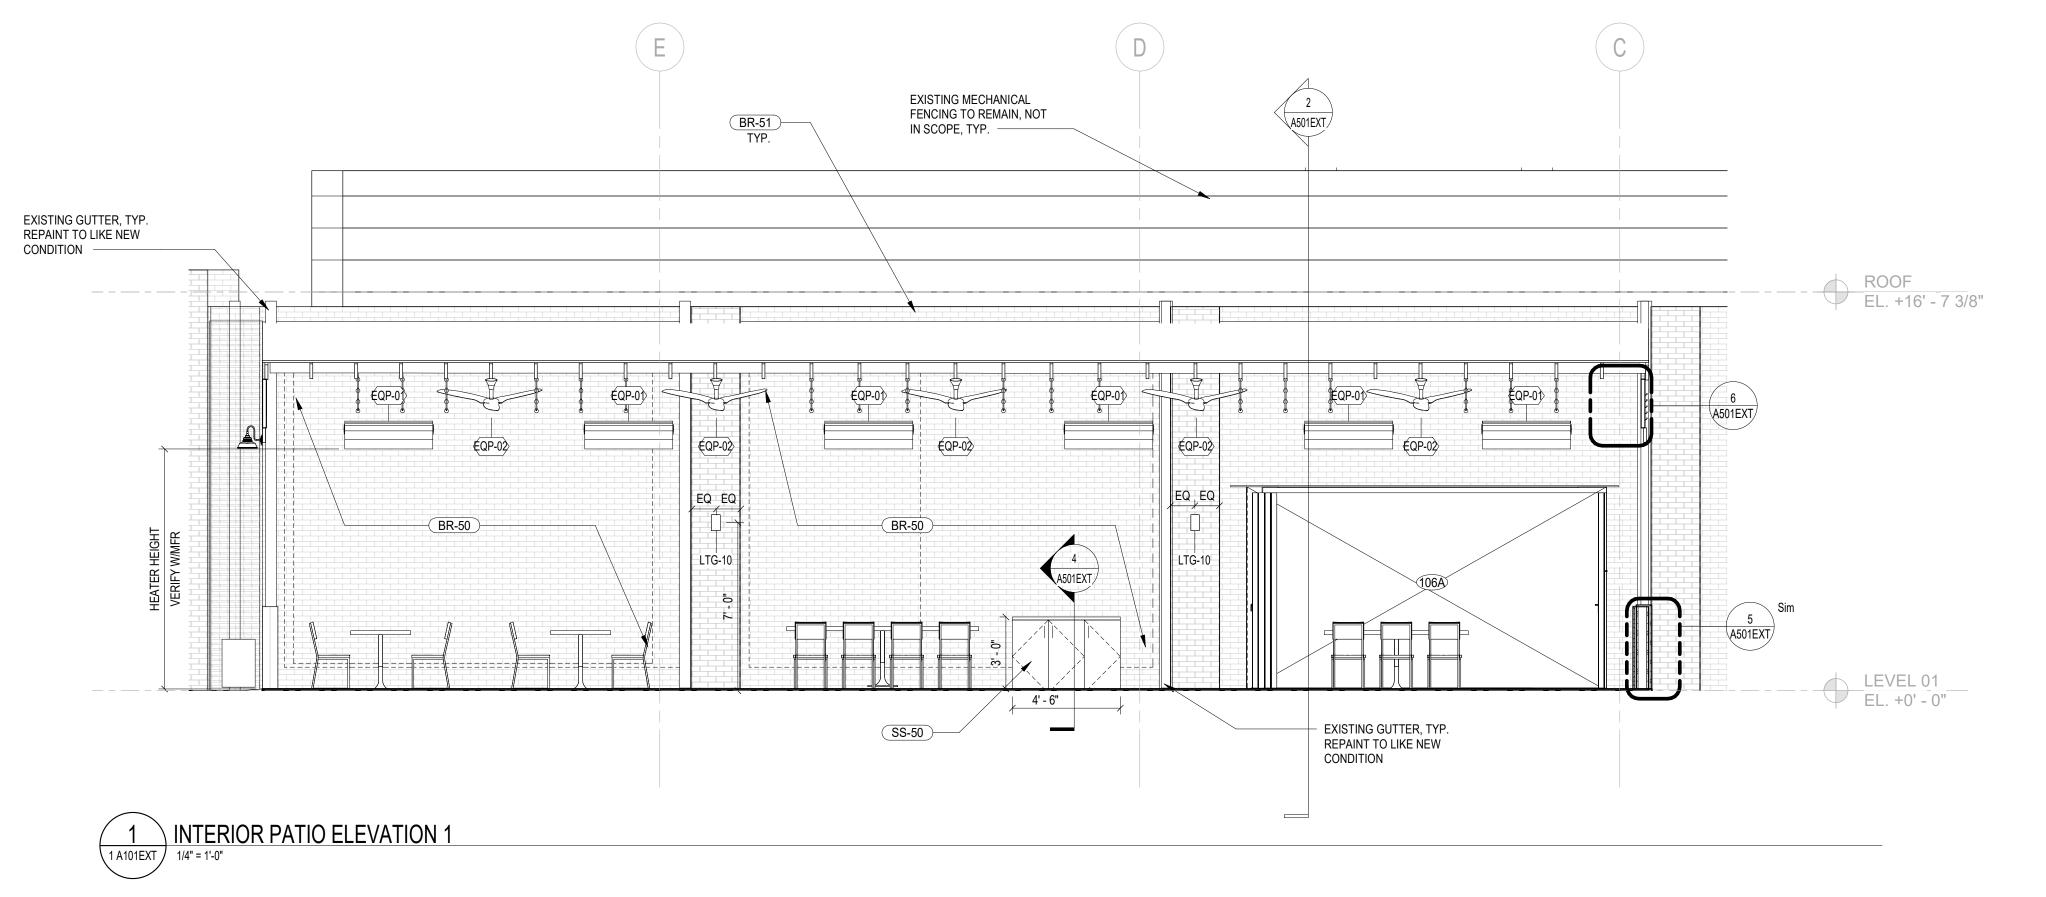

# GENERAL NOTES - EXTERIOR

- A. AREAS SHOWN AS GRAY/NIC ARE OUTSIDE SCOPE OF WORK.B. ALL DIMS SHOWN ARE FROM FACE OF FINISH.
- ALL DIMS SHOWN ARE FROM FACE OF FINISH.

  ARCHITECTURAL ELEMENTS SHOWN IN GRAY ARE EXISTING TO REMAIN.

  ALL ELEMENTS NOTED AS EXISTING TO REMAIN SHALL BE PRESERVED AND PROTECTED BY THE GC BEFORE
- BEGINNING DEMOLITION.
  GC TO COORDINATE GUTTER EXTENSIONS BELOW PROPOSED PATIO WORK TO MAINTAIN ADEQUATE ROOF AND
- SIDE DRAINAGE.

  F. REFER TO FINISH SCHEDULE FOR MATERIAL SPECIFICATIONS. INSTALL PER MANUFACTURER RECOMMENDATIONS.

  G. REFER TO ELEVATIONS FOR ADDITIONAL WALL FINISHES AS TAGGED & SCHEDULED.

  H. SURFACES TO BE PAINTED MUST BE CLEAN DRY AND FREE OF DIRT DUST. GREASE, OIL SOAP, WAX, SCALING.
- REFER TO ELEVATIONS FOR ADDITIONAL WALL FINISHES AS TAGGED & SCHEDULED.
  SURFACES TO BE PAINTED MUST BE CLEAN. DRY. AND FREE OF DIRT DUST, GREASE, OIL, SOAP, WAX, SCALING
  PAINT, WATER SOLUBLE MATERIALS, AND MILDEW. REMOVE ANY PEELING OR SCALING PAINT AND SAND THESE
  AREAS TO FEATHER EDGES SMOOTH WITH ADJACENT SURFACES. GLOSSY AREAS SHOULD BE DULLED. DRYWALL
  SURFACES MUST BE FREE OF SANDING DUST.
  FINISH WALLS AS SPECIFIED IN PLAN AND ELEVATION.
- FURNISH AND INSTALL MILLWORK AS DETAILED, REFER TO MILLWORK DETAILS FOR MORE INFO.
  GC TO EVALUATE EXISTING SITE CONDITIONS PRIOR TO STARTING WORK. EXTERIOR SITE SLOPING SHOWN FOR
  REFERENCE ONLY, ALL SLOPPED AND HEIGHTS TO BE VERIFIED IN THE FILED BEFORE STARTING WORK.

# **3877. design**

COPYRIGHT NOTICE:

STUDIO3877 EXPRESSLY RESERVES ITS COMMON LAW COPYRIGHT AND OTHER PROPERTY RIGHTS TO THESE PLANS. THESE PLANS ARE NOT TO BE REPRODUCED, CHANGED, OR COPIED IN ANY FORM OR MANNER WHATSOEVER, NOR ARE THEY TO BE ASSIGNED TO ANY THIRD PARTY WITHOUT OBTAINING THE EXPRESS WRITTEN PERMISSION AND CONSENT OF STUDIO3877.

OWNER : BAKER'S BREAD LLC 115 KING STREET ALEXANDRIA, VA 22314 **GENERAL CONTRACTOR:** TECH 24 5256 EISENHOWER AVE ALEXANDRIA, VA 22304 [T] 571.233.8585 [W] WWW.TECH24CONSTRUCTION.COM ARCHITECT: //3877 3333 K STREET NW, SUITE 60 WASHINGTON DC 20007 [T] 202.350.4244 [W] WWW.3877.DESIGN MEP ENGINEER : BUILT ENVIRONMENT ENGINEERS 6861 ELM STREET SUITE 2D MCLEAN, VA 22101 [T] 703.888.0649 [W] WWW.BEENGRS.COM

MCLEAN, VA 22101
[T] 703.888.0649
[W] WWW.BEENGRS.COM

STRUCTURAL ENGINEER:
EHLERT BRYAN
8609 WESTWOOD CENTER DRIVE
SUITE 800
TYSONS, VA 22182
[T] 703.854.1028
[W] WWW.EHLERT-BRYAN.COM



# **ISSUED FOR PERMIT**

DRAWING DATA

PROJECT: JUNCTION BAKERY - ALEXANDRIA

ADDRESS: 1508 MT VERNON AVENUE ALEXANDRIA, VA 22301


SHEET SUBMISSION INDEX

○ EXTERIOR PERMIT - 3.31.2023

2 EXTERIOR PERMIT REVISION 19 JUNE 2023
6 SUP/EXTERIOR PERMIT REVISION 25 JAN 2024

# **REVISED 1/25/2024**

SEAL & SIGNATURE:

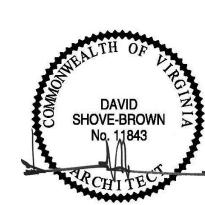

PROFESSIONAL CERTIFICATION: I HEREBY CERTIFY THAT THESE
DOCUMENTS WERE PREPARED OR APPROVED BY ME, AND THAT I
AM A DULY LICENSED PROFESSIONAL ARCHITECT UNDER THE LAWS
OF THE STATE OF VIRGINIA, LICENSE No: 11843


SHEET TITLE: PATIO ELEVATIONS

PROJECT NO: 2020.72

DATE ISSUED: 02/08/23

SCALE: As indicated

/25/2024 3:42:52 PM

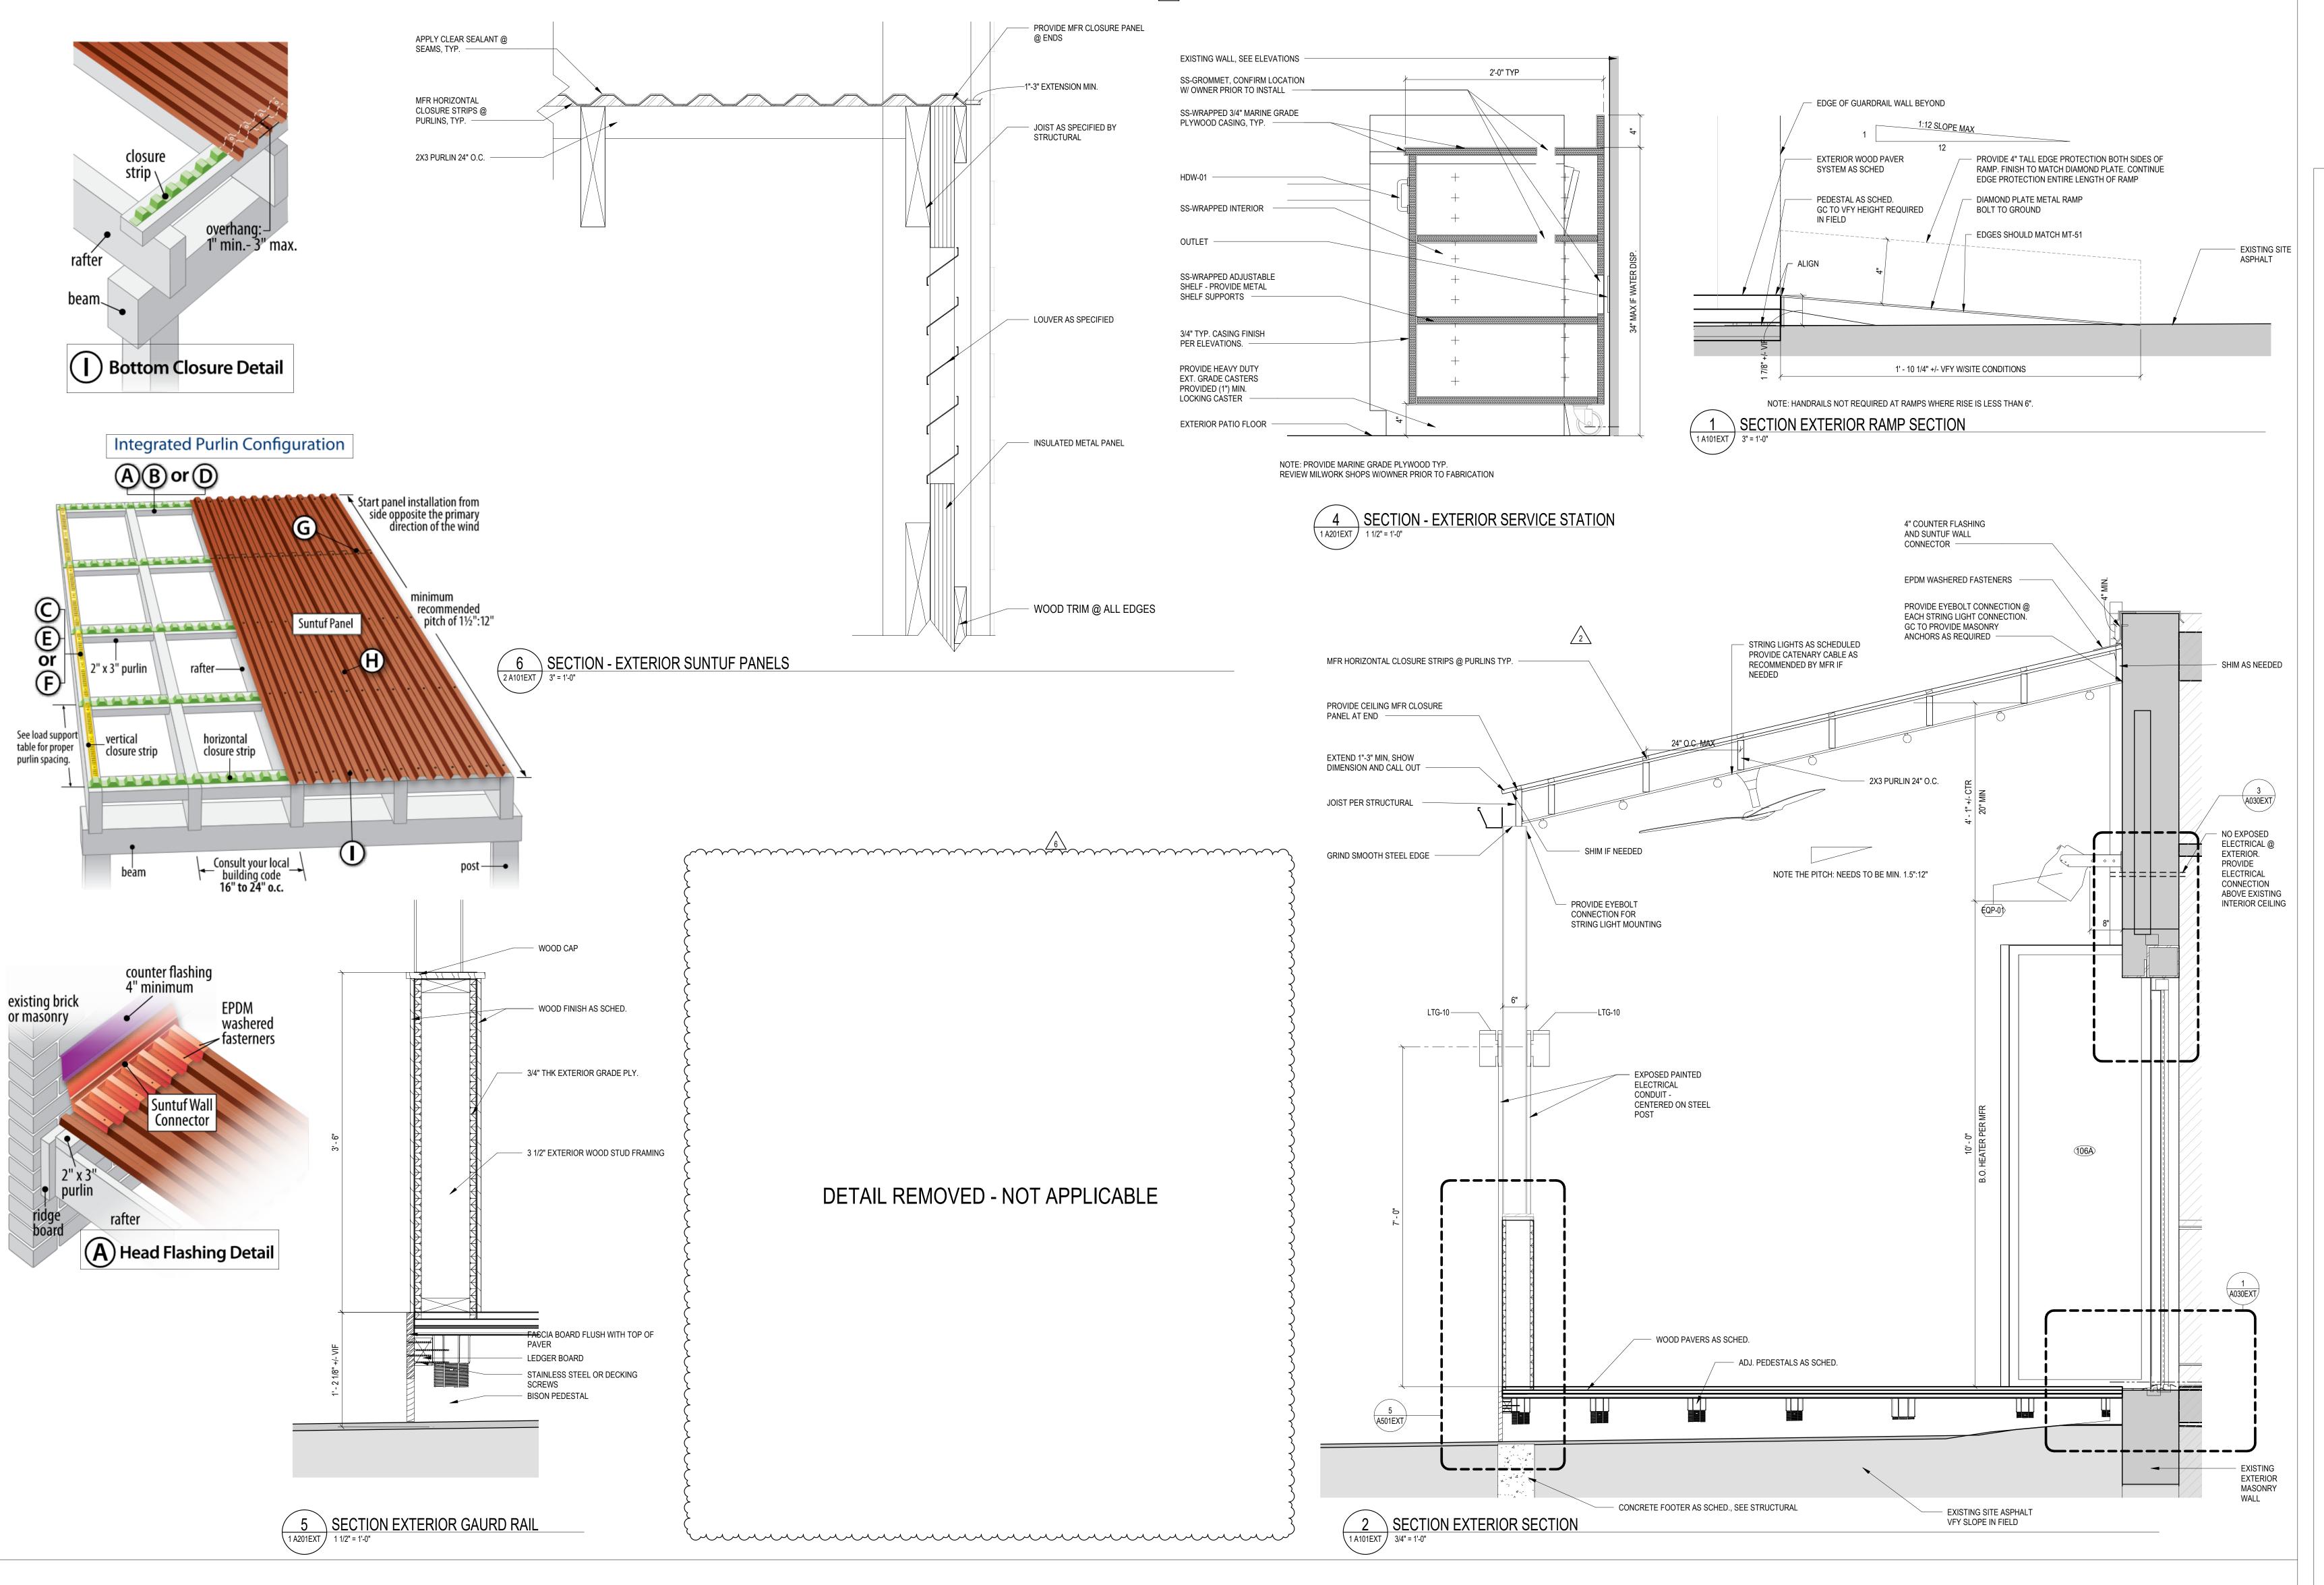

# GENERAL NOTES - EXTERIOR

- A. AREAS SHOWN AS GRAY/NIC ARE OUTSIDE SCOPE OF WORK.
- ALL DIMS SHOWN ARE FROM FACE OF FINISH.

  ARCHITECTURAL ELEMENTS SHOWN IN GRAY ARE EXISTING TO REMAIN.
- ALL ELEMENTS NOTED AS EXISTING TO REMAIN SHALL BE PRESERVED AND PROTECTED BY THE GC BEFORE BEGINNING DEMOLITION.
- E. GC TO COORDINATE GUTTER EXTENSIONS BELOW PROPOSED PATIO WORK TO MAINTAIN ADEQUATE ROOF AND SIDE DRAINAGE.
   F. REFER TO FINISH SCHEDULE FOR MATERIAL SPECIFICATIONS. INSTALL PER MANUFACTURER RECOMMENDATIONS.
   G. REFER TO ELEVATIONS FOR ADDITIONAL WALL FINISHES AS TAGGED & SCHEDULED.
- REFER TO ELEVATIONS FOR ADDITIONAL WALL FINISHES AS TAGGED & SCHEDULED.
  SURFACES TO BE PAINTED MUST BE CLEAN. DRY. AND FREE OF DIRT DUST, GREASE, OIL, SOAP, WAX, SCALING
  PAINT, WATER SOLUBLE MATERIALS, AND MILDEW. REMOVE ANY PEELING OR SCALING PAINT AND SAND THESE
  AREAS TO FEATHER EDGES SMOOTH WITH ADJACENT SURFACES. GLOSSY AREAS SHOULD BE DULLED. DRYWALL
  SURFACES MUST BE FREE OF SANDING DUST.
  FINISH WALLS AS SPECIFIED IN PLAN AND ELEVATION.
- FURNISH AND INSTALL MILLWORK AS DETAILED, REFER TO MILLWORK DETAILS FOR MORE INFO.
  GC TO EVALUATE EXISTING SITE CONDITIONS PRIOR TO STARTING WORK. EXTERIOR SITE SLOPING SHOWN FOR REFERENCE ONLY, ALL SLOPPED AND HEIGHTS TO BE VERIFIED IN THE FILED BEFORE STARTING WORK.

**38** 7 7 . d e s i g n

COPYRIGHT NOTICE:

STUDIO3877 EXPRESSLY RESERVES ITS COMMON LAW COPYRIGHT AND OTHER PROPERTY RIGHTS TO THESE PLANS. THESE PLANS ARE NOT TO BE REPRODUCED, CHANGED, OR COPIED IN ANY FORM OR MANNER WHATSOEVER, NOR ARE THEY TO BE ASSIGNED TO ANY THIRD PARTY WITHOUT OBTAINING THE EXPRESS WRITTEN PERMISSION AND CONSENT OF STUDIO3877.

OWNER:
BAKER'S BREAD LLC
115 KING STREET
ALEXANDRIA, VA 22314
GENERAL CONTRACTOR:
TECH 24
5256 EISENHOWER AVE
ALEXANDRIA, VA 22304
[T] 571.233.8585
[W] WWW.TECH24CONSTRUCTION.COM
ARCHITECT:
//3877
3333 K STREET NW, SUITE 60
WASHINGTON DC 20007
[T] 202.350.4244

[W] WWW.3877.DESIGN

MEP ENGINEER:

BUILT ENVIRONMENT ENGINEERS

6861 ELM STREET

SUITE 2D

MCLEAN, VA 22101

[T] 703.888.0649
[W] WWW.BEENGRS.COM

STRUCTURAL ENGINEER:
EHLERT BRYAN
8609 WESTWOOD CENTER DRIVE
SUITE 800
TYSONS, VA 22182
[T] 703.854.1028
[W] WWW.EHLERT-BRYAN.COM



# **ISSUED FOR PERMIT**

DRAWING DATA

PROJECT: JUNCTION BAKERY - ALEXANDRIA

ADDRESS: 1508 MT VERNON AVENUE ALEXANDRIA, VA 22301

SHEET SUBMISSION INDEX

© EXTERIOR PERMIT - 3.31.2023


NO. REVISION DATE

2 EXTERIOR PERMIT REVISION
6 SUP/EXTERIOR PERMIT REVISION

SUP/EXTERIOR PERMIT REVISION 25 JAN 2024

# **REVISED 1/25/2024**

SEAL & SIGNATURE:

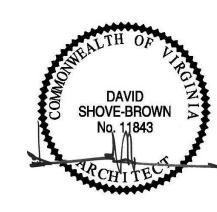

PROFESSIONAL CERTIFICATION: I HEREBY CERTIFY THAT THESE
DOCUMENTS WERE PREPARED OR APPROVED BY ME, AND THAT I
AM A DULY LICENSED PROFESSIONAL ARCHITECT UNDER THE LAWS
OF THE STATE OF VIRGINIA, LICENSE No: 11843

SHEET TITLE: CONSTRUCTION DETAILS

PROJECT NO: 2020.72

DATE ISSUED: 02/08/23

SCALE: As indicated

**4501EXT** 

#### STRUCTURAL NOTES

## GENERAL

A. THE MODIFICATIONS TO THE BUILDING ARE DESIGNED UNDER THE PROVISIONS OF THE 2018

INTERNATIONAL BUILDING CODE AND ASCE 7-16. B. THE FOLLOWING LOADS WERE USED IN THE DESIGN:

BUILDING RISK CATEGORY

ROOF LIVE LOAD MINIMUM UNIFORM ROOF LIVE LOAD 30 PSF / 300 PT LOAD

ROOF SNOW LOAD GROUND SNOW LOAD (Pg) 25 PSF FLAT-ROOF SNOW LOAD (Pf) 21 PSF SNOW EXPOSURE FACTOR (Ce) SNOW LOAD IMPORTANCE FACTOR (Is) THERMAL FACTOR (Ct) ROOF RAIN LOAD (R), PER ASCE 7 SECTION 8.3

WIND SPEED (3-SECOND GUST)

115 MPH Vasd: (0.77\*VULT) 90 MPH WIND EXPOSURE

C. SEE ARCHITECTURAL DRAWINGS FOR ANGLES, CLIPS, PLATES, ETC., AND OTHER MISCELLANEOUS ITEMS. VERIFY AND COORDINATE ALL FRAMES, OPENINGS, ETC. WITH THE MECHANICAL AND ELECTRICAL CONTRACTORS.

D. SUBMIT SHOP DRAWINGS FOR THE FOLLOWING ITEMS. SUBMITTALS INCLUDE BUT MAY NOT BE LIMITED

--CONCRETE MIX DESIGN --REINFORCING STEEL --STRUCTURAL STEEL --POLYCARBONATE ROOF SHEATHING

DO NOT USE CONTRACT DRAWINGS AS A BASE FOR SHOPS. REVIEW IS LIMITED TO DESIGN CONFORMANCE. CONTRACTOR IS RESPONSIBLE FOR DIMENSIONS.

#### EARTHWORK

A. FOUNDATIONS ARE DESIGNED TO BEAR ON ENGINEERED FILL OR NATURAL SOIL WITH A CAPACITY OF 1,500 PSF. THIS VALUE IS TO BE VERIFIED IN THE FIELD BY THE BUILDING INSPECTOR OR A QUALIFIED TESTING AGENCY.

B. BOTTOM OF ALL EXTERIOR FOOTINGS SHALL BE A MINIMUM OF 2 FOOT-6 INCH BELOW FINISH EXTERIOR GRADE. WHERE REQUIRED, STEP FOOTINGS IN RATIO OF 2 HORIZONTAL TO 1 VERTICAL.

C. COMPACTED BACKFILL BELOW BUILDING SLABS AND FOOTINGS: ALL SOIL FILL MATERIAL MUST BE APPROVED BY SOILS ENGINEER PRIOR TO PLACEMENT. PROOFROLL SUBGRADE REMOVING AND REPLACING SOFT OR COMPRESSIVE MATERIALS. FILL MATERIAL SHALL BE PLACED IN LAYERS NOT TO EXCEED 8 INCHES AND COMPACTED TO MIN. 95 PERCENT OF THE DRY MAXIMUM DENSITY AS DETERMINED BY ASTM D698.

#### DEMOLITION

A. CONTRACTOR SHALL VERIFY THAT EXISTING CONSTRUCTION CORRESPONDS TO THAT SHOWN ON THE DRAWINGS. DISCREPANCIES SHALL BE IMMEDIATELY BROUGHT TO THE ATTENTION OF THE ARCHITECT/ENGINEER.

B. PROVIDE ADEQUATE SHORING, BRACING AND OTHER TEMPORARY SUPPORT DURING DEMOLITION. UNTIL PROPERLY SHORED. DO NOT CUT EXISTING STRUCTURAL MEMBER IN A MANNER RESULTING IN A REDUCTION OF LOAD-CARRYING CAPACITY. DO NOT EXCEED THE CAPACITY OF THE EXISTING STRUCTURE WITH SUPERIMPOSED LOADS.

#### CONCRETE

A. CONCRETE CONSTRUCTION SHALL BE PER THE APPLICABLE BUILDING CODE, ACI 318 AND ACI 301, LATEST

B. CONCRETE SHALL ATTAIN THE FOLLOWING 28 DAY COMPRESSIVE STRENGTHS PER ASTM A39.

C. VERIFY CONCRETE STRENGTHS WITH A MINIMUM OF ONE SET OF NINE 4X8-INCH COMPRESSION CYLINDERS, (3 @ 7 DAYS, 3 @ 28, 3 SPARE).

D. EXTERIOR CONCRETE SHALL BE AIR-ENTRAINED TO PROVIDE AN AIR CONTENT OF 6+/-1.5 PERCENT BY

# E. PROVIDE CLEAR DISTANCE TO OUTERMOST REINFORCING, UNO, AS FOLLOWS:

CONCRETE CAST AGAINST EARTH 3 INCHES

F. NON-SHRINK GROUT FOR COLUMNS BASE PLATES SHALL ATTAIN A 28 DAY COMPRESSIVE STRENGTH: F'c

G. REINFORCING STEEL SHALL CONFORM TO A615-GR60; MESH SHALL CONFORM TO ASTM A185 WITH MINIMUM LAPS OF 8 INCHES. PLACING PLANS AND SHOP FABRICATION DETAILS SHALL BE IN ACCORDANCE WITH "THE MANUAL OF STANDARD PRACTICE FOR DETAILING REINFORCED CONCRETE STRUCTURES". FURNISH SUPPORT BARS AND ACCESSORIES IN ACCORDANCE WITH C.R.S.I. STANDARDS.

# STEEL

A. STEEL CONSTRUCTION SHALL BE CONSTRUCTED IN ACCORDANCE WITH THE APPLICABLE BUILDING CODE AND SHALL CONFORM TO AISC 360. STRUCTURAL STEEL SHALL CONFORM TO THE FOLLOWING ASTM STANDARDS:

STEEL PLATES AND ANGLES STRUCTURAL RECT/ROUND (HSS) ANCHOR RODS (3/4" DIAM. OR LESS)

HIGH-STRENGTH BOLTS

A572 GRADE 50 A500 - GR C F1554 - 36 KSI

= 850 PSI FOR SINGLE MEMBER USE

B. WELDING OF STRUCTURAL STEEL SHALL BE WITH E70XX ELECTRODES.

# WOOD FRAMING

A. FRAMING LUMBER FOR STUDS, HEADERS AND JOISTS SHALL BE HEM FIR (HF) #2, SPRUCE-PINE-FIR (SPF) #1/#2, OR BETTER, WITH A MAXIMUM MOISTURE CONTENT OF 19-PERCENT, HAVING THE FOLLOWING MINIMUM PROPERTIES (BASED ON 2X12 MEMBERS):

BENDING STRESS "Fb" HORIZONTAL SHEAR "Fv" COMPRESSION PERPENDICULAR TO GRAIN "Fc" = 405 PSI COMPRESSION PARALLEL TO GRAIN "Fc11" MODULUS OF ELASTICITY "E"

= 1150 PSI = 1,300,000 PSI

NOTES: SPF (SOUTH) IS NOT ACCEPTABLE.

COMPRESSION PARALLEL TO GRAIN "Fc11"

B. ALL EXPOSED EXTERIOR FRAMING AND FRAMING IN CONTACT WITH MASONRY OR CONCRETE SHALL BE PRESSURE-TREATED (PT). FRAMING SHALL BE PRESSURE-TREATED WITH ALAKALINE COPPER QUAT (ACQ) OR COPPER AZOLE (CBA-A AND CA-B), NOT SODIUM BORATE (SBX). PT LUMBER SHALL NOT BE

C. TREATED LUMBER (PT) SHALL BE SOUTHERN PINE (SP) #2 OR BETTER, HAVING THE FOLLOWING MINIMUM PROPERTIES (BASED ON 2X12 MEMBERS):

BENDING STRESS "Fb" HORIZONTAL SHEAR "Fv"

MODULUS OF ELASTICITY "E"

= 750 PSI SINGLE MEMBER USE = 175 PSI COMPRESSION PERPENDICULAR TO GRAIN "Fc" = 565 PSI = 1,250 PSI

= 1,400,000 PSI

D. PREFABRICATED JOIST HANGERS, BEAM HANGERS, POST CAPS, AND POST BASES SHALL BE SIZED AND ATTACHED PER MANUFACTURER'S RECOMMENDATIONS, TO ACHIEVE AT LEAST THE MINIMUM MANUFACTURER LISTED CAPACITIES, UNO ON THE DRAWINGS. FASTENERS AND CONNECTORS UTILIZED WITH TREATED LUMBER (PT) SHALL MEET G185 HOT-DIPPED GALVANIZING. FASTENERS AND CONNECTORS UTILIZED WITH FIRE-RETARDANT TREATED LUMBER (FRT) SHALL MEET G90 HOT-DIPPED

E. ANCHOR BOLTS CONNECTING PRESSURE-TREATED WOOD PLATES TO FOUNDATIONS, MASONRY WALLS, OR CONCRETE SLABS SHALL BE HOT-DIPPED GALVANIZED.

F. ALL BOLTED CONNECTIONS, INCLUDING SILL ANCHOR BOLTS, THRU BOLTS AND LAGS SHALL HAVE A STANDARD CUT METAL WASHER BETWEEN THE WOOD MEMBER AND NUT, UNLESS A LARGER PLATE WASHER OR OTHER IS NOTED ON THE DRAWINGS.

G. NAILS FOR FRAMING AND SHEATHING CONNECTIONS SPECIFIED IN THE DRAWINGS AND ASSOCIATED NOTES SHALL CONFORM TO ASTM F1667 AND SHALL MEET THE FOLLOWING MINIMUM SIZE REQUIREMENTS:

TYPE DIAMETER x LENGTH 0.131" x 2-1/2"

0.148" x 3" 0.148" x 3-1/4" 0.162" x 3-1/2" 0.192" x 4" MINIMUM STRENGTH SHANK DIAMETER

BUILDING CODE.

0.099" TO 0.142" 100 KSI 90 KSI 0.143" TO 0.177" 0.178" TO 0.254" 80 KSI NOTE: NAILS USED IN STANDARD CONNECTIONS SHALL BE SIZED PER THE REQUIREMENTS OF THE H. ROOF MEMBERS SHALL BE CONNECTED AT EACH BEARING POINT WITH ONE PREFABRICATED GALVANIZED METAL ANCHOR. ANCHORS SHALL BE 18 GAGE MINIMUM AND SHALL BE ATTACHED TO HAVE A CAPACITY TO RESIST A 450# UPLIFT LOADING, UNLESS SHOWN OTHERWISE ON DRAWINGS.

I. DO NOT SPLICE STRUCTURAL MEMBERS BETWEEN SUPPORTS.

7. POST-INSTALLED ANCHORS IN CONCRETE AND MASONRY

## A. GENERAL

INSTALL ANCHORS IN STRICT CONFORMANCE WITH THE MANUFACTURER'S PUBLISHED INSTALLATION INSTRUCTIONS AND PROCEDURES. ALL POST-INSTALLED ANCHORS IN CONCRETE SHALL HAVE ICC APPROVAL FOR USE IN CRACKED CONCRETE.

SUBSTITUTION REQUESTS FOR ALTERNATE PRODUCTS MUST BE SUBMITTED FOR APPROVAL PRIOR TO USE. CONTRACTOR SHALL PROVIDE LOAD CAPACITIES DEMONSTRATING THAT THE SUBSTITUTED PRODUCT IS CAPABLE OF ACHIEVING THE PERFORMANCE VALUES OF THE SPECIFIED PRODUCT.

PROVIDE STAINLESS STEEL FASTENERS FOR EXTERIOR USE OR WHEN PERMANENTLY EXPOSED TO WEATHER. PROVIDE GALVANIZED CARBON STEEL ANCHORS AT OTHER LOCATIONS, UNLESS OTHERWISE NOTED.

### B. PRODUCTS

ANCHORS IN CONCRETE --EXPANSION ANCHORS SHALL BE HILTI KWIK BOLT TZ2. --UNDERCUT ANCHORS SHALL BE HILTI HDA-P.

-- SCREW ANCHORS SHALL BE HILTI KWIK HUS EZ. --ADHESIVE ANCHORS SHALL BE HILTI HIT-HY 200 SAFE SET SYSTEM WITH HILTI HIT-Z ROD OR WITH HILTI HOLLOW DRILL BIT SYSTEM WITH HAS-E THREADED ROD.

ANCHORS IN MASONRY: --EXPANSION ANCHORS SHALL BE HILTI KWIK BOLT TZ2. GROUT MASONRY CELLS SOLID WITH 2000 PSI GROUT AT ANCHOR LOCATIONS. --SCREW ANCHORS SHALL BE HILTI KWIK HUS EZ. GROUT MASONRY CELLS SOLID WITH 2000 PSI GROUT AT ANCHOR LOCATIONS.

--ADHESIVE ANCHORS IN SOLID MASONRY SHALL BE HILTI HIT-HY 270 ADHESIVE ANCHORING

SYSTEM. STEEL ANCHOR ELEMENT SHALL BE HILTI HAS-E CONTINUOUSLY THREADED

ROD OR HILTI HIS-N INTERNALLY THREADED INSERT. --ADHESIVE ANCHORS IN HOLLOW OR MULTI-WYTHE MASONRY SHALL BE HILTI HIT-HY 270 ADHESIVE ANCHORING SYSTEM. STEEL ANCHOR ELEMENT SHALL BE HILTI HAS-E CONTINUOUSLY THREADED ROD OR HILTI HIT-IC INTERNALLY THREADED INSERT. THE APPROPRIATE SIZE SCREEN TUBE SHALL BE USED PER THE ADHESIVE MANUFACTURER'S RECOMMENDATION.

SUBSTITUTIONS: SUBSTITUTIONS FOR THE SPECIFIED ANCHORS SHALL BE SUBMITTED AS REQUESTED ABOVE. FOR ADHESIVE ANCHORS, PROPOSED SUBSTITUTE PRODUCTS SHALL INCLUDE THE FOLLOWING BASIS

OF DESIGN PARAMETERS: ANCHORS IN CONCRETE: -CRACKED CONCRETE

ADHESIVE ANCHORS IN CONCRETE:

-CRACKED CONCRETE -WATER SATURATED CONCRETE

DEGREES FAHRENHEIT (SHORT TERM)

-BASE MATERIAL TEMPERATURE OF 50-100 DEGREES FAHRENHEIT (AT INSTALLATION). -BASE MATERIAL IN-SERVICE TEMPERATURE OF 110 DEGREES FAHRENHEIT (LONG TERM), 130 DEGREES FAHRENHEIT (SHORT TERM)

ADHESIVE ANCHORS IN MASONRY: -BASE MATERIAL TEMPERATURE OF 50-100 DEGREES FAHRENHEIT (AT INSTALLATION). -BASE MATERIAL IN-SERVICE TEMPERATURE OF 110 DEGREES FAHRENHEIT (LONG TERM), 130

#### C. INSTALLATION

ALL INSTALLATION PROCEDURES SHALL BE PER MANUFACTURERS RECOMMENDATIONS. COORDINATE AND/OR PROVIDE FOR THIRD PARTY INSPECTION AS REQUIRED BY BUILDING CODE OR LOCAL JURISDICTION.

ANCHOR CAPACITY IS DEPENDENT UPON SPACING BETWEEN ADJACENT ANCHORS AND PROXIMITY OF ANCHOR TO EDGE OF CONCRETE OR MASONRY. INSTALL ANCHORS IN ACCORDANCE WITH SPACING AND EDGE DISTANCE INDICATED ON THE DRAWINGS: IF NOT SHOWN, COMPLY WITH MINIMUM SPACING AND EDGE DISTANCE FOR FULL ANCHOR CAPACITY, AS SPECIFIED BY MANUFACTURER.


EXISTING REINFORCING BARS IN THE CONCRETE OR MASONRY STRUCTURE MAY CONFLICT WITH SPECIFIC ANCHOR LOCATIONS. DO NOT CUT OR DAMAGE REINFORCING BARS UNLESS SPECIFICALLY PERMITTED IN THE DRAWINGS.

PRIOR TO DRILLING, THE CONTRACTOR SHALL LOCATE REINFORCING BAR POSITIONS IN THE IMMEDIATE VICINITY OF PROPOSED POST-INSTALLED ANCHORS USING GPR, X-RAY, OR OTHER NON-DESTRUCTIVE MEANS.

WHEN CONFLICTS BETWEEN PROPOSED ANCHORS AND EXISTING REINFORCING BARS EXIST, SUBMIT RESULTS OF BAR LOCATIONS TO ARCHITECT / ENGINEER FOR REVIEW AND FURTHER DIRECTION.


WARNING: THE STRUCTURAL INTEGRITY OF THE BUILDING SHOWN ON THESE PLANS IS DEPENDENT UPON COMPLETION ACCORDING TO PLANS AND SPECIFICATIONS. STRUCTURAL MEMBERS ARE NOT SELF-BRACING UNTIL PERMANENTLY AFFIXED TO THE STRUCTURE. THE STRUCTURAL ENGINEERS ASSUME NO LIABILITY FOR THE STRUCTURE DURING CONSTRUCTION.



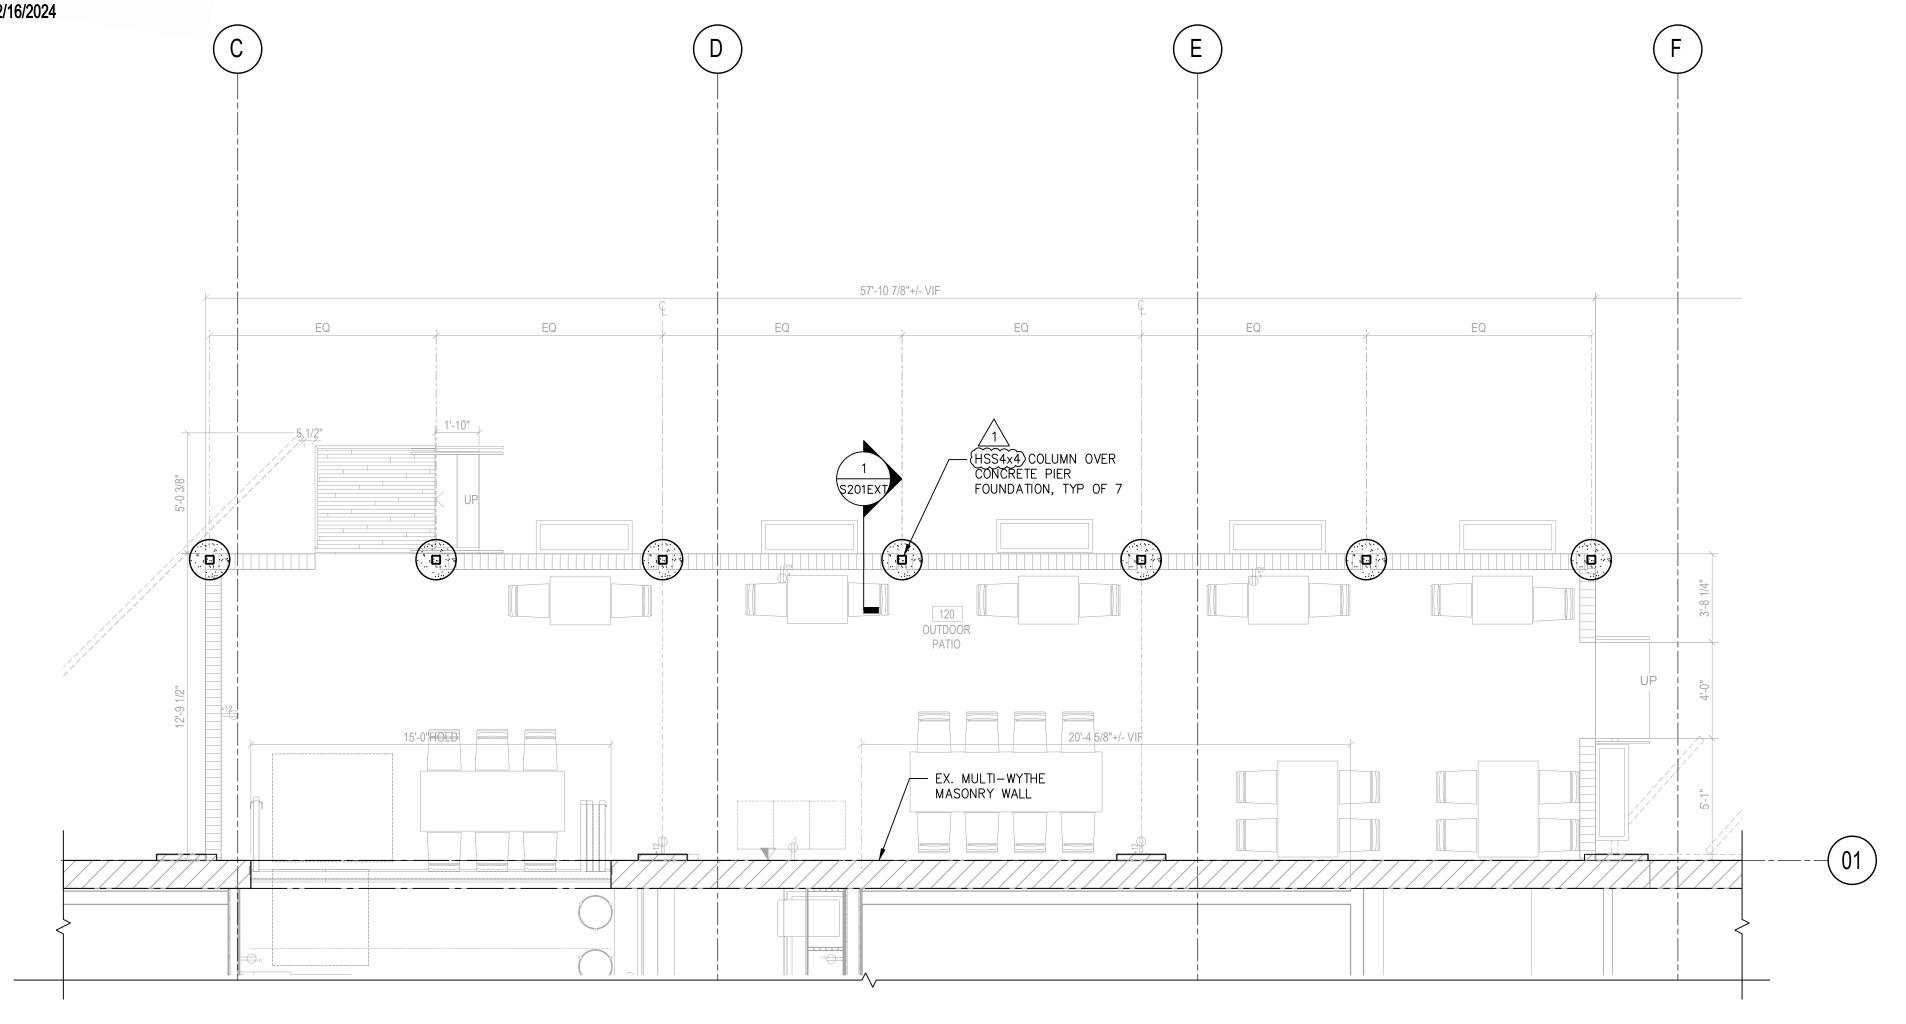

# PARTIAL FOUNDATION PLAN

SCALE: 1/4" = 1'-0"

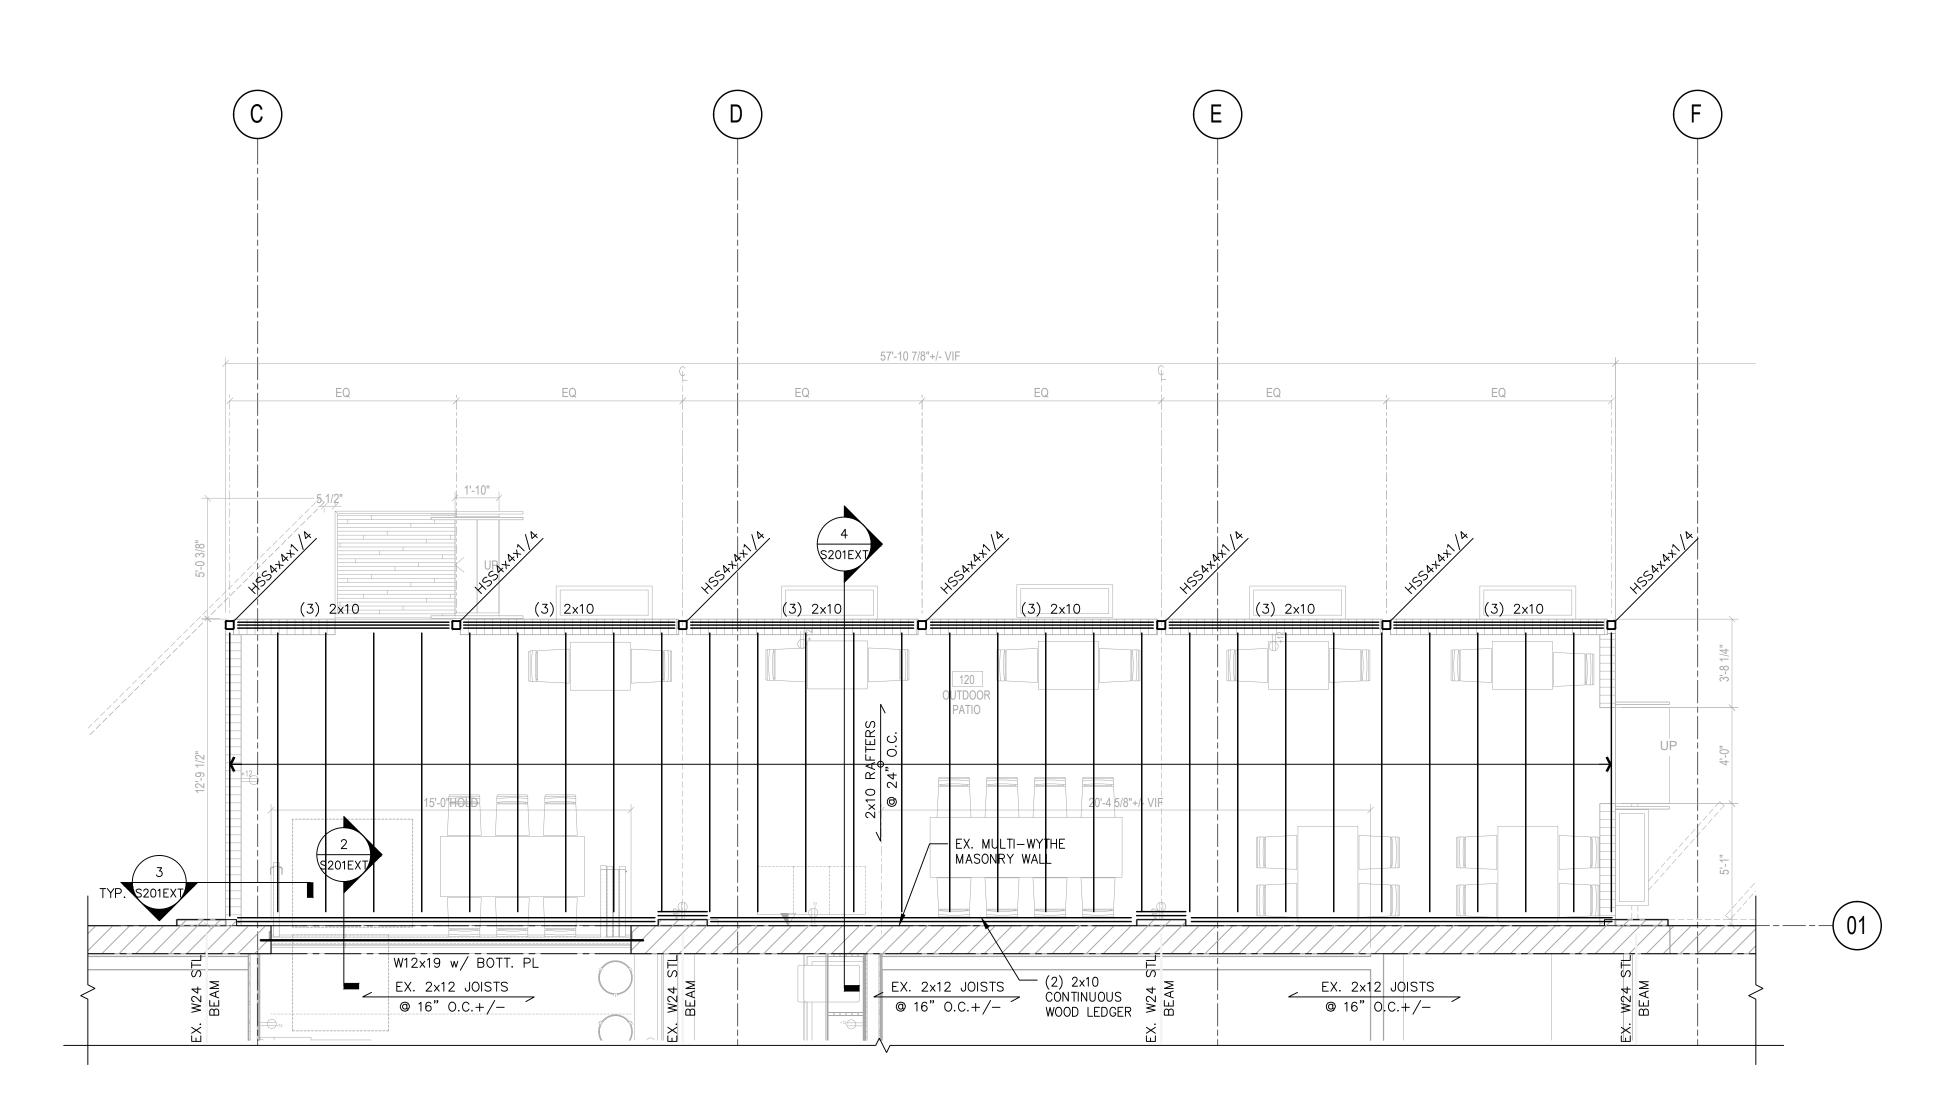

PARTIAL FRAMING PLAN SCALE: 1/4" = 1'-0"SEE ARCH FOR STEEL COATING REQUIREMENTS FOR DURABILITY.

> EHLERT BRYAN 8609 Westwood Center Drive, Sullo 844 Tysons, VA 22182 (703) 827-9552 Fax (703) 356-2031 www.ehlert-bryan.com

w w w . 3 8 7 7 . d e s i g n

COPYRIGHT NOTICE:

BAKER'S BREAD LLC

STUDIO3877 EXPRESSLY RESERVES ITS COMMON LAW COPYRIGHT AND OTHER PROPERTY RIGHTS TO THESE PLANS. THESE PLANS ARE NOT TO BE REPRODUCED, CHANGED, OR COPIED IN ANY FORM OR MANNER WHATSOEVER, NOR ARE THEY TO BE ASSIGNED TO ANY THIRD PARTY WITHOUT OBTAINING THE EXPRESS WRITTEN PERMISSION AND CONSENT OF STUDIO3877.

> NOE LANDINI 115 KING STREET ALEXANDIRA, VA 22314 **GENERAL CONTRACTOR** TECH 24 VIC BONOMI 5256 EISENHOWER AVE ALEXANDRIA, VA 22304 [T] 571.233.8585 [W] WWW.TECH24CONSTRUCTION.COM 3333 K STREET NW, SUITE 60 WASHINGTON DC 20007 [T] 202.350.4244 [W] WWW.3877.DESIGN **BUILT ENVIRONMENT ENGINEERS** 6861 ELM STREET SUITE 2D MCLEAN, VA 22101 TT 703.888.0649 [W] WWW.BEENGRS.COM

SINGER EQUIPMENT COMPANY 180 HELLER PLACE BELLMAWR, NJ 08031 TT 646-702-9922



# **ISSUED FOR PERMIT**

DRAWING DATA

**JUNCTION BAKERY -ALEXANDRIA** 

**1508 MT VERNON AVENUE ALEXANDRIA, VA 22301** 

SHEET SUBMISSION INDEX

REVISION 1 EXTERIOR STRUCTURAL REVISION 06/19/2023


SIGNATURE:





ENTER PROFESSIONAL CERTIFICATION TEXT HERE THAT IS REQUIRED FOR THE JURISDICTION WHERE DRAWINGS WILL BE SUBMITTED.

SHEET TITLE: STRUCTURAL NOTES, PARTIAL FOUNDATION AND FRAMING PLANS PROJECT NO: 2020.72 DATE ISSUED: 06/19/23

SCALE: As indicated

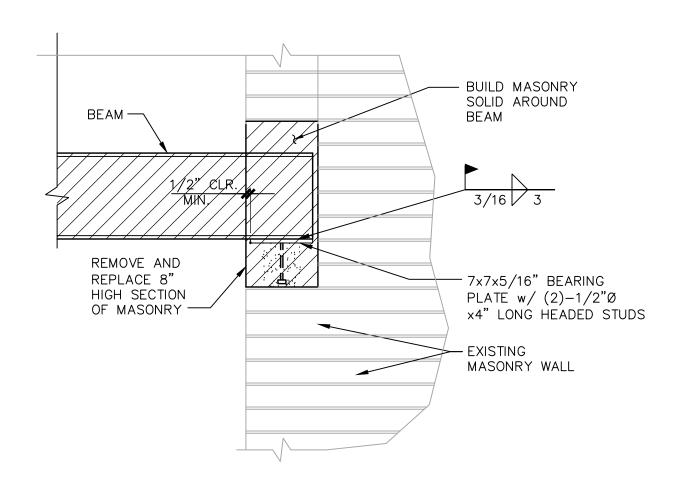


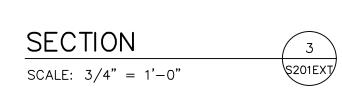


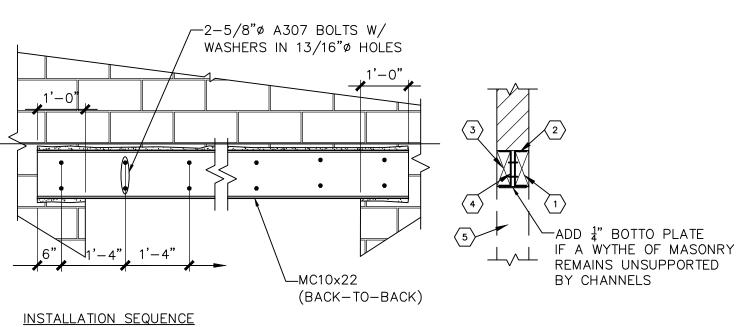


- REMOVE 4" WYTHE OF MASONRY FOR FULL LENGTH OF OPENING + SUPPORT LENGTH.
- (2) INSTALL STEEL CHANNEL AND MORTAR TIGHT TO BRICK ABOVE AND BELOW BEARING AT END. CURE 2 DAYS.
- REMOVE REMAINING 4" WYTHE AND INSTALL SECOND CHANNEL ALIGNING HOLES WITH FIRST CHANNEL.
- 4 BOLT TO FIRST CHANNEL & MORTAR INTO PLACE.
- (5) SAWCUT & REMOVE REMAINDER OF WALL. REPOINT BRICK @ EDGE.

ALTERNATE LINTEL INSTALLATION IN EXISTING WALL

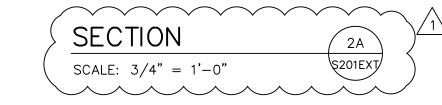

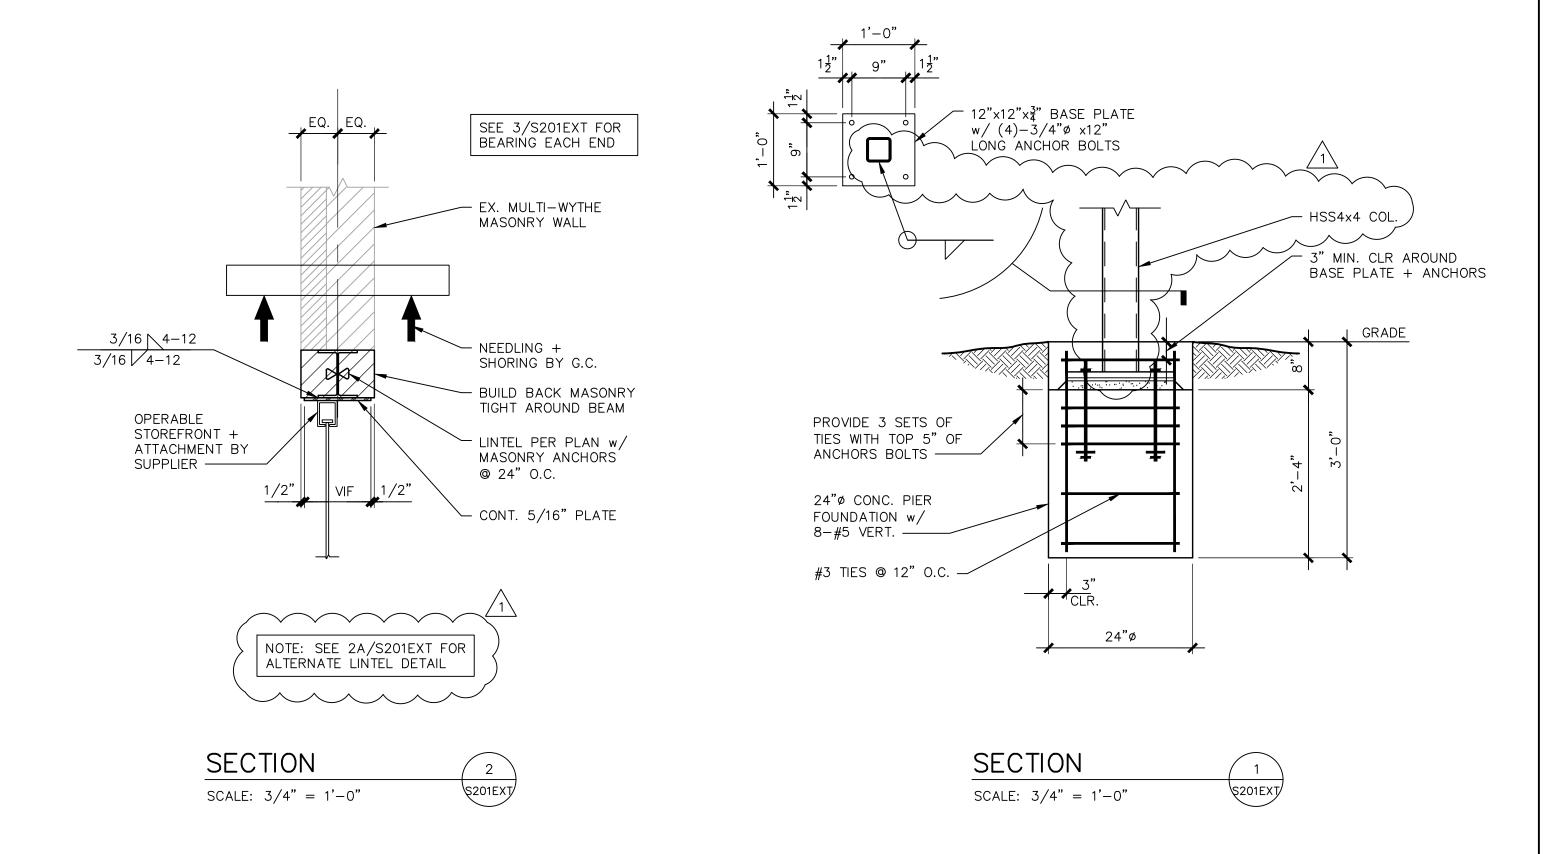

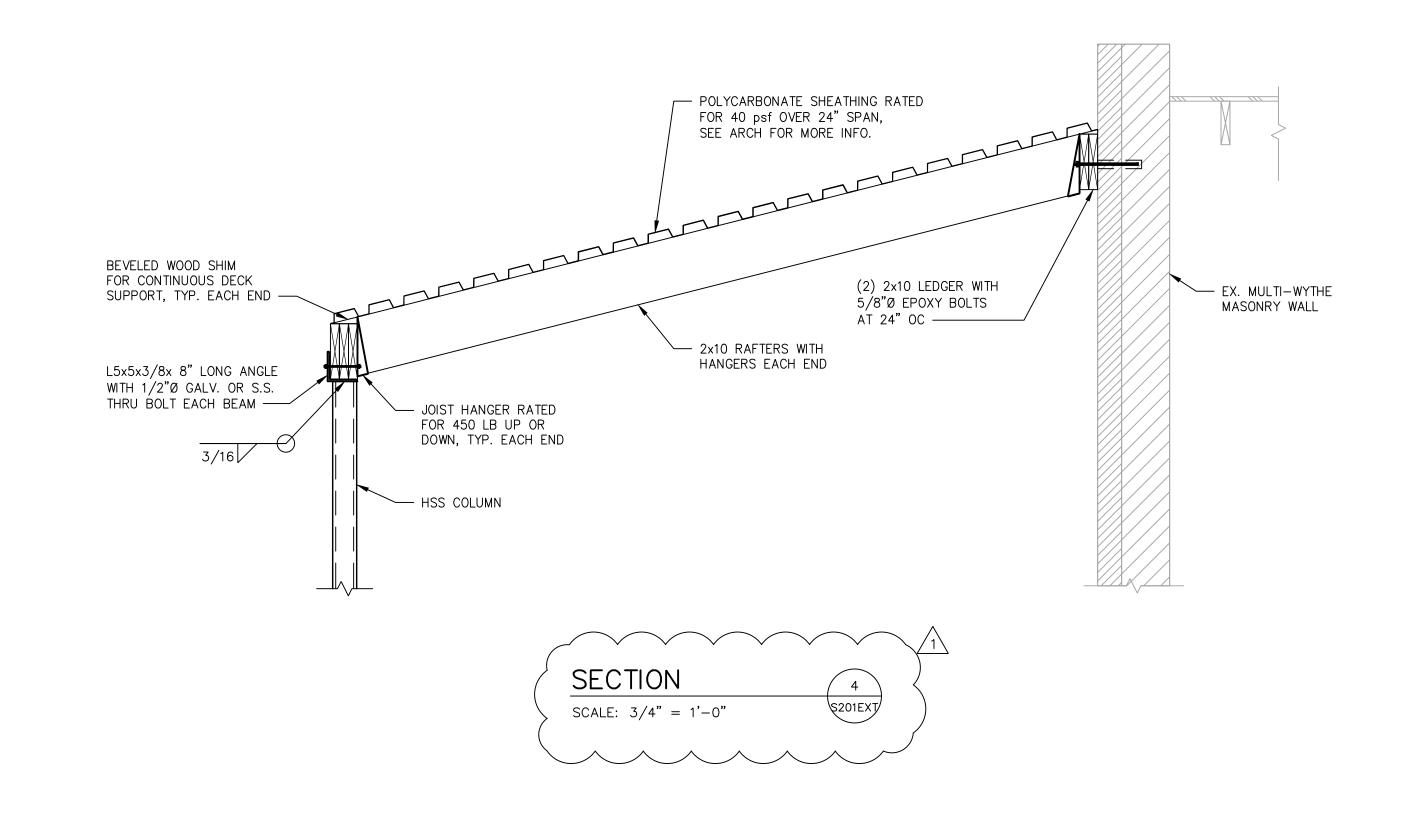



COPYRIGHT NOTICE:

STUDIO3877 EXPRESSLY RESERVES ITS COMMON LAW COPYRIGHT AND OTHER PROPERTY RIGHTS TO THESE PLANS. THESE PLANS ARE NOT TO BE REPRODUCED, CHANGED, OR COPIED IN ANY FORM OR MANNER WHATSOEVER, NOR ARE THEY TO BE ASSIGNED TO ANY THIRD PARTY WITHOUT OBTAINING THE EXPRESS WRITTEN PERMISSION AND CONSENT OF STUDIO3877.

OWNER:
BAKER'S BREAD LLC
NOE LANDINI
115 KING STREET
ALEXANDIRA, VA 22314
GENERAL CONTRACTOR:
TECH 24
VIC BONOMI
5256 EISENHOWER AVE
ALEXANDRIA, VA 22304
[T] 571.233.8585
[W] WWW.TECH24CONSTRU

[T] 571.233.8585
[W] WWW.TECH24CONSTRUCTION.COM
ARCHITECT:
//3877
3333 K STREET NW, SUITE 60
WASHINGTON DC 20007
[T] 202.350.4244
[W] WWW.3877.DESIGN

MEP ENGINEER:
BUILT ENVIRONMENT ENGINEERS
6861 ELM STREET
SUITE 2D
MCLEAN, VA 22101
[T] 703.888.0649
[W] WWW.BEENGRS.COM

FOOD SERVICE:
SINGER EQUIPMENT COMPANY
JAMES FEUSTEL
180 HELLER PLACE
BELLMAWR, NJ 08031
[T] 646-702-9922
[W] WWW.SINGEREQUIPMENT.COM



# **ISSUED FOR PERMIT**

DRAWING DATA

JUNCTION BAKERY - ALEXANDRIA

1508 MT VERNON AVENUE ALEXANDRIA, VA 22301

SHEET SUBMISSION INDEX

DATE

1 EXTERIOR STRUCTURAL REVISION 06/19/2023

REVISION

SEAL & SIGNATURE:



ENTER PROFESSIONAL CERTIFICATION TEXT HERE THAT IS REQUIRED FOR THE JURISDICTION WHERE DRAWINGS WILL BE SUBMITTED.


SHEET TITLE: FRAMING SECTIONS

PROJECT NO: 2020.72

DATE ISSUED: 06/19/23

SCALE: As indicated

S201FXT

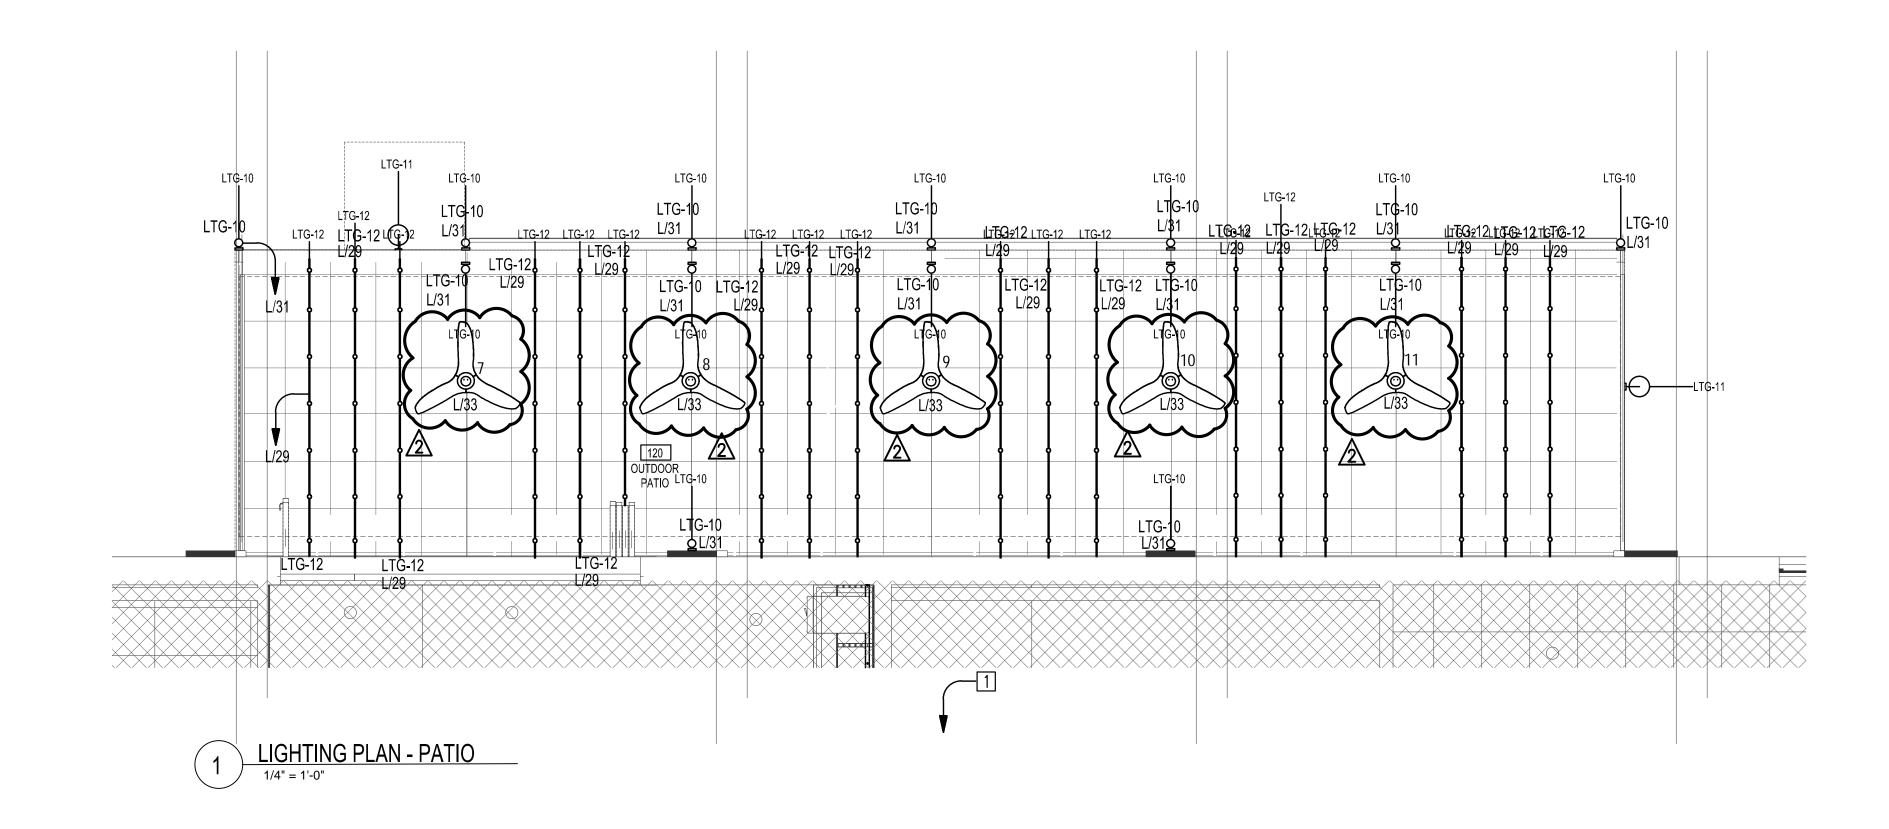


# **GENERAL NOTES:**

- A. REFER TO ARCHITECTURAL PLANS, DETAILS, AND ELEVATIONS FOR LOCATIONS, MOUNTING HEIGHTS, AND FINISHES FOR ALL LIGHTING FIXTURES.
- B. PROVIDE CONDUIT, WIRE, SWITCHES, RELAYS, POWER PACKS, ETC. FOR A COMPLETE LIGHTING INSTALLATION AS DEFINED ON PLANS.
- C. FIELD COORDINATE EXACT ROUTING OF ALL NEW FEEDERS AND BRANCH CIRCUITS.
- D. LIGHTING CONTROL DEVICE MANUFACTURER TO VERIFY ALL INFORMATION INDICATED ON THIS PLAN, AND MODIFY DEVICE TYPE AND LAYOUT AS NEEDED FOR A COMPLETE FUNCTIONAL LIGHTING CONTROL SYSTEM.
- E. ALL LUMINARIES FINISHES TO BE CONFIRMED BY ARCHITECT.
- F. ALL LUMINARIES TO BE UL LISTED FOR THE INTENDED USES.
- G. ALL EXIT SIGNS ARE EQUIPPED WITH 2 HR BATTERY PACK. CONNECT TO NEAREST LIGHTING CIRCUIT AHEAD OF SWITCHED LEG.
- H. ALL EXTERIOR LIGHTING SHALL BE CONTROLLED BY ASTRONOMICAL TIMECLOCK AND PHOTOCELL.
- K. ALL EXTERIOR LIGHT FIXTURES TIME CLOCK SHOULD BE PROGRAMMED TO SHUT OFF FROM 12 MIDNIGHT OR WITHIN ONE (1) HOUR OF THE END OF BUSINESS OPERATIONS, WHICHEVER IS LATER, UNTIL 6 A.M. OR BUSINESS OPENING, WHICHEVER IS EARLIER.

THE INTERIOR BY THE BAR. COORDINATE CONTROL SWITCH LOCATIONS WITH THE ARCHITECT.

			LIGHTING FIXTURE SCH	EDULE - EXTER	IOR	
TYPE	DESCRIPTION	MANUFACTURER	MODEL	FINISH	LAMPING	COMMENTS
ΓG-10	EXTERIOR CYLINDER SCONCE	REJUVENATION OR APPROVED	THORBURN NARROW WALL SCONCE #A7004, WET RATED	DARK ALUMINUM	5W LED	FIXTURE TO BE DIMMABLE AND HARDWIRED. PROVIDE ALL PARTS AND ACCESSORIES FOR COMPLETE INSTALLATION
G-11	EXTERIOR CAGE LIGHT SCONCE	SCHOOLHOUSE LIGHTING OR APPROVED ALTERNATIVE	FACTORY 4 OUTDOOR SCONCE, WET RATED. PROVIDE CAGE	BLACK BK	MAX WATTAGE 100W, LED LAMP TBD	FIXTURE TO BE DIMMABLE AND HARDWIRED. PROVIDE ALL PARTS AND ACCESSORIES FOR COMPLETE INSTALLATION.
<del>16-12</del>	STRING LIGHTS		CS/CS2 SERIES, NON-SUSPENDED E26 STRING LIGHTS 24 O.C. SOCKETS, WET RATED. FIXTURE IS CUTTABLE IN FIELD.	BLACK	1W LED PER SOCKET	FIXTURE TO BE DIMMABLE AND HARDWIRED. PROVIDE ALL PARTS AND ACCESSORIES FOR COMPLETE INSTALLATION. GC TO VERIFY LENGTHS IN FIELD PRIOR TO ORDERING FIXTURE.

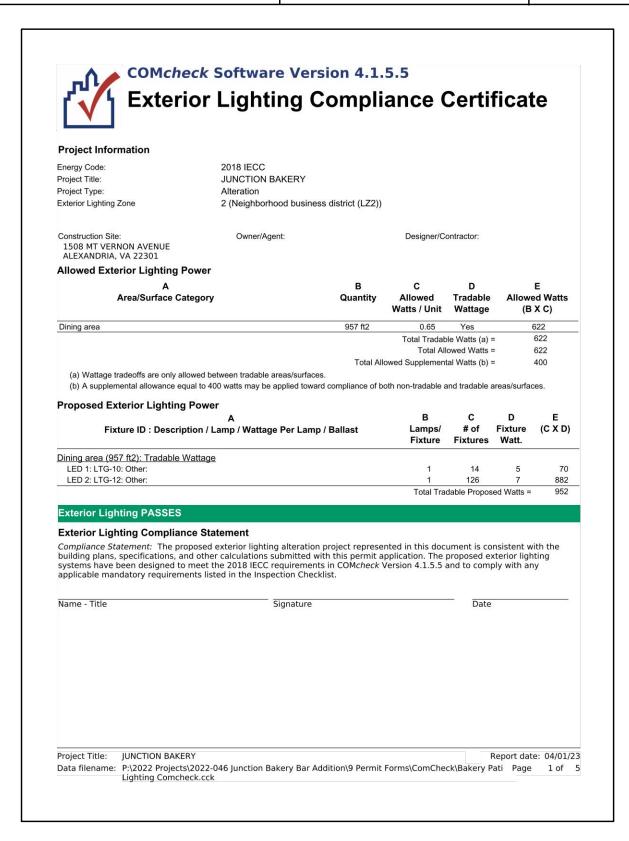

# w w w . 3 8 7 7 . d e s i g n

COPYRIGHT NOTICE:

STUDIO3877 EXPRESSLY RESERVES ITS COMMON LAW COPYRIGHT AND OTHER PROPERTY RIGHTS TO THESE PLANS. THESE PLANS ARE NOT TO BE REPRODUCED, CHANGED, OR COPIED IN ANY FORM OR MANNER WHATSOEVER, NOR ARE THEY TO BE ASSIGNED TO ANY THIRD PARTY WITHOUT OBTAINING THE EXPRESS WRITTEN PERMISSION AND CONSENT OF STUDIO3877.

OWNER : BAKER'S BREAD LLC NOE LANDINI 115 KING STREET ALEXANDIRA, VA 22314 GENERAL CONTRACTOR : 5256 EISENHOWER AVE ALEXANDRIA, VA 22304 [T] 571.233.8585

[W] WWW.TECH24CONSTRUCTION.COM 3333 K STREET NW, SUITE 60

WASHINGTON DC 20007 [T] 202.350.4244 [W] WWW.3877.DESIGN BUILT ENVIRONMENT ENGINEERS

6861 ELM STREET MCLEAN, VA 22101 [T] 703.888.0649

[W] WWW.BEENGRS.COM SINGER EQUIPMENT COMPANY JAMES FEUSTEL 180 HELLER PLACE



**ISSUED FOR PERMIT** 

DRAWING DATA

PROJECT: JUNCTION BAKERY -ALEXANDRIA

ADDRESS: 1508 MT VERNON AVENUE ALEXANDRIA, VA 22301

SHEET SUBMISSION INDEX INTERIOR PERMIT - 3.31.2023

EXTERIOR PERMIT - 3.31.2023

REV NO. REVISION DATE EXTERIOR PERMIT REVISIONS 31 JULY 2023

SIGNATURE:



ENTER PROFESSIONAL CERTIFICATION TEXT HERE THAT IS REQUIRED FOR THE JURISDICTION WHERE DRAWINGS WILL BE SUBMITTED.


SHEET TITLE: LIGHTING PLAN


PROJECT NO: 2022-46 DATE ISSUED: 03/31/23

SCALE: As indicated

EXTE-101



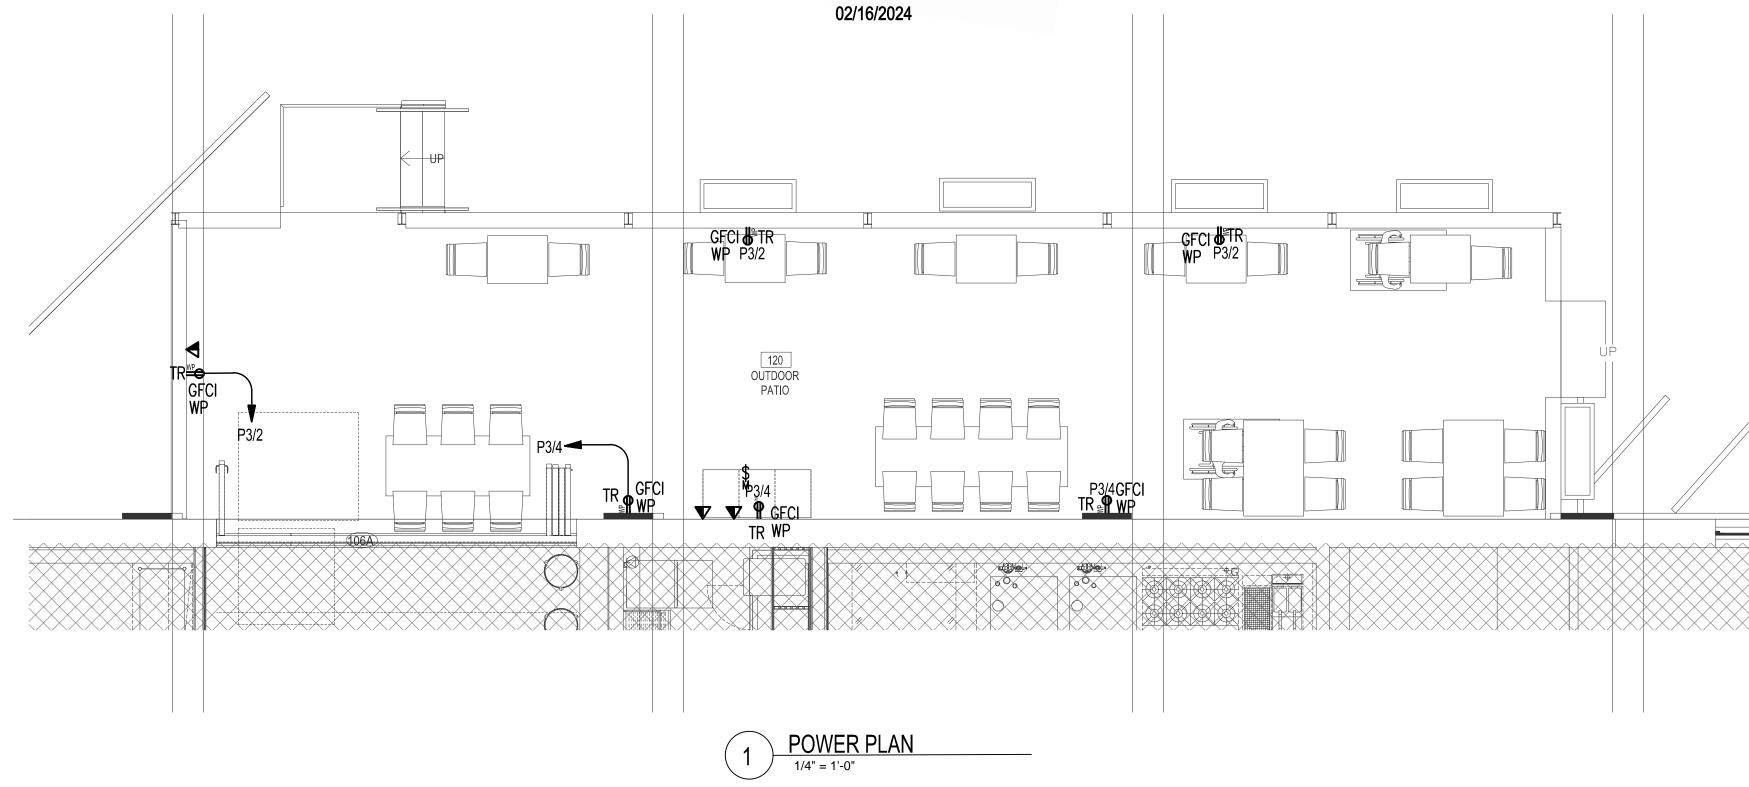

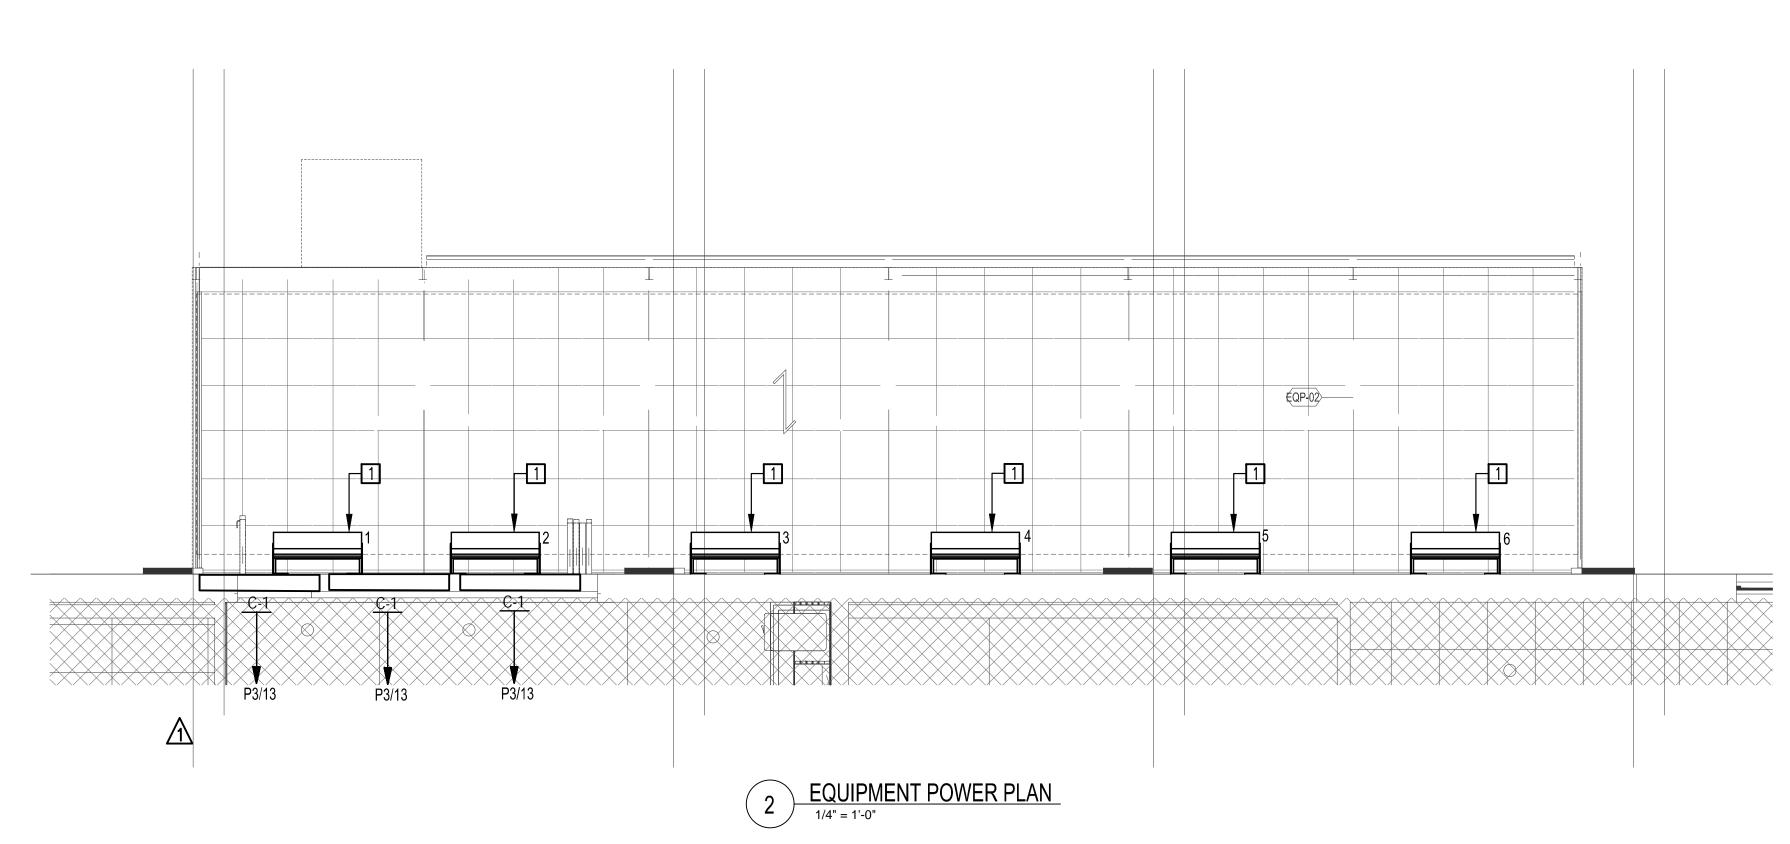

			EQUIPMENT SCHEDULE - EX	TERIOR		
Type Mark	Description	Manufacturer	Model	Finish	Comments	
EQP-01	OUTDOOR WALL HEATERS	SCHWANK	2152-N		GC TO PROVIDE: (6) TWO STAGE HEATERS, 30 DEGREE MOUNTING BRACKET; (2) JM-0203-TS 3-GANG SCHWANK 2-STAGE SWITCHES, (ADJACENT TO LIGHTING CONTROLS); (1) MULTI MOUNT 150VA TRANSFORMER FOR ALL 6 HEATERS - MOUNTEI WITHIN THE SPACE IN A CONCEALED, DRY AND VENTILATED LOCATION. CONTACT ERIC KAHN FOR PURCHASE: 415-884-2880 ERIC@ALFRESCO-HEATING.COM	)
EQP-02	Haiku 60In Dia	Big Ass Fans	60" inch MK-HK-4-05-2506-A258-F258. OMIT LIGHTS, COORDINATE DOWNROD ATTACHMENT WITH SLOPED CEILING. COORDINATE CONTROL SPEC WITH OWNER AND INCLUDE IN PURCHASE.		PROVIDE ALL PARTS AND PIECES REQUIRED FOR FULL AND COMPLETE INSTALLATION. PROVIDE STABILIZER KIT.	

			AIR (	CURTAIN SCHEDULE			
Type Mark	CFM	HP	MCA	Dimensions (HxLxW)	MOP	Weight (LBS)	Basis of Design (BERNER)
C-1	1680	1/5	1.7	7.5" x 61" x 13.6"	15	57	ALC08-1060A

1. ELECTRICAL BASED IN 208V/1PH/60HZ

**GENERAL NOTES:** 

A. REFER TO ARCHITECTURAL AND KITCHEN PLANS, DETAILS, AND ELEVATIONS FOR LOCATIONS, MOUNTING HEIGHTS, AND FINISHES FOR ALL

ELECTRICAL DEVICES. B. PROVIDE CONDUIT, WIRE, OVERCURRENT PROTECTION, ETC. FOR COMPLETE ELECTRICAL DEVICE INSTALLATION AS DEFINED ON PLANS.

C. FIELD COORDINATE EXACT ROUTING OF ALL NEW FEEDERS AND BRANCH CIRCUITS.

THE INTERIOR BY THE BAR. COORDINATE CONTROL SWITCH LOCATIONS WITH THE ARCHITECT.

w w w . 3 8 7 7 . d e s i g n

COPYRIGHT NOTICE:

STUDIO3877 EXPRESSLY RESERVES ITS COMMON LAW COPYRIGHT AND OTHER PROPERTY RIGHTS TO THESE PLANS. THESE PLANS ARE NOT TO BE REPRODUCED, CHANGED, OR COPIED IN ANY FORM OR MANNER WHATSOEVER, NOR ARE THEY TO BE ASSIGNED TO ANY THIRD PARTY WITHOUT OBTAINING THE EXPRESS WRITTEN PERMISSION AND CONSENT OF STUDIO3877.


OWNER : BAKER'S BREAD LLC NOE LANDINI 115 KING STREET ALEXANDIRA, VA 22314 GENERAL CONTRACTOR : 5256 EISENHOWER AVE ALEXANDRIA, VA 22304

[T] 571.233.8585 [W] WWW.TECH24CONSTRUCTION.COM

3333 K STREET NW, SUITE 60 WASHINGTON DC 20007 [T] 202.350.4244 [W] WWW.3877.DESIGN

BUILT ENVIRONMENT ENGINEERS 6861 ELM STREET SUITE 2D MCLEAN, VA 22101 [T] 703.888.0649

[W] WWW.BEENGRS.COM SINGER EQUIPMENT COMPANY JAMES FEUSTEL 180 HELLER PLACE

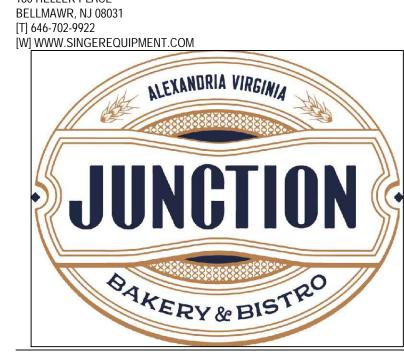

**ISSUED FOR PERMIT** 

DRAWING DATA

PROJECT: JUNCTION BAKERY -ALEXANDRIA

ADDRESS: 1508 MT VERNON AVENUE ALEXANDRIA, VA 22301

SHEET SUBMISSION INDEX

INTERIOR PERMIT - 3.31.2023

 EXTERIOR PERMIT - 3.31.2023 PERMIT RESPONSE - 6.07.2023

REVISION

EXTERIOR PERMIT REVISIONS

31 JULY 2023

SIGNATURE:



ENTER PROFESSIONAL CERTIFICATION TEXT HERE THAT IS REQUIRED FOR THE JURISDICTION WHERE DRAWINGS WILL BE SUBMITTED.

SHEET TITLE: POWER PLAN

PROJECT NO: 2022-46 DATE ISSUED: 03/31/23

SCALE: As indicated

PAN	NELBOARD: MDP			FED FROM	1:		M OUN SURI	IΠNG: FACE	BUS AM		JG ONLY Y: 600A	VOLTAGE: 120/208V, 3P AIC RMS: 6	
T Y DI	DESCRIPTION	DEV.	C K			LOAD/PH	ASE (VA)			C K	DEV.	DESCRIPTION	Υ
E			T	Α	В	С	Α	В	С	T			E
			1	16200			5145			2			E
	Existing Panel "M"	200/3	3		16200			5145		4	100/3	Existing Panel "L"	E
			5			16200			5145	6			E
1			7	9000			12468			8			E
1	Existing RTU	150/3	9		9000			12468		10	200/3	Existing Panel "L1"	E
1			11			9000			12468	12			E
			13	22090						14			E
	Existing Panel "P1 & P2"	400/3	15		22090					16			
			17			22090	17,613	17,613		18			
	SUBTOTAL (VA)		47,290						17,613			SUBTOTAL (VA)	
	SUB-TOTAL ALL PHASES	(VA)		PHA		PHASE B		PHASE C				ARC-FAULT CIRCUIT BREAKER	
		()		64,903		64,903		64,903		.,		** GFCI CIRCUIT BREAKER	
245	D OLIMIA DV DV TVDE	1 00	SKIKIT.	OTT D	7	DEL	LAND	Ĭ		<u> </u>		CONNECTED LOAD OLIVIA DV	- i
	D SUMMARY BY TYPE		NNE	CTED	DE		IAND					CONNECTED LOAD SUMMARY	
₹	= RECEPTACLE = LIGHTING	0		VA VA			VA			10	194,709		_
_	DE LEGISTO	19/1	00	VA	167 700		V-2-4-1				<b>54</b> 0	AMPS	
	= EQUIPMENT	167,7	U9			167,709							
( /	= KITCHEN EQUIP = MOTOR	0		VA VA	-		VA VA					NEC LOAD SUMMARY	_
// (	THE REPORT OF THE PARTY OF THE			TO REAL PROPERTY.	-	100	VA				194,709	CONTROL OF THE CONTRO	-
PK.	= LARGEST MOTOR 0 VA = ELECTRIC HEAT 27,000 VA				U	V /TL				134,703	V /\		

PAN	ELBOARD: M			FED FROM	18 18		M OUN SURI	ITING:	MAIN BUS AM		225A/3P	VOLTAGE: 120/208V, 3PI AIC RMS: 10
T Y DE	SCRIPTION	DEV.	C K	IIIDI		LOAD/PH4	Video agranti	//OL	BOS AM	C K	DEV.	DESCRIPTION
P E		DLV.	T	Α	В	С	A	В	С	T	DLV.	BEGGIAI HOIV
VI	EXISTING EXHAUST FAN	20/2	1	300		Alto dia	1250		Adv. II	2	40/2	EXISTING WALK IN CU
M	EXISTING EXPAUST FAIN	2012	3	±	300		±	1250	, .	4	40/2	ENSTING WALK IN CO
М	EXISTING MAU	20/2	5			500			1000	6	20/2	FREEZER CU
VI	Externite in to	LorL	7	500			1000			8		Company for Contract
M			9		2000			750	s	10	20/1	EXISTING HEATE
M	EXISTING RTU-2	60/3	11	(A. 16)		2000	5-5016 (3-1)		1000	12	40/2	EXISTING LOAD
М			13	2000	70.0300		1000			14		
M.	EVICTING ETH	40010	15		3000	2000		1000	4000	16	30/2	EXISTING FREEZER
M	EXISTING RTU	100/3	17	0000		3000	500		1000	18	0014	EMOTING LIGHT
M		-	19	3000	40.00		500	500		20	20/1	EXISTING LIGHT
M.	EVIOTINIO ALIUI	2012	21		1000	750		500	540	22	20/1	EXISTING HEATE
VI VI	EXISTING AHU	30/3	23 25	1000		750	540	-	540	24 26	20/1	EXISTING RECEPTACLE EXISTING RECEPTACLE
M			27	1000	2000		340	540		28	20/1	EXISTING RECEPTABLE
M	EXISTING RTU	50/3	29		2000	2000		340		30	20/1	SPAR
VI VI	EXISTING KIO	3073	31	2000		2000		-	1	32	20/1	SPAR
H			33	2000	3000					34	20/1	SPAR
H	EXISTING DUCT HEATER	70/3	35		5000	3000				36	20/1	SPAR
H		,,,,	37	3000	£	5000		£	1	38	20/1	SPAF
TOTAL STREET	PACE		39		4			2	·	40	J-MAN	SPAC
N/2007	PACE		41							42		SPAC
ı	SUBTOTAL (VA)		1	11,800	11,300	11,250	4,290	4,040	3,540			SUBTOTAL (VA)
	OUR TOTAL ALL PUNCES A	7.4.5		PHA	SE A	PHA	SE B	PHA	SE C		* A	RC-FAULT CIRCUIT BREAKER
	SUB-TOTAL ALL PHASES (	/A)		16,090		15,340		14,790	)			** GFCI CIRCUIT BREAKER
OAD	SUMMARY BY TYPE	C	ONNE	CTED		DEM	IAND			11		CONNECTED LOAD SUMMARY
R	= RECEPTACLE	1,62	20	VA		1,620	VA				46,220	VA
L	= LIGHTING	500	0	VA		625	VA				128	AMPS
E	= EQUIPMENT	0		VA		0	VA					
<	= KITCHEN EQUIP	0		VA			VA					
M	= MOTOR	24,8	1000	VA		24,850	ALCO MANAGEMENT					NEC LOAD SUMMARY
Х	= LARGEST MOTOR	9,00		VA		11,250				i.	48,595	
H	= ELECTRIC HEAT	10,2	50	VA		10,250	VA				135	AMPS


PAN	ELBOA	RD: L			FED FROM	<b>M</b> :			NTING: FACE			JG ONLY	VOLTAGE: 120/208V, 3PH, 4)
т			<del></del>	-	MIDE			SURI	FACE	BUS AM	1	Y: 225A	AIC RMS: 10KA
Y DE	SCRIPTI	NO	DEV.	C			LOAD/PH	ASE (VA)			C K	DEV.	DESCRIPTION
P E				T	Α	В	С	Α	В	С	Ţ		DESCRIPTION I
L EX	STING L	IGHTS	20/1	1	600			800			2	20/1	EXISTING LIGHTS
L EX	ISTING L	IGHTS	20/1	3		300			600		4	20/1	EXISTING LIGHTS
L EX	(STING L	IGHTS	20/1	5			800			300	6	20/1	EXISTING LIGHTS
L EX	STING L	IGHTS	20/1	7	600			1200			8	20/1	EXISTING SIGNAGE
L EX	¶S∏NG L	IGHTS	20/1	9		600			1200		10	20/1	EXISTING SHOW WINDOW
L EX	(ISTING L	IGHTS	20/1	11			600	-		720	12	20/1	EXISTING RECEPTACLES
SF	PARE		20/1	13							14	20/1	SPARE
SF	PARE		20/1	15							16	20/1	SPARE
SF	PARE		20/1	17	8						18	20/1	SPARE
L EX	STING L	IGHTS	20/1	19	600						20	20/1	SPARE
L EX	STING L	IGHTS	20/1	21		600					22	20/1	SPARE
L LIG	GHTS		20/1	23		74.130	600				24	20/1	SPARE
L LIC	SHTS		20/1	25	850				*		26	20/1	SPARE
L LIG	GHTS		20/1	27		850	-			-	28	20/1	SPARE
L EX	TERIOR	LIGHTS	20/1	29			455				30	20/1	SPARE
	TANK		20M	<b>3</b> 1	<b>455</b>	<b>~</b>					32	20/1	SPARE
E PA	ATIO FAN	S	15/1	33		120					34	20/1	SPARE
<b>SE</b>	WSE !		<del>\</del>	25	<b>→</b>						36	20/1	SPARE
SF	ACE			37				45	(*)		38		SPACE
SF	PACE			39							40		SPACE
SF	PACE			41							42		SPACE
		SUBTOTAL (VA)	•		3,105	2,470	2,455	2,000	1,800	1,020			SUBTOTAL (VA)
	O.	LID TOTAL ALL DUAGES A	/ A \		PHA	SE A	PHA	SE B	PHA	SEC		* A	RC-FAULT CIRCUIT BREAKER
		OB-10 INC NEET THOSES (I	(A)		5, 105	j	4,270		3,475	i			** GFCI CIRCUIT BREAKER
	SLIMMAR	RY BY TYPE	0	NNIE	CTED	7	DEM	IAND	]				CONNECTED LOAD SUMMARY
R	=	RECEPTACLE	1,92		VA	1	1,920		1		5). 2 <sub>7</sub>	12,850	
L	=	LIGHTING	10,8	-4200	VA	-	13,513						AMPS
E	=	EQUIPM ENT	120	1.18 4-20	VA	-		VA			<u> </u>	30 .	AMFS
K	=	KITCHEN EQUIP	0		VA	-		VA					
M	=	MOTOR	0		VA	1	1	VA	1				NEC LOAD SUMMARY
matter.		LARGEST MOTOR	0		VA	-	1977	VA	1				A COLO
X	=					-			1		b	15,553	
H	=	ELECTRIC HEAT	0		VA		0	VA				43	AMPS


**EXISTING** 

PA	NELBOARD: P1-S1			FED FROM	1:		MOUN	NΠNG: FACE			G ONLY	VOLTAGE: 120/208V, 3PH,	
Т			С	MDP				ACE	BUS AM	C	Y: 400A	AIC RMS: 10K	AI
Y P	DESCRIPTION	DEV.	K			LOAD/PHA	ASE (VA)			K	DEV.	DESCRIPTION	Y
Ε			T	Α	В	C	Α	В	С	T			1
П	SPARE	20/1	1				3850			2			
	SPARE	20/1	3					3850		4	50/3	EXISTING SPIRAL MIXER	1
M	EXISTING DISPOSAL	25/1	5			1000			3850	6			1000
E	EXISTING ESPRESSO	20/1	7	500			1910			8	20/0	EMOTING IOE MAKED	
Е	EMOTINO EODDEOGO HA OLINE	2010	9		1500			1910		10	30/2	EXISTING ICE MAKER	1
E	EXISTING ESPRESSO MACHINE	30/2	11			1500			750	12	0010	EVIOTING WAR BUTER	Comment of the last
K	EXISTING UC REF.	20/1	13	500			750			14	20/2	EXISTING WARMER	( Parties
K	EXISTING REF.	20/1	15		750			720		16	20/1	EXISTING RECEPTACLE	The same of
E	EVIOTING COFFEE HARMINE	4010	17			2000			500	18	20/1	EXISTING PROOFER LIGHTS	Γ
E	EXISTING COFFEE MACHINE	40/2	19	2000			540			20	20/1	EXISTING COOLER LIGHTS	
E	EXISTING COFFEE GRINDER	20/1	21		500			720		22	20/1	EXISTING RECEPTACLES	
E	EXISTING HOOD CONTROL	20/1	23			500			540	24	20/1	EXISTING RECEPTACLES	
K	EXISTING UC REF.	20/1	25	350			720			26	20/1	EXISTING RECEPTACLES	
K			27		1100			750		28	20/1	EXISTING REACH IN REF.	-
K	EXISTING DOUGH MOULDER	20/3	29			1100			720	30	20/1	EXISTING RECEPTACLES	
K			31	1100			540		area area	32	20/1	EXISTING RECEPTACLES	
Е	EXISTING ANSUL SYSTEM	20/1	33		500			500		34	2002		1
R	EXISTING RECEPTACLE RTU	20/1	35			500	-		500	36	30/2	EXISTING HOOD FAN DISH RM	Ī
K	EXISTING REACH IN REF.	20/1	37	750		GRATION ST	540		CHIEROS I	38	20/1	EXISTING RECEPTACLES	
K	EXISTING COUNTER MIX	20/1	39		750	:		720		40	20/1	EXISTING RECEPTACLES	
K	EXISTING SHEETER	20/1	41			480			720	42	20/1	EXISTING RECEPTACLES	1
	SUBTOTAL (VA)			5,200	5, 100	7,080	8,850	9,170	7,580			SUBTOTAL (VA)	_
	TOTAL ALL PHASES (VA)			PHA	SEA	PHA	SE B	PHA	SE C	i.	* /	RC-FAULT CIRCUIT BREAKER	_
	SECTIONS 1 & 2			25,681		25,210		23,180	)			** GFCI CIRCUIT BREAKER	
0,	DAD SUMMARY BY TYPE CON		ONNE	CTED		DEM	AND					CONNECTED LOAD SUMMARY	
R	= RECEPTACLE	12,7	40	VA		11,370	VA				74,071		
L	= LIGHTING	1,04	10	VA		1,300	VA			a a	206	AMPS	
E	= EQUIPMENT	14,0	91	VA		14,091	VA						
K	= KITCHEN EQUIP	44,0	00	VA	]	28,600	VA						-
M	= MOTOR 2,200 VA		]	2,200	VA					NEC LOAD SUMMARY			
Χ	= LARGEST MOTOR	0		VA	]	0	VA				57,561	VA	
H	= ELECTRIC HEAT	0		VA		0	VA				160	AMPS	

PA	NELBOARD: P1-S2	idi	FED FROM: P1-S1			MOUNTING: SURFACE		MAIN LUG OF BUS AMPACITY: 4				
T Y P	DESCRIPTION	DEV. K		LOAD/PHASE (VA)					C K	DEV.	DESCRIPTION	
E			T	Α	В	С	Α	В	С	T		
K	EXISTING REF.	20/1	43	750			1000			44	20/1	EXISTING HAND DRYER
K	EXISTING REF.	20/1	45	** *-	750			1000		46	20/1	EXISTING HAND DRYER
K	EXISTING REF.	20/1	47			750			500	48	20/1	EXISTING POS
E	EXISTING PANEL "P3" 10		49	1191			500			50	20/1	EXISTING POS
E		100/3	51	e.	900			540		52	20/1	EXISTING RECEPTACLES
Ξ			53			0			540	54	20/1	EXISTING RECEPTACLES
	SPACE		55				720			56	20/1	EXISTING RECEPTACLES
(	EXISTING LOAD	20/1	57	e.	500			540		58	20/1	EXISTING RECEPTACLES
<	The second second second		59			500			720	60	20/1	EXISTING RECEPTACLES
₹	EXISTING RECEPTACLES	20/1	61	720			750			62	20/1	EXISTING JUICE MIXER
<	EXISTING WARMER	20/2	63	x 4	750			540		64	20/1	EXISTING RECEPTACLES
(	EXIOTING WATURER		65			750			540	66	20/1	EXISTING RECEPTACLES
<	EXISTING DW	EXISTING DW 20/2	67	1500			1000			68	20/2	EXISTING EQUIPMENT
<	EXISTING DW		69	· -	1500			1000		70		
<	EXISTING WARMER	20/2	71			500			1000	72	20/2	EXISTING EQUIPMENT -
K	EXISTING WATWIER		73	500			1000	VIII 1.75 (A.)		74	ZUIZ	
	EXISTING CIRCULATING PUMP	20/1	75		200			720		76	20/1	EXISTING RECEPTACLES
K	2724 2272	20/3	77			500			1500	78		1,000 A WE A WALL TO
<	EXISTING MIIXER		79	500			1500			80	30/3	EXISTING PROOFER
K			81		500			1500		82		
_	SPARE	20/1	83						720	84	20/1	EXISTING RECEPTACLES
SUBTOTAL (VA)				5,161 5,100 3,000			6,470 5,840		5,520			SUBTOTAL (VA)
SUB-TOTAL ALL PHASES (VA) SECTION 2				PHASE A		PHASE B		PHASE C		* ARC-FAULT CIRCUIT BREAKER		
				11,631		10,940		8,520	8,520		** GFCI CIRCUIT BREAKER	

PA	NELBOARD: L1		and the same of th			NAME OF TAXABLE PARTY.			MAIN LUG ONLY MPACITY: 225A		VOLTAGE: 120/208V, 3PH,	
T C C				LOAD/PHASE (V						C	DEV.	AIC RMS: 22K
Y DESCRIPTION P. DEV. K		NOE (VA)						K				
E	EMOTILO HIVED	0014		A	В	С	A	В	С		0014	EVIOT DESERTI OF
	EXISTING MIXER	20/1	1	1440	4004		720	700		2	20/1	EXIST. RECEPTA CLES
K K	EXISTING MIXER	20/2	5		1664	1664		720	500	6	20/1	EXIST. RECEPTA CLE
-	EXISTING REACH IN REF.	20/1	7	1488	£	1004	500	s.	300	8	20/2	EXIST. RECEPTACLES
100	EXISTING REACH IN FREEZER	20/1	9		1200			500		10		
	SPARE	20/1	11		10.00				500	12	20/2	EXIST. RECEPTACLES *
K	EXISTING COMBLOVEN STEAMER	20/1	13	1000			500			14	20/1	EXISTING RECEPTACLES
	SHUNT TRIP		15					720		16	20/1	EXISTING RECEPTACLE
K	EXISTING EXHAUST HOOD	20/1	17			1000			720	18	20/1	EXISTING RECEPTACLE
K	EXISTING EXHAUST HOOD	20/1	19	1000			720			20	20/1	EXISTING RECEPTACLE
K	EXISTING WAIT STATION	20/1	21		500			500		22	20/1	EXISTING RECEPTACLE
K	EXIST. REMOTE WATER CHILLER	20/1	23			1200			720	24	20/1	EXISTING RECEPTAICLE
_	EXIST. GLASS WASHER	25/1	25	2000			900			26	20/1	EXISTING RECEPTAICLE
	EXIST. POS TERMINAL	20/1	27		500			1200		28	20/1	EXIST. TILTING SKILLE
	EXIST. BACK BAR COOLER	20/1	29			720				30		SHUNT TRI
-	EXIST. BACK BAR COOLER	20/1	31	1080	4000		1000			32	20/1	EXIST. COMBI OVEN STREAME
Mag.	EXIST. COMBLOVEN STEAMER SHUNT TRIP	20/1	33 35		1000				1000	34 36	20/1	SHUNT TRI EXIST. COMBI OVEN STREAME
_	EXIST. UC ICE MACHINE	20/1	37	950					1000	38	20/1	SHUNT TRI
	EXIST. UCICE MACHINE	20/1	39	330	950			720	, ·	40	20/1	EXIST. RECEPTACLE
	EXIST. RECEPTACLES	20/1	41		550	500		720	200	42	20/1	EXIST. RECEPTACLES- OUTDOO
M	ENG I. NE SET THOSES	20, 1	43	800		000	1080		200	44	201	Eddi. (Edd. Molec dollar)
M	EXIST. EXHAUST FAN	15/3	45		800			1080		46	20/3	EXIST. MFCU
M			47			800			1080	48		
М		1	49	750			1080			50		
M	EXIST. MAU 15//3	15//3	51		750			1080		52	20/3	EXIST. MFCU
М			53			<b>750</b>			1080	54		
	SUBTOTAL (VA)			10,508	7,364	6,634	6,500	6,520	5,800			SUBTOTAL (VA)
SUB-TOTAL ALL PHASES (VA)				PHASE A		I AND A STATE OF THE STATE OF T			W		126	ARC-FAULT CIRCUIT BREAKER
	300 1011121121111020 (11			17,008		13,884		12,434				** GFCI CIRCUIT BREAKER
					ľ			1		-		
LOAD SUMMARY BY TYPE CONNE						DEMAND					CONNECTED LOAD SUMMARY	
R	= RECEPTACLE	4,06	Harris Control	VA		4,060					47,421	
L	= UGHTING	0		VA		2000	VA				132	AMPS
E	= EQUIPMENT	500		VA		500						
K M	= KITCHEN EQUIP	30,9	9-9 (O.Se	VA		20,108	10000					NEC LOAD SUMMARY
M X	= MOTOR = LARGEST MOTOR	8,68 3,24		VA VA		8,685 4,050	10 15 10 10 10 10 10 10 10 10 10 10 10 10 10			-	37,403	NEC LOAD SUMMARY
1	- LARGEST WOTOK	3,24	ŧU.	VΑ		4,000	V A				51,403	V A

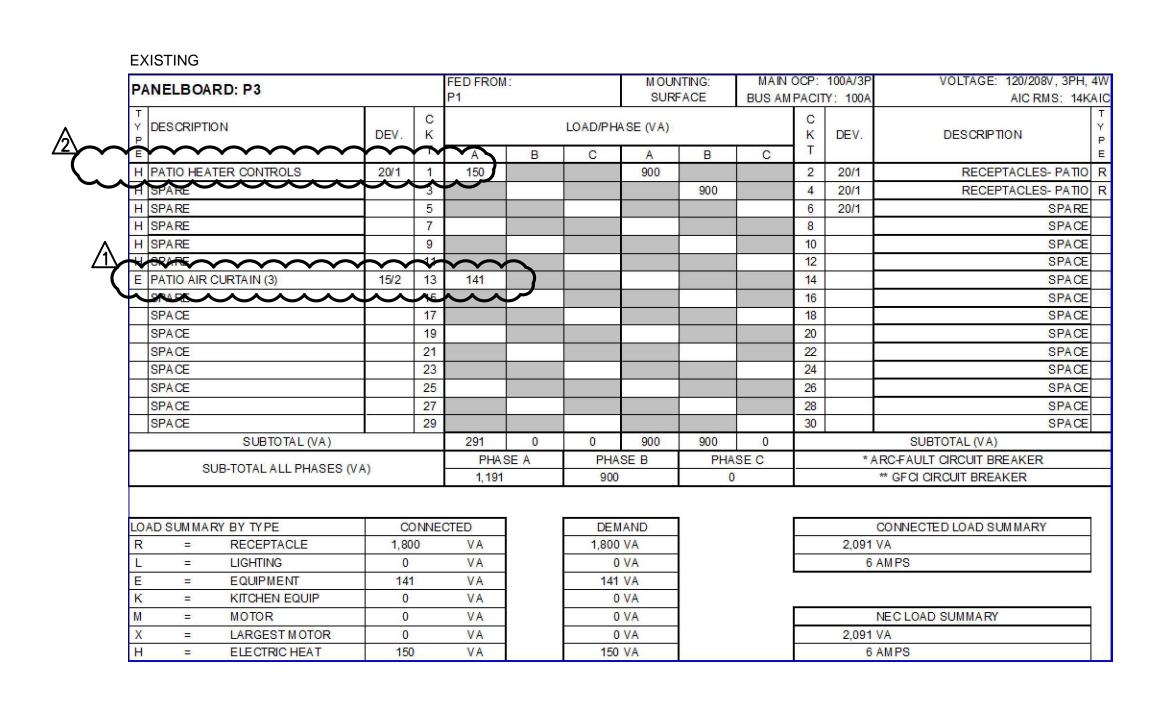

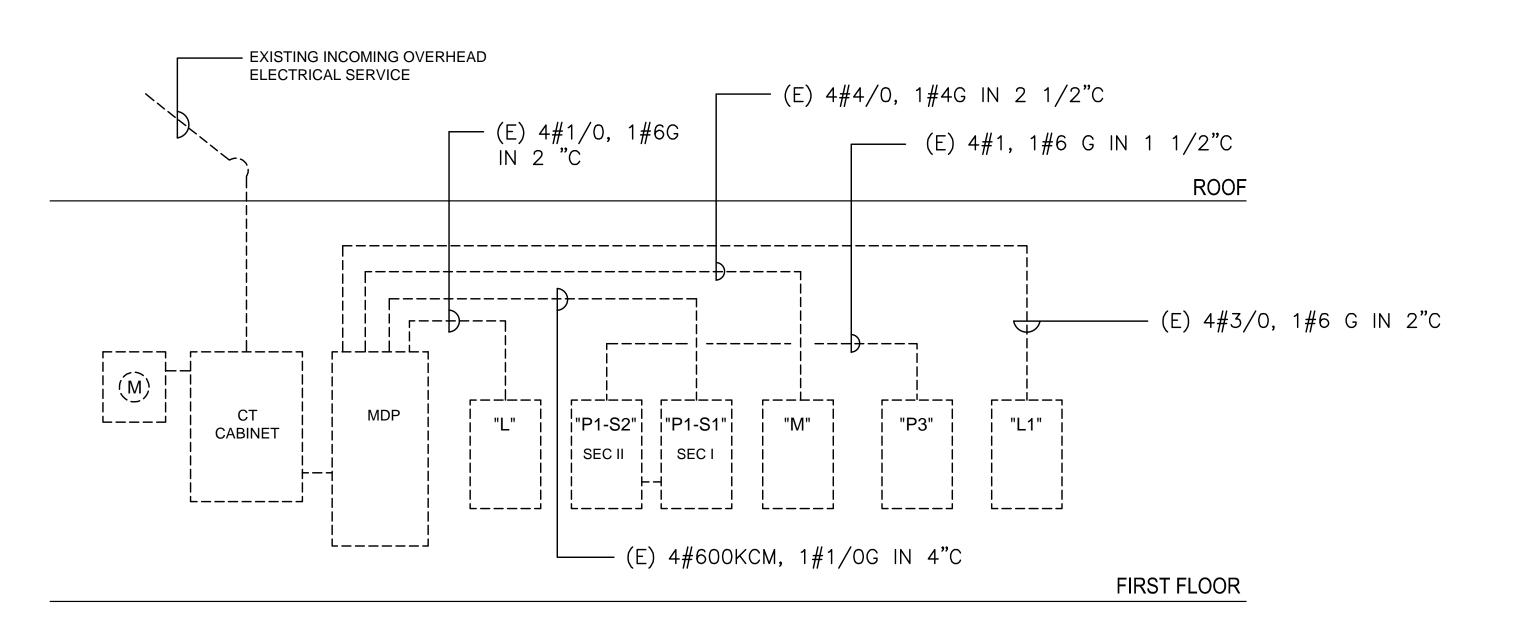

POWER RISER DIAGRAM NOT TO SCALE

# NOTES:

A) ALL DASHED EQUIPMENT IS EXISTING TO REMAIN.



COPYRIGHT NOTICE:

STUDIO3877 EXPRESSLY RESERVES ITS COMMON LAW COPYRIGHT AND OTHER PROPERTY RIGHTS TO THESE PLANS. THESE PLANS ARE NOT TO BE REPRODUCED, CHANGED, OR COPIED IN ANY FORM OR MANNER WHATSOEVER, NOR ARE THEY TO BE ASSIGNED TO ANY THIRD PARTY WITHOUT OBTAINING THE EXPRESS WRITTEN PERMISSION AND CONSENT OF STUDIO3877.

BAKER'S BREAD LLC NOE LANDINI 115 KING STREET ALEXANDIRA, VA 22314 **GENERAL CONTRACTOR:** TECH 24 5256 EISENHOWER AVE ALEXANDRIA, VA 22304 [T] 571.233.8585 [W] WWW.TECH24CONSTRUCTION.COM 3333 K STREET NW, SUITE 60 WASHINGTON DC 20007 [T] 202.350.4244 [W] WWW.3877.DESIGN MEP ENGINEER : BUILT ENVIRONMENT ENGINEERS 6861 ELM STREET SUITE 2D MCLEAN, VA 22101 [T] 703.888.0649 [W] WWW.BEENGRS.COM FOOD SERVICE: SINGER EQUIPMENT COMPANY JAMES FEUSTEL 180 HELLER PLACE BELLMAWR, NJ 08031 [T] 646-702-9922



**ISSUED FOR PERMIT** 

DRAWING DATA

PROJECT: JUNCTION BAKERY -ALEXANDRIA

ADDRESS: 1508 MT VERNON AVENUE ALEXANDRIA, VA 22301

SHEET SUBMISSION INDEX INTERIOR PERMIT - 3.31.2023

EXTERIOR PERMIT - 3.31.2023

PERMIT RESPONSE - 6.07.2023

DATE REVISION

EXTERIOR PERMIT REVISIONS 31 JULY 2023

SEAL & SIGNATURE:



ENTER PROFESSIONAL CERTIFICATION TEXT HERE THAT IS REQUIRED FOR THE JURISDICTION WHERE DRAWINGS WILL BE SUBMITTED.

> SHEET TITLE: PANEL SCHEDULES AND POWER RISER PROJECT NO: 2022-46 DATE ISSUED: 03/31/23 SCALE: As indicated

## **GENERAL NOTES**

- SCOPE: FURNISH ALL LABOR, MATERIALS, TOOLS, EQUIPMENT, SERVICES AND SKILLED SUPERVISION NECESSARY TO PROVIDE, INSTALL, TEST AND ADJUST HVAC AND PLUMBING SYSTEMS COMPLETE, OPERATIONAL, AND READY FOR USE, AS INDICATED IN THESE DRAWINGS AND SPECIFICATIONS.
- PERMITS, LICENSES & FEES: PAY ALL REQUIRED FEES AND OBTAIN ALL NECESSARY PERMITS AND LICENSES FOR LEGAL REMOVAL AND INSTALLATION OF THE WORK.
- APPLICABLE CODES AND STANDARDS: ALL WORK SHALL BE PERFORMED IN ACCORDANCE WITH THE FOLLOWING CODES AND STANDARDS AND ANY REGULATIONS EFFECTIVE IN THE PROJECT JURISDICTION. ALL CODE CONFLICTS SHALL BE BROUGHT TO THE ATTENTION OF THE OWNER FOR RESOLUTION. APPLICABLE CODES AND STANDARDS ON THIS PROJECT INCLUDE, BUT ARE NOT LIMITED TO, THE FOLLOWING:

A. VIRGINIA BUILDING CODE, 2018 B. VIRGINIA MECHANICAL CODE, 2018 C. VIRGINIA FUEL GAS CODE 2018 D. VIRGINIA ENERGY CONSERVATION CODE 2018 E. NFPA 70, NATIONAL ELECTRICAL CODE 2017 F. NFPA 72, NATIONAL FIRE ALARM CODE G. 2010 ADA STANDARD

- DRAWING ACCURACY: DRAWINGS ARE DIAGRAMMATIC AND NOT INTENDED TO BE SCALED. WHEN INDICATED, ALL WORK SHALL BE PHYSICALLY LOCATED IN ACCORDANCE WITH ANNOTATED DIMENSIONS ON ARCHITECTURAL PLANS, ELEVATIONS AND DETAILS.
- SITE VISIT: THE CONTRACTOR SHALL VISIT THE SITE AND SHALL FAMILIARIZE HIMSELF WITH THE EXISTING CONDITIONS, EQUIPMENT, DUCTWORK, PIPING, WIRING, CONSTRUCTION, FINISHES, AND STRUCTURE PRIOR TO START OF WORK. WHEN ANY DISCREPANCY OR CONFLICT IS DETECTED AT THE PROJECT SITE, THE OWNER SHALL BE NOTIFIED IMMEDIATELY PRIOR TO COMMENCING WORK.
- COORDINATION: CONTRACTOR SHALL COORDINATE AND SEQUENCE THE WORK OF ALL DIVISIONS AND TRADES PRIOR TO FABRICATION AND INSTALLATION OF DUCTWORK AND RACEWAYS. COORDINATE THE LOCATION OF ALL NEW EQUIPMENT, DUCTWORK, AND DEVICES WITH NEW STRUCTURE AND EQUIPMENT BEFORE FABRICATION. MAKE NECESSARY ACCOMMODATIONS TO MEET THE INTENT OF THE DRAWINGS AND ENSURE A COORDINATED INSTALLATION.
- SUBMITTALS AND SUBSTITUTIONS: CONTRACTOR SHALL PROVIDE PRODUCT INFORMATION, SHOP DRAWINGS, DOCUMENTS AND WARRANTIES FOR MATERIALS AND SERVICES TO THE OWNER FOR APPROVAL. NO SUBSTITUTION WILL BE ALLOWED WITHOUT PERMISSION OF THE OWNER'S REPRESENTATIVE IN WRITING. SUBSTITUTE MATERIAL SHALL BE COMPATIBLE WITH OTHER COMPONENTS OF THE SYSTEM.
- INSTALLATION OF NEW WORK: INSTALLATION OF EQUIPMENT, DUCTWORK, PIPING, FIXTURES, ETC. SHALL BE DONE IN NEAT AND WORKMANLIKE MANNER, AND SHALL CONFORM TO THE LATEST TRADE PRACTICES. REFER TO ARCHITECTURAL DRAWINGS TO VERIFY EXACT LOCATION OF EQUIPMENT, FIXTURES, ETC. COORDINATE DUCTWORK AND PIPING WITH THE WORK OF OTHER TRADES PRIOR TO FABRICATION. MAKE NECESSARY ACCOMMODATIONS TO MEET THE INTENT OF THE DRAWINGS AND ENSURE A COORDINATED INSTALLATION.
- DRAWINGS ARE DIAGRAMMATIC AND REPRESENT THE INTENT OF THE CONTRACT. DESIGN DRAWINGS ARE NOT TO BE CONSIDERED AS SUBSTITUTION TO SHOP DRAWINGS. DRAWINGS SHALL BE FOLLOWED AS CLOSELY AS CONDITIONS ALLOW TO COMPLETE THE INTENT OF THE CONTRACT. THE RIGHT IS RESERVED BY THE ENGINEER TO MAKE MINOR CHANGES IN LOCATIONS AND ARRANGEMENTS WHEN REQUIRED BY JOB DEVELOPMENT WITHOUT ADDITIONAL COMPENSATION TO THE CONTRACTOR.
- 10. MOUNTING HEIGHTS: COORDINATE MOUNTING HEIGHTS OF DEVICES ON FINISHED WALLS TO PROVIDE A NEAT AND SYMMETRICAL APPEARANCE. SEE ARCHITECTURAL PLANS, ELEVATIONS AND DETAILS FOR HEIGHTS AND LOCATIONS OF EQUIPMENT. DIMENSIONS, UNLESS OTHERWISE NOTED, ARE TO CENTERLINE OF EQUIPMENT.
- 11. WARNING SIGNS: PROVIDE SIGNS, BARRICADES, GUARDS, AND PROTECTION FOR SAFETY DURING CONSTRUCTION. WORK AREA SHALL BE KEPT CLEAN, CLEAR OF OBSTRUCTIONS, WELL ILLUMINATED, AND UNDER ORGANIZED MATERIAL STORAGE.
- 12. FIRE STOPPING: REFER TO ARCHITECTURAL PLANS FOR DETAILS AND REQUIREMENTS FOR CONDUIT AND PIPING PENETRATIONS THROUGH WALLS, FLOORS AND CEILINGS.
- 13. REPAIR: ALL WORK SHALL BE DONE IN SUCH A MANNER TO MINIMIZE DAMAGE TO ADJACENT EQUIPMENT. PIPING, DUCTWORK, WIRING, FIXTURES, CONSTRUCTION, FINISHES AND STRUCTURE. ANY DAMAGE RESULTING FROM WORK UNDER THIS PROJECT SHALL BE REPAIRED OR REPLACED BY THE CONTRACTOR TO THE SATISFACTION OF THE OWNER AT NO ADDITIONAL COST.
- 14. <u>CLEANING & MATERIAL DISPOSITION:</u> CLEAR ALL DEBRIS FROM THE AREA OF WORK AND LEAVE SITE IN CLEAN CONDITION. CLEAN ALL EQUIPMENT ENCLOSURES, INSIDE AND OUTSIDE. ALL DEMOLISHED EQUIPMENT AND DEBRIS NOT TO BE REUSED OR SALVAGED SHALL BE REMOVED FROM THE SITE AND PROPERLY DISPOSED OF IN ACCORDANCE WITH APPLICABLE REGULATIONS.
- 15. <u>HAZARDOUS MATERIALS:</u> IF SUSPECTED HAZARDOUS MATERIALS ARE ENCOUNTERED IN AREAS EXPECTED TO CONTAIN ACMs, PCBs, OR LEAD, THE CONTRACTOR SHALL CEASE DEMOLITION ACTIVITIES AND NOTIFY THE
- 16. PROVIDE DIELECTRIC PIPING UNIONS BETWEEN DISSIMILAR METALS.
- 17. PIPING SHALL NOT COME INTO DIRECT CONTACT WITH CONCRETE OR STRUCTURE IN ANY LOCATION.
- 18. VALVES AND PIPING ACCESSORIES SHALL BE IN LINE SIZE. PROVIDE SUPPLY STOP VALVES AT ALL NON-FLUSH VALVE TYPE FIXTURES.
- 19. PROVIDE CODE COMPLIANT (ASSE) BACKFLOW PREVENTER WITH SHUT OFF VALVES, UNION, AND ESCUTCHEON AT EACH EQUIPMENT CONNECTION THAT REQUIRES A POTABLE WATER CONNECTION.
- 20. CONTRACTOR IS PROHIBITED FROM USING LEAD-BASED SOLDER.
- 21. ALL PIPING PENETRATING CEILINGS AND WALLS SHALL BE INSTALLED WITH ESCUTCHEONS AT PENETRATION. PIPING PENETRATING EXTERIOR WALLS. ROOFS AND FLOOR AND CEILING SHALL BE FLASHED IN APPROVED MANNER AND SHALL BE SEALED WATERTIGHT TO MAINTAIN INTEGRITY OF SEPARATION. PIPING PENETRATING FIRE RATED PARTITIONS SHALL BE INSTALLED WITH FIRE RATED SEALS AS REQUIRED BY ARCHITECT AND AUTHORITY HAVING JURISDICTION.
- 22. PROVIDE ACCESS TO SYSTEM COMPONENTS THAT ARE CONCEALED AND REQUIRE PERIODIC SERVICE.
- 23. PLUMBING EQUIPMENT, PIPING, INSULATION, ETC., INSTALLED IN HVAC PLENUM SPACES SHALL MEET CODE REQUIREMENTS FOR SMOKE DEVELOPMENT AND COMBUSTIBILITY.

#### **GENERAL NOTES**

- 24. PROVIDE SHUTOFF VALVES ON BRANCH PIPING AND SLIPPLIFS TO INDIVIDUAL FIXTURES AND FOLLIDMENT **VALVES** DIAMETE
- 25. VERIFY ARCHIT
- 26. SLOPE LARGER
- 27. GUARAN ACCEPT
- 28. ALL ABANDONED PLUMBING PIPING SHALL BE REMOVED (BOTH FROM ABOVE CEILINGS AND BELOW SLAB).

TIDE SHUTOFF VALVES ON BRANCH PIPING AND SUPPLIES TO INDIVIDUAL FIXTURES AND EQUIPMENT.  TIDE VALVES ON ALL WATER, ETC, MAIN BRANCHES IN CORRIDORS AND WHERE INDICATED ON DRAWINGS.  ES SHALL BE INSTALLED WITH STEM UP. VALVES INSTALLED SHALL BE PERMANENTLY ACCESSIBLE FOR  ES 3" DIAMETER AND SMALLER AND SHALL BE CHAIN OPERATED FOR VALVES LARGER THAN 3"  ETER.	EXTP-001 EXTP-101	GENERAL NOTES, SYMBOLS, AND ABBREVIATIONS  LEVEL 1 — NEW WORK PLAN
EY EXACT SIZES, LOCATIONS, INVERTS AND ELEVATIONS PRIOR TO RUNNING ANY PIPING. REFER TO INTECTURAL & CIVIL DRAWINGS FOR EXACT LOCATIONS OF FIXTURES AND EQUIPMENT.		
E HORIZONTAL WASTE PIPING AS FOLLOWS: 2-1/2" DIAMETER AND SMALLER AT 2%, 3" DIAMETER AND ER AT 1% IN DIRECTION OF FLOW.		
ANTEE: ALL PLUMBING WORK SHALL BE GUARANTEED FOR A PERIOD OF ONE YEAR FROM THE DATE OF PTANCE OF THE FINAL INSTALLATION BY THE OWNER'S REPRESENTATIVE.		

	PIPE LINE TYPES
	SANITARY PIPE ABOVE FLOOR
	SANITARY PIPE BELOW FLOOR
	VENT
	COLD WATER
	HOT WATER
	HOT WATER RETURN
	EXISTING SANITARY PIPE ABOVE FLOOR
	EXISTING PIPE BELOW FLOOR
=======	EXISTING VENT
======	EXISTING COLD WATER
_=====	EXISTING HOT WATER
======	EXISTING HOT WATER RETURN
—s——s—	STORM
—	FIRE PROTECTION
	SPRINKLER PIPE
cc	GAS PIPE
	EXISTING GAS PIPE

	SYMBOLS
<b>&gt;</b> −∞	P TRAP
5—	PIPE BREAK (SINGLE LINE)
C	PIPE FITTING DOWN OR DROP
-0-	PIPE FITTING TEE DOWN
0	PIPE FITTING UP
<b> </b>	SHUT OFF VALVE
	CHECK VALVE — BACKFLOW PREVENTER
$\dashv$	CLEANOUT
	CAP OR END OF PIPE
<b> </b>	OS&Y
•	POINT OF RECONNECTION
<b>S</b>	EXTENT OF DEMOLITION
W	REGULATOR
®	METER

	ABBREVIATIONS
ABV	ABOVE
ASME	AMERICAN SOC. OF MECHANICAL ENGINEERS
ASTM	AMERICAN SOC. FOR TESTING & MATERIAL
BEL	BELOW
BLDG	BUILDING
СО	CLEANOUT
CW	COLD WATER
DF	DRINKING FOUNTAIN
DN	DOWN
DW	DISHWASHER
DWG	DRAWING
ED	EMERGENCY FLOOR DRAIN
ET	EXPANSION TANK
(E)	EXISTING
EX	EXISTING
ETR	EXISTING TO REMAIN
EWH	ELECTRIC WATER HEATER
FCO	FLOOR CLEANOUT
FD	FLOOR DRAIN
GWH	GAS WATER HEATER
HW	HOT WATER
HWR	HOT WATER RETURN
LAV	LAVATORY
NIC	NOT IN CONTRACT
NTS	NOT TO SCALE
PSK	PANTRY SINK

REFRIGERATOR

SHOWER DRAIN

TEMPERING VALVE

VERIFY IN FIELD

WATER CLOSET

UNLESS OTHERWISE NOTED

SHOWER

URINAL

**DRAWING LIST** 



COPYRIGHT NOTICE:

STUDIO3877 EXPRESSLY RESERVES ITS COMMON LAW COPYRIGHT AND OTHER PROPERTY RIGHTS TO THESE PLANS. THESE PLANS ARE NOT TO BE REPRODUCED, CHANGED, OR COPIED IN ANY FORM OR MANNER WHATSOEVER, NOR ARE THEY TO BE ASSIGNED TO ANY THIRD PARTY WITHOUT OBTAINING THE EXPRESS WRITTEN PERMISSION AND CONSENT OF STUDIO3877.

BAKER'S BREAD LLC NOE LANDINI 115 KING STREET ALEXANDIRA, VA 22314 **GENERAL CONTRACTOR** 5256 EISENHOWER AVE ALEXANDRIA, VA 22304 [T] 571.233.8585 [W] WWW.TECH24CONSTRUCTION.COM

3333 K STREET NW, SUITE 60 WASHINGTON DC 20007 [T] 202.350.4244 [W] WWW.3877.DESIGN MEP ENGINEER

BUILT ENVIRONMENT ENGINEERS 6861 ELM STREET MCLEAN, VA 22101 [T] 703.888.0649 [W] WWW.BEENGRS.COM

SINGER EQUIPMENT COMPANY JAMES FEUSTEL 180 HELLER PLACE BELLMAWR, NJ 08031 [T] 646-702-9922



# **ISSUED FOR PERMIT**

DRAWING DATA

PROJECT: JUNCTION BAKERY -**ALEXANDRIA** 

ADDRESS: 1508 MT VERNON AVENUE **ALEXANDRIA, VA 22301** 


SHEET SUBMISSION INDEX

 INTERIOR PERMIT - 3.31.2023 EXTERIOR PERMIT - 3.31.2023

PERMIT RESPONSE - 6.07.2023

REVISION DATE 31 JULY 2023 EXTERIOR PERMIT REVISIONS


SIGNATURE:

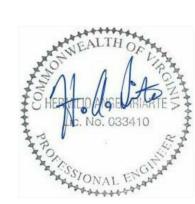

ENTER PROFESSIONAL CERTIFICATION TEXT HERE THAT IS REQUIRED FOR THE JURISDICTION WHERE DRAWINGS WILL BE SUBMITTED.

SHEET TITLE: GENERAL NOTES, SYMBOLS, & PROJECT NO: 2022-46

DATE ISSUED: 03/31/23 SCALE: As indicated

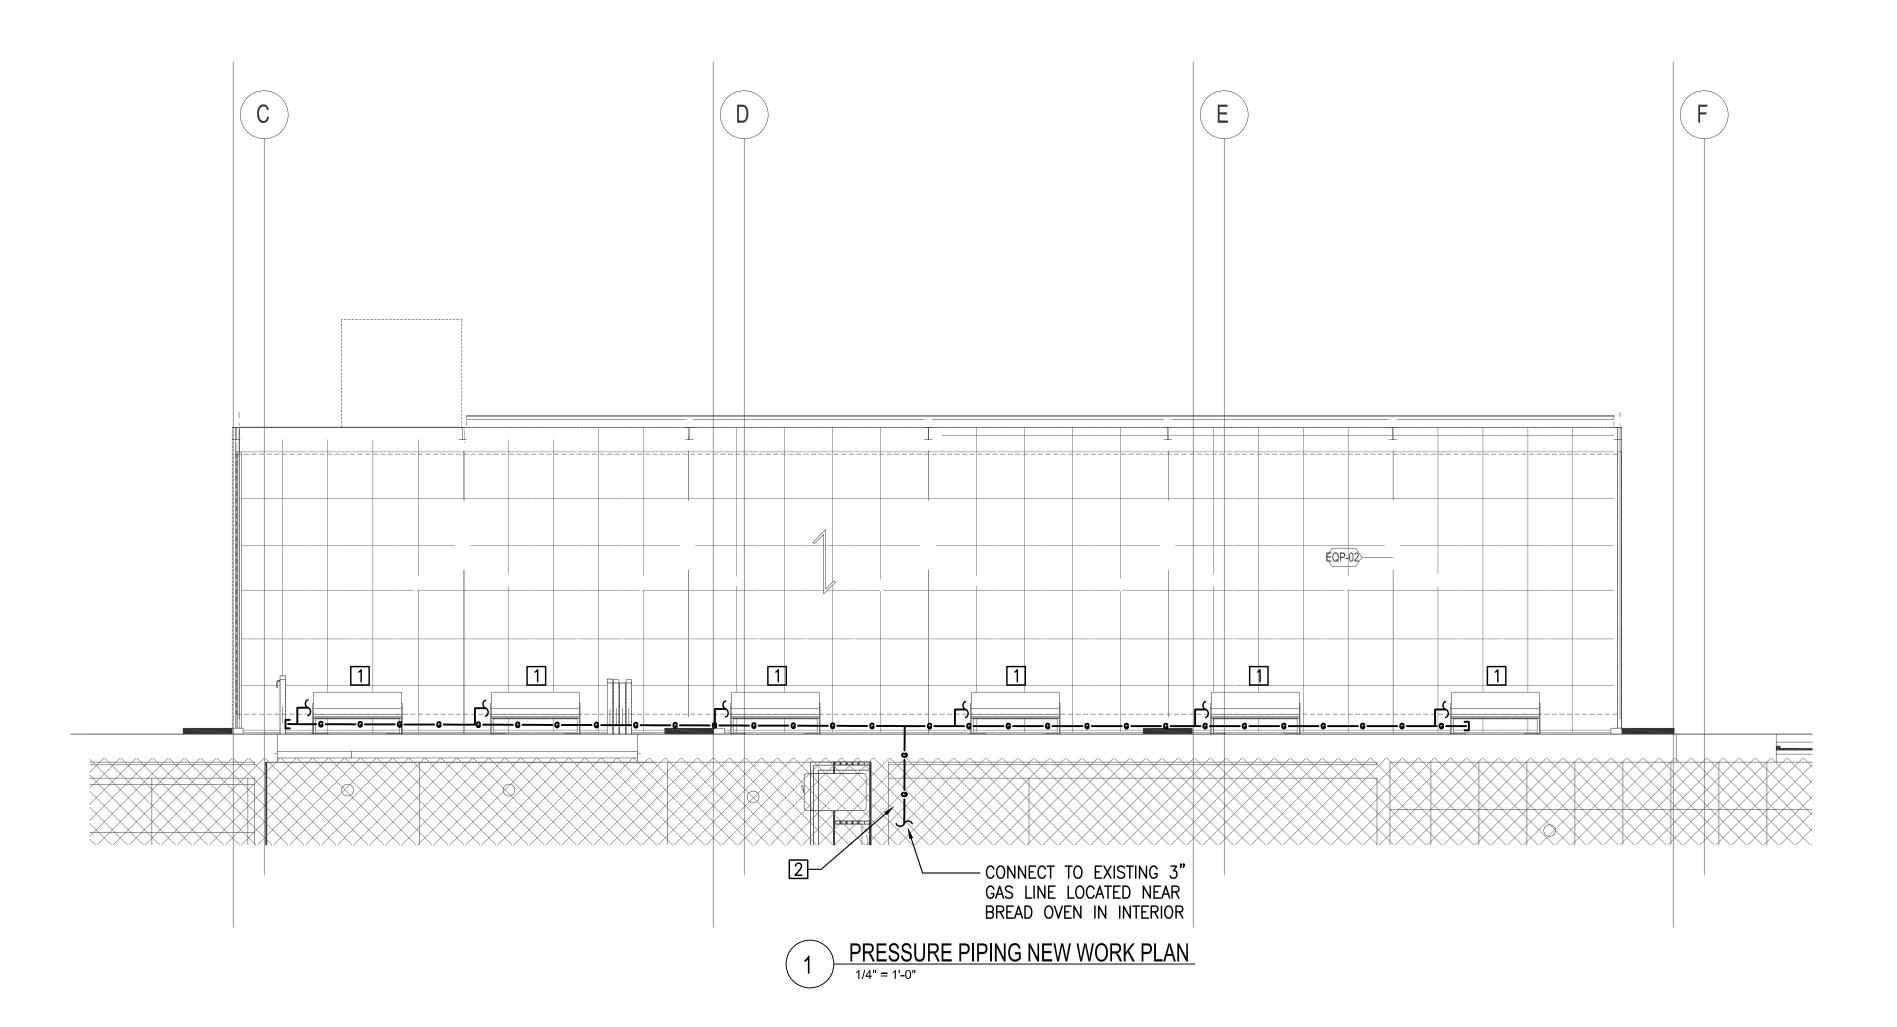

**GENERAL NOTES:** 

A. SEE DRAWING POO1 FOR GENERAL NOTES,

- SYMBOLS, & ABBREVIATIONS. B. FIELD VERIFY ADDITIONAL PIPING NOT SHOWN ON
- PLAN. VARIATIONS MAY BE ENCOUNTERED DURING DEMOLITION/CONSTRUCTION.
- C. CONTRACTOR IS TO REPAIR WALLS, SLAB, & CEILING AREAS AFFECTED BY PLUMBING WORK.

- 1. PATIO HEATER (50 MBH) REFER TO ARCHITECTURAL DWGS FOR DETAILS.
- 2. PIPING TO BE ABOVE FINISHED CEILING INSIDE BLDG.

w w w . 3 8 7 7 . d e s i g n

COPYRIGHT NOTICE:

STUDIO3877 EXPRESSLY RESERVES ITS COMMON LAW COPYRIGHT AND OTHER PROPERTY RIGHTS TO THESE PLANS. THESE PLANS ARE NOT TO BE REPRODUCED. CHANGED, OR COPIED IN ANY FORM OR MANNER WHATSOEVER, NOR ARE THEY TO BE ASSIGNED TO ANY THIRD PARTY WITHOUT OBTAINING THE EXPRESS WRITTEN PERMISSION AND CONSENT OF STUDIO3877.

BAKER'S BREAD LLC NOE LANDINI 115 KING STREET ALEXANDIRA, VA 22314 **GENERAL CONTRACTOR:** 5256 EISENHOWER AVE ALEXANDRIA, VA 22304

[T] 571.233.8585 [W] WWW.TECH24CONSTRUCTION.COM

3333 K STREET NW, SUITE 60 WASHINGTON DC 20007 [T] 202.350.4244 [W] WWW.3877.DESIGN MEP ENGINEER:

BUILT ENVIRONMENT ENGINEERS 6861 ELM STREET MCLEAN, VA 22101 [T] 703.888.0649 [W] WWW.BEENGRS.COM

FOOD SERVICE: SINGER EQUIPMENT COMPANY JAMES FEUSTEL 180 HELLER PLACE BELLMAWR, NJ 08031



# **ISSUED FOR PERMIT**

DRAWING DATA

PROJECT: JUNCTION BAKERY -**ALEXANDRIA** 

ADDRESS: 1508 MT VERNON AVENUE **ALEXANDRIA, VA 22301** 

SHEET SUBMISSION INDEX

 INTERIOR PERMIT - 3.31.2023 ISSUED FOR CONSTRUCTION INTERIOR - 08.11.2023

REVISION DATE EXTERIOR PERMIT REVISIONS EXTERIOR PERMIT REVISIONS

# **REVISED 1/25/2024**

SIGNATURE:




ENTER PROFESSIONAL CERTIFICATION TEXT HERE THAT IS REQUIRED FOR THE JURISDICTION WHERE DRAWINGS WILL BE SUBMITTED.

SHEET TITLE: LEVEL 1 - NEW WORK PLAN

PROJECT NO: 2022-46 DATE ISSUED: 03/31/23

SCALE: As indicated 

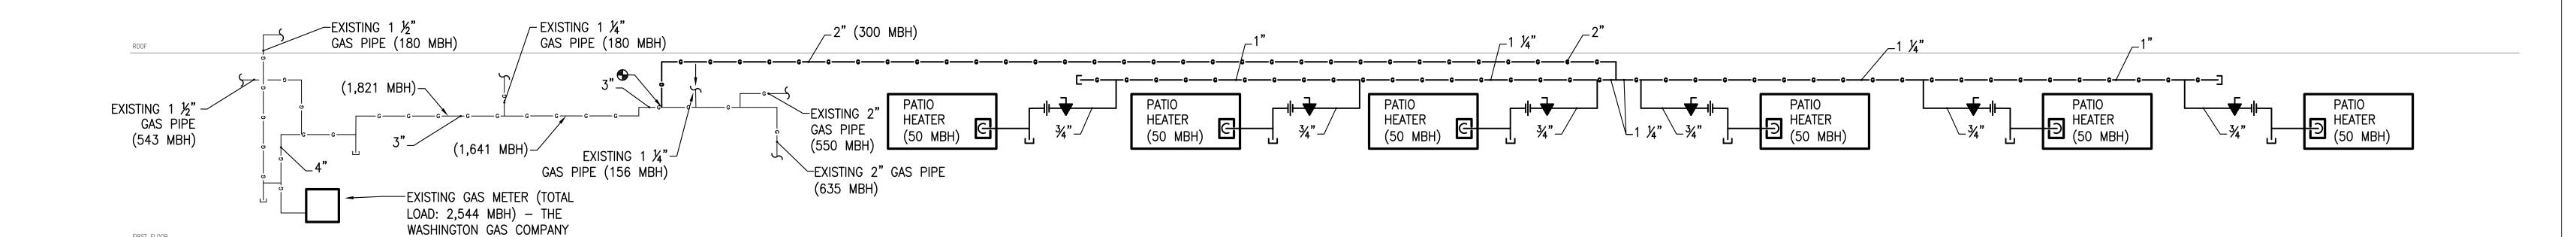

**GAS RISER NOTES:** 1. PLUMBING GAS WORK BEGINS AFTER POINT OF CONNECTION ON SHOWN RISER DIAGRAM AFTER GAS METER AND REGULATOR. WASHINGTON GAS TO PROVIDE GAS METER AND REGULATOR (OUTDOORS).

BASIS OF DESIGN IS SCHEDULE 40 BLACK STEEL. BASIS OF DESIGN IS LONGEST LENGTH METHOD FROM 2018 VFGC. 3.1. DESIGN BASIS = 2015 IFGC, TABLE 402.4(1)

INLET PRESSURE = LESS THAN 2.0 PSI PRESSURE DROP = 0.3 IN WC SPECIFIC GRAVITY = 0.60 GAS PIPE MEASURED LENGTH = 125 FT

4. SHUTOFF VALVES SHALL BE ACCESSIBLE.

5. PROVIDE SHUTOFF VALVES FOR ALL APPLIANCES AND EQUIPMENT AS REQUIRED.

6. PROVIDE DIRT LEGS AS REQUIRED.

FIRST FLOOR

7. REFER TO FLOOR PLANS FOR ADDITIONAL PIPING AND OFFSETS NOT SHOWN. 8. PROVIDE EXPANSION/DEFLECTION FITTINGS AS REQUIRED FOR ALL PIPING THAT PASSES ACROSS BLDG WALLS (OR JOINTS) AS WELL AS ROOFS (WHERE

HORIZONTAL OFFSETS ARE NOT PROVIDED). 9. PROVIDE KICK PLATES AS REQUIRED FOR GAS PIPING IN WALLS AS PER IFGC