ISSUE: Certificate of Appropriateness for alterations (signage)

APPLICANT: Donald Simpson, Jr., represented by Econo Sign Inc.

LOCATION: Old and Historic Alexandria District

501 King Street

ZONE: CD / Commercial Downtown Zone


STAFF RECOMMENDATION

Staff recommends approval of the Certificate of Appropriateness for alterations, with the following conditions:

- Anchors for the sign should be installed into the mortar joints on the masonry to avoid damaging the brick.
- The illumination shall be no greater than 150 lumens.

GENERAL NOTES TO THE APPLICANT

- 1. APPEAL OF DECISION: In accordance with the Zoning Ordinance, if the Board of Architectural Review denies or approves an application in whole or in part, the applicant or opponent may appeal the Board's decision to City Council on or before 14 days after the decision of the Board.
- 2. COMPLIANCE WITH BAR POLICIES: All materials must comply with the BAR's adopted policies unless otherwise specifically approved.
- 3. BUILDING PERMITS: Most projects approved by the Board of Architectural Review require the issuance of one or more construction permits by Department of Code Administration (<u>including signs</u>). The applicant is responsible for obtaining all necessary construction permits after receiving Board of Architectural Review approval. Contact Code Administration, 703-746-4200 for further information.
- 4. ISSUANCE OF CERTIFICATES OF APPROPRIATENESS AND PERMITS TO DEMOLISH: Applicants must obtain a copy of the Certificate of Appropriateness or Permit to Demolish PRIOR to applying for a building permit. Contact BAR Staff, Room 2100, City Hall, 703-746-3833, or preservation@alexandriava.gov for further information.
- 5. EXPIRATION OF APPROVALS NOTE: In accordance with Sections 10-106(B), 10-206(B) and 10-307 of the Zoning Ordinance, any Board of Architectural Review approval will expire 12 months from the date of issuance if the work is not commenced and diligently and substantially pursued by the end of that 12-month period.
- 6. HISTORIC PROPERTY TAX CREDITS: Applicants performing extensive, certified rehabilitations of historic properties may separately be eligible for state and/or federal tax credits. Consult with the <u>Virginia Department of Historic Resources (VDHR)</u> prior to initiating any work to determine whether the proposed project may qualify for such credits.

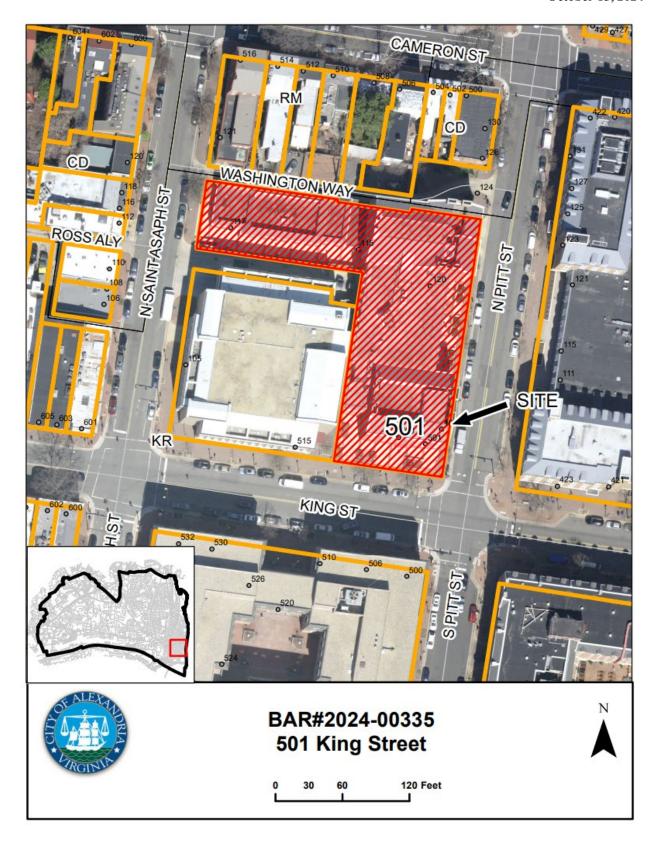

I. APPLICANT'S PROPOSAL

The applicant requests a Certificate of Appropriateness for alterations to replace the existing halolit signage for CVS Pharmacy with new halo-lit signage.

Site context

The subject property is part of the Bankers Square development, at the corner of King Street and North Pitt Street. The signage will be visible from both streets.

II. <u>HISTORY</u>

There have been several different structures located on the subject property throughout the years. According to the 1885 Sanborn map, the corner of King Street and North Pitt Street was once occupied by several two-story commercial structures, mainly selling cigars and drugs. According to the 1907 Sanborn map, the corner was occupied by two- and three-story commercial structures including a tailor, photographer, hardware store, and cigar store, with residential units above. The 1921 Sanborn map shows in that some of those structures had been demolished and replaced with the First and Citizens National Bank building (constructed in 1909). The bank shared the block with businesses such as Warfield's Drugstore, Ridgley and Jones Haberdashers, and Poppa George's hot dogs.

In 1963, Alexandria City Council passed the Gadsby Commercial Urban Renewal project, which proposed the demolition and redevelopment of several city blocks, including the subject property. The First National Bank and adjacent commercial structures were demolished in 1968 to make way for the Bankers Square development built in **1969** that still stands today. On at least four occasions, the Board has approved halo-lit signage for businesses at this location, in 1971, 1993, 2001, and 2010.

Previous BAR Approvals

April 17, 1952 Alterations January 15, 1953 Signage July 10, 1968 Construction of Bankers Square Two signs May 19, 1971 BAR-88-105 Alterations BAR-88-171 Signage Halo-lit signage for Super Crown Books BAR-93-187 BAR2001-00130 Halo-lit signage for Books-a-Million

BAR2010-00343 Halo-lit signage for CVS

III. ANALYSIS

Certificate of Appropriateness

The applicant proposes to replace two existing halo-lit channel letter signs, one on the King Street elevation and one on the North Pitt Street elevation, with new halo-lit channel letter signs. The only significant change in the design is the addition of a heart logo in front of the letters. The signs will each be 32.98 square feet. The proposal requires approval at a public hearing because halo-lit signage cannot be approved administratively by staff.





Figure 1: Existing CVS signage (left) and proposed signage (right) on King Street elevation

According to the *Design Guidelines*, "Signs and awnings are prominent visual elements of the streetscape in commercial areas of the historic districts." The *Design Guidelines* encourage signage to be compatible and blend in with the architecture of the building. Further, "When signs distract, shout out to the pedestrian, are not sensitively placed on the architecture or obscure it, a negative image of the historic commercial streetscape is created."

In the opinion of staff, the proposed signage is appropriate in both size and design. Halo-lit signage has been approved and used at this location several times since the construction of Bankers Square and the illumination does not detract from the historic streetscape. Therefore, staff recommends approval of the Certificate of Appropriateness for alterations, with the following conditions:

- Anchors for the sign should be installed into the mortar joints on the masonry to avoid damaging the brick.
- The illumination shall be no greater than 150 lumens.

STAFF

Brendan Harris, Historic Preservation Planner, Planning & Zoning Tony LaColla, AICP, Land Use Services Division Chief, Planning & Zoning

IV. <u>CITY DEPARTMENT COMMENTS</u>

Legend: C- code requirement R- recommendation S- suggestion F- finding

Zoning

- C-1 Proposed wall sign will comply with Zoning.
- F-1 Wall signs to follow the regulations under Sec. 9-202 for commercial signs.

Code Administration

C-1 A sign permit is required.

Transportation and Environmental Services

No comments received.

Alexandria Archaeology

No archaeology comments.

V. ATTACHMENTS

Application Materials

- Completed application
- Plans
- Material specifications
- Photographs
- Public comment if applicable
- Any other supporting documentation

			(OFFICE USE ONLY)
ADDRESS OF PROJECT:			
DISTRICT: Old & Historic Ale	exandria 🗌 P	arker – Gray	☐ 100 Year Old Building
TAX MAP AND PARCEL:			ZONING:
APPLICATION FOR: (Please check	all that apply)		
☐ CERTIFICATE OF APPROPE	RIATENESS		
PERMIT TO MOVE, REMOVE (Required if more than 25 square fee	•		
WAIVER OF VISION CLEARA CLEARANCE AREA (Section 5			YARD REQUIREMENTS IN A VISION ance)
WAIVER OF ROOFTOP HVA (Section 6-403(B)(3), Alexandria 199			NT
Applicant: Property Owner	Business	(Please provide	business name & contact person)
Name:			<u> </u>
Address:			<u> </u>
City:	_ State:	Zip:	
Phone:	_ E-mail :		
Authorized Agent (if applicable):	Attorney	☐ Archite	ct
Name:			Phone:
E-mail:			
Legal Property Owner:			
Name:			
Address:			
City:	_ State:	Zip:	
Phone:	F-mail·		

BAR CASE# _______

	BAR CASE#
	(OFFICE USE ONLY)
NATURE OF PROPOSED WORK:	: Please check all that apply
doors wind	lease check all that apply. ce, gate or garden wall HVAC equipment shutters dows siding shed gola/trellis painting unpainted masonry
DESCRIPTION OF PROPOSED be attached).	DWORK: Please describe the proposed work in detail (Additional pages may
SUBMITTAL REQUIREMENTS):
Check this box if there is a hom copy of the letter approving the pro	neowner's association for this property. If so, you must attach a ject.
	inimum supporting materials for BAR applications. Staff may ng application review. Please refer to the relevant section of the nation on appropriate treatments.
material that are necessary to thorodocketing of the application for revi	below to ensure the application is complete. Include all information and bughly describe the project. Incomplete applications will delay the lew. Pre-application meetings are required for all proposed additions. eet with staff prior to submission of a completed application.
Demolition/Encapsulation : All must complete this section. Check N/A	l applicants requesting 25 square feet or more of demolition/encapsulation if an item in this section does not apply to your project.
 Existing elevation drawings Clear and labeled photograto be demolished. Description of the reason for 	Attent of the proposed demolition/encapsulation. So clearly showing all elements proposed for demolition/encapsulation. So apply of all elevations of the building if the entire structure is proposed or demolition/encapsulation. So we see to demolition/encapsulation and why such alternatives are not

BAR CASE#	
•	(OFFICE USE ONLY)

Additions & New Construction: Drawings must be to scale and should not exceed 11" x 17" unless approved by staff. Check N/A if an item in this section does not apply to your project.

	<u>N/A</u>	
		Scaled survey plat showing dimensions of lot and location of existing building and other structures on the lot, location of proposed structure or addition, dimensions of existing structure(s), proposed addition or new construction, and all exterior, ground and roof mounted equipment.
		FAR & Open Space calculation form. Clear and labeled photographs of the site, surrounding properties and existing structures, if
П		applicable. Existing elevations must be scaled and include dimensions.
		Proposed elevations must be scaled and include dimensions. Include the relationship to adjacent structures in plan and elevations.
		Materials and colors to be used must be specified and delineated on the drawings. Actual
		samples may be provided or required. Manufacturer's specifications for materials to include, but not limited to: roofing, siding, windows,
		doors, lighting, fencing, HVAC equipment and walls. For development site plan projects, a model showing mass relationships to adjacent properties and structures.
illun	ninat	& Awnings: One sign per building under one square foot does not require BAR approval unless ed. All other signs including window signs require BAR approval. Check N/A if an item in this section does y to your project.
	N/A	Linear feet of building: Front:Secondary front (if corner lot): Square feet of existing signs to remain: Photograph of building showing existing conditions. Dimensioned drawings of proposed sign identifying materials, color, lettering style and text. Location of sign (show exact location on building including the height above sidewalk). Means of attachment (drawing or manufacturer's cut sheet of bracket if applicable). Description of lighting (if applicable). Include manufacturer's cut sheet for any new lighting fixtures and information detailing how it will be attached to the building's facade.
Alt	erat	tions: Check N/A if an item in this section does not apply to your project.
	N/A	Clear and labeled photographs of the site, especially the area being impacted by the alterations, all sides of the building and any pertinent details.
		Manufacturer's specifications for materials to include, but not limited to: roofing, siding, windows, doors, lighting, fencing, HVAC equipment and walls.
		Drawings accurately representing the changes to the proposed structure, including materials and overall dimensions. Drawings must be to scale.
		An official survey plat showing the proposed locations of HVAC units, fences, and sheds. Historic elevations or photographs should accompany any request to return a structure to an earlier appearance.

	BAR CASE#(OFFICE USE ONLY)				
	(OFFICE USE ONLY)				
ALL	ALL APPLICATIONS: Please read and check that you have read and understand the following items:				
	I understand that after reviewing the proposed alterations, BAR staff will invoice the appropriate filing fee in APEX. The application will not be processed until the fee is paid online.				
	I understand the notice requirements and will return a copy of the three respective notice forms to BAR staff at least five days prior to the hearing. If I am unsure to whom I should send notice I will contact Planning and Zoning staff for assistance in identifying adjacent parcels.				
	I, the applicant, or an authorized representative will be present at the public hearing.				
	I understand that any revisions to this initial application submission (including applications deferred for restudy) must be accompanied by the BAR Supplemental form and revised materials.				
The undersigned hereby attests that all of the information herein provided including the site plan, building elevations, prospective drawings of the project, and written descriptive information are true, correct and accurate. The undersigned further understands that, should such information be found incorrect, any action taken by the Board based on such information may be invalidated. The undersigned also hereby grants the City of Alexandria permission to post placard notice as required by Article XI, Division A, Section 11-301(B) of the 1992 Alexandria City Zoning Ordinance, on the property which is the subject of this application. The undersigned also hereby authorizes the City staff and members of the BAR to inspect this site as necessary in the course of research and evaluating the application. The applicant, if other than the property owner, also attests that he/she has obtained permission from the property owner to make this application.					
APP	LICANT OR AUTHORIZED AGENT:				
Signa	ature: Laura Mercier				
Printe	ed Name:				
Date	:				

OWNERSHIP AND DISCLOSURE STATEMENT Use additional sheets if necessary

1. Applicant. State the name, address and percent of ownership of any person or entity owning an interest in the applicant, unless the entity is a corporation or partnership, in which case identify each owner of more than three percent. The term ownership interest shall include any legal or equitable interest held at the time of the application in the real property					
which is the subject of the appli					
Name	Address	Percent of Ownership			
1.					
2.					
3.					
an interest in the property locate entity is a corporation or partner percent. The term ownership into	ddress and percent of ownership ed at	(address), unless the owner of more than three quitable interest held at the			
Name	Address	Percent of Ownership			
1.					
2.					
3.					
3. Business or Financial Relationships. Each person or entity listed above (1 and 2), with an ownership interest in the applicant or in the subject property is required to disclose any business or financial relationship, as defined by Section 11-350 of the Zoning Ordinance, existing at the time of this application, or within the12-month period prior to the submission of this application with any member of the Alexandria City Council, Planning Commission, Board of Zoning Appeals or either Boards of Architectural Review.					
Name of person or entity	Relationship as defined by Section 11-350 of the Zoning Ordinance	Member of the Approving Body (i.e. City Council, Planning Commission, etc.)			
1.	Lonning Oranianos	r turning commission, etc.)			
2.					
3.					
NOTE: Business or financial relationships of the type described in Sec. 11-350 that arise after the filing of this application and before each public hearing must be disclosed prior to the public hearings.					
As the applicant or the applicant's authorized agent, I hereby attest to the best of my ability that the information provided above is true and correct.					
•	,	a Mercier			
Date Printed	I Name	Signature			



DEPARTMENT OF CODE ADMINISTRATION

Gregg Fields Director 301 King Street Room-4200 Alexandria, Virginia 22314 Phone (703) 746-4200 Fax (703) 838-3880

Date

This statement certifies that I	Donald Simpson, Jr.	, owner/owner's agent
of the property located at	501 King Street, Alexandria, VA 2231-	4 ; who is
not a licensed architect, engineer,	or contractor, is not subject to licensure	or certification as a
contractor or subcontractor pursu	ant to Chapter 11 of Title 54.1 of the Co	de of Virginia. I also
understand that the permits obtain	ned pursuant to the 2018 Uniform States	vide Building Code
will be in my name and that I am	acting as contractor for this project. I ac	cept full responsibility
for the work performed.		
The state of the s	A 8	76/74


NOTICE TO OWNER

Signature of Owner

If you decide to make arrangements with a contractor to complete the work intended by this permit(s), the City of Alexandria strongly recommends that the contractor be the responsible party to secure the permits required by the Uniform Statewide Building Code (USBC). When contractors apply for permits, the city will verify that he/she is properly licensed by the State and City to perform the intended work. Unwillingness by the contractor to obtain required permits may be an indication that he/she is not property licensed.

For your protection, do not deal with unlicensed contractors. If you have any questions about licensing regulations, please contact the Permit Center at <u>permit.center@alexandriava.gov</u> or by phone at 703.746.4200 or the Virginia State Board for Contractors (DPOR) at <u>www.dpor.virginia.gov</u> or by phone at 804.367.8511.

Also, in accordance with Section 54.1-1101 (Exemptions) of the Code of Virginia (COV); you as the owner supervising or performing work consistent with the construction, removal, repair, or improvement of a primary residence and have not owned more than one primary residence in Virginia during the past 24 months is exempt from the code per this section.

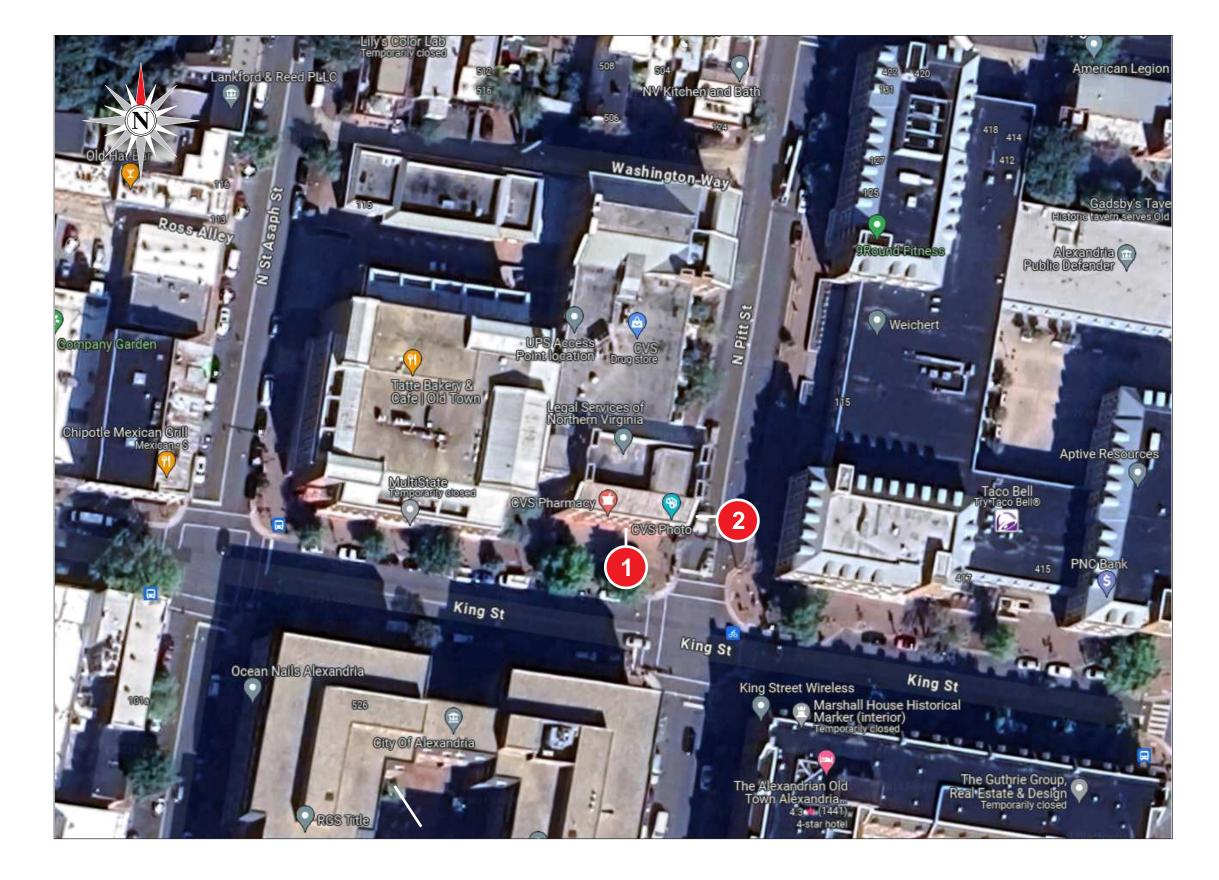

SITE PLAN/OVERHEAD VIEW

800.772.7932

www.atlasbtw.com

National Headquarters: 1077 West Blue Heron Blvd. West Palm Beach, Florida 33404



Revisions:
08.20.2024 - add dimensions and notes



PM: SG	Address: 501 King Street
Drawn By: NR	City State: Alexandria, VA
Date: 04.11.2024	Drawing Number: 193797



12396 WORLD TRADE DRIVE, SUITE 312

SAN DIEGO, CA 92128

PROJECTMANAGER@SULLAWAYENG.COM PHONE: 1-858-312-5150 FAX: 1-858-777-3534

PROJECT: CVS PHARMACY, 501 KING STREET, ALEXANDRIA, VA


PROJECT #: 46281

CLIENT: ATLAS SIGN INDUSTRIES

DATE: 07/04/2024

ENGINEER: RM

LAST REVISED:

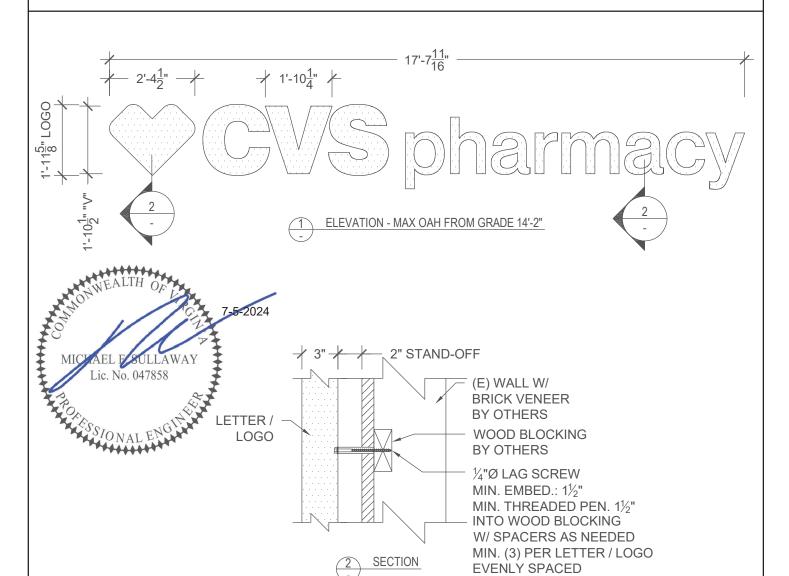



Complies with UL48
Sign Certification E212706

ELECTRICAL DATA		
Volts	120V Primary / 12V Secondary	
Total Amps	1.3 Total Amps	
Circuits	(1) 120VAC/20 amp Dedicated	
Visible Disconnects	(1) 120 VAC 20 Amp	
Power Supplies	(2) GEPS12-60 @ 0.65 Amps Ea.	

GENERAL NOTES

- 1. DESIGN CODE: IBC 2018 & VIRGINIA UNIFORM STATE BC 2018
- 2. DESIGN LOADS: ASCE 7-16
- 3. WIND VELOCITY 115 MPH EXPOSURE C
- 4. LAG SCREWS PER NDS SPECIFICATIONS
- 5. PROVIDE PROTECTION AGAINST DISSIMILAR METALS
- 6. ALL DIMENSIONS TO BE VERIFIED PRIOR TO FABRICATION
- 7. ALL EXISTING ELEMENTS AND DIMENSIONS TO BE VERIFIED IN FIELD

ELECTRICAL NOTES

- 1. All materials and fasteners meet 3004.4
- All electrical components listed and approved in accordance with UL48 and NEC NFPA 70.
- 3. Sign grounded according to NEC 600.7.
- Signs manufactured and listed NEC 600.3 and marked per NEC 600.4.
- 5. All branch circuits per NEC 600.5(B).1 or (B).2.
- 6. All Signs controlled by photocell or time clock per NEC 600.
- 7. One visible 20 amp disconnect per sign per circuit per NEC 600.6(A).1
- All Class 2 rated LED modules and LED power supplies will be in compliance with a nationally recognized test laboratory and NEC 600.33 (A) thru (D).



PROJECT: CVS PHARMACY DATE: 7/4/2024

PROJ. NO.: 46281 ENGINEER: RM

CLIENT: ATLAS SIGN INDUSTRIES

V5.5

units; pounds, feet unless noted otherwise

Applied Wind Loads; from ASCE 7-16

$p_{net} = \lambda K_{zt} p_{net}$	30		(ASCE 30).4-1)		
λ=	1.21	(ASCE Fig. 30.4-1)				
$K_{zt}=$	1.0	(unless unusual landscape)				
V=	115	mph	Exposure=	С		
Area=	4.68	ft ²				
max. height=	14.17	ft				
p _{net30} =	23.80	psf			$p_{net} = 28.80$	psf
p _{net30} =	-31.90	psf			p _{net} = -38.60	psf

Loads on 0.25" Dia. Lag Screws - Letter / Logo to Wall (LRFD):

<u> </u>	3 , ,	
Pnet=	See Above=	38.60 psf
Tributary Area per Logo=	A _{Trib} =(2'-4.5")*(1'-11.625")=	4.676 ft ² <governs< td=""></governs<>
Tributary Area per Letter=	A _{Trib} =(1'-10.25")*(1'-10.5")=	3.477 ft ²
Wind Load=	WL=Pnet*ATrib=	180 lbs
Dead Load=	DL=1.2*10psf*ATrib=	56 lbs
#screws=	=	3 screws
dia.=	=	0.250 in
Tension per screw=	Tu=WL/#screws=	60 lbs
Shear per screw=	Vu=DL/#screws=	19 lbs



PROJECT: CVS PHARMACY
PROJ. NO.: 46281

DATE: 7/4/2024
ENGINEER: RM

CLIENT: ATLAS SIGN INDUSTRIES

LAG SCREWS (LRFD) - SOLID WOOD TO SOLID ALUMINUM - WITHDRAWAL AND SINGLE SHEAR LATERAL

	FACTORED FASTENER LO Wu 60 lb	ADING Withdrawal Load	MAIN MEMBER DOUGLAS FIR-LARC	SIDE MEMBER H ALUMINUM 6061-T6	
INPUT	Z _u 19 lb FASTENER DIMENSIONS	Lateral Load	G 0.5 t _m 1.5 in	F_u 42 ksi t_s 0.063 in	Ultimate Strength Thickness
DESIGN	L _m 1.5 in D 0.250 in W 0 in	Length into Main MBR Nominal Diameter Washer	θ <u>90</u> de		n Member End Grain (x)
3	g 2 in	Gap		-	

 p_{min} 1 in Minimum dowel penetration for lateral loading [NDS 11.1.3.7]

p 1.5 in Actual dowel penetration based on selected dowel length

STANDARD HEX LAG SCREWS [NDS Appendix Table L2]

DOWEL BEARING CALCULATIONS

⊦ _{e,II}	5600 p)SI		Dowel bearing strength, perpendicular to grain [NDS Table 11.3.2 Footnote 2]
$F_{e,perp}$	4465.5 p	si		Dowel bearing strength, parallel to grain [NDS Table 11.3.2 Footnote 2]
F_{em}	4465.5 p	si F _e	63000 psi	Dowel bearing strength - Hankinson formula [NDS 11.3-11] & Steel [NDS Comm. I2]
L_{m}	1.5 ir	n L _s	0.063 in	Dowel bearing length
q_{m}	772.52 lb	os/in q _s	10899 lbs/in	Dowel bearing resistance [AWC Techincal Report 12] - D _r Assumption
$M_{\rm m}$	60.407 ir	n-lbs M _s	60.407 in-lbs	Dowel moment resistance based [AWC Technical Report 12] - D _r Assumption

YIELD MODE DOWEL EQUATIONS [AWC Technical Report 12 Table 1-1]

3	246.33 lb	P 686.64					R _d 2.7875	K_D	2.23	K _θ	1.25
П	56.338 lb	P 157.04	A 0.0003 B	2.7815	C	-445.4	R _d 2.7875	K_D	2.23		
III_{m}	63.078 lb	P 175.83	A 0.0004 B	2.75	C	-495	R _d 2.7875	K_D	2.23		
III_s	12.435 lb	P 34.662	A 0.0007 B	2.0315	C	-71.22	R_d 2.7875	K_D	2.23		
IV	21.235 lb	P 59.192	A 0.0007 B	2	C	-120.8	R_d 2.7875	K_D	2.23		
		Ref Value	Adjustment Factors [NDS]								

Z 12.435 lb Ref Value Adjustment Factors [NDS Table Z' 26.859 lb Adj Value C_M C_t C_g C_g

C _M	C _t	Cg	$C_{\!\scriptscriptstyle\Delta}$	C _d	C_{eg}	C _{st}	C _{di}	C _{tn}	K _F	ф	λ
1	1	1	1		1		1	1	3.32	0.65	1

WITHDRAWAL LOADING [NDS 11.2.1]

W 225 lb/in Reference Value [NDS 11.2-1]

W' 486 lb/in Adj Value

 $p_{t,req} \;\; 0.1238 \; in \;\;\;\;\;$ Required thread penetration for withdrawal

p_{t,req} 0.125 in -->Rounded up to nearest 1/8"

 $p_{t,ovr}$ 1.500 in Override for additional thread penetration

p_{t,sel} 1.500 in

RATIO 0.696 PASS

COMBINED LATERAL AND WITHDRAWAL LOADING [NDS 11.4.1]

 α 1.2694 rad = 72.73 deg

Z_u' 63 lb

 Z_{α} ' 220.65 lb Based on $p_{t,sel}$

RATIO 0.286 PASS

Adjustment Factors [NDS Table 10.3.1]

C _M	C _t	C_{eg}	K _F	ф	λ	
1	1	1	3.32	0.65	1	



2024 Rebranding Conversion

LOCATION #02149

501 King Street Alexandria, VA 22314

CS#

SO# 193797

DATE: 04/11/2024 REV: 08/20/2024



Existing Signage Overview

CODE:


Code allows for a max of one square foot per linear foot of building frontage. Signs cannot be higher than 20 Feet above grade.

- measured from bottom of sign .

Signs can only be mounted flat against wall.

Face changes require a permit



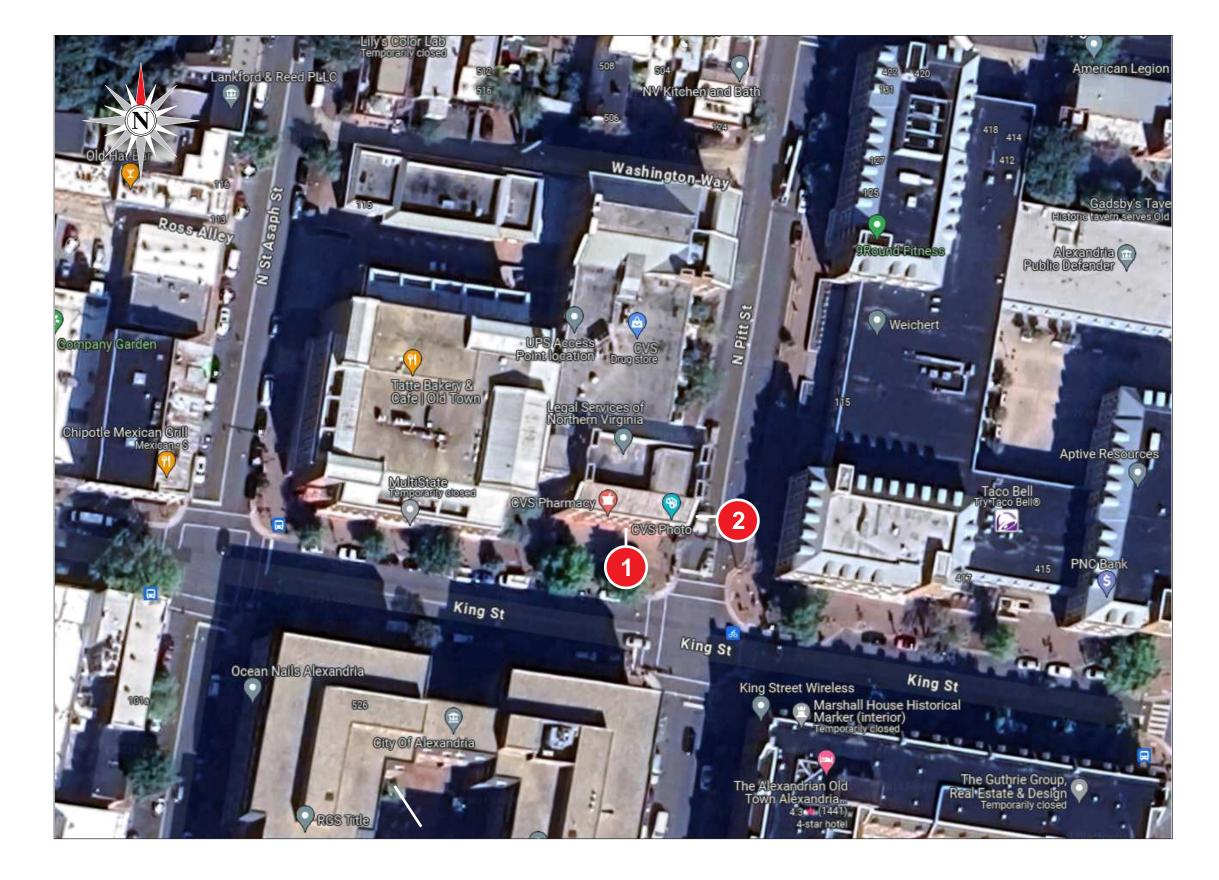

SITE PLAN/OVERHEAD VIEW



Revisions:	
National Headquarters: 1077 West Blue Heron Blvd. 08.20.2024 - add dim	ensions and notes
West Palm Beach, Florida 33404	
800.772.7932	
www.atlasbtw.com	






PM: SG	Address: 501 King Street
Drawn By: NR	City State: Alexandria, VA
Date: 04.11.2024	Drawing Number: 193797



EXISTING CONDITIONS - LONG FRONT ELEVATION

1. REMOVE EXISTING HALO LIT "CVS" LETTERSET & REPLACE W/ NEW - FASCIA RESTORATION

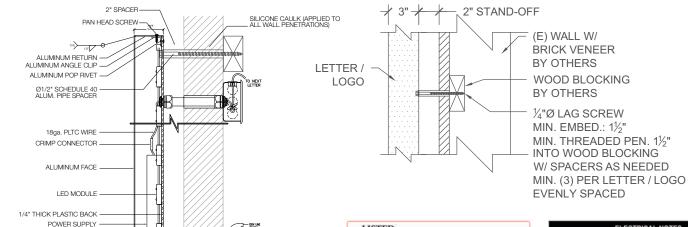

12ga. STRANDED THHN

- WIRE, FITTING, &
CONDUIT (TO PRIMARY)

- JUNCTION BOX

- WIRE NUT

West Palm Beach, Florida 33404

800.772.7932

www.atlasbtw.com

LISTED

MET

SNF 821

Total Amps

Visible Disconnects

Circuits

Typical Section - 3" Deep Halo Lit Letter - Self Contained

Complies with

- 1. All materials and fasteners meet 3004.4 2. All electrical components listed and approved in accordance with UL48 and NEC NFPA 70.
- Sign grounded according to NEC 600.7.
- . Signs manufactured and listed NEC 600.3 and marked per
- 5. All branch circuits per NEC 600.5(B).1 or (B).2.
- 6. All Signs controlled by photocell or time clock per NEC 600. 7. One visible 20 amp disconnect per sign per circuit per
- 8. All Class 2 rated LED modules and LED power supplies will be in compliance with a nationally recognized test laboratory and NEC 600.33 (A) thru (D).



PROPOSED CONDITIONS - LONG FRONT ELEVATION

CODE:

Code allows for a max of one square foot per linear foot of building frontage. Signs cannot be higher than 20 Feet above grade.

- measured from bottom of sign.

Signs can only be mounted flat against wall.

Face changes require a permit







SCALE: 1/4" = 1'-0"

ONE [1] REQUIRED - MANUFACTURE & INSTALL

33.08 SQ. FT.



JUNCTION BOX

FLECTRICAL CONDUIT & FITTING

National Headquarters: 1077 West Blue Heron Blvd.

UL48

Sign Certification

E212706

120V Primary / 12V Secondary

(1) 120VAC/20 amp Dedicated

(2) GEPS12-60 @ 0.65 Amps Ea.

1.3 Total Amps

(1) 120 VAC 20 Amp






PM: SG	Address: 501 King Street
Drawn By: NR	City State: Alexandria, VA
Date: 04.11.2024	Drawing Number: 193797



EXISTING CONDITIONS - SIDE ELEVATION

2. REMOVE EXISTING HALO LIT "CVS" LETTERSET & REPLACE W/ NEW - FASCIA RESTORATION

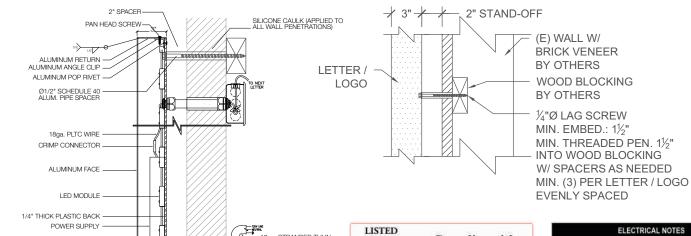

MET

SNF 821

Total Amps

Visible Disconnects

Circuits

12ga. STRANDED THHN

- WIRE, FITTING, & CONDUIT (TO PRIMARY)

- JUNCTION BOX

West Palm Beach, Florida 33404

800.772.7932

www.atlasbtw.com

Typical Section - 3" Deep Halo Lit Letter - Self Contained

Complies with

- 1. All materials and fasteners meet 3004.4 2. All electrical components listed and approved in accordance with
- UL48 and NEC NFPA 70. . Sign grounded according to NEC 600.7.
- . Signs manufactured and listed NEC 600.3 and marked per
- 5. All branch circuits per NEC 600.5(B).1 or (B).2.
- 6. All Signs controlled by photocell or time clock per NEC 600. . One visible 20 amp disconnect per sign per circuit per
- 8. All Class 2 rated LED modules and LED power supplies will be in compliance with a nationally recognized test laboratory and NEC 600.33 (A) thru (D).



PROPOSED - SIDE ELEVATION

CODE:

Code allows for a max of one square foot per linear foot of building frontage. Signs cannot be higher than 20 Feet above grade.

- measured from bottom of sign.

Signs can only be mounted flat against wall.

Face changes require a permit







SCALE: 1/4" = 1'-0"

ONE [1] REQUIRED - MANUFACTURE & INSTALL

33.08 SQ. FT.



JUNCTION BOX

ELECTRICAL CONDUIT & FITTING

National Headquarters: 1077 West Blue Heron Blvd.

1.3 Total Amps

(1) 120 VAC 20 Amp

UL48

Sign Certification

E212706

(1) 120VAC/20 amp Dedicated

(2) GEPS12-60 @ 0.65 Amps Ea.





PM: SG	Address: 501 King Street
Drawn By: NR	City State: Alexandria, VA
Date: 04.11.2024	Drawing Number: 193797



EXISTING CONDITIONS

SCOPE:

3. LEAVE EXISTING HOURS PLAQUE AS IS. NO WORK REQUIRED



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PM: SG	Address: 501 King Street
Drawn By: NR	City State: Alexandria, VA
Date: 04.11.2024	Drawing Number: 193797