

Special Use Permit # 2023-00107 1508 Mount Vernon Avenue -Junction Bakery & Bistro – Increase in Permitted Floor Area Ratio


Application	General Data		
Request: Public hearing and	Planning Commission	March 5, 2024	
consideration of a Special Use	Hearing:		
Permit to increase FAR up to	City Council	March 16, 2024	
.75	Hearing:		
Address: 1508 Mount Vernon	Zone:	CL/Commercial Low	
Avenue			
Applicant: Noe Landini	Small Area Plan:	Potomac West	

Staff Recommendation: APPROVAL subject to compliance with all applicable codes and ordinances and the recommended permit conditions found in Section III of this report.

Staff Reviewers:

Patrick Silva, Urban Planner, patrick.silva@alexandriava.gov
Ann Horowitz, Principal Planner, ann.horowitz@alexandriava.gov

PLANNING COMMISSION ACTION, MARCH 5, 2024: On a motion by Commissioner Lyle, seconded by Vice Chair McMahon, the Planning Commission voted to recommended approval of Special Use Permit #2023-00107, as submitted. The motion carried on a vote of 7-0.

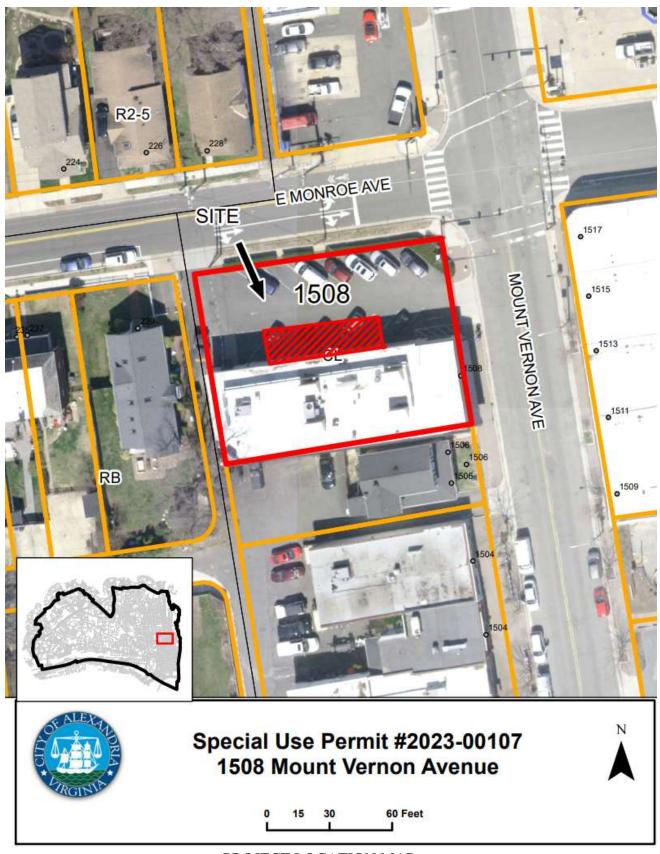

PROJECT LOCATION MAP

I. DISCUSSION

The applicant, Noe Landini, requests Special Use Permit approval for an increase in the permitted floor area ratio, pursuant to Section 4-106(B)(1) of the Zoning Ordinance, to accommodate the construction of a new 720 square foot covered outdoor dining patio at Junction Bakery & Bistro located at 1508 Mount Vernon Avenue.

SITE DESCRIPTION

The subject site is located on one corner parcel of record. The parcel has 90 feet of frontage on Mount Vernon Avenue, 120 feet of frontage on East Monroe Avenue, and a lot area of 11,244 square feet. It is developed with a one-story 5,348 square foot commercial building with an eight-space surface parking lot, including one loading space located on-site (Figure 1).

A mix of commercial uses — personal service, restaurant, retail, and automobile service stations — surround the restaurant to the east, north, and south while single family dwellings and townhouses are located to the west.



Figure 1: Site Context

BACKGROUND

In February 1996, City Council first approved Special Use Permit #1995-00205 for a restaurant use, known as Mancini's Restaurant, at the subject site. In November 1996, City Council approved both Special Use Permit #1996-00156 for additional seating, outdoor dining, and an increase in the hours of operation for the business as well as Encroachment #1996-00005 to permit eight seats of outdoor dining in the public right of way along Mount Vernon Avenue located in front of the

business and for an awning. In November 1998, City Council approved Special Use Permit #1998-00119 which authorized live entertainment and on-premises alcohol sales. In March 1999, City Council approved Encroachment #1999-00001 to permit the use of the public alleyway at the rear of the restaurant for customer and employee parking. In May 2001, City Council approved Special Use Permit #2001-00020 to allow extended hours of operation. In June 2002, City Council approved Special Use Permit #2002-00024, a one-year review of the previous approval, which also addressed resident concerns related to noise from supply deliveries and employees parking on nearby streets. In November 2015, staff administratively approved Special Use Permit #2015-00102 for a change of ownership for the existing restaurant, which included a retail bakery and accessory catering, from Barbara Mancini to Noe Landini who began operating the business as Junction Bakery & Bistro. In January 2016, City Council approved Special Use Permit #2016-00077 which allowed the business to begin selling off-premises beer and wine. Most recently, in April 2023, staff administratively approved Special Use Permit #2023-00012 for a minor amendment to Special Use Permit #2016-00077 to allow the applicant to add 32 additional seats of outdoor dining in the on-site surface parking lot reducing the total amount of available off-street spaces from twelve to nine.



Figure 2: Junction Bakery from Mt. Vernon Ave.

PROPOSAL

The applicant requests Special Use Permit approval to increase FAR up to .75 at the subject site. The applicant's proposal would add a new 720 square foot covered outdoor dining patio, as an addition to the north side of the building and in the on-site surface parking lot, where the 32 outdoor dining seats now exist. A Special Use Permit is required to approve the proposed covered patio as the 720 square feet of floor area would result in a floor area ratio of .53, whereas Section 4-106(B)(1) of the Zoning Ordinance states that the maximum floor area ratio permitted for a nonresidential property by right is 0.5. Pursuant to Section 4-106(B)(1) of the Zoning Ordinance,

the floor area ratio for a nonresidential property in the CL/Commercial Low zone may be increased to an amount not to exceed .75 with approval of a Special Use Permit.

The proposed covered patio would occupy one parking space in the on-site lot, bringing the available off-street parking total to seven spaces.

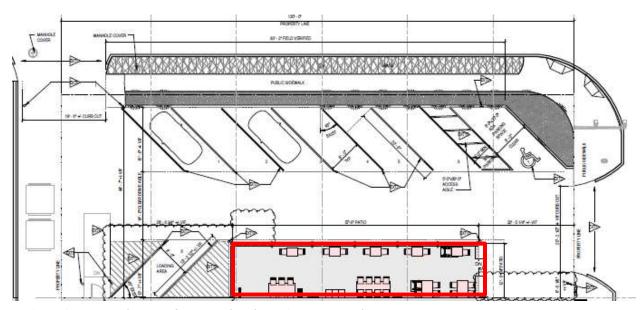


Figure 3: Proposed area to be covered and a patio constructed

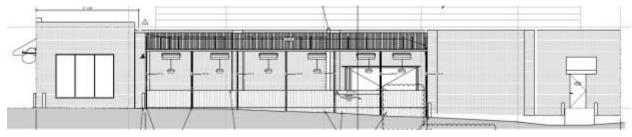


Figure 4: South facing patio elevation

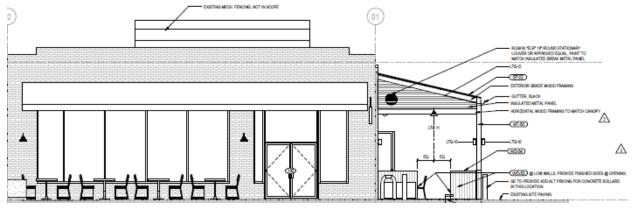


Figure 5: West facing patio elevation

PARKING

The business currently occupies 5,348 square feet of floor area for a restaurant and is approved to operate up to 40 seats of outdoor dining. Pursuant to Section 8-200(A)(17)(a) of the Zoning Ordinance, a restaurant located within the City's Enhanced Transit Area is required to provide a minimum of one off-street parking space for every 1,000 square feet of floor area. Pursuant to Section 8-200(A)(17)(c) of the Zoning Ordinance, the first 20 outdoor seats are exempt from being factored into parking requirements, and the area occupied by each seat over 20 seats is calculated as 15 square feet per seat. With a maximum of 40 outdoor seats approved, this would constitute an additional 300 square feet for purposes of off-street parking requirement calculations. The existing 5,348 square foot indoor restaurant and the 300 square feet for outdoor dining, totaling 5,648 square feet, results in a parking requirement of six off-street spaces. The applicant meets this requirement via the seven off-street parking spaces which will be provided in their on-site surface parking lot.



Figure 6: Future patio designated with barriers (left) and existing parking area (right)

ZONING/MASTER PLAN DESIGNATION

The subject property is located within the CL/Commercial Low zone and the Mount Vernon Urban Overlay zone. Section 4-102.1 (B) of the Zoning Ordinance allows for a restaurant with outdoor dining up to 40 seats with approval of an Administrative Special Use Permit. Section 4-106(B)(1) states that the floor area ratio of a nonresidential property located within the CL/Commercial Low zone may be increased to an amount not to exceed .75 with Special Use Permit approval.

The proposed use is consistent with the Potomac West chapter of the Master Plan which designates

the property for commercial use. It also complies with the Mount Vernon Avenue Business Area Plan, which establishes a mix of residential, retail, and commercial uses in the Monroe Avenue Gateway area, promoting neighborhood-oriented restaurants.

II. STAFF ANALYSIS

Staff supports the applicant's request for an increase in the permitted floor area ratio to .53 to accommodate the construction of a new covered outdoor dining patio addition at 1508 Mount Vernon Avenue. Staff finds that Special Use Permit criteria, as outlined in Section 11-504(A) of the Zoning Ordinance, are satisfied to allow the minor increase in FAR. The Special Use Permit request:

1. Will not adversely affect the health or safety of persons residing or working in the neighborhood of the proposed use;

The increased floor area and construction of a covered patio would have no adverse effects on the health and safety of adjacent residents and employees as the proposed use would not adversely affect the safety of the motoring public and of pedestrians using the facility and the area immediately surrounding the site. The new construction of a covered patio would be contained well within the property line and would be located away from adjacent residential uses. In addition, no aspect of the patio's construction would result in inadequate pedestrian and/or vehicular access. All required entrance and exit drives would be provided and designed so as to prevent traffic hazards. Furthermore, all aspects of the covered patio construction would need to comply with applicable building and fire codes, ensuring the safety of patrons, employees, and neighboring properties.

2. Will not be detrimental to the public welfare or injurious to property or improvements in the neighborhood; and

Increasing the allowable floor area ratio to allow for the construction of the proposed covered patio would not adversely impact neighboring properties, and in fact, benefit the neighborhood by maintaining street vitality and providing outdoor dining along the Mount Vernon Avenue corridor year-round. Staff finds that the proposed increase in floor area ratio of 0.03 is quite modest and would not contribute to an overall appearance of excessive density at the site or otherwise adversely impact light conditions and air quality for neighboring properties. Furthermore, the proposed use will be constructed, arranged, and operated in such a way so as not to dominate the immediate vicinity or interfere with the development and use of neighboring properties as the covered patio's highest point would be below that of the roofline of the existing building and would be screened from nearby residential properties by both fencing and landscape elements.

3. Will substantially conform to the master plan of the city.

The Special Use Permit request is consistent with the recommended use of the site as a commercial property as envisioned in the Potomac West Small Area Plan and the Mount Vernon Avenue Business Area Plan. The configuration of the proposed covered patio is in keeping with the building form and design approach recommendations for new construction as recommended in Section 6.2 of the Mount Vernon Business Area Plan, including the focus on new construction which reflects the scale of existing buildings, appropriate building setbacks to minimize impacts on adjacent residential properties, and ground level commercial storefronts which contribute to the vitality of the streetscape and the pedestrian experience.

Subject to the conditions stated in Section III of this report, staff recommends approval of the Special Use Permit request.

III. RECOMMENDED CONDITIONS

Staff recommends **approval** subject to compliance with all applicable codes and ordinances and the following conditions:

- 1. The Special Use Permit shall be granted to the applicant only or to any business or entity in which the applicant has a controlling interest. (P&Z)
- 2. The roof and patio construction shall be consistent with the application materials submitted on January 25, 2024.
- 3. The Director of Planning and Zoning shall review the Special Use Permit one year after approval and shall docket the matter for consideration by the Planning Commission and City Council if (a) there have been documented violations of the permit conditions which were not corrected immediately, constitute repeat violations or which create a direct and immediate adverse zoning impact on the surrounding community; (b) the Director has received a request from any person to docket the permit for review as a result of a complaint that rises to the level of a violation; or (c) the Director has determined that there are problems with the operation of the use and that new or revised conditions are needed. (P&Z)

<u>Staff Note:</u> In accordance with section 11-506(c) of the zoning ordinance, construction or operation shall be commenced and diligently and substantially pursued within 18 months of the date of granting of a Special Use Permit by City Council or the special use permit shall become void.

IV. CITY DEPARTMENT COMMENTS

Legend: C - code requirement R - recommendation S - suggestion F - finding

<u>Transportation & Environmental Services:</u>

- C-1 The applicant shall comply with the City of Alexandria's Solid Waste Control, Title 5, Chapter 1, which sets forth the requirements for the recycling of materials (Sec. 5-1-99). In order to comply with this code requirement, the applicant shall provide a completed Recycling Implementation Plan (RIP) Form within 60 days of SUP approval. Contact the City's Recycling Program Coordinator at (703) 746-4410, or via e-mail at commercialrecycling@alexandriava.gov, for information about completing this form. (T&ES-DROW)
- C-2 The applicant shall comply with the City of Alexandria's Noise Control Code, Title 11, Chapter 5, which sets the maximum permissible noise level as measured at the property line. (T&ES-DROW)
- C-3 Section 5-1-42- Collection by Private collectors. (c) Time of collection. Solid waste shall be collected from all premises not serviced by the city at least once each week. No collections may be made between the hours of 11:00 p.m. and 7:00 a.m. (6:00 a.m. from May 1, through September 30) if the collection area is less than 500 feet from a residential area. (T&ES-DROW)

Code Enforcement:

F-1 Building permit is required.

Fire:

No comments or concerns.

Parks and Recreation:

No comments or concerns.

Police Department:

No comments or concerns.

Health Department:

No comments or concerns.

STAFF: Tony LaColla, Division Chief, Land Use Services

Ann Horowitz, Principal Planner Patrick Silva, Urban Planner



February 26, 2024

Karl W. Moritz, Director
Department of Planning and Zoning
City of Alexandria
City Hall, Room 2100
Alexandria, VA 22314

RE: SUP2023-0107


1508 Mt. Vernon Ave Junction Bakery

Dear Mr. Moritz,

The Del Ray Citizens Association (DRCA) voted to support the extension of the FAR as requested in SUP 2023-0107 at 1508 Mt. Vernon Ave for Junction Bakery with the following recommendations:

- Recommend installation of bike racks along the northeast corner of the building.
- Recommend the mural be preserved and / or replaced / expanded if affected by the new opening to the patio.
- Recommend a striped pedestrian pathway be provided along the patio / deck to the sidewalk to allow safe passageway in the parking lot.

The Del Ray Citizens Association Land Use Committee (DRCA LUC) held a public Zoom meeting on Tuesday, January 30, 2024. The applicant and a city staff representative were in attendance and the presentation prepared by the LUC of the proposed SUP was reviewed. Questions and comments were addressed by the applicant and city staff.

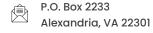



On Thursday, February 15, 2024 during the regular DRCA Zoom membership meeting, the membership reviewed the presentation, the motion set forth by the LUC was discussed, and the membership voted to support the SUP with the recommendations.

Sincerely,

Kristine Hesse, DRCA LUC Co-Chair Lisa Lettieri, DRCA LUC Co-Chair Katie Waynick DRCA President

cc: Patrick Silva, P & Z

Noe Landini, Junction Bakery

City of Alexandria, Virginia

MEMORANDUM

DATE: FEBRUARY 29, 2024

TO: CHAIR NATHAN MACEK

AND MEMBERS OF THE PLANNING COMMISSION

FROM: KARL W. MORITZ, DIRECTOR

DEPARTMENT OF PLANNING & ZONING

SUBJECT: DOCKET ITEM #3 – SUP #2023-00107

1508 MOUNT VERNON AVENUE –

JUNCTION BAKERY & BISTRO INCREASE IN FAR

In this memorandum, staff responds to the Del Ray Civic Association (DRCA) recommendations for SUP #2023-00197, which were emailed to the commission on February 26. The SUP request is for additional FAR for the construction of a canopy at 1508 Mount Vernon Avenue. In addition, Commissioner Lyle separately requested that staff investigate the costs associated with implementing the DRCA recommendations and these are also included in the memorandum.

Given that the DRCA recommendations for the placement of a bicycle rack, maintenance of the mural, and installation of a striped pedestrian path do not directly offset an impact of the request for additional FAR, staff does not recommend additional SUP conditions. The potential for impacts associated with additional FAR sought through an SUP, primarily relate to the physical and aesthetic implications of added bulk on the site, surrounding buildings, and the neighborhood. A bicycle rack and striped pedestrian path do not offset the proposed additional bulk requested in this SUP. Conditions for these two features may have been appropriate to consider under SUP #2023-00012, that approved the outdoor dining; however, no such conditions were required at the time of that approval. A condition for a mural also does not offset impacts of added bulk or the restaurant and outdoor dining use and would be appropriate for review separately under a sign permit.

Should the applicant elect to independently address the DRCA recommendations, these must be addressed in compliance with City regulations.

Secondly, staff gathered estimates, at Commissioner Lyle's request, for each of the DRCA recommendations. A bike rack purchase and installation would average \$500; mural repainting could range between \$3,250 to \$6,500; and approximate costs for a striped pedestrian pathway would be \$700.

Staff continues to recommend approval of SUP #2023-00107 subject to the existing conditions in the staff report.



APPLICATION SPECIAL USE PERMIT

SPECIAL U	SE PERMIT #	_			
PROPERTY LOCATION:					
TAX MAP REFERENCE:	ZONE:				
APPLICANT:					
Name:					
Address:					
PROPOSED USE:					
	lies for a Special Use Permit in accordance was 1992 Zoning Ordinance of the City of Alexand				
permission to the City of Alexa	otained permission from the property ow ndria staff and Commission Members to land etc., connected with the application.				
permission to the City of Alexandria	obtained permission from the property ow a to post placard notice on the property for w 7, Section 4-1404(D)(7) of the 1992 Zoning C	hich this application			
including all surveys, drawings, etc accurate to the best of their knowle materials, drawings or illustrations representations made to the Direc the applicant unless those materi illustrative of general plans and in	ests that all of the information herein provided, required to be furnished by the applicant and edge and belief. The applicant is hereby not as submitted in support of this application at tor of Planning and Zoning on this application all also or representations are clearly stated to attentions, subject to substantial revision, put a Zoning Ordinance of the City of Alexandria,	are true, correct and ified that any written and any specific oral on will be binding on be non-binding or rsuant to Article XI,			
	Noe Landin	i			
Print Name of Applicant or Agent	Signature	Date			
Mailing/Street Address	Telephone #	Fax#			
City and State Zip Code	Email addres				

PROPE	ERTY OWNER'S AUTHORIZATION		
As the	property owner of		I hereby
	(Property Address)		•
grant th	ne applicant authorization to apply for the		use as
J	(use)		
describ	ed in this application.		
Name [.]		Phone_	
riamo	Please Print		
Δddress	S:	_ Email:	
			
Signat	_{ure:} Noe Landini	Date:	
Olgilat	uie.	Date.	
1.	Floor Plan and Plot Plan. As a part of this applic site plan with the parking layout of the proposed floor and site plans. The Planning Director may request which adequately justifies a waiver.	use. The SUP application checklist	lists the requirements of the
	[] Required floor plan and plot/site plan attac	hed.	
	[] Requesting a waiver. See attached written	request.	
2.	The applicant is the <i>(check one):</i>		
	[] Owner		
	[] Contract Purchaser		
	[] Lessee or		
	[] Other: of the	e subject property.	
	ne name, address and percent of ownership of ar the entity is a corporation or partnership, in which o		
			
		· · · · · · · · · · · · · · · · · · ·	· · · · · · · · · · · · · · · · · · ·

OWNERSHIP AND DISCLOSURE STATEMENT

Use additional sheets if necessary

interest in the appli owner of more than	cant, unless th three percent.	e entity is a corporation or partne	of any person or entity owning an ership, in which case identify each aclude any legal or equitable interest of the application.		
Name		Address	Percent of Ownership		
1.					
2.					
3.					
interest in the proper unless the entity is a percent. The term of	ty located at corporation or p wnership interes	ess and percent of ownership of an partnership, in which case identify eat shall include any legal or equitable is the subject of the application.	(address), ach owner of more than three		
Name		Address	Percent of Ownership		
1.					
2.					
3.					
3. Business or Financial Relationships. Each person or entity indicated above in sections 1 and 2, with an ownership interest in the applicant or in the subject property are require to disclose any business or financial relationship, as defined by Section 11-350 of the Zoning Ordinance, existing at the time of this application, or within the12-month period prior to the submission of this application with any member of the Alexandria City Council, Planning Commission, Board of Zoning Appeals or either Boards of Architectural Review. All fields must be filled out completely. Do not leave blank. (If there are no relationships please indicated each person or entity and "None" in the corresponding fields). For a list of current council, commission and board members, as well as the definition of business and financial relationship, click here.					
Name of person	or entity	Relationship as defined by	Member of the Approving		
		Section 11-350 of the Zoning Ordinance	Body (i.e. City Council, Planning Commission, etc.)		
1.		J. W.I.W.IIV			
2					
2.					
3.					
NOTE Durings of		ahina af tha tura da anihadin Caa	4.050 that arise of tan the filling of		
As the applicant of	NOTE: Business or financial relationships of the type described in Sec. 11-350 that arise after the filing of this application and before each public hearing must be disclosed prior to the public hearings. As the applicant or the applicant's authorized agent, I hereby attest to the best of my ability that the information provided above is true and correct.				
		N	oe Landini		
Date	Printed	I Name	Signature		

If property owner or applicant is being represented by an authorized agent such as an attorney, realtor, or which there is some form of compensation, does this agent or the business in which the agent is employed business license to operate in the City of Alexandria, Virginia?	
[] Yes. Provide proof of current City business license	
[] No. The agent shall obtain a business license prior to filing application, if required by the City Code.	
NARRATIVE DESCRIPTION	
3. The applicant shall describe below the nature of the request in detail so that the Planning Common Council can understand the nature of the operation and the use. The description should fully discuss that activity. (Attach additional sheets if necessary.)	

USE CHARACTERISTICS

4.	[] a no [] an o [] an o	oposed special use permit request is for (check one): ew use requiring a special use permit, expansion or change to an existing use without a special use permit, expansion or change to an existing use with a special use permit, er. Please describe:
5.	Please	describe the capacity of the proposed use:
	A.	How many patrons, clients, pupils and other such users do you expect? Specify time period (i.e., day, hour, or shift).
	B.	How many employees, staff and other personnel do you expect? Specify time period (i.e., day, hour, or shift).
6.	Please	describe the proposed hours and days of operation of the proposed use:
	Day:	Hours:
		
7.	Please	describe any potential noise emanating from the proposed use.
	A.	Describe the noise levels anticipated from all mechanical equipment and patrons.
	B.	How will the noise be controlled?

A. What type of trash and garbage will be generated by the use? (i. B. How much trash and garbage will be generated by the use? (i.e. week)	e. office paper, food wrappers)
B. How much trash and garbage will be generated by the use? (i.e. week)	
week)	
C. How often will trash be collected?	
D. How will you prevent littering on the property, streets and nearby	
Will any hazardous materials, as defined by the state or federal government the property?	ent, be handled, stored, or gener

handl	led, stored, or	generated on the property?	
[]Y	es. [] No.	
If yes		name, monthly quantity, and specific disposal method below:	
			_
What	methods are	proposed to ensure the safety of nearby residents, employees and patrons?	-
			_
			-
	L SALES		_
—			-
 DHOI	L SALES	oposed use include the sale of beer, wine, or mixed drinks?	_
	L SALES		-
	Will the pro	oposed use include the sale of beer, wine, or mixed drinks?	- - ABC license
	Will the pro	oposed use include the sale of beer, wine, or mixed drinks? [] No cribe existing (if applicable) and proposed alcohol sales below, including if the	- - ABC license
	Will the pro	oposed use include the sale of beer, wine, or mixed drinks? [] No cribe existing (if applicable) and proposed alcohol sales below, including if the	- ABC license
	Will the pro	oposed use include the sale of beer, wine, or mixed drinks? [] No cribe existing (if applicable) and proposed alcohol sales below, including if the	- ABC license



PARKING AND ACCESS REQUIREMENTS

14.	A.	How many parking spaces of each type are provided for the proposed use:
		Standard spaces
		Compact spaces
		Handicapped accessible spaces.
		Other.
		Planning and Zoning Staff Only
	Req	uired number of spaces for use per Zoning Ordinance Section 8-200A
	Doe	es the application meet the requirement? [] Yes [] No
	B.	Where is required parking located? <i>(check one)</i> [] on-site [] off-site
DIEA		TE: Purcuant to Section 9 200 (C) of the Zening Ordinance, commercial and industrial uses may provide off
site pa or ind	arking v ustrial u	TE: Pursuant to Section 8-200 (C) of the Zoning Ordinance, commercial and industrial uses may provide off vithin 500 feet of the proposed use, provided that the off-site parking is located on land zoned for commerciauses. All other uses must provide parking on-site, except that off-street parking may be provided within 300 e with a special use permit.
	C.	If a reduction in the required parking is requested, pursuant to Section 8-100 (A) (4) or (5) of the Zoning Ordinance, complete the PARKING REDUCTION SUPPLEMENTAL APPLICATION.
		[] Parking reduction requested; see attached supplemental form
15.	Pleas	se provide information regarding loading and unloading facilities for the use:
	A.	How many loading spaces are available for the use?
		Planning and Zoning Staff Only
	R	equired number of loading spaces for use per Zoning Ordinance Section 8-200
	Е	oes the application meet the requirement?
		[]Yes []No

B.	Where are off-street loading facilities located?			
C.	During what hours of the day do you expect loading			
D.	How frequently are loading/unloading operations ex			
	reet access to the subject property adequate or are any essary to minimize impacts on traffic flow?			
СН	ARACTERISTICS			
Will t	the proposed uses be located in an existing building?	[] Yes	[] No	
Do y	ou propose to construct an addition to the building?	[] Yes	[] No	
	ou propose to construct an addition to the building? large will the addition be? square feet.	[] Yes	[] No	
How	•	[] Yes	[] No	
How	large will the addition be? square feet.			

End of Application

Supplemental application for the following uses:

Automobile	Oriented

Parking Reduction

Signs

Substandard Lot

Lot modifications requested with SUP use

Interior Floor Plan

Include labels to indicate the use of the space (doors, windows, seats, tables, counters, equipment)

If Applicable

Plan for outdoor uses

Contextual site image

Show subject site, on-site parking area, surrounding buildings, cross streets

Department of Planning and Zoning Floor Area Ratio and Open Space Calculations

COL								
Δ	Property Info	rmation						
A1.	4500 M 1			01			CL	
Αι.	Street Address						Zon	e
A2.	11,040.00		x	0.50		=	5,52	
	Total Lot Area			Floor Area Ratio A	llowed by Zone		Max	kimum Allowable Floor Area
В.	Existing Gross			Allowable Exclu	sions**			
	Basement	0.00			0.00		B1.	5,348.00 Sq. Ft.
	First Floor	5,155.00		Stairways**	0.00		J.,	Existing Gross Floor Area*
	Second Floor	0.00		Mechanical**	57.00		B2.	207.00 Sq. Ft.
	Third Floor	0.00		Attic less than 7'**	0.00			Allowable Floor Exclusions**
	Attic	0.00		Porches**	0.00		В3.	5,141.00 Sq. Ft. Existing Floor Area Minus Exclusions
	Porches	0.00			0.00			(subtract B2 from B1)
	Balcony/Deck	0.00		Lavatory***	150.00		Coi	mments for Existing Gross Floor Area
	Lavatory***	193.00		Other**	0.00			
	Other**	0.00			0.00			
D 1	Total Gross	5,348,00	D2		207.00			
C.	Proposed Gross	oss Floor Area <u>s Area</u>		Allowable Exclu	sions**			
	Basement	0.00		Basement**	0.00		C1.	
	First Floor	720.00		Stairways**	0.00			Proposed Gross Floor Area*
	Second Floor	0.00		Mechanical**	0.00		C2.	0.00 Allowable Floor Exclusions**
	Third Floor	0.00		Attic less than 7'**	0.00		00	720.00
	Attic	0.00		Porches**	0.00		C3.	Proposed Floor Area Minus Exclusions
	Porches	0.00		Balcony/Deck**	0.00			(subtract C2 from C1)
	Balcony/Deck			Lavatory***	0.00			
	Lavatory***	0.00		Other**				
	Other	0.00		Other**	0.00			Notes
C1.	Total Gross	720.00	C2	. <u>Total Exclusions</u>	0.00			*Gross floor area is the sum of <u>all areas</u> <u>under roof of a lot</u> , measured from the face
D.	Total Floor A	rea		E. Open Spa	Ce (RA & RB Zon	ies)		of exterior walls, including basements, garages, sheds, gazebos, guest buildings and other accessory buildings.
D1.	5,861.00	Sq. Ft.		E1.	s	q. Ft.		** Refer to the Zoning Ordinance (Section 2-145(B)) and consult with Zoning Staff for
	Total Floor Area (add B3 and C3)		Existing Ope	n Space			information regarding allowable exclusions. Sections may also be required for some
D2.	D2 . 5,520.00 Sq. Ft. E2 . Sq. Ft.			exclusions.				
	Total Floor Area	Allowed		Required Op-	en Space			***Lavatories may be excluded up to a

The undersigned hereby certifies and attests that, to the best of his/her knowledge, the above computations are true and correct.

Proposed Open Space

E3.


maximum of 50 square feet, per lavatory. The maximum total of excludable area for


lavatories shall be no greater than 10% of


gross floor area.

by Zone (A2)

Sq. Ft.

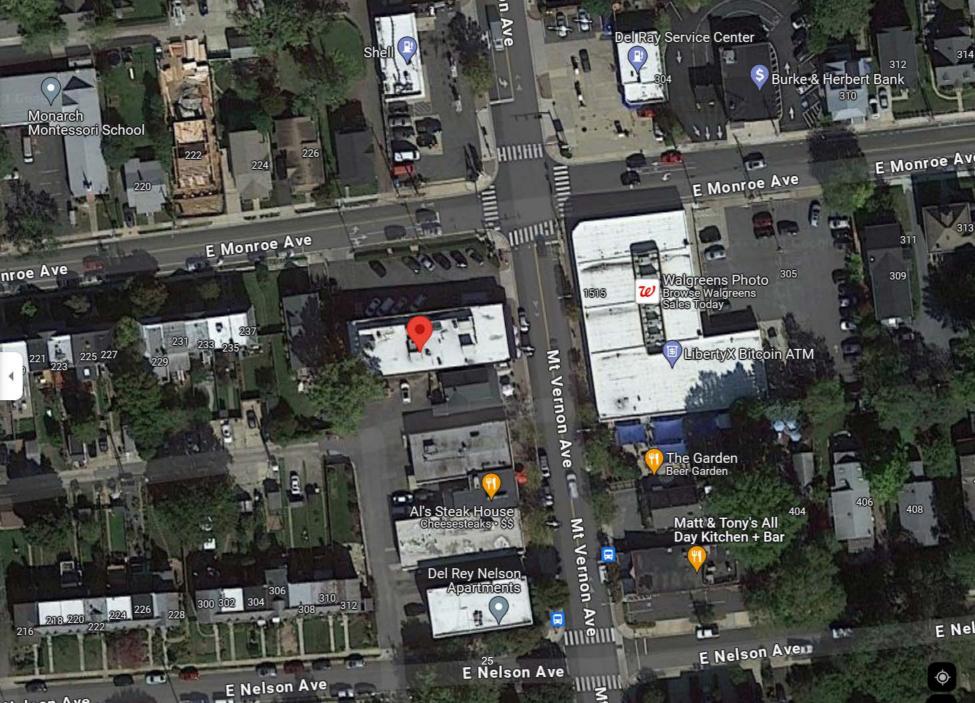

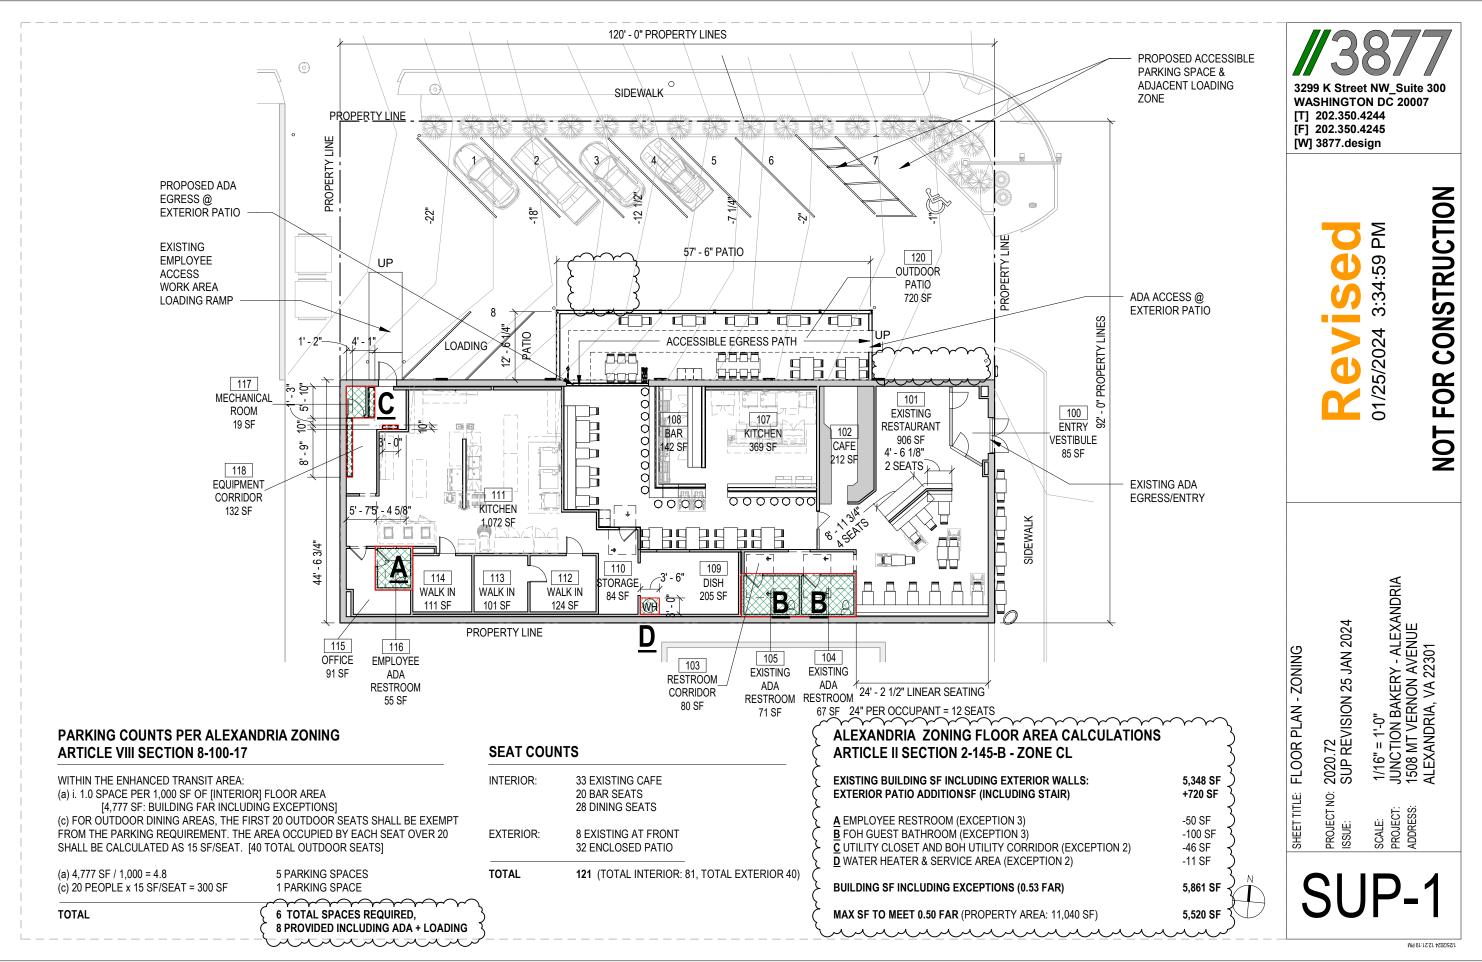

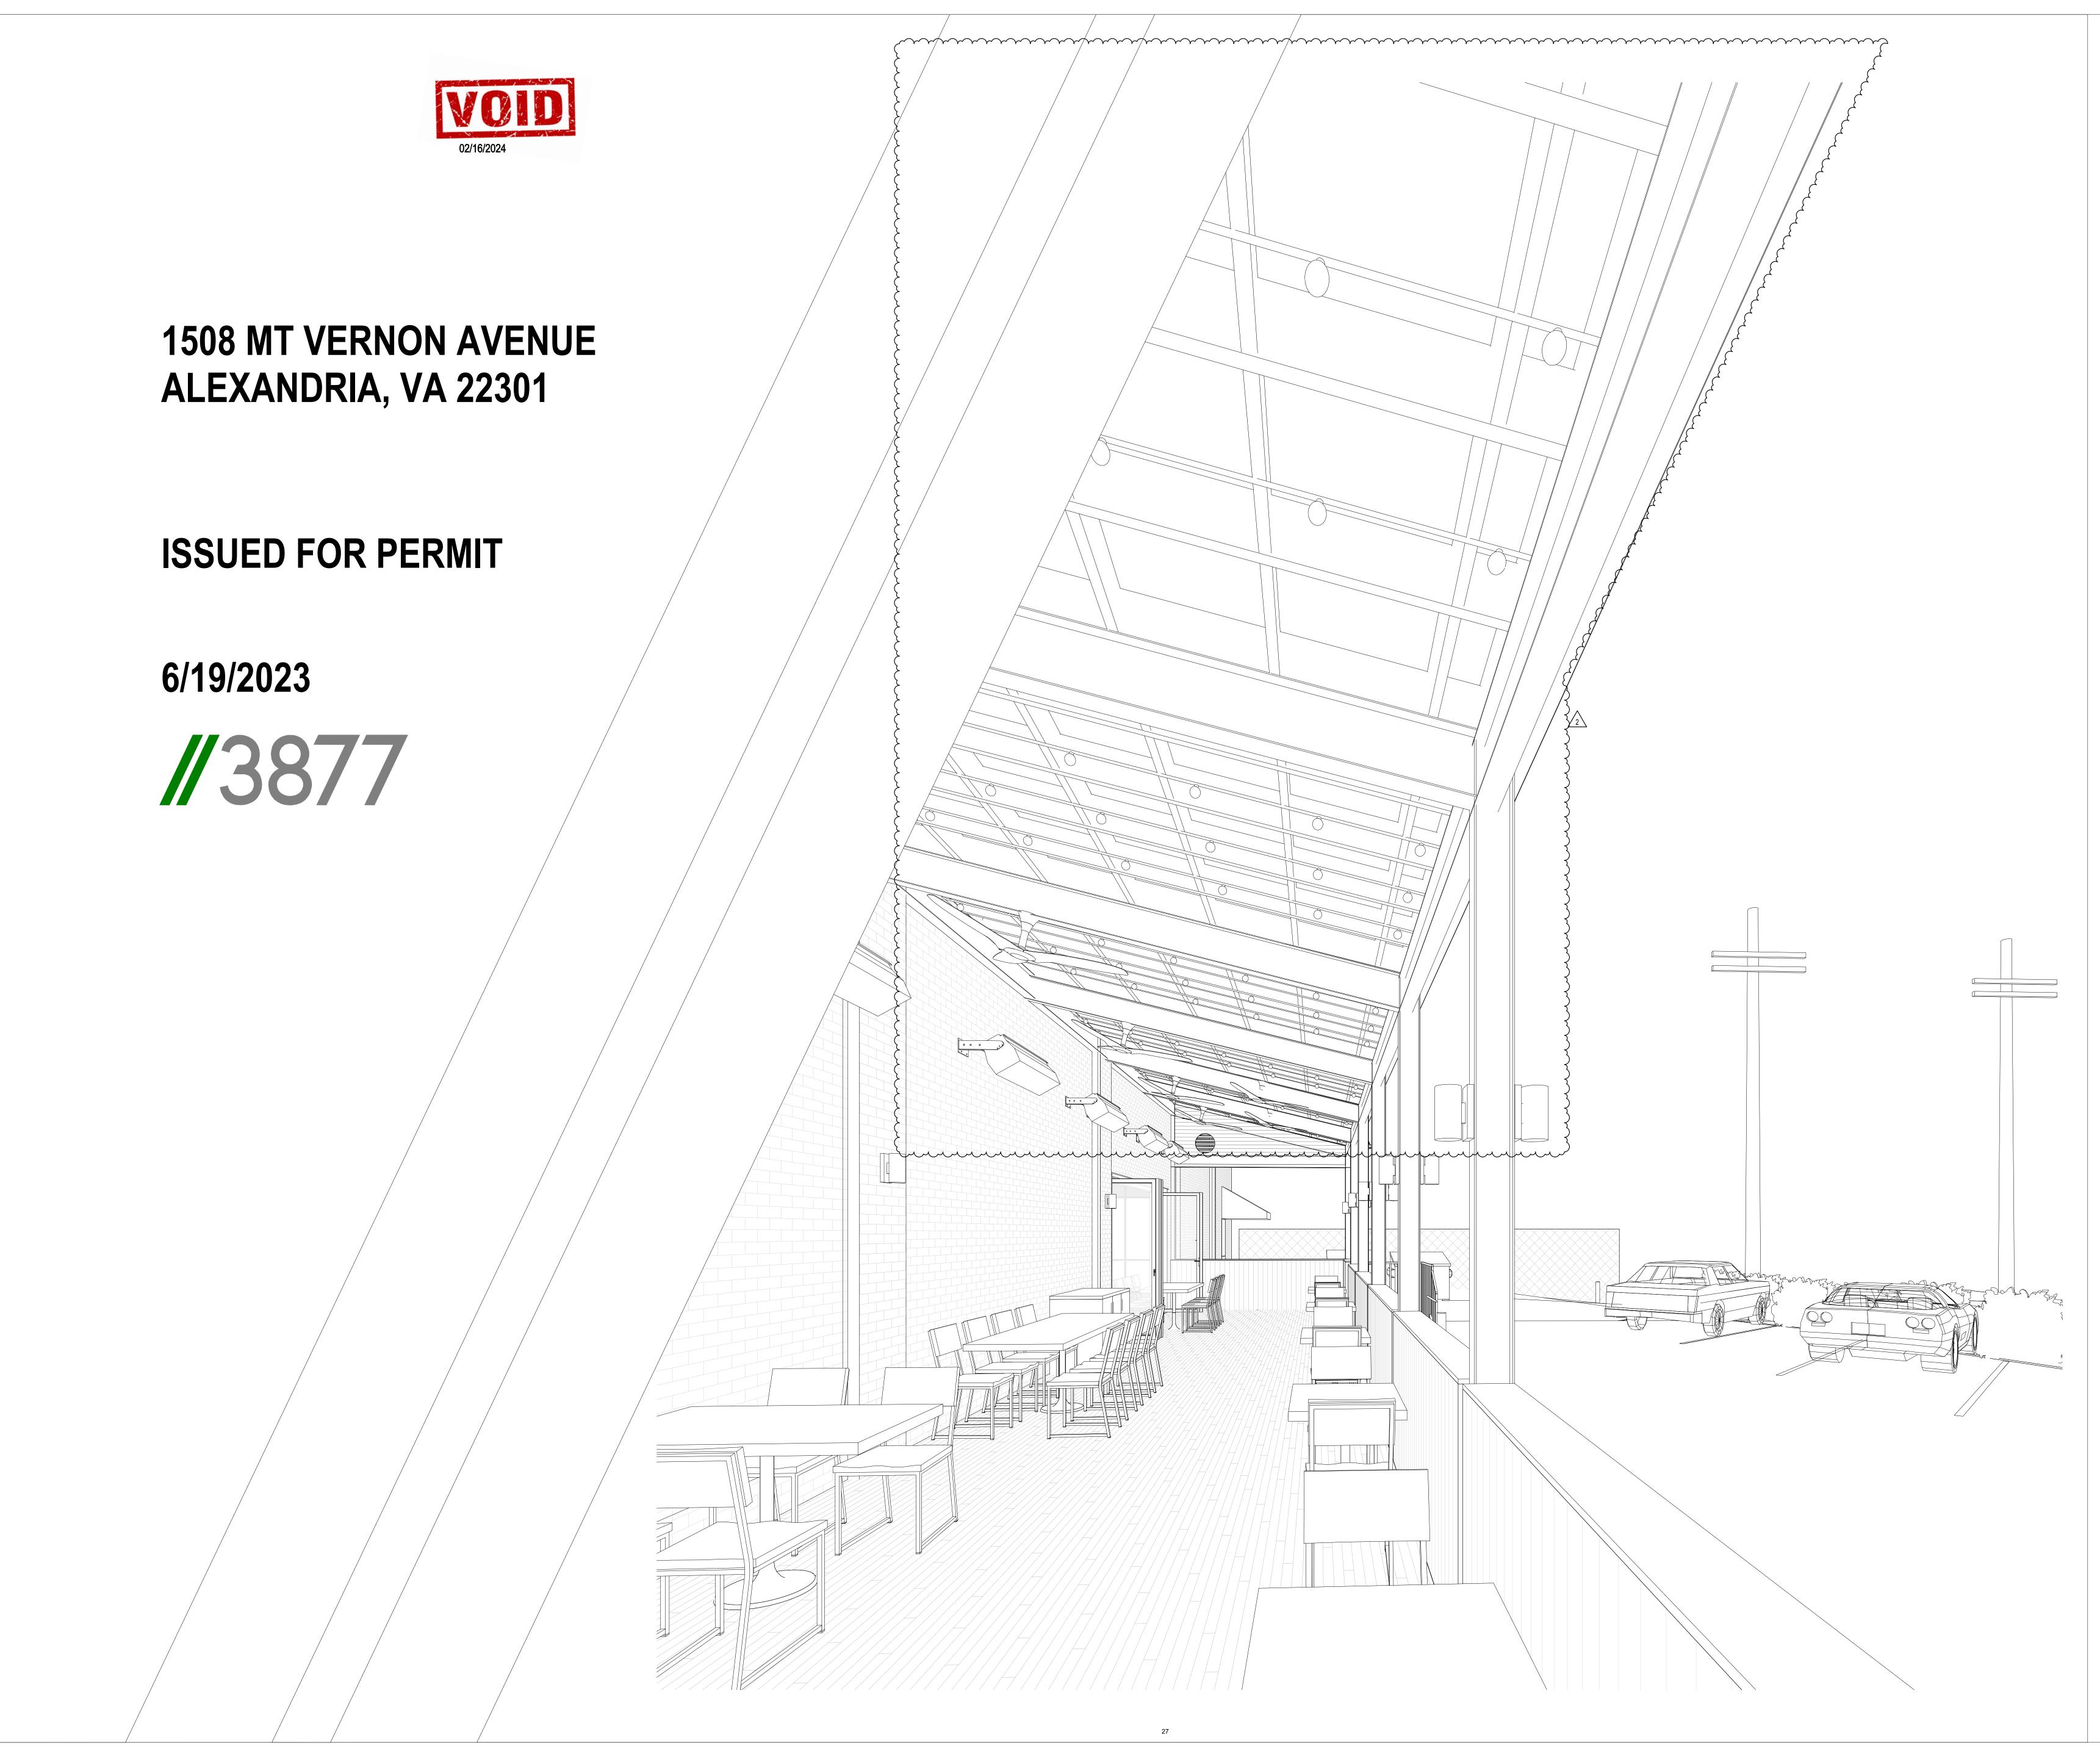

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OWNER : BAKER'S BREAD LLC 115 KING STREET ALEXANDRIA, VA 22314

TECH 24 5256 EISENHOWER AVE ALEXANDRIA, VA 22304

3333 K STREET NW, SUITE 60 WASHINGTON DC 20007 [T] 202.350.4244 [W] WWW.3877.DESIGN

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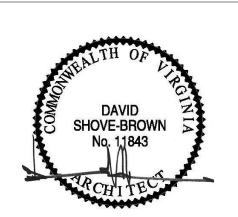
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PROJECT: JUNCTION BAKERY -**ALEXANDRIA**

ADDRESS: 1508 MT VERNON AVENUE **ALEXANDRIA, VA 22301**


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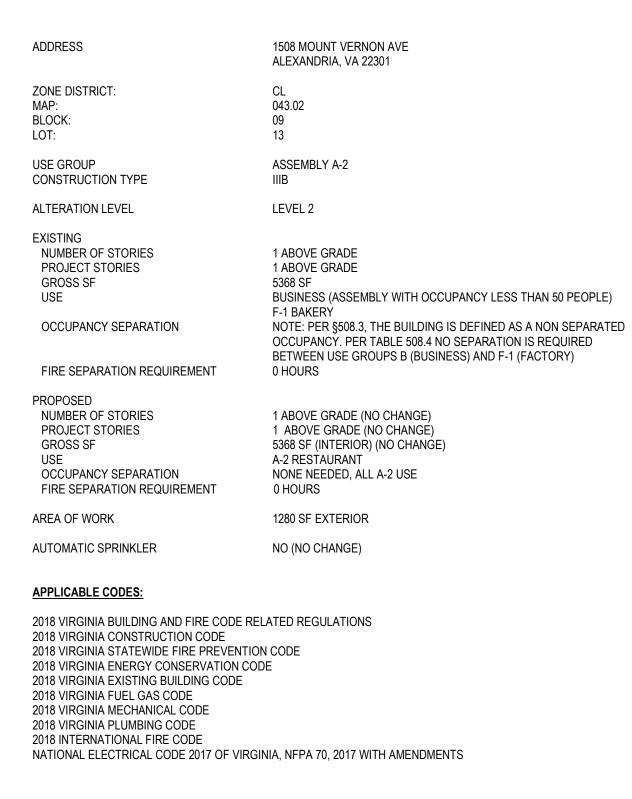
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SHEET TITLE: COVER SHEET

DATE ISSUED: 02/08/23





PROJECT DIRECTORY

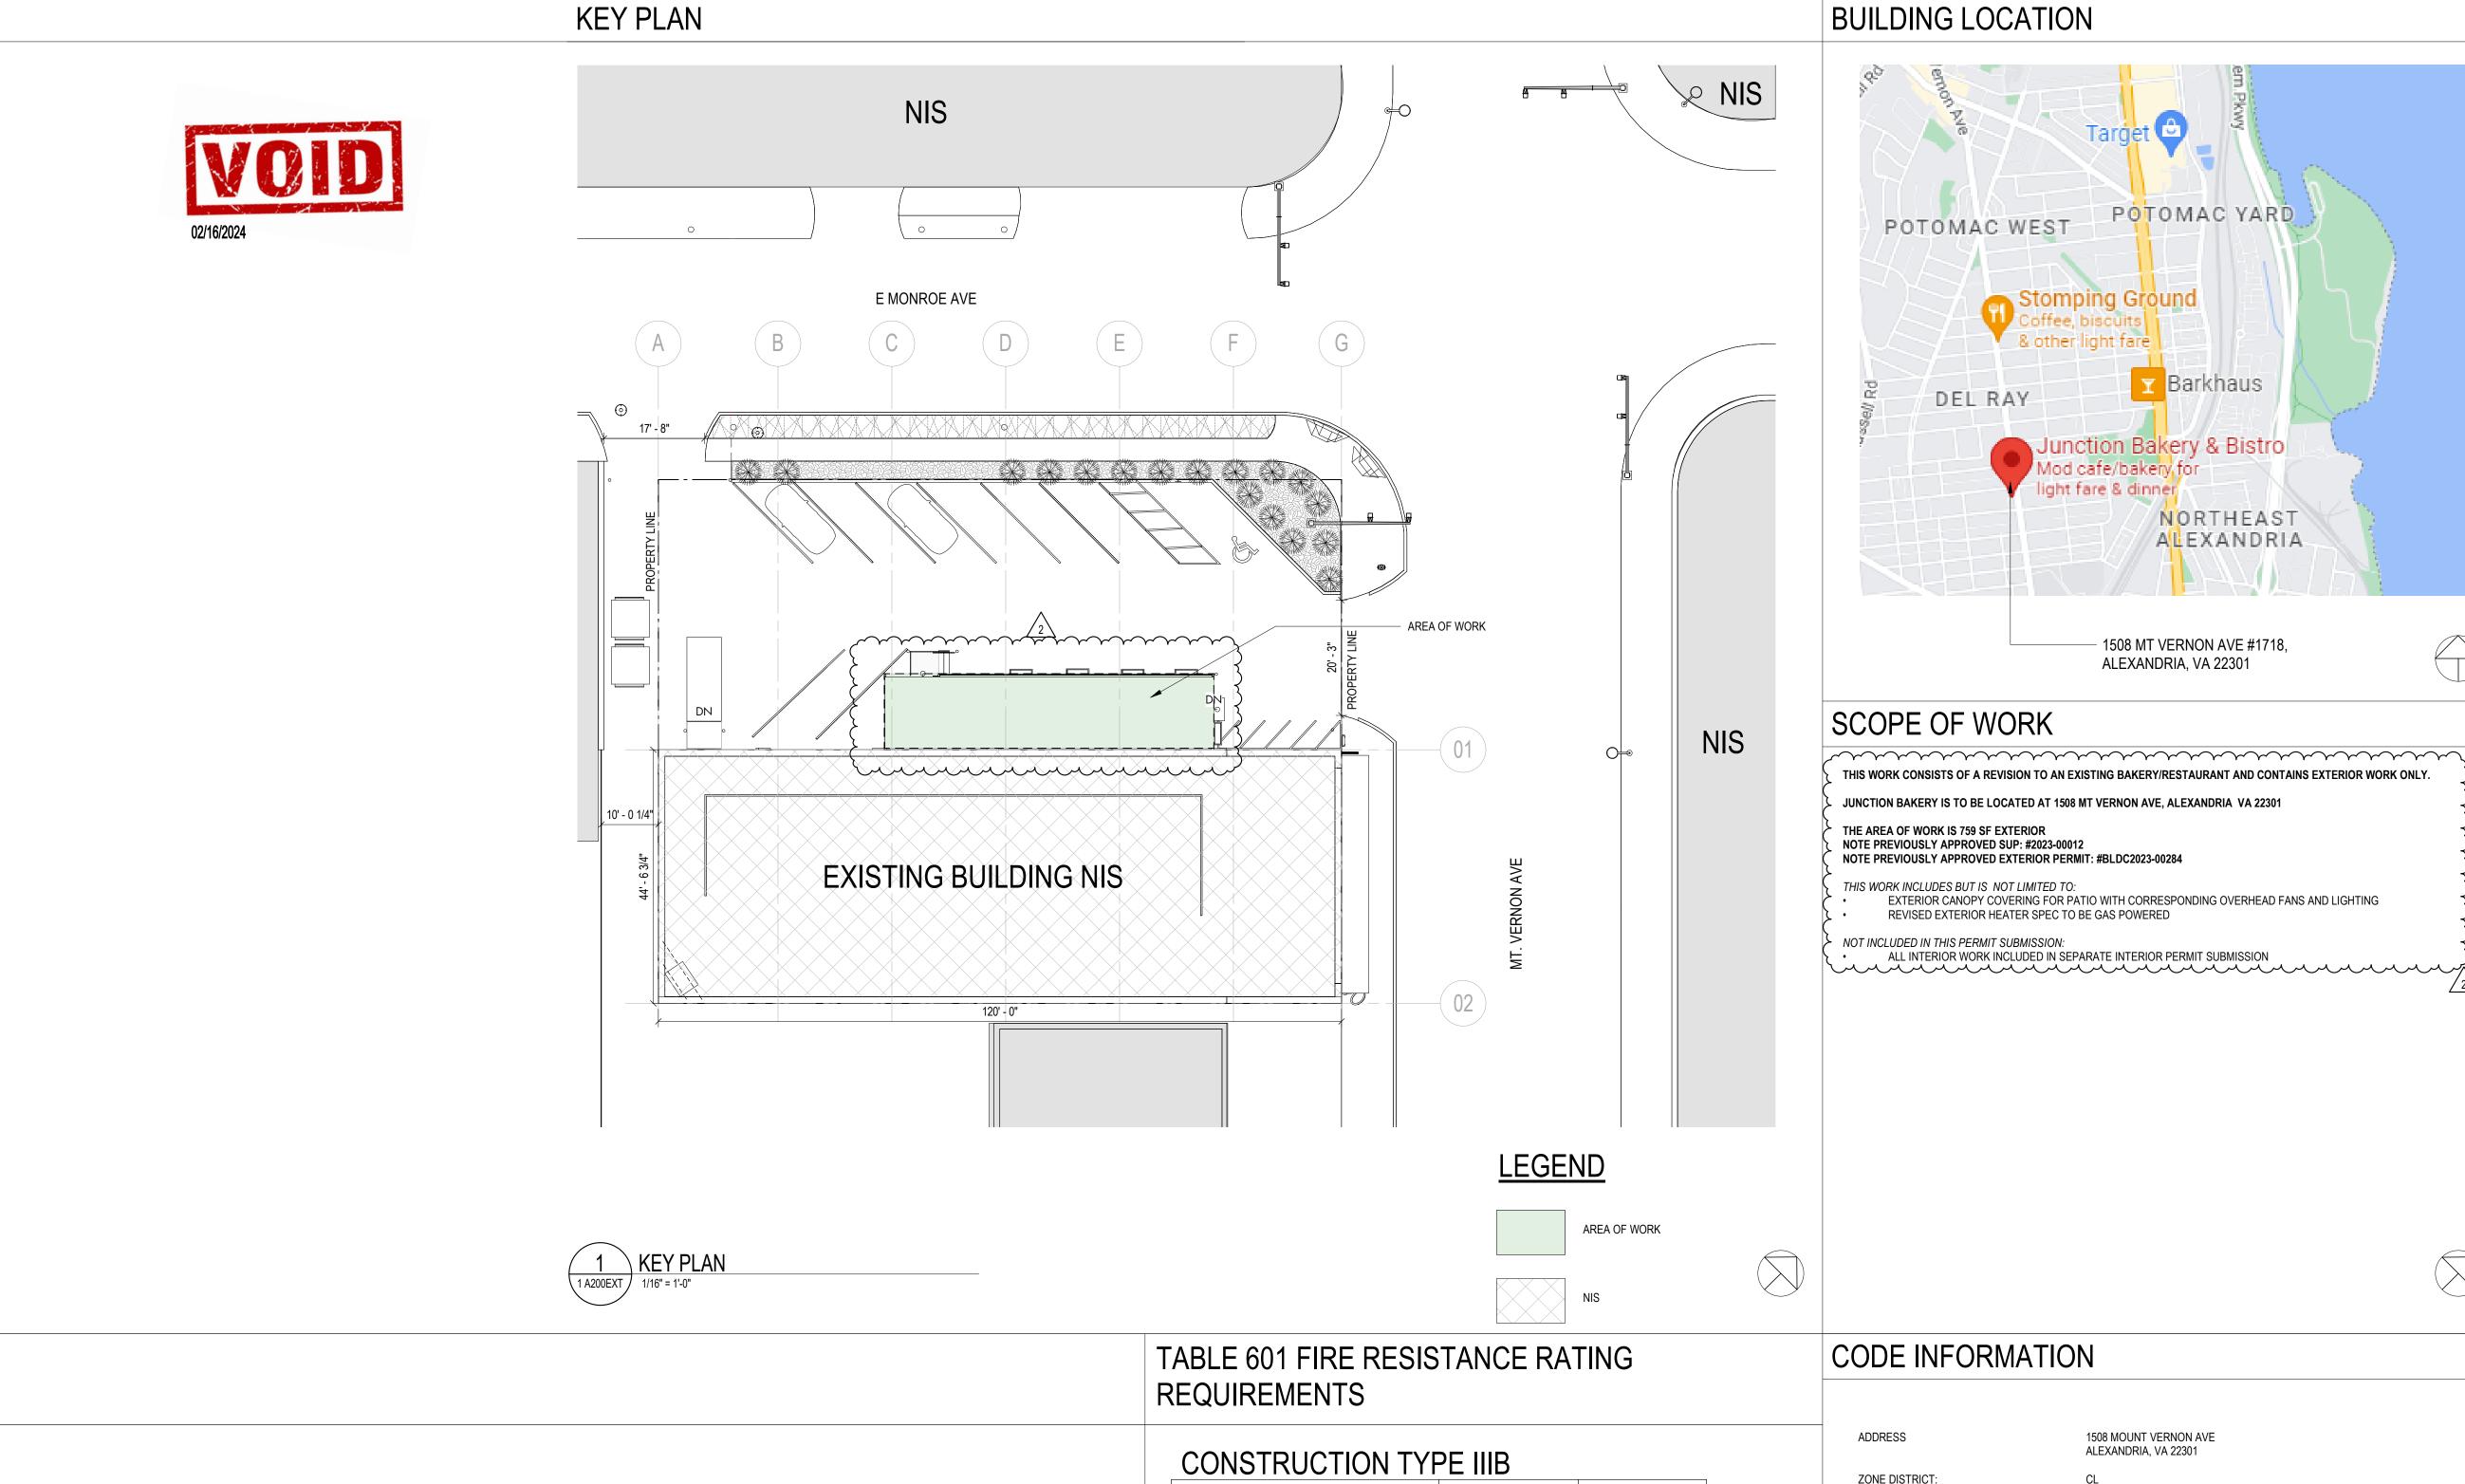JUNCTION BAKERY NOE LANDINI 1508 MT VERNON AVE ALEXANDRIA, VA 22301

> **MEP ENGINEER:** BUILT ENVIRONMENT

ENGINEERS

MILTON IRIARTE

MCLEAN, VA 22131

[T] 703.888.0649

6861 ELM STREET, SUITE 2D

SHEET INDEX

000EXT | COVER SHEET

A101EXT LEVEL 1 - PLANS

A201EXT | PATIO ELEVATIONS

A030EXT | SCHEDULES

A100EXT SITE PLAN

A002EXT PROJECT INFORMATION

A200EXT EXTERIOR ELEVATIONS

A501EXT | CONSTRUCTION DETAILS

EXTP-101 LEVEL 1 - NEW WORK PLAN

POTOMAC YARD

Barkhaus

1508 MT VERNON AVE #1718,

ALEXANDRIA, VA 22301

NORTHEAST ALEXANDRIA

BUILDING OWNER: JUNCTION BAKERY NOE LANDINI 115 KING STREET ALEXANDRIA, VA 22314

GENERAL CONTRACTOR: VIC BONOMI 5256 EISENHOWER AVE ALEXANDRIA, VA 22304

SHEET INDEX EXTERIOR

Sheet Name

S101EXT STRUCTURAL NOTES, PARTIAL FOUNDATION AND FRAMING 1. 1

EXTE-201 POWER PLAN

EXTE-601 PANEL SCHEDULES AND POWER RISER

EXTP-001 GENERAL NOTES SYMBOLS ABBREVIATIONS

• 3

\$201EXT FRAMING SECTIONS

[W] 3877.DESIGN STRUCTURAL ENGINEER: ELHERT BRYAN BENJAMIN GUNDEN, PE, SE 8609 WESTWOOD CENTER DRIVE SUITE 800 [T] 571.233.8585 TYSONS VA 22182 [W] WWW.TECH24CONSTRUCTION.COM [T] 703.749.7941

ARCHITECT:

DAVID SHOVE BROWN, AIA

WASHINGTON, DC 20007

[W] WWW.EHLERT-BRYAN.COM

|•|•

| • | •

| • | •

| • | •

3333 K STREET NW

//3877

SUITE 60

[T] 202.350.4244

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[W] WWW.EHLERT-BRYAN.COM

[T] 703.854.1028

PROJECT: JUNCTION BAKERY -**ALEXANDRIA**


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SHEET SUBMISSION INDEX ○ EXTERIOR PERMIT - 3.31.2023

REV NO. REVISION DATE

EXTERIOR PERMIT REVISION

SIGNATURE:

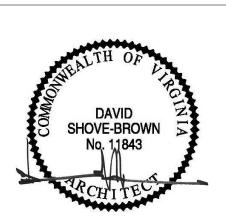

PROFESSIONAL CERTIFICATION: I HEREBY CERTIFY THAT THESE DOCUMENTS WERE PREPARED OR APPROVED BY ME, AND THAT I AM A DULY LICENSED PROFESSIONAL ARCHITECT UNDER THE LAWS OF THE STATE OF VIRGINIA, LICENSE No: 11843

SHEET TITLE: PROJECT INFORMATION

PROJECT NO: 2020.72 DATE ISSUED: 02/08/23


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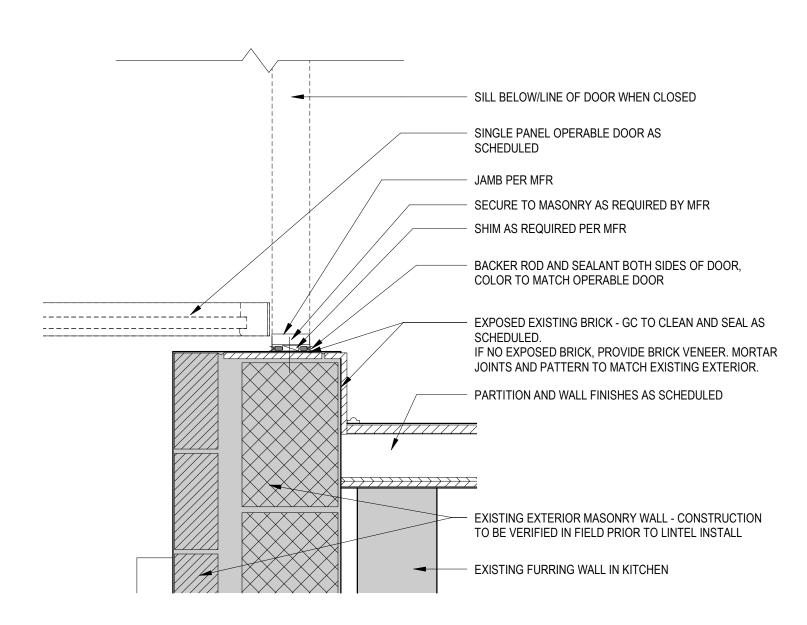
CONSTRUCTION TYPE	PE IIIB	
BUILDING ELEMENT	REQUIRED	PROVIDED
PRIMARY STRUCTURAL FRAME (*g)	0	0 ETR
EXTERIOR BEARING WALLS (*f, *g) INTERIOR BEARING WALLS	2 0	2 ETR 0 ETR
EXTERIOR NONBEARING WALLS/PARTITIONS INTERIOR NONBEARING WALLS/PARTITIONS (*e)	Per Table 602	0 ETR 0 ETR
FLOOR CONSTRUCTION AND ASSOC. SECONDARY MEMBERS (See Section 202)	0	0 ETR
ROOF CONSTRUCTION AND ASSOC. SECONDARY MEMBERS (See Section 202)	0	0 ETR

a. Roof supports: Fire-resistance ratings of primary structural frame and bearing walls are permitted to be reduced by 1 hour where supporting a roof only. b. Except in Group F-1, H, M and S-1 occupancies, fire protection of structural members shall not be required, including protection of roof framing and decking where every part of the roof construction is 20


feet or more above any floor immediately below. Fire-retardant-treated wood members shall be allowed to be used for such unprotected members. c. In all occupancies, heavy timber shall be allowed where a 1-hour or less fire-resistance rating is

d. Not less than the fire-resistance rating required by other sections of this code. e. Not less than the fire-resistance rating based on fire separation distance (see Table 602). f. Not less than the fire-resistance rating as referenced in Section 704.10




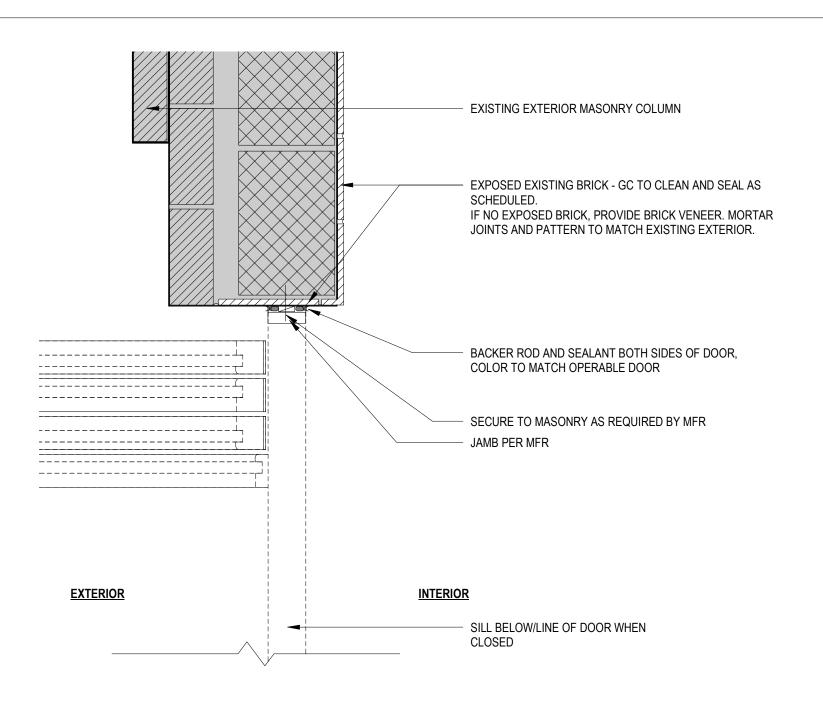


2 4 A030EXT EXTERIOR OPERABLE DOOR JAMB 1 1/2" = 1'-0"

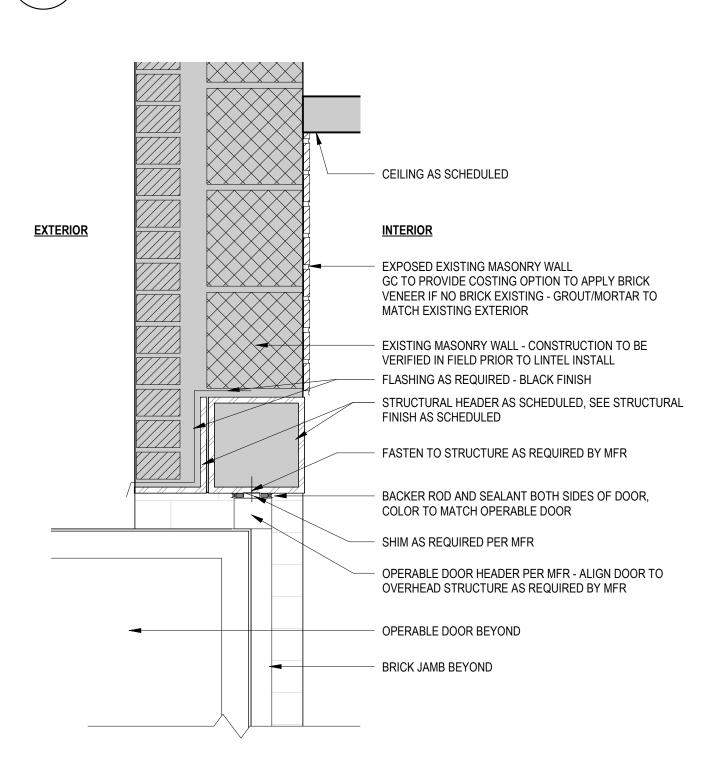

3 EXTERIOR OPERABLE DOOR HEADER

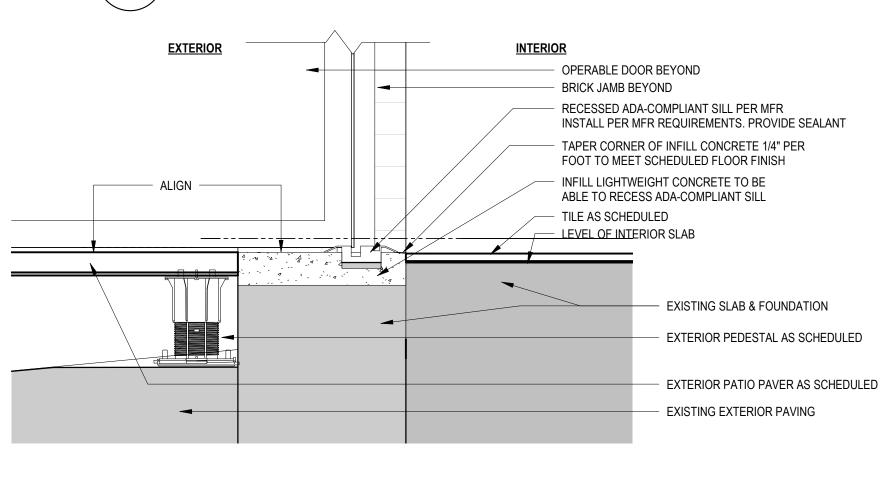

1 EXTERIOR OPERABLE DOOR SILL

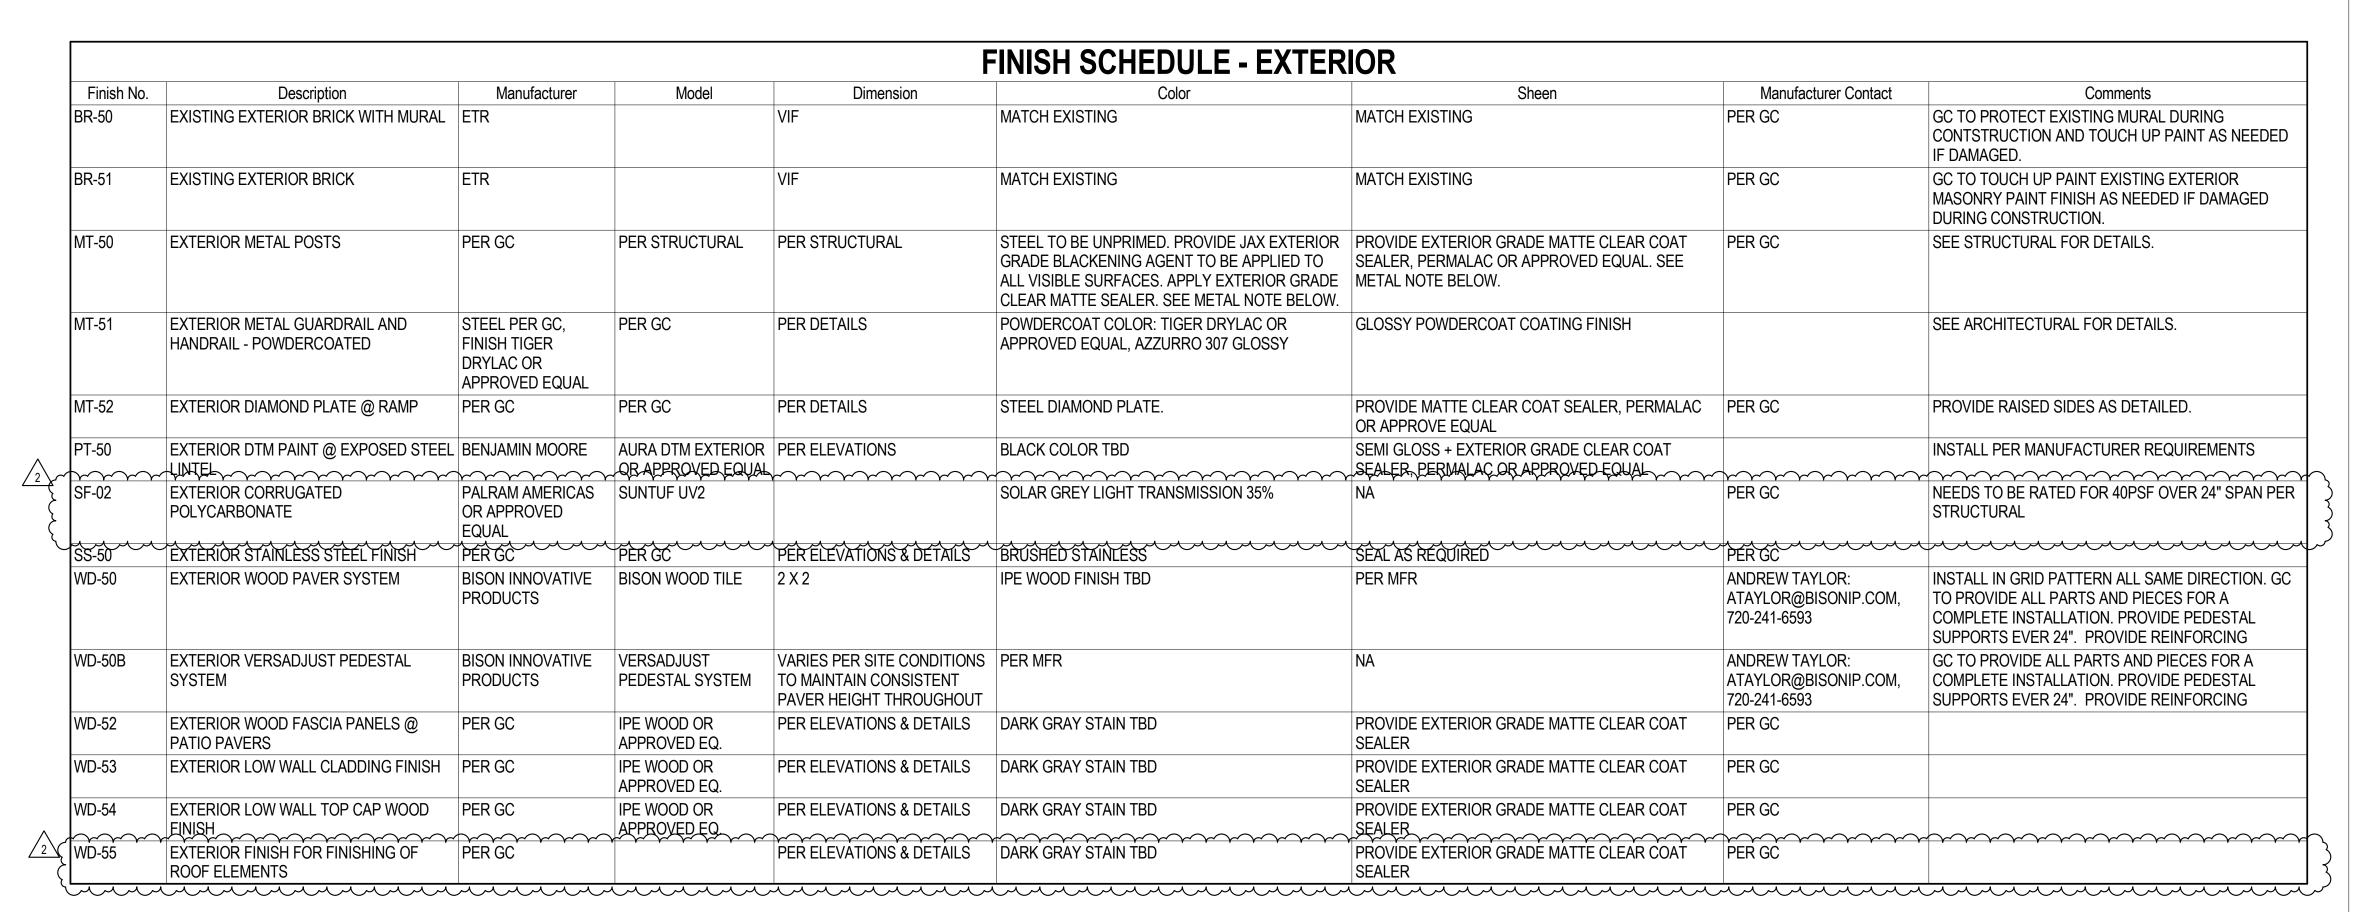

FINISH SAMPLE NOTE:

GC TO PROVIDE MIN (3) SAMPLES OF EACH FINISH LISTED FOR REVIEW BY OWNER AND ARCHITECT PRIOR TO ORDERING AND FABRICATION.

METAL BLACKENING NOTE:

FOR METAL FINISHES RECEIVING BLACKENING AGENT, USE JAX IRON/STEEL/NICKEL BLACKENER OR APPROVED EQUAL. PRIOR TO APPLYING, METAL MUST BE CLEAN, FREE OF LACQUER, OIL, GREASE, AND WAX. APPLY BLACKENER PER MFR INSTRUCTIONS PRIOR TO MECHANICALLY DRYING AND APPLYING CLEAR COAT SEALER AS SCHEDULED. SUGGESTED SEALER BRAND: PERMALAC. GC TO TEST BOTH BLACKENING AGENT AND SEALER ON METAL SAMPLE PRIOR TO FINISHING MATERIAL TO BE INSTALLED.

MFR CONTACT: ANTHONY NAPPY, 914-668-1818, ANTHONY@JAXCHEMICAL.COM


			LIGHTING FIXT	URE SC	HEDUL	E - EXTERIOR		
				Phase				
TYF	PE DESCRIPTION	MANUFACTURER	MODEL	Created	COMMENTS	FINISH	LAMPING	COMMENTS
LTG-10	EXTERIOR CYLINDER SCONCE	REJUVENATION OR APPROVED	THORBURN NARROW WALL SCONCE #A7004, WET RATED	New		DARK ALUMINUM	MAX WATTAGE 40W, LED LAMP TBD	FIXTURE TO BE DIMMABLE AND HARDWIRED. PROVIDE ALL PARTS
	·	ALTERNATE		Construction				AND ACCESSORIES FOR COMPLETE INSTALLATION FIXTURE TO BE DIMMABLE AND HARDWIRED. PROVIDE ALL PARTS
2 (LTG-11	EXTERIOR CAGE LIGHT	SCHOOLHOUSE LIGHTING OR	FACTORY 4 OUTDOOR SCONCE, WET RATED. PROVIDE CAGE	New	, , , , , , , , , , , , , , , , , , ,	BLACK BK	MAX WATTAGE 100W, LED LAMP TBD	FIXTURE TO BE DIMMABLE AND HARDWIRED. PROVIDE ALL PARTS
₹ , ,	SCONCE	APPROVED ALTERNATE		Construction				$\ $ AND ACCESSORIES FOR COMPLETE INSTALLATION $\ \cdot\ _{L^{\infty}}$
LTG-12	STRING LIGHTS	AMERICAN LIGHTING OR	LS/LS2 SERIES, NON-SUSPENDED E26 STRING LIGHTS 24" O.C.	New		BLACK	MAX WATTAGE PER SOCKET 25W, LED	FIXTURE TO BE DIMMABLE AND HARDWIRED. PROVIDE ALL PARTS
		APPROVED ALTERNATE	SOCKETS, WET RATED. FIXTURE IS CUTTABLE IN FIELD.	Construction			LAMP TBD	AND ACCESSORIES FOR COMPLETE INSTALLATION. GC TO VERIFY
								LENGTHS IN FIELD PRIOR TO ORDERING FIXTURE.

				EQUIPMEN	NT SCHEDULE	E - EXTE	RIOR	
2	Type Mark QP-01	Description OUTDOOR WALL HEATERS	Manufacturer SCHWANK	Model 2152-N	FINISH BLACK	INPUT BTUH 50,000/36,500	WEIGHT GAS (LBS.) NAT 44	Comments GC TO PRÓVIDE: (6) 2152 TWO STAGE HEATERS, 30 DEGREE MOUNTING AND WALL MOUNTING BRACKET; (2) JM-0203-TS 3-GANG SCHWANK 2-STAGE SWITCHES, (ADJACENT TO LIGHTING CONTROLS); (1) MULTI MOUNT 150VA TRANSFORMER FOR ALL 6 HEATERS - MOUNTED WITHIN THE SPACE IN A CONCEALED, DRY AND
7	QP-02	Haiku 60In Dia	Big Ass Fans	60" inch MK-HK-4-05-2506-A258-F258. OMIT LIGHTS, COORDINATE DOWN ATTACHMENT WITH SLOPED CEILING. COORDINATE CONTROL SPEC WOWNER AND INCLUDE IN PURCHASE.				VENTILATED LOCATION. CONTACT: ERIC KAHN, E: ERIC@ALFRESCO-HEATING.COM, T: 415.884.2880 PROVIDE ALL PARTS AND PIECES REQUIRED FOR FULL AND COMPLETE INSTALLATION. PROVIDE STABILIZER KIT.

	DOOR SCHEDULE - EXTERIOR													
	Do	or Dooi								Frame			Fire	e
Level	No	о. Туре	Location	Description	Width	Height	Thickness	Construction	Door Finish	Frame Finish	Jamb Type	Glass Type	Rating	Comments - HARDWARE SET
LEVEL 01	100	CC	ENTRY VESTIBULE	EXISTING STOREFRONT ENTRANCE	6' - 2"	6' - 8"		ETR - ALUM + INSULATED TEMPERED GLASS	ETR - BLACK	ETR - BLACK	ETR	ETR-TEMPERED	NA	HW-1
LEVEL 01	106	SA I	OUTDOOR PATIO	"Monumental Aluminum Framed Folding System"	15' - 0"	8' - 6"	1 99/128"	ALUM + INSULATED TEMPERED GLASS		BLACK	1/A030EXT, 2/A030EXT, 3/A030EXT	CLR TEMP INSUL.		HW-2: COORDINATE DOOR SIZE IN FIELD WITH DEMO CONDITIONS AND WITH PROPOSED STRUCTURAL HEADER SUPPORT.
LEVEL 01	118	A	EQUIPMENT CORRIDOR	EXISTING BOH DOOR	3' - 4"	7' - 0"	1 3/4"	ETR - SOLID CORE HM	ETR - PT	ETR - PT	ETR - HM	NA	NA	HW-3

CONTINUOUS AIR BARRIER REQUIRED, TYP. GC TO PROVIDE SEALED CONNECTIONS AT ALL JOINTS VIA

CAULK OR GASKETS, TYP.

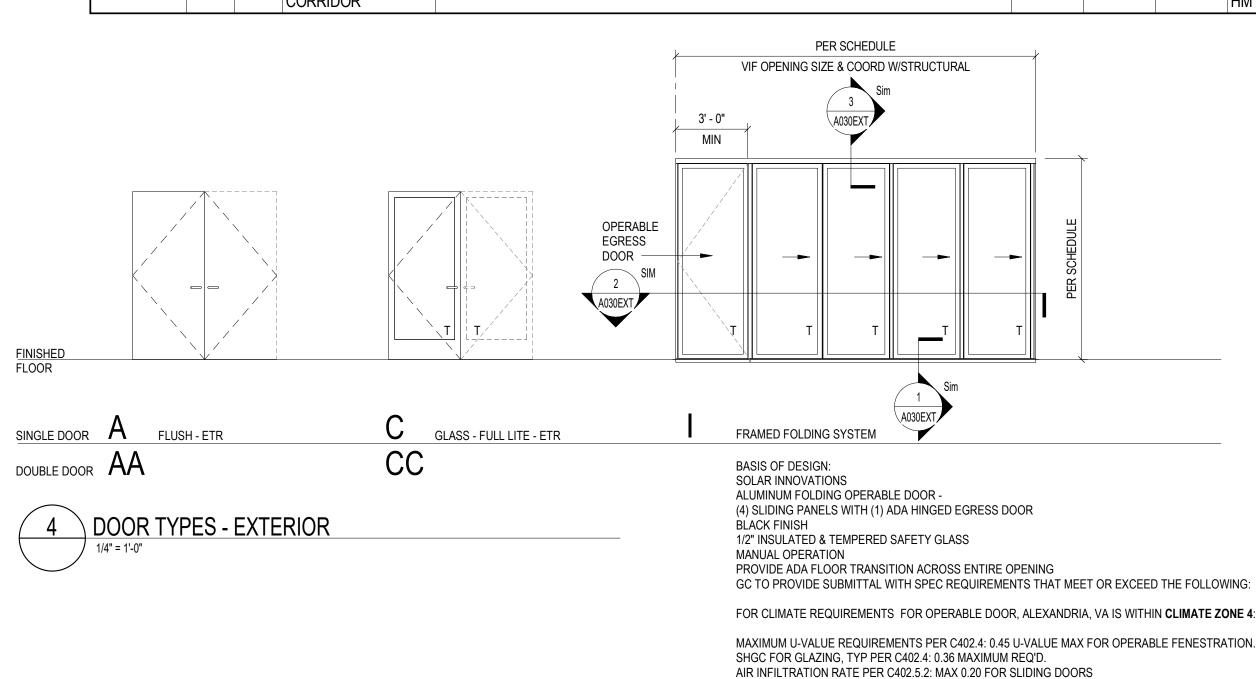

DOOR HARDWARE SCHEDULE

HARDWARE SET	COMPONENT	COUNT	MANUFACTURER	MODEL	FINISH	COMMENTS				
	HINGES	6		EXISTING TO REMAIN						
	LOCK	1		EXISTING DEADBOLT						
	LEVER	2		EXISTING PUSH/PULL LEVER						
HW-1 EXISTING	CLOSER	2		EXISTING CLOSER		GC TO CONFIRM HARDWARE IS EXISTING AND				
ENTRY DOUBLE	SIGN	1		EXISTING		FUNCTIONING OR REPLACE AS NEEDED IF				
DOOR	DOOR SEALS	1		EXISTING - REPLACE IF MISSING		MISSING OR DAMAGED.				
	DOOR SWEEP	1		EXISTING - REPLACE IF MISSING						
	ASTRAGAL	1		EXISTING - REPLACE IF MISSING						
	SILENCERS			EXISTING - REPLACE IF MISSING						
	HINGES	3	PER MFR	PER MFR	BLACK					
	LOCK			PER MFR	BLACK					
	CLOSER			PER MFR	BLACK					
	PANIC DEVICE	1	PER MFR	PER MFR - MUST MEET ADA	BLACK	PROVIDE BLACK FINISH TYP. CLOSER TO BE ADA				
HW-2 OPERABLE DOOR	DOOR SEAL	ALL PANELS	PER MFR	PER MFR	BLACK	COMPLIANT AND NOT REQUIRE MORE THAN 5LBS OF FORCE TO OPEN. LOCK @ SWING DOOR TO BE INTEGRATED ON PANIC DEVICE.				
	BOTTOM SWEEP	ALL PANELS	PER MFR	PER MFR	BLACK					
	ADA SILL	1	PER MFR	PER MFR	ANOD					
	HINGES			EXISTING						
	LEVER			EXISTING						
LIM O EVICTINO	LATCH			EXISTING		OO TO CONFIDM HARRIMARE IO EVICTING AND				
HW-3 EXISTING EMPLOYEE	CLOSER			EXISTING		GC TO CONFIRM HARDWARE IS EXISTING AND FUNCTIONING OR REPLACE AS NEEDED IF				
ACCESS DOOR	DOOR SEALS			EXISTING - REPLACE IF MISSING		MISSING OR DAMAGED.				
	DOORSWEEP			EXISTING - REPLACE IF MISSING						
	SILENCERS			EXISTING - REPLACE IF MISSING						
	SILL			EXISTING - REPLACE IF MISSING						

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TYSONS, VA 22182

[T] 703.854.1028

[W] WWW.EHLERT-BRYAN.COM

PROJECT: JUNCTION BAKERY - ALEXANDRIA

ADDRESS: 1508 MT VERNON AVENUE ALEXANDRIA, VA 22301


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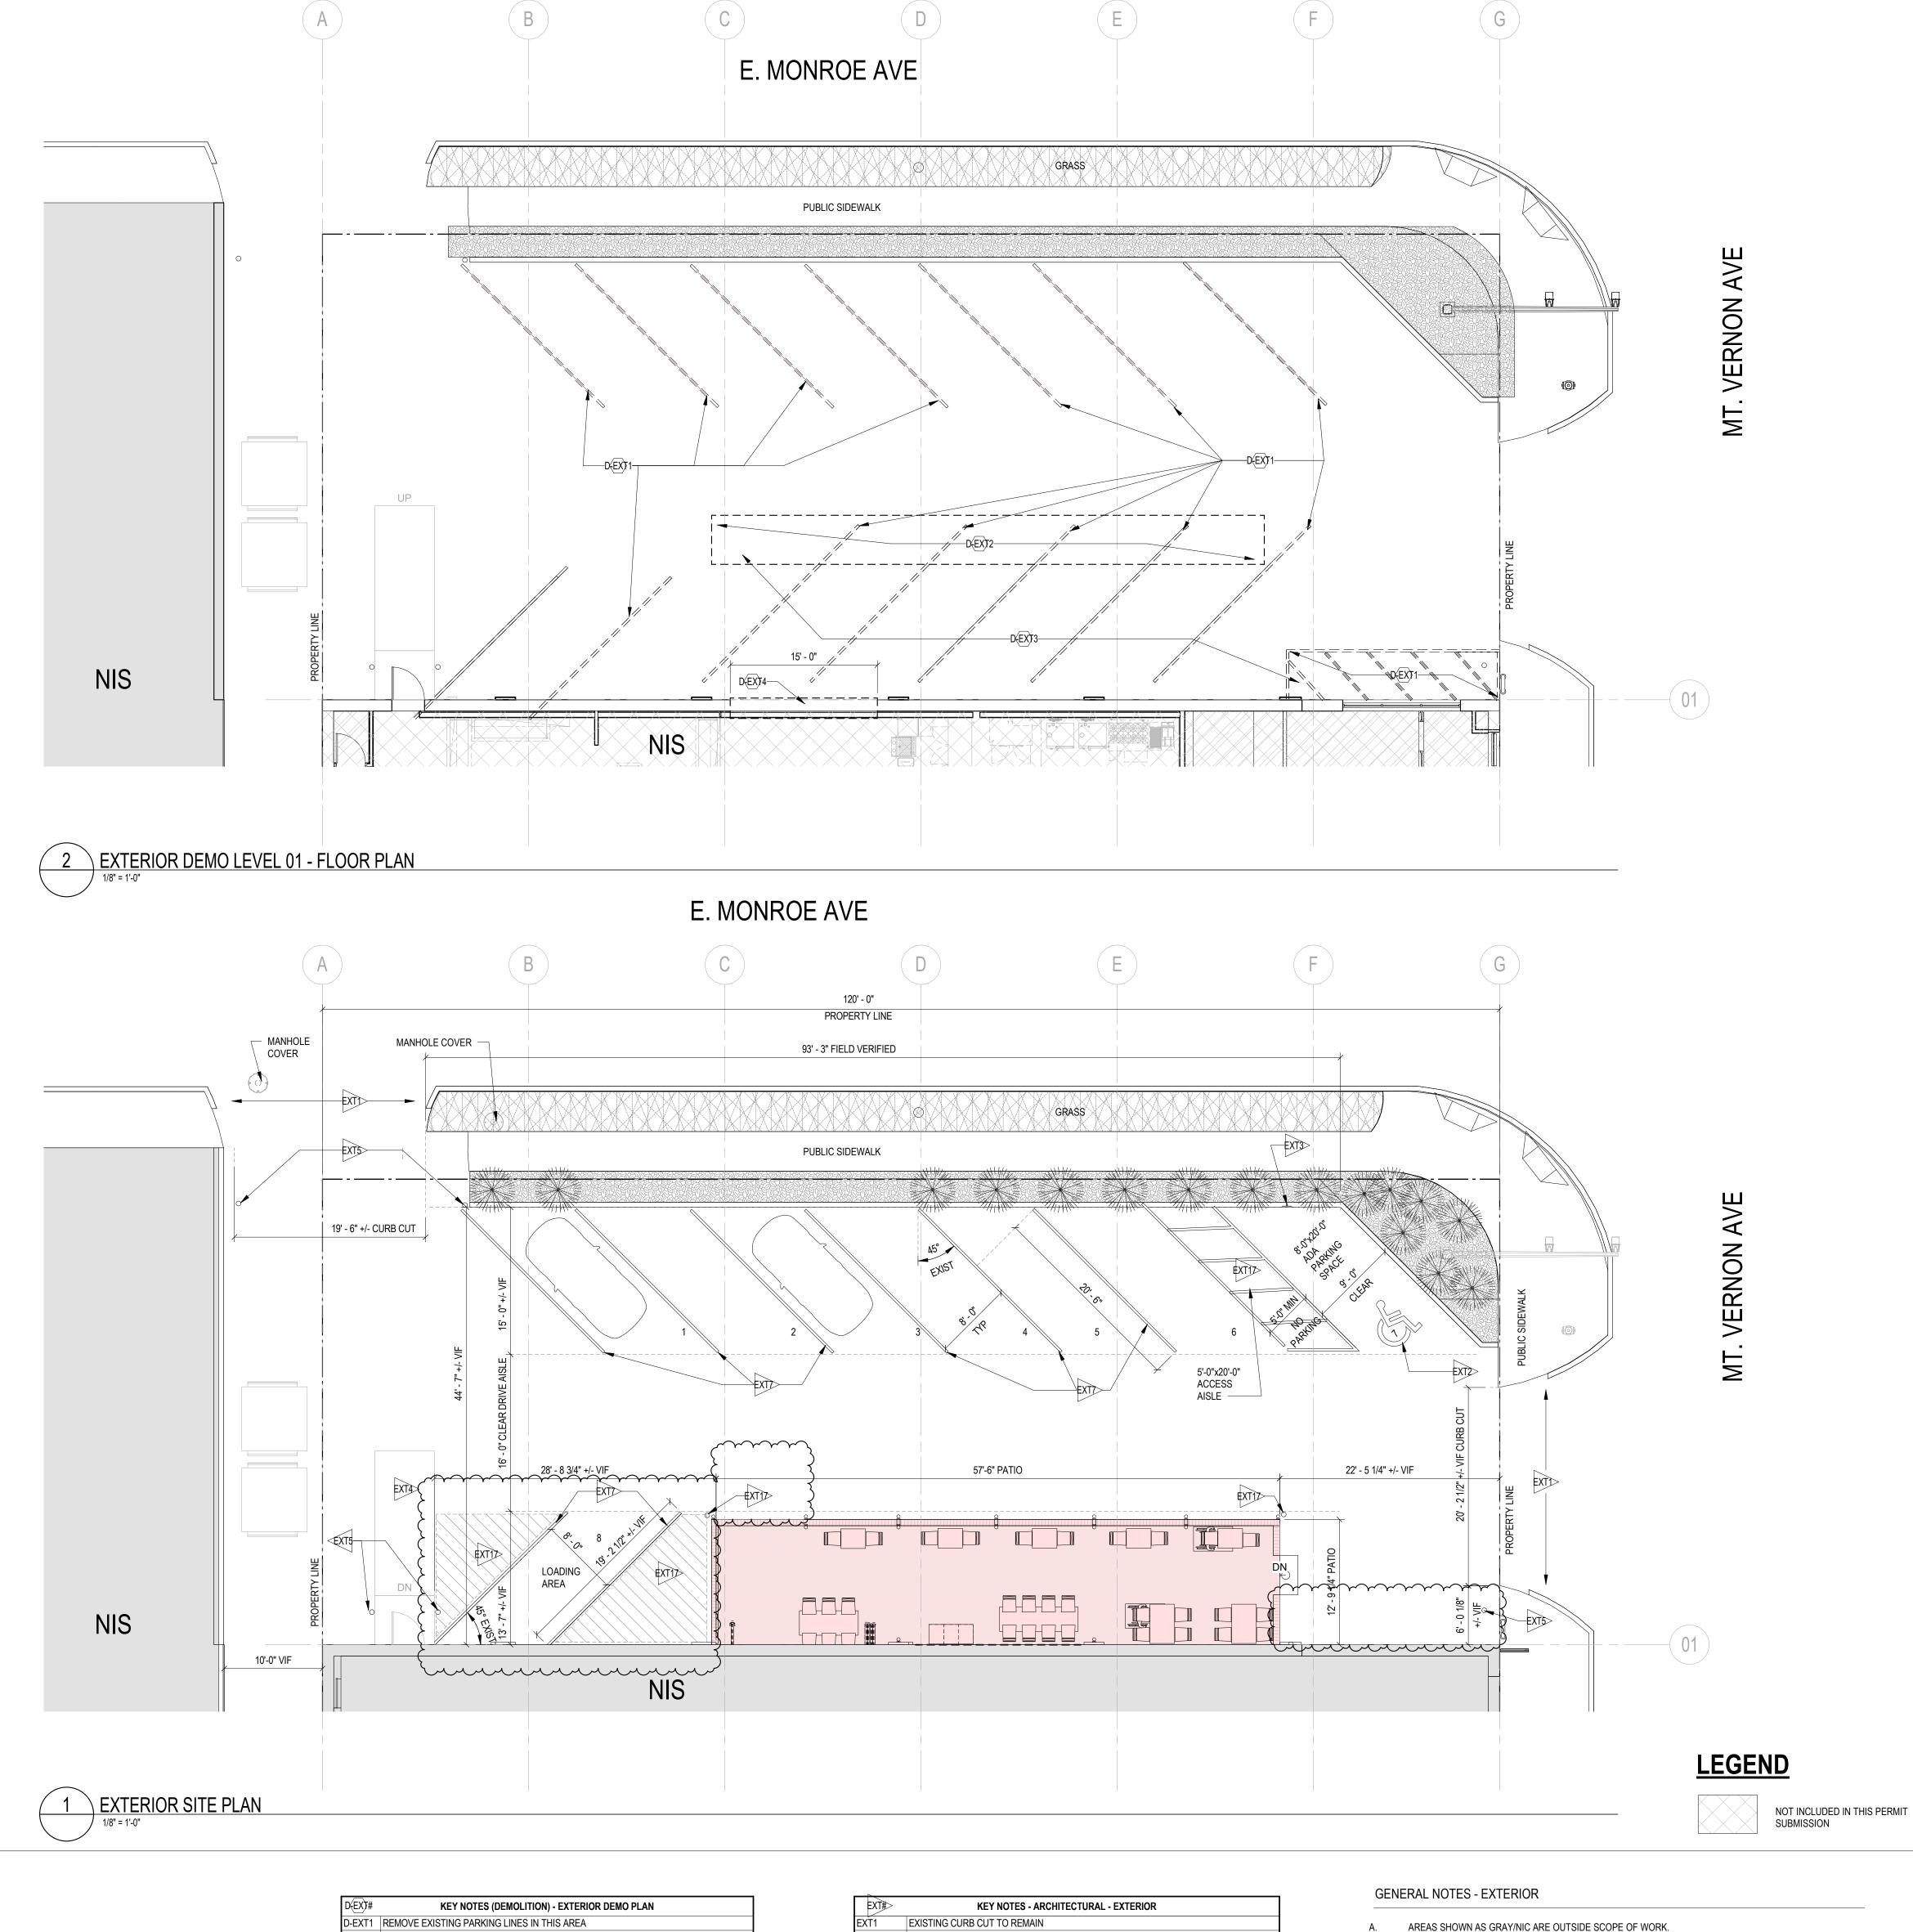


SHEET TITLE: SCHEDULES
PROJECT NO: 2020.72


DATE ISSUED: 02/08/23

SCALE: As indicated

A030EXT

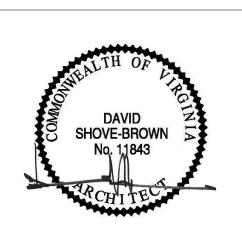

D-EXT2 COORDINATE SITE DEMO WITH STRUCTURAL D-EXT3 GC TO REMOVE AND SALVAGE EXISTING SITE FURNISHINGS. COORDINATE STORAGE WITH OWNER. PRESERVE AND PROTECT EXISTING PLANTERS FOR REINSTALLATION D-EXT4 REMOVE PORTION OF EXTERIOR MASONRY WALL. COORDINATE EXTENTS WITH NEW WORK. PROVIDE SHORING PER STRUCTURAL. SEE STRUCTURAL FOR MORE INFO.

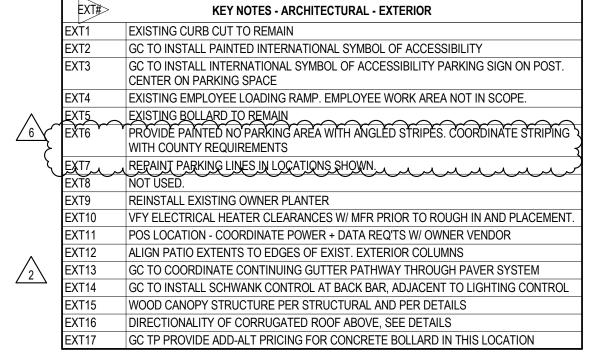

- ALL DIMS SHOWN ARE FROM FACE OF FINISH. ARCHITECTURAL ELEMENTS SHOWN IN GRAY ARE EXISTING TO REMAIN.
- ALL ELEMENTS NOTED AS EXISTING TO REMAIN SHALL BE PRESERVED AND PROTECTED BY THE GC BEFORE BEGINNING DEMOLITION. GC TO COORDINATE GUTTER EXTENSIONS BELOW PROPOSED PATIO WORK TO MAINTAIN ADEQUATE ROOF AND
- SIDE DRAINAGE. REFER TO FINISH SCHEDULE FOR MATERIAL SPECIFICATIONS. INSTALL PER MANUFACTURER RECOMMENDATIONS. REFER TO ELEVATIONS FOR ADDITIONAL WALL FINISHES AS TAGGED & SCHEDULED. SURFACES TO BE PAINTED MUST BE CLEAN. DRY. AND FREE OF DIRT DUST, GREASE, OIL, SOAP, WAX, SCALING PAINT, WATER SOLUBLE MATERIALS, AND MILDEW. REMOVE ANY PEELING OR SCALING PAINT AND SAND THESE AREAS TO FEATHER EDGES SMOOTH WITH ADJACENT SURFACES. GLOSSY AREAS SHOULD BE DULLED. DRYWALL SURFACES MUST BE FREE OF SANDING DUST.
- FINISH WALLS AS SPECIFIED IN PLAN AND ELEVATION. FURNISH AND INSTALL MILLWORK AS DETAILED, REFER TO MILLWORK DETAILS FOR MORE INFO. GC TO EVALUATE EXISTING SITE CONDITIONS PRIOR TO STARTING WORK. EXTERIOR SITE SLOPING SHOWN FOR REFERENCE ONLY, ALL SLOPPED AND HEIGHTS TO BE VERIFIED IN THE FILED BEFORE STARTING WORK.

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STRUCTURAL ENGINEER: EHLERT BRYAN 8609 WESTWOOD CENTER DRIVE **TYSONS, VA 22182** [T] 703.854.1028 [W] WWW.EHLERT-BRYAN.COM



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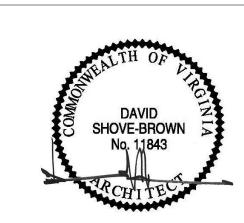
PROJECT: JUNCTION BAKERY -**ALEXANDRIA**

ADDRESS: 1508 MT VERNON AVENUE **ALEXANDRIA, VA 22301**

SHEET SUBMISSION INDEX O EXTERIOR PERMIT - 3.31.2023

DATE EXTERIOR PERMIT REVISION 19 JUNE 2023 SUP/EXTERIOR PERMIT REVISION 25 JAN 2024

REVISED 1/25/2024





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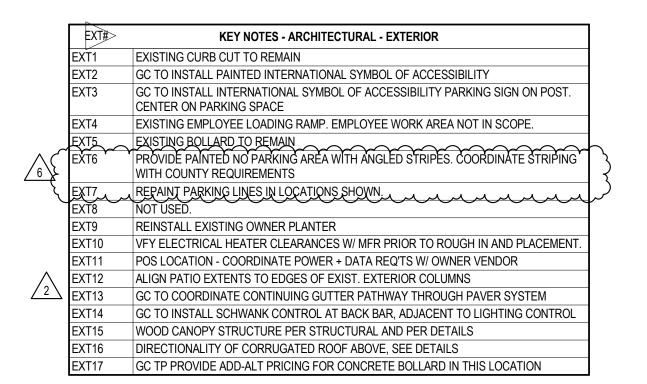
SHEET TITLE: SITE PLAN

PROJECT NO: 2020.72 DATE ISSUED: 02/08/23

SCALE: As indicated



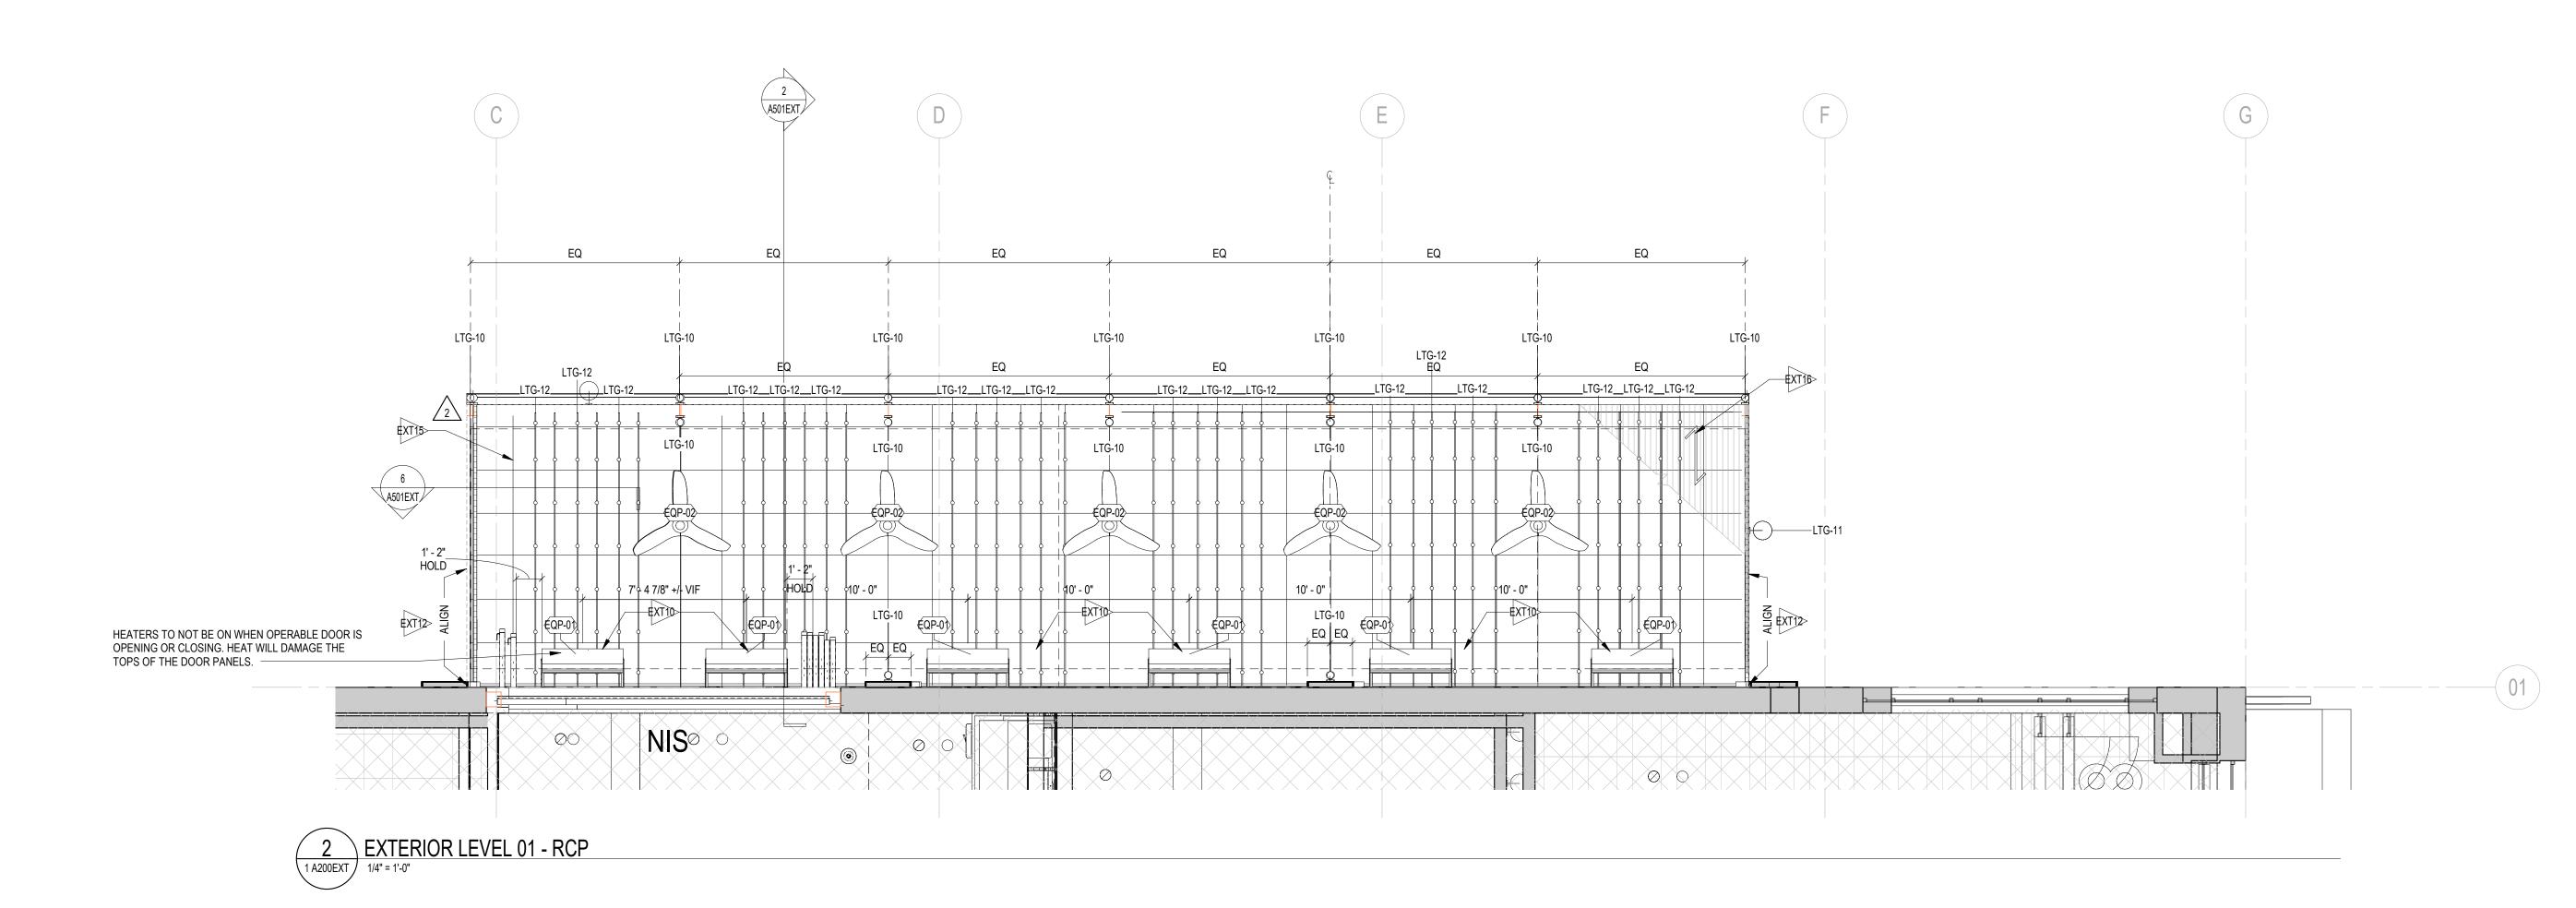

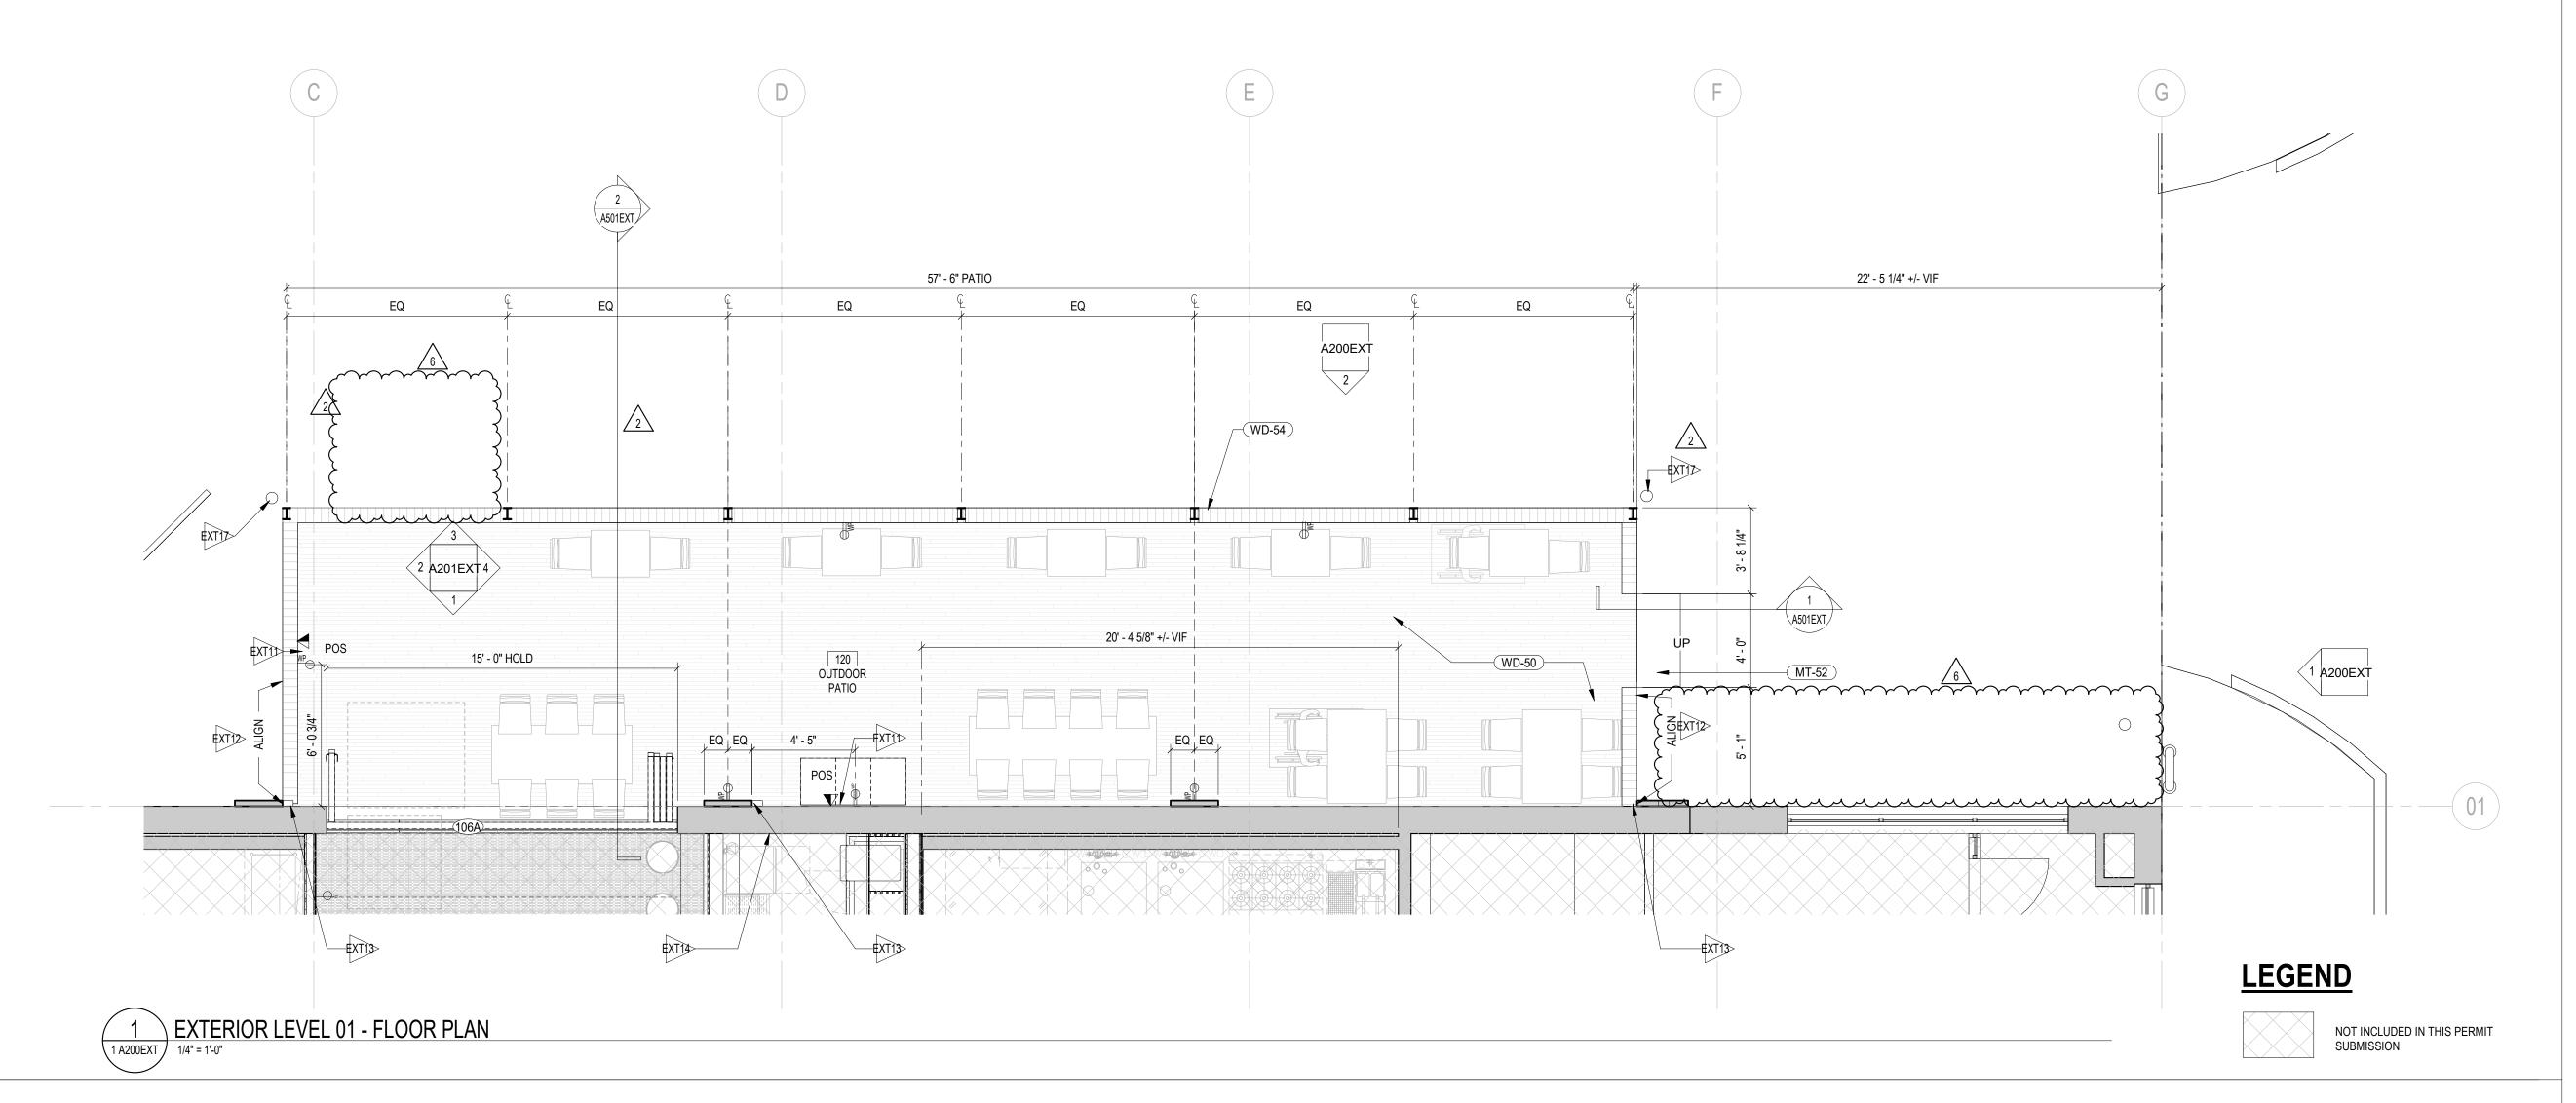

GENERAL NOTES - EXTERIOR

- AREAS SHOWN AS GRAY/NIC ARE OUTSIDE SCOPE OF WORK.
 ALL DIMS SHOWN ARE FROM FACE OF FINISH.
- ARCHITECTURAL ELEMENTS SHOWN IN GRAY ARE EXISTING TO REMAIN.
 ALL ELEMENTS NOTED AS EXISTING TO REMAIN SHALL BE PRESERVED AND PROTECTED BY THE GC BEFORE
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 GC TO COORDINATE GUTTER EXTENSIONS BELOW PROPOSED PATIO WORK TO MAINTAIN ADEQUATE ROOF AND SIDE DRAINAGE.
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 REFER TO ELEVATIONS FOR ADDITIONAL WALL FINISHES AS TAGGED & SCHEDULED.
 SURFACES TO BE PAINTED MUST BE CLEAN. DRY. AND FREE OF DIRT DUST, GREASE, OIL, SOAP, WAX, SCALING PAINT, WATER SOLUBLE MATERIALS, AND MILDEW. REMOVE ANY PEELING OR SCALING PAINT AND SAND THESE AREAS TO FEATHER EDGES SMOOTH WITH ADJACENT SURFACES. GLOSSY AREAS SHOULD BE DULLED. DRYWALL SURFACES MUST BE FREE OF SANDING DUST.
- FINISH WALLS AS SPECIFIED IN PLAN AND ELEVATION.
 FURNISH AND INSTALL MILLWORK AS DETAILED, REFER TO MILLWORK DETAILS FOR MORE INFO.
 GC TO EVALUATE EXISTING SITE CONDITIONS PRIOR TO STARTING WORK. EXTERIOR SITE SLOPING SHOWN FOR REFERENCE ONLY, ALL SLOPPED AND HEIGHTS TO BE VERIFIED IN THE FILED BEFORE STARTING WORK.

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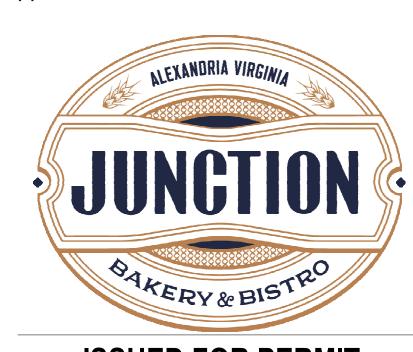
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[T] 703.854.1028
[W] WWW.EHLERT-BRYAN.COM



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PROJECT: JUNCTION BAKERY - ALEXANDRIA

ADDRESS: 1508 MT VERNON AVENUE ALEXANDRIA, VA 22301

SHEET SUBMISSION INDEX

• EXTERIOR PERMIT - 3.31.2023


NO. REVISION DATE

2 EXTERIOR PERMIT REVISION 19 JUNE 2023

REVISED 1/25/2024

SUP/EXTERIOR PERMIT REVISION 25 JAN 2024

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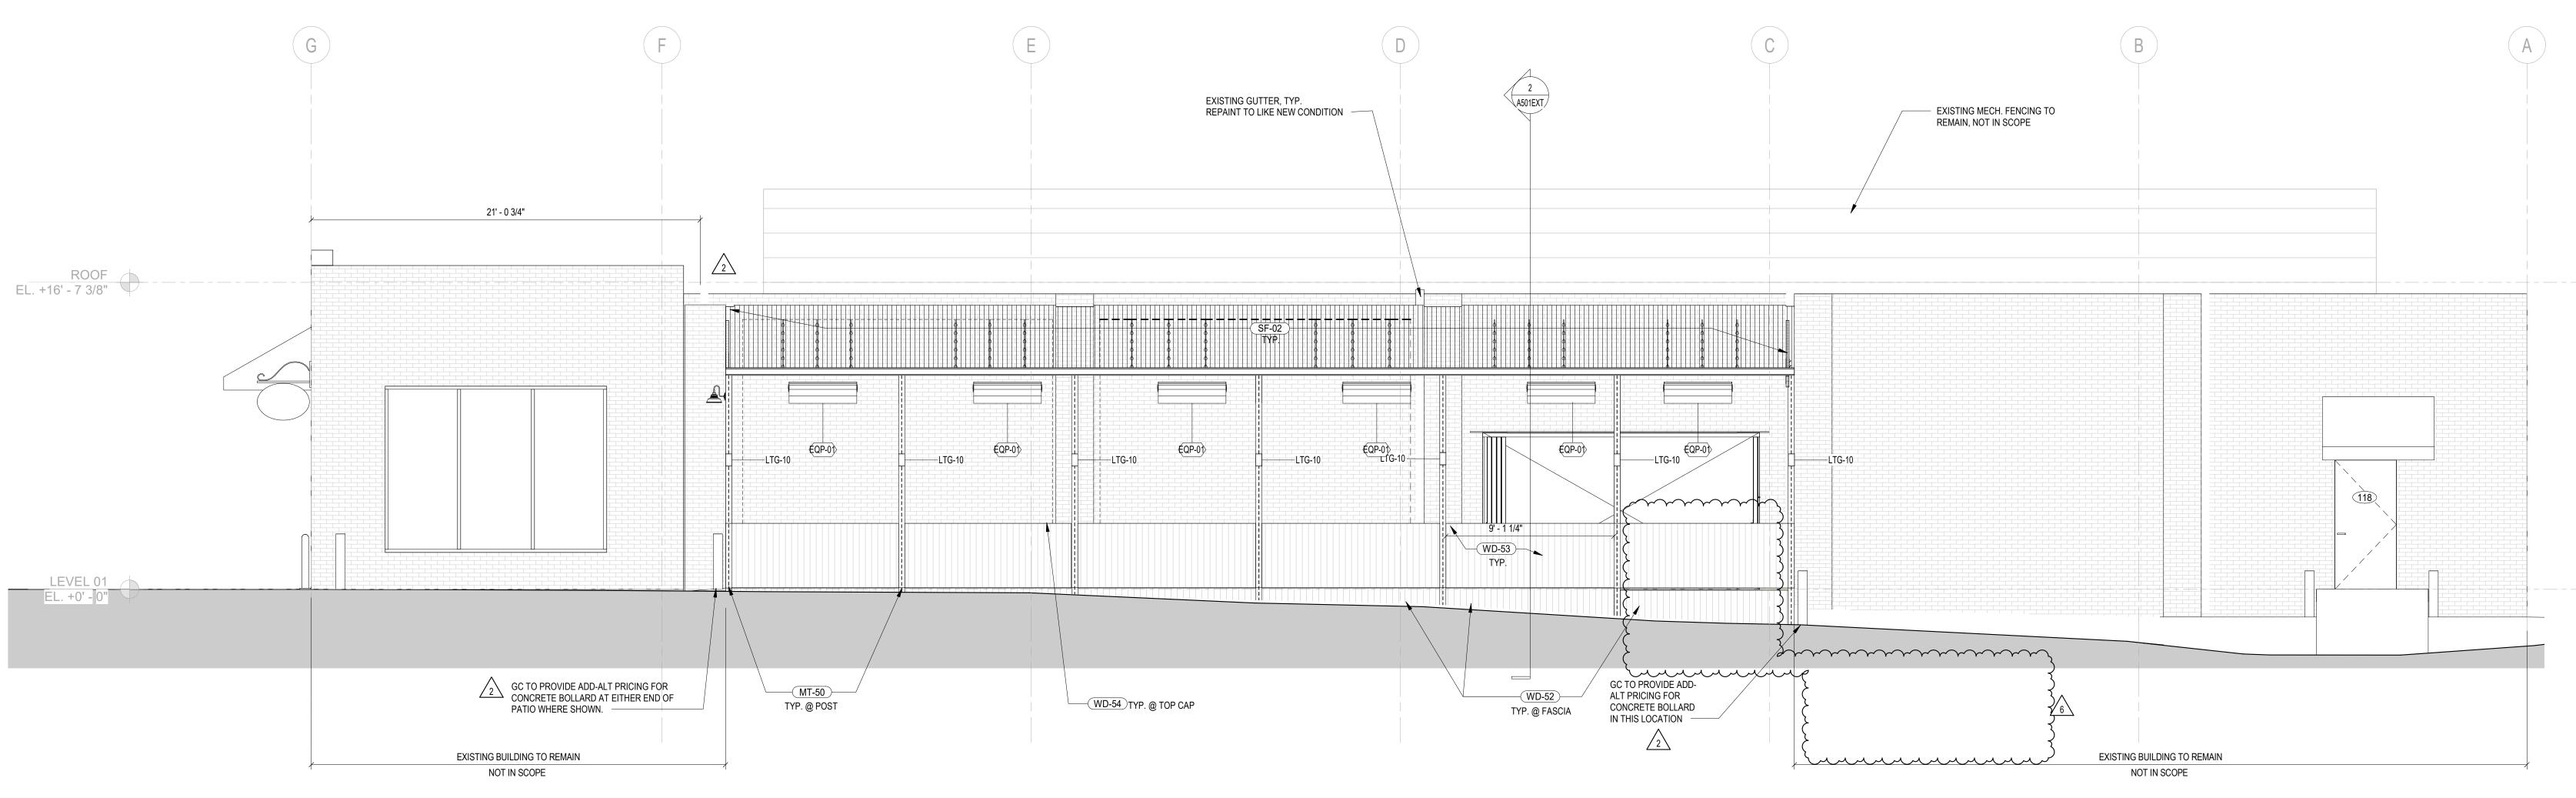
SHEET TITLE: LEVEL 1 - PLANS

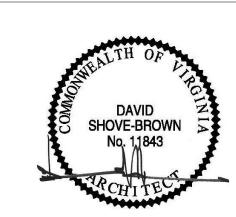PROJECT NO: 2020.72

DATE ISSUED: 02/08/23


SCALE: As indicated

A101E



2 EXTERIOR ELEVATION - SIDE ELEVATION

1/4" = 1'-0"

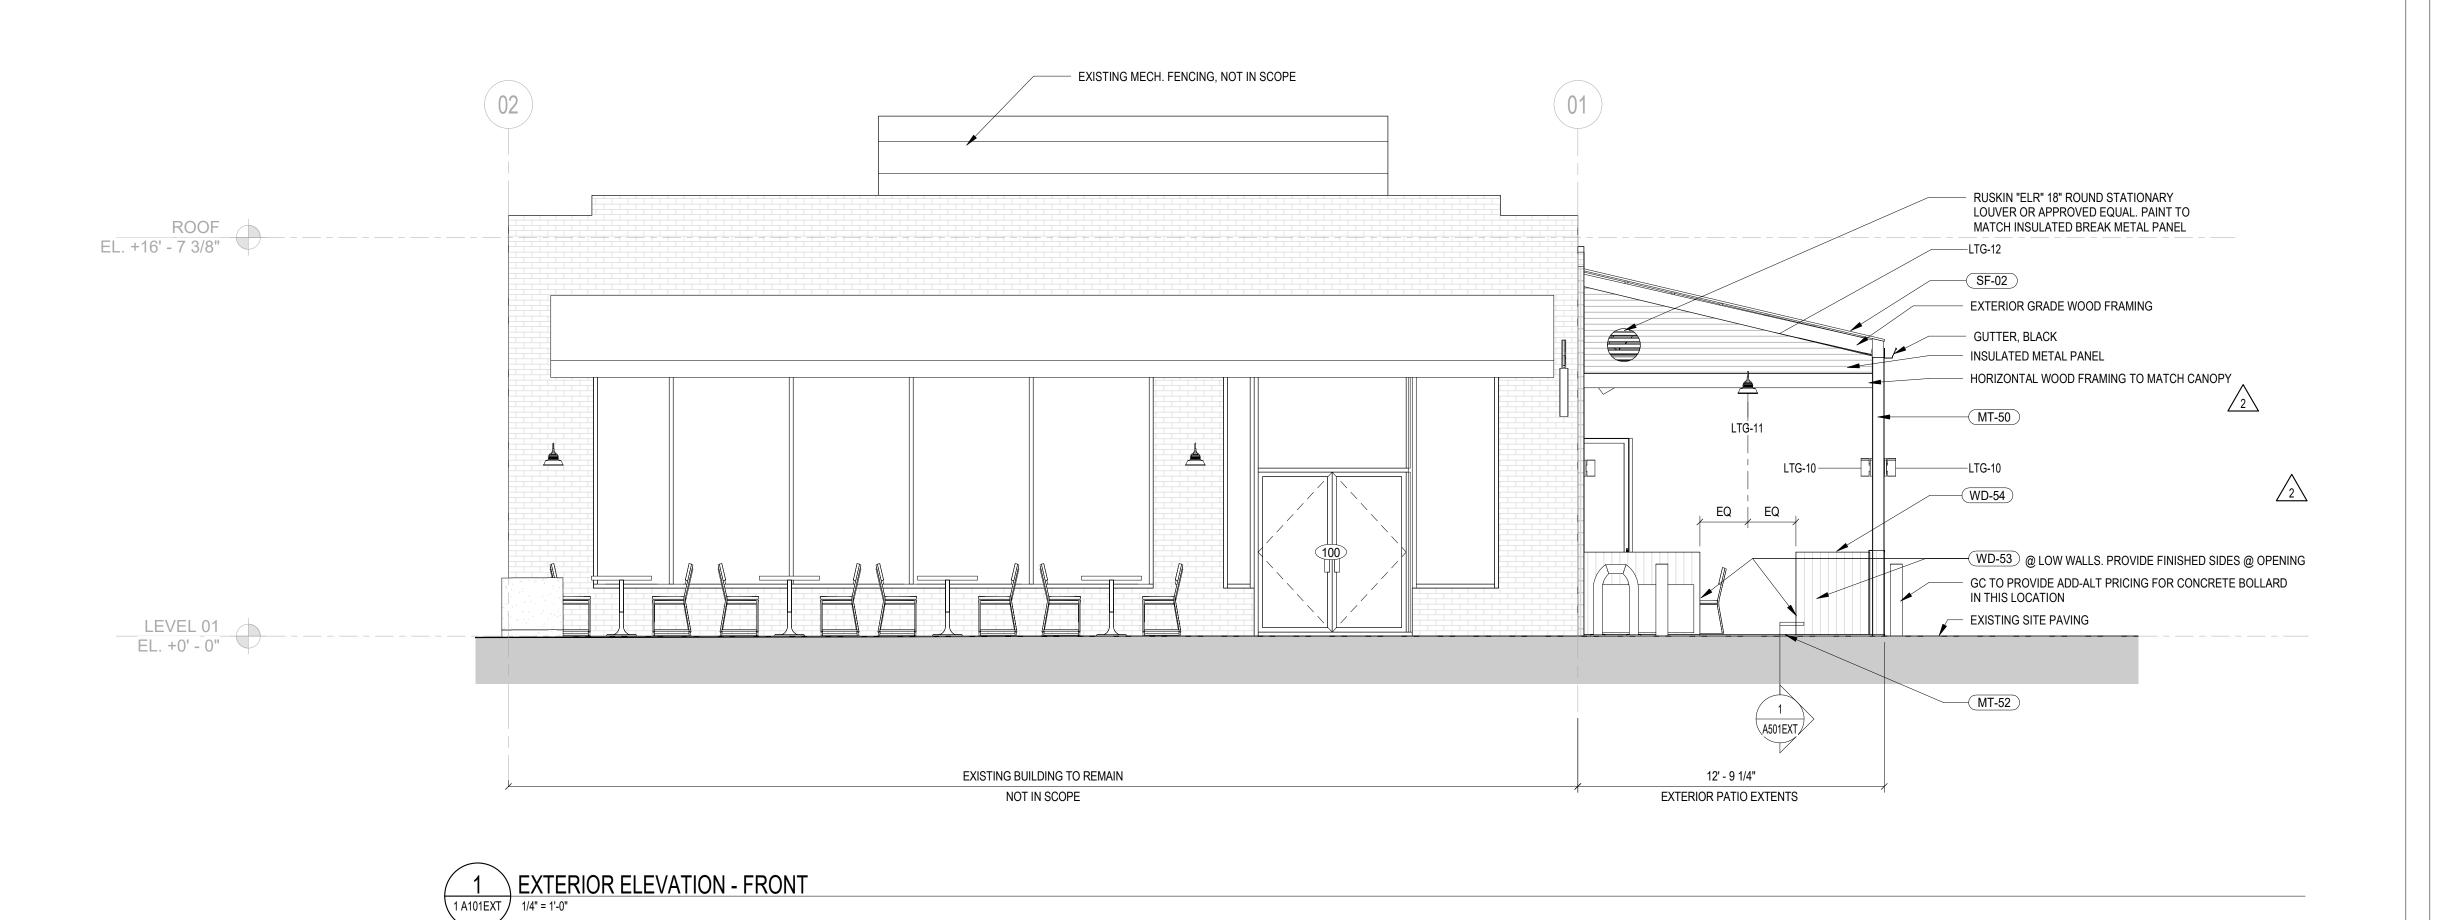

GENERAL NOTES - EXTERIOR

A. AREAS SHOWN AS GRAY/NIC ARE OUTSIDE SCOPE OF WORK.
B. ALL DIMS SHOWN ARE FROM FACE OF FINISH.

SURFACES MUST BE FREE OF SANDING DUST.

- ARCHITECTURAL ELEMENTS SHOWN IN GRAY ARE EXISTING TO REMAIN.

 ALL ELEMENTS NOTED AS EXISTING TO REMAIN SHALL BE PRESERVED AND PROTECTED BY THE GC BEFORE
- BEGINNING DEMOLITION.
 GC TO COORDINATE GUTTER EXTENSIONS BELOW PROPOSED PATIO WORK TO MAINTAIN ADEQUATE ROOF AND SIDE DRAINAGE.
- F. REFER TO FINISH SCHEDULE FOR MATERIAL SPECIFICATIONS. INSTALL PER MANUFACTURER RECOMMENDATIONS.
 G. REFER TO ELEVATIONS FOR ADDITIONAL WALL FINISHES AS TAGGED & SCHEDULED.
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 K. GC TO EVALUATE EXISTING SITE CONDITIONS PRIOR TO STARTING WORK. EXTERIOR SITE SLOPING SHOWN FOR REFERENCE ONLY, ALL SLOPPED AND HEIGHTS TO BE VERIFIED IN THE FILED BEFORE STARTING WORK.

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BAKER'S BREAD LLC 115 KING STREET ALEXANDRIA, VA 22314 **GENERAL CONTRACTOR:** 5256 EISENHOWER AVE ALEXANDRIA, VA 22304 [T] 571.233.8585 [W] WWW.TECH24CONSTRUCTION.COM ARCHITECT: //3877 3333 K STREET NW, SUITE 60 WASHINGTON DC 20007 [T] 202.350.4244 [W] WWW.3877.DESIGN **MEP ENGINEER:** BUILT ENVIRONMENT ENGINEERS 6861 ELM STREET SUITE 2D MCLEAN, VA 22101 [T] 703.888.0649 [W] WWW.BEENGRS.COM <u>STRUCTURAL ENGINEER :</u> EHLERT BRYAN 8609 WESTWOOD CENTER DRIVE

TYSONS, VA 22182



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PROJECT: JUNCTION BAKERY - ALEXANDRIA

ADDRESS: 1508 MT VERNON AVENUE ALEXANDRIA, VA 22301

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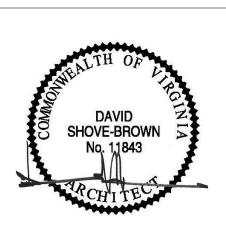
• EXTERIOR PERMIT - 3.31.2023

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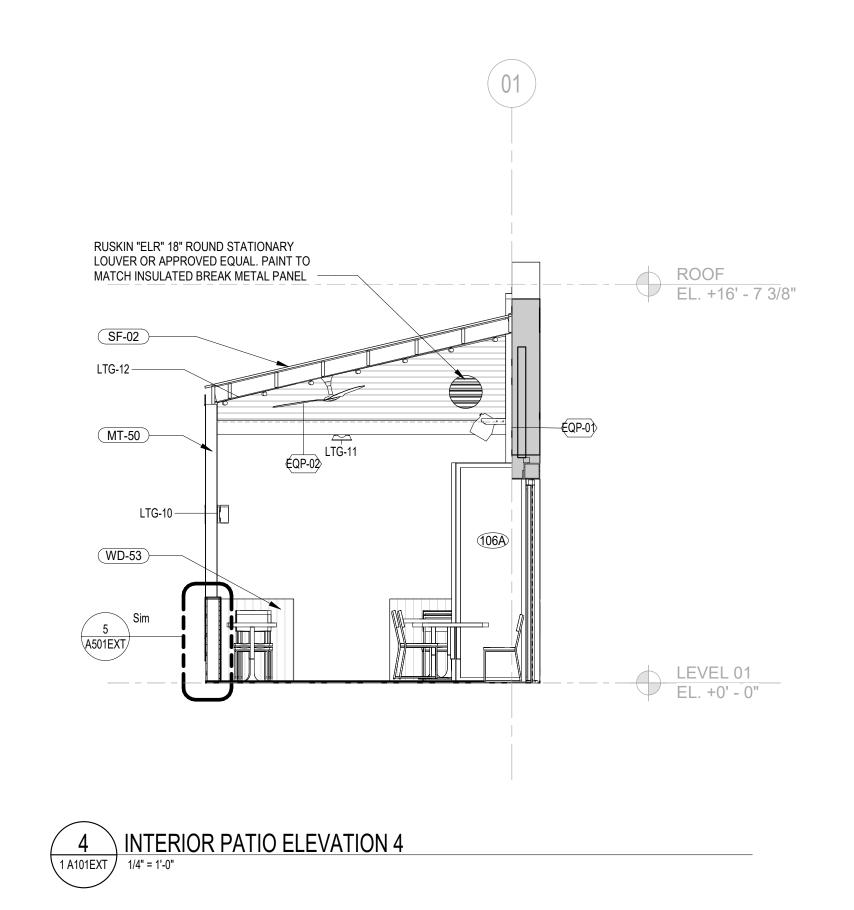
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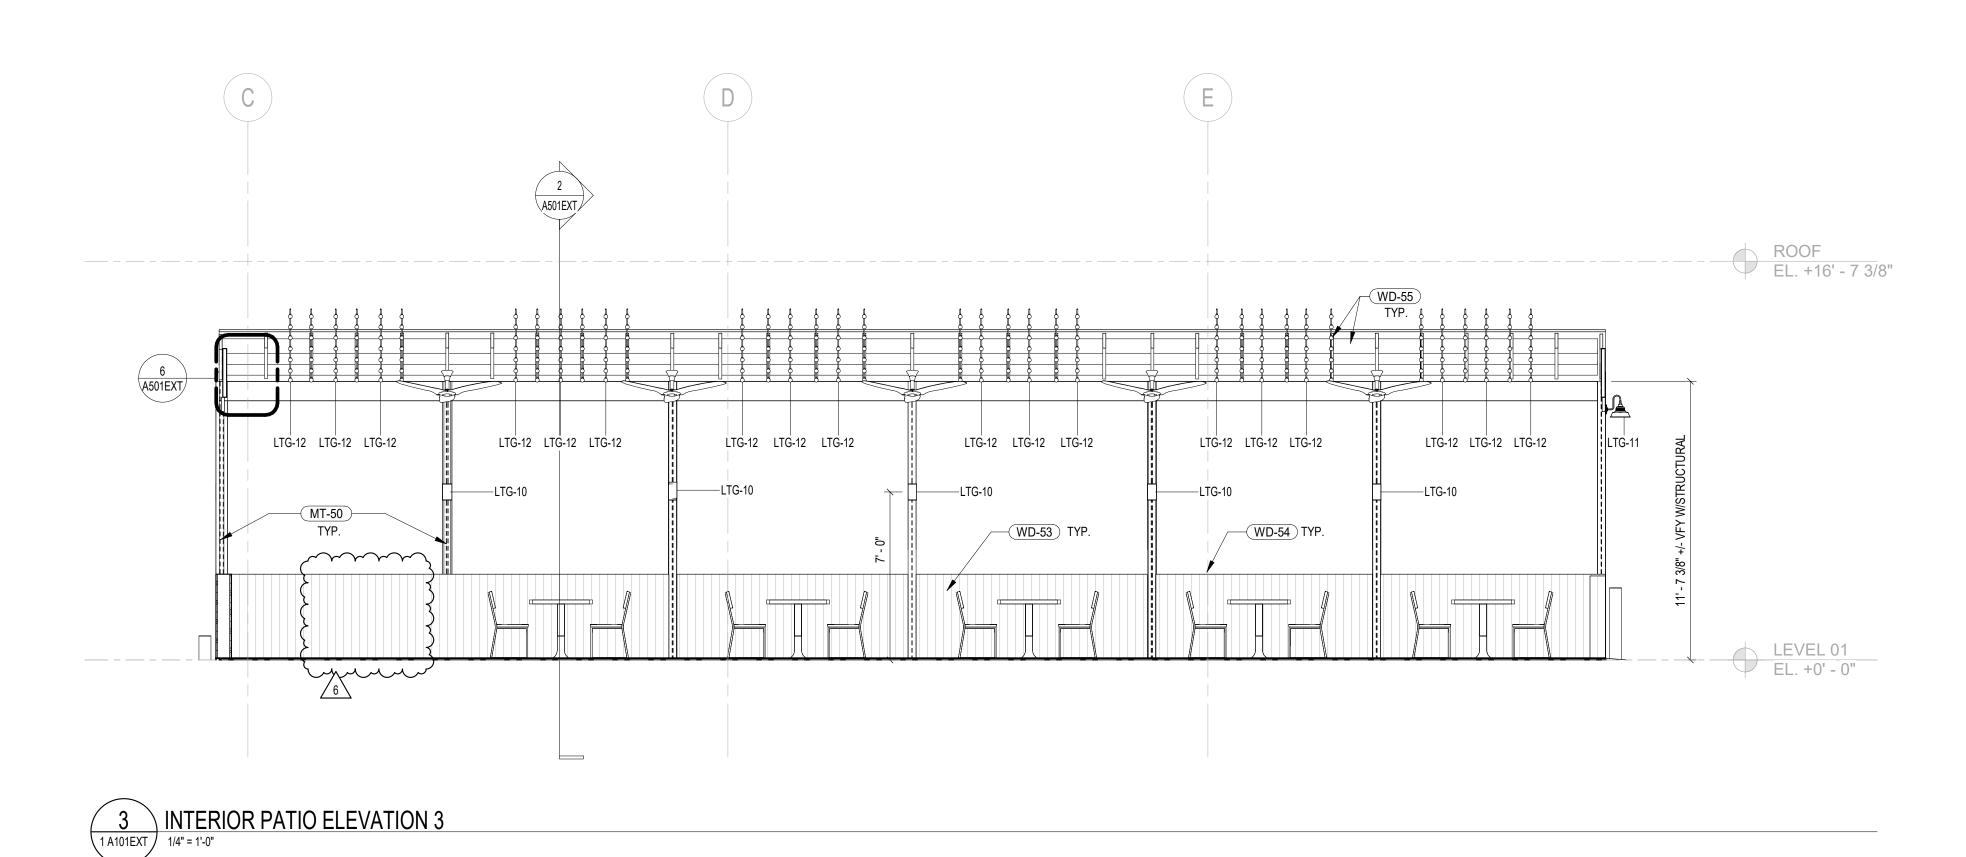
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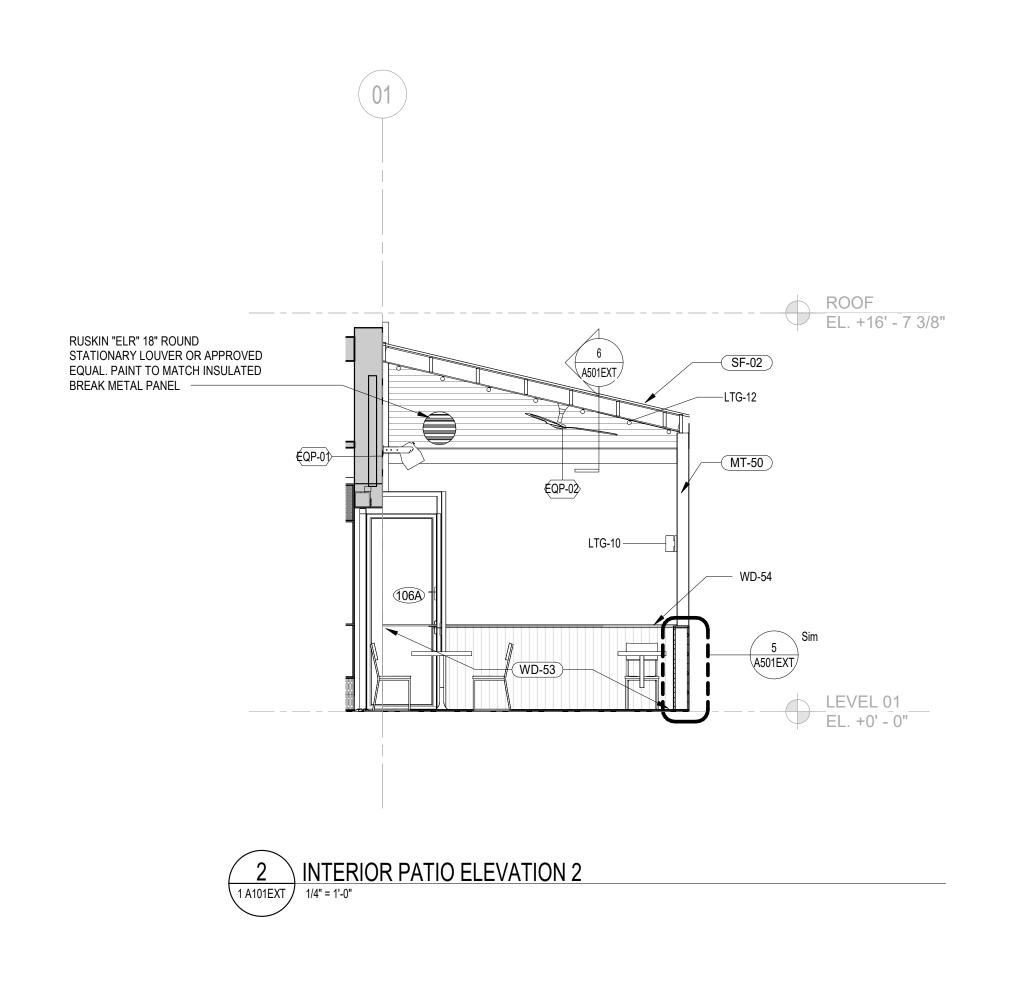
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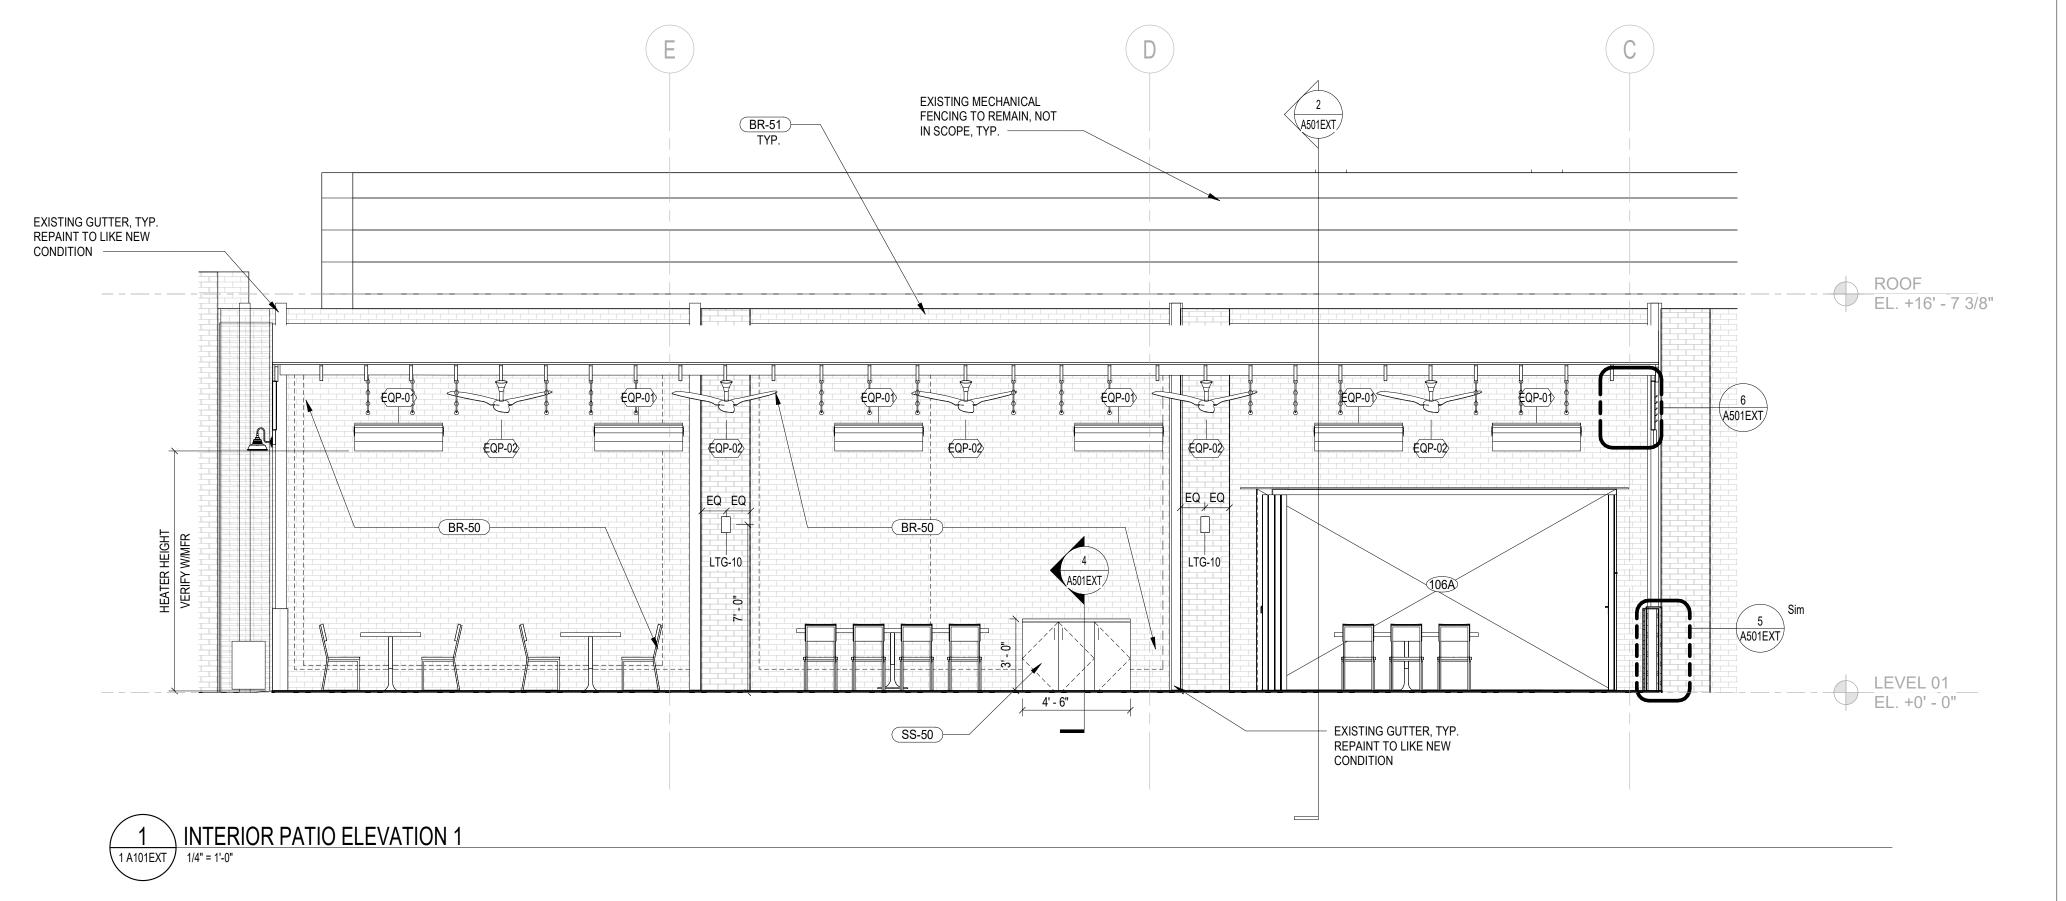
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8609 WESTWOOD CENTER DRIVE

TYSONS, VA 22182



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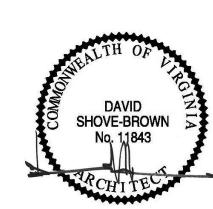
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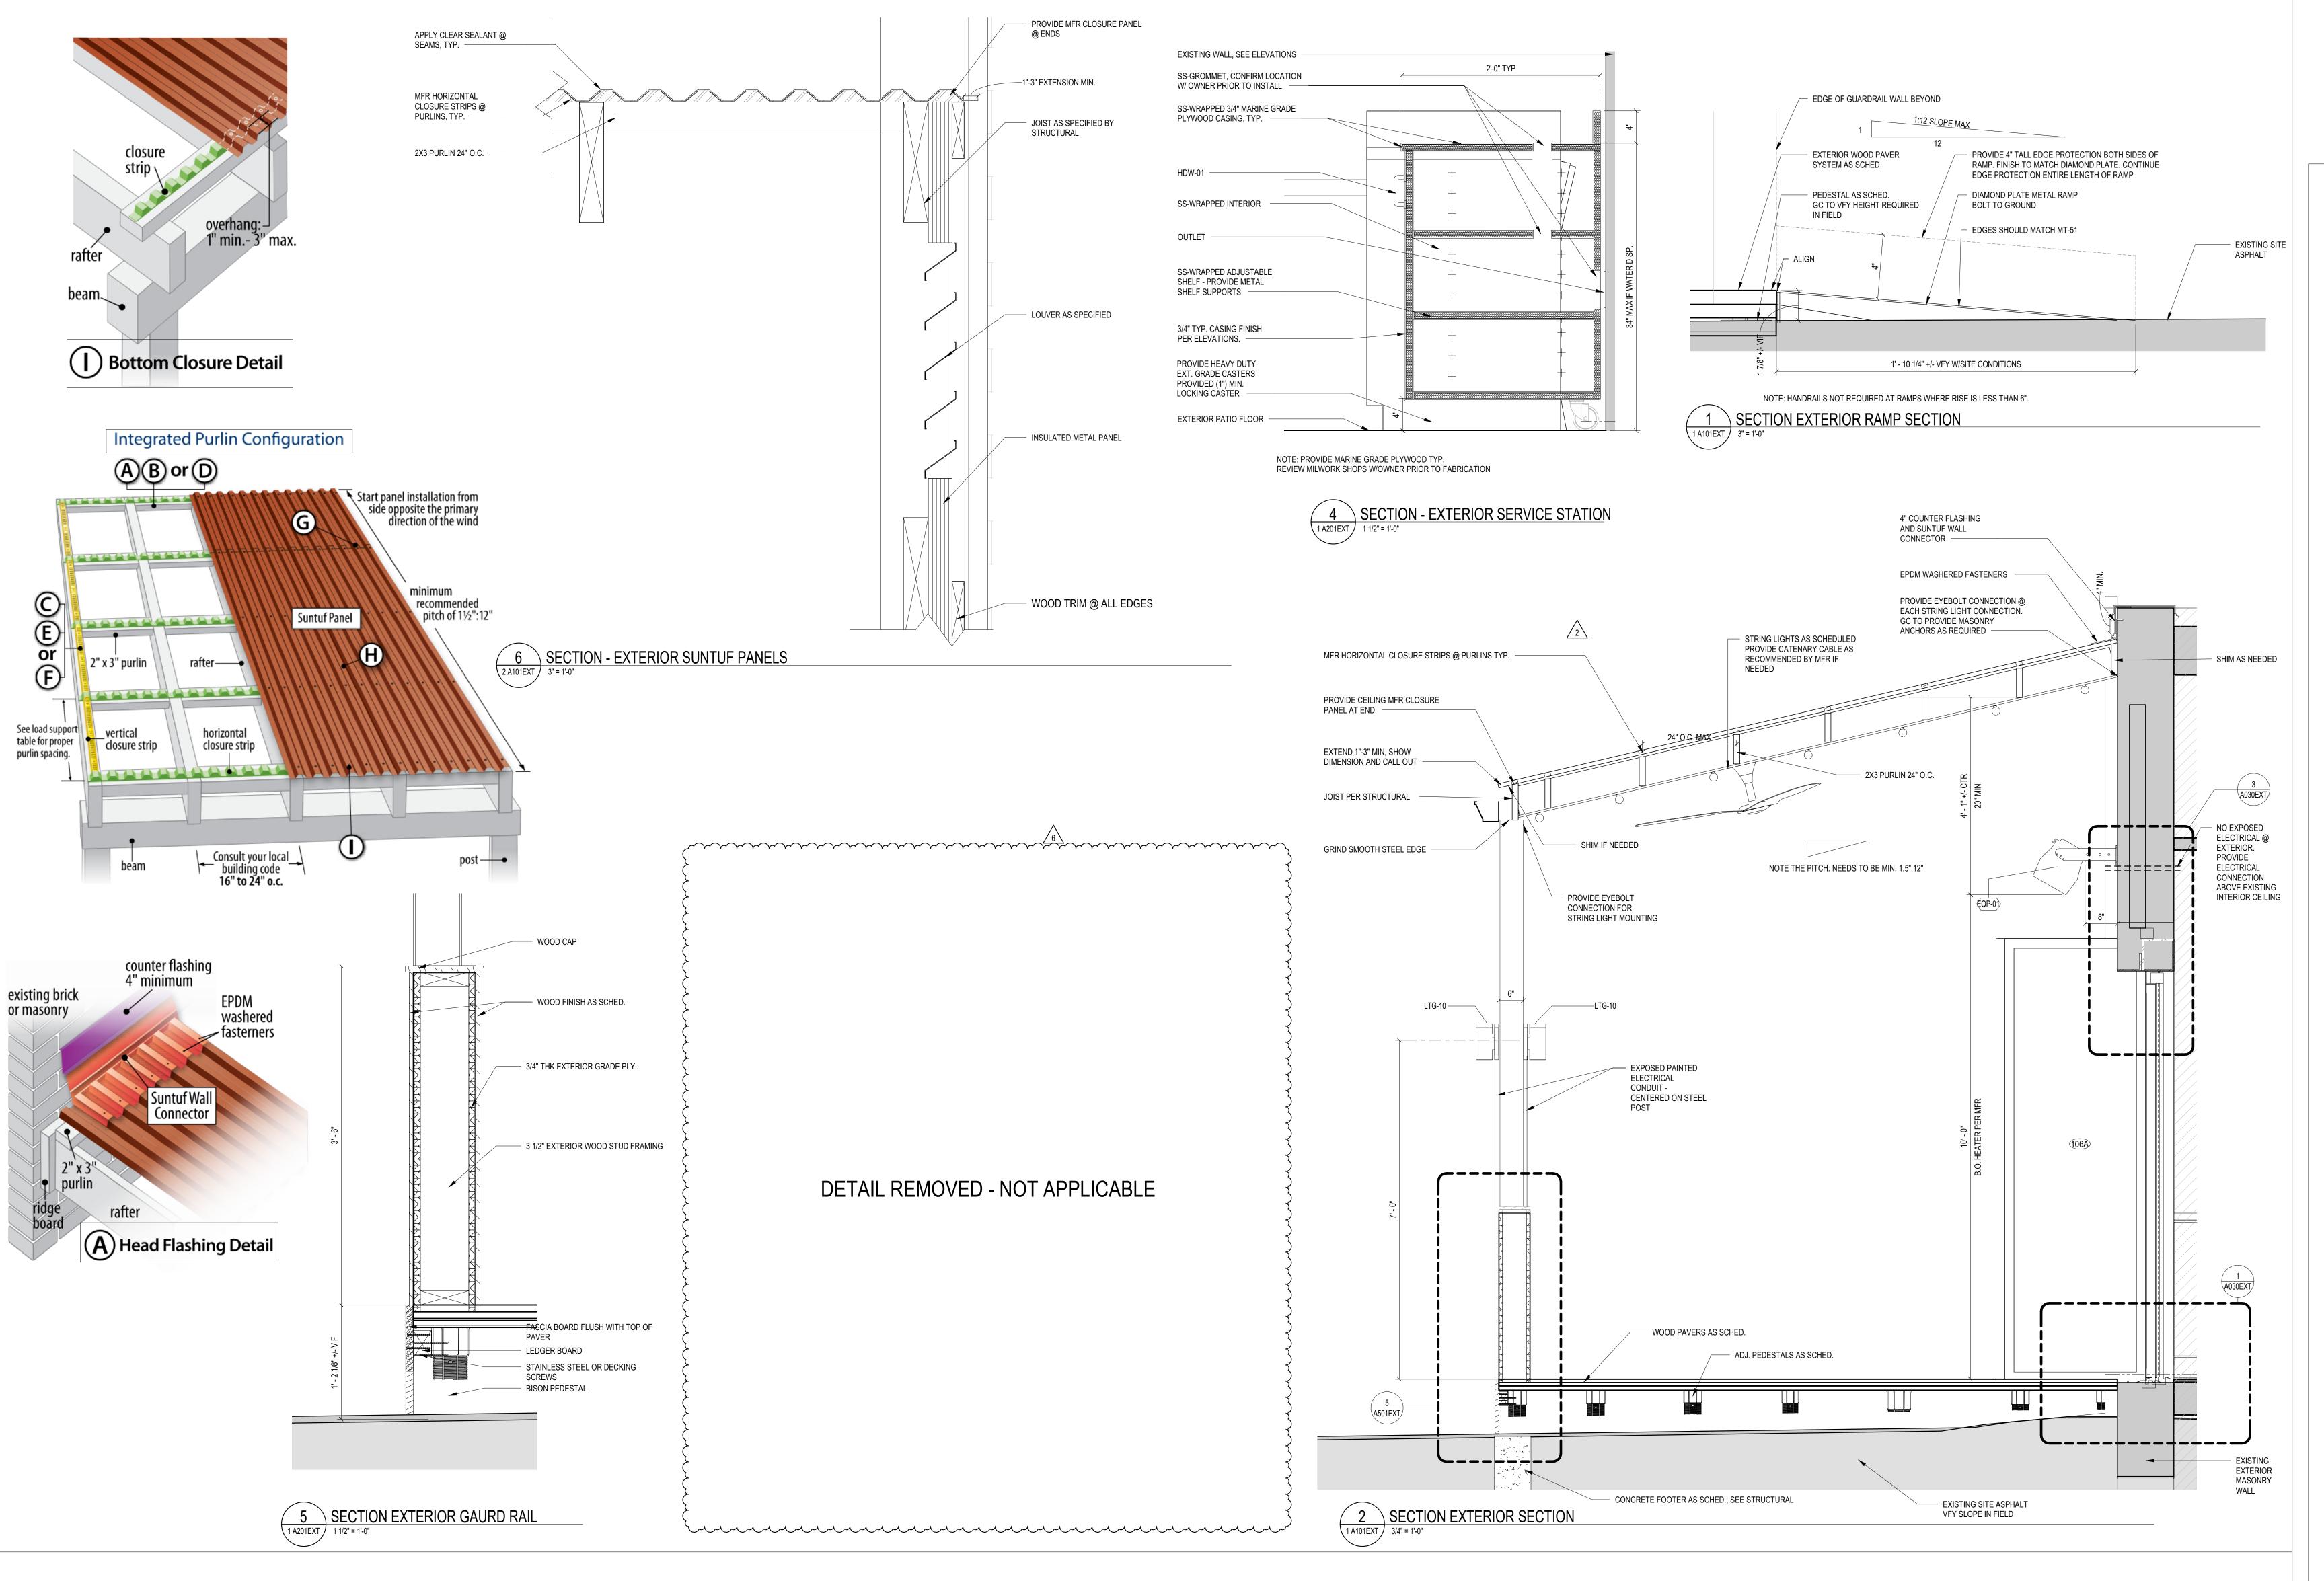
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SHEET TITLE: PATIO ELEVATIONS

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STRUCTURAL ENGINEER:
EHLERT BRYAN
8609 WESTWOOD CENTER DRIVE

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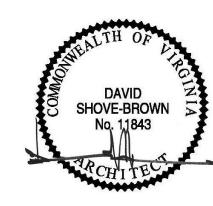
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SHEET TITLE: CONSTRUCTION DETAILS

PROJECT NO: 2020.72

DATE ISSUED: 02/08/23

SCALE: As indicated

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STRUCTURAL NOTES

GENERAL

A. THE MODIFICATIONS TO THE BUILDING ARE DESIGNED UNDER THE PROVISIONS OF THE 2018

INTERNATIONAL BUILDING CODE AND ASCE 7-16. B. THE FOLLOWING LOADS WERE USED IN THE DESIGN:

ROOF RAIN LOAD (R), PER ASCE 7 SECTION 8.3

BUILDING RISK CATEGORY

ROOF LIVE LOAD MINIMUM UNIFORM ROOF LIVE LOAD 30 PSF / 300 PT LOAD

ROOF SNOW LOAD GROUND SNOW LOAD (Pg) 25 PSF FLAT-ROOF SNOW LOAD (Pf) 21 PSF SNOW EXPOSURE FACTOR (Ce) SNOW LOAD IMPORTANCE FACTOR (Is) THERMAL FACTOR (Ct)

WIND SPEED (3-SECOND GUST)

115 MPH Vasd: (0.77*VULT) 90 MPH WIND EXPOSURE

CONFORMANCE. CONTRACTOR IS RESPONSIBLE FOR DIMENSIONS.

C. SEE ARCHITECTURAL DRAWINGS FOR ANGLES, CLIPS, PLATES, ETC., AND OTHER MISCELLANEOUS ITEMS. VERIFY AND COORDINATE ALL FRAMES, OPENINGS, ETC. WITH THE MECHANICAL AND ELECTRICAL CONTRACTORS.

D. SUBMIT SHOP DRAWINGS FOR THE FOLLOWING ITEMS. SUBMITTALS INCLUDE BUT MAY NOT BE LIMITED

--CONCRETE MIX DESIGN --REINFORCING STEEL --STRUCTURAL STEEL

--POLYCARBONATE ROOF SHEATHING

DO NOT USE CONTRACT DRAWINGS AS A BASE FOR SHOPS. REVIEW IS LIMITED TO DESIGN

EARTHWORK

A. FOUNDATIONS ARE DESIGNED TO BEAR ON ENGINEERED FILL OR NATURAL SOIL WITH A CAPACITY OF 1,500 PSF. THIS VALUE IS TO BE VERIFIED IN THE FIELD BY THE BUILDING INSPECTOR OR A QUALIFIED TESTING AGENCY.

B. BOTTOM OF ALL EXTERIOR FOOTINGS SHALL BE A MINIMUM OF 2 FOOT-6 INCH BELOW FINISH EXTERIOR GRADE. WHERE REQUIRED, STEP FOOTINGS IN RATIO OF 2 HORIZONTAL TO 1 VERTICAL.

C. COMPACTED BACKFILL BELOW BUILDING SLABS AND FOOTINGS: ALL SOIL FILL MATERIAL MUST BE APPROVED BY SOILS ENGINEER PRIOR TO PLACEMENT. PROOFROLL SUBGRADE REMOVING AND REPLACING SOFT OR COMPRESSIVE MATERIALS. FILL MATERIAL SHALL BE PLACED IN LAYERS NOT TO EXCEED 8 INCHES AND COMPACTED TO MIN. 95 PERCENT OF THE DRY MAXIMUM DENSITY AS DETERMINED BY ASTM D698.

DEMOLITION

A. CONTRACTOR SHALL VERIFY THAT EXISTING CONSTRUCTION CORRESPONDS TO THAT SHOWN ON THE DRAWINGS. DISCREPANCIES SHALL BE IMMEDIATELY BROUGHT TO THE ATTENTION OF THE ARCHITECT/ENGINEER.

B. PROVIDE ADEQUATE SHORING, BRACING AND OTHER TEMPORARY SUPPORT DURING DEMOLITION. UNTIL PROPERLY SHORED, DO NOT CUT EXISTING STRUCTURAL MEMBER IN A MANNER RESULTING IN A REDUCTION OF LOAD-CARRYING CAPACITY. DO NOT EXCEED THE CAPACITY OF THE EXISTING STRUCTURE WITH SUPERIMPOSED LOADS.

CONCRETE

A. CONCRETE CONSTRUCTION SHALL BE PER THE APPLICABLE BUILDING CODE, ACI 318 AND ACI 301, LATEST

B. CONCRETE SHALL ATTAIN THE FOLLOWING 28 DAY COMPRESSIVE STRENGTHS PER ASTM A39.

C. VERIFY CONCRETE STRENGTHS WITH A MINIMUM OF ONE SET OF NINE 4X8-INCH COMPRESSION CYLINDERS, (3 @ 7 DAYS, 3 @ 28, 3 SPARE).

D. EXTERIOR CONCRETE SHALL BE AIR-ENTRAINED TO PROVIDE AN AIR CONTENT OF 6+/-1.5 PERCENT BY

E. PROVIDE CLEAR DISTANCE TO OUTERMOST REINFORCING, UNO, AS FOLLOWS:

CONCRETE CAST AGAINST EARTH 3 INCHES

F. NON-SHRINK GROUT FOR COLUMNS BASE PLATES SHALL ATTAIN A 28 DAY COMPRESSIVE STRENGTH: F'c

G. REINFORCING STEEL SHALL CONFORM TO A615-GR60; MESH SHALL CONFORM TO ASTM A185 WITH MINIMUM LAPS OF 8 INCHES. PLACING PLANS AND SHOP FABRICATION DETAILS SHALL BE IN ACCORDANCE WITH "THE MANUAL OF STANDARD PRACTICE FOR DETAILING REINFORCED CONCRETE STRUCTURES". FURNISH SUPPORT BARS AND ACCESSORIES IN ACCORDANCE WITH C.R.S.I. STANDARDS.

STEEL

A. STEEL CONSTRUCTION SHALL BE CONSTRUCTED IN ACCORDANCE WITH THE APPLICABLE BUILDING CODE AND SHALL CONFORM TO AISC 360. STRUCTURAL STEEL SHALL CONFORM TO THE FOLLOWING ASTM STANDARDS:

STEEL PLATES AND ANGLES STRUCTURAL RECT/ROUND (HSS) ANCHOR RODS (3/4" DIAM. OR LESS)

HIGH-STRENGTH BOLTS

A572 GRADE 50 A500 - GR C F1554 - 36 KSI

B. WELDING OF STRUCTURAL STEEL SHALL BE WITH E70XX ELECTRODES.

WOOD FRAMING

A. FRAMING LUMBER FOR STUDS, HEADERS AND JOISTS SHALL BE HEM FIR (HF) #2, SPRUCE-PINE-FIR (SPF) #1/#2, OR BETTER, WITH A MAXIMUM MOISTURE CONTENT OF 19-PERCENT, HAVING THE FOLLOWING MINIMUM PROPERTIES (BASED ON 2X12 MEMBERS):

BENDING STRESS "Fb" HORIZONTAL SHEAR "Fv" COMPRESSION PERPENDICULAR TO GRAIN "Fc" = 405 PSI COMPRESSION PARALLEL TO GRAIN "Fc11"

= 850 PSI FOR SINGLE MEMBER USE = 1150 PSI = 1,300,000 PSI

MODULUS OF ELASTICITY "E"

COMPRESSION PARALLEL TO GRAIN "Fc11"

NOTES: SPF (SOUTH) IS NOT ACCEPTABLE. B. ALL EXPOSED EXTERIOR FRAMING AND FRAMING IN CONTACT WITH MASONRY OR CONCRETE SHALL BE PRESSURE-TREATED (PT). FRAMING SHALL BE PRESSURE-TREATED WITH ALAKALINE COPPER QUAT (ACQ) OR COPPER AZOLE (CBA-A AND CA-B), NOT SODIUM BORATE (SBX). PT LUMBER SHALL NOT BE

C. TREATED LUMBER (PT) SHALL BE SOUTHERN PINE (SP) #2 OR BETTER, HAVING THE FOLLOWING MINIMUM PROPERTIES (BASED ON 2X12 MEMBERS):

BENDING STRESS "Fb" HORIZONTAL SHEAR "Fv"

= 750 PSI SINGLE MEMBER USE = 175 PSI COMPRESSION PERPENDICULAR TO GRAIN "Fc" = 565 PSI

= 1,250 PSI

MODULUS OF ELASTICITY "E" = 1,400,000 PSI D. PREFABRICATED JOIST HANGERS, BEAM HANGERS, POST CAPS, AND POST BASES SHALL BE SIZED AND ATTACHED PER MANUFACTURER'S RECOMMENDATIONS, TO ACHIEVE AT LEAST THE MINIMUM MANUFACTURER LISTED CAPACITIES, UNO ON THE DRAWINGS. FASTENERS AND CONNECTORS UTILIZED WITH TREATED LUMBER (PT) SHALL MEET G185 HOT-DIPPED GALVANIZING. FASTENERS AND CONNECTORS UTILIZED WITH FIRE-RETARDANT TREATED LUMBER (FRT) SHALL MEET G90 HOT-DIPPED

E. ANCHOR BOLTS CONNECTING PRESSURE-TREATED WOOD PLATES TO FOUNDATIONS, MASONRY WALLS, OR CONCRETE SLABS SHALL BE HOT-DIPPED GALVANIZED.

F. ALL BOLTED CONNECTIONS, INCLUDING SILL ANCHOR BOLTS, THRU BOLTS AND LAGS SHALL HAVE A STANDARD CUT METAL WASHER BETWEEN THE WOOD MEMBER AND NUT, UNLESS A LARGER PLATE WASHER OR OTHER IS NOTED ON THE DRAWINGS.

G. NAILS FOR FRAMING AND SHEATHING CONNECTIONS SPECIFIED IN THE DRAWINGS AND ASSOCIATED NOTES SHALL CONFORM TO ASTM F1667 AND SHALL MEET THE FOLLOWING MINIMUM SIZE REQUIREMENTS:

TYPE DIAMETER x LENGTH 0.131" x 2-1/2"

0.148" x 3" 0.148" x 3-1/4" 0.162" x 3-1/2" 0.192" x 4" MINIMUM STRENGTH SHANK DIAMETER

0.099" TO 0.142"

0.143" TO 0.177"

0.178" TO 0.254" 80 KSI NOTE: NAILS USED IN STANDARD CONNECTIONS SHALL BE SIZED PER THE REQUIREMENTS OF THE BUILDING CODE.

100 KSI

90 KSI

H. ROOF MEMBERS SHALL BE CONNECTED AT EACH BEARING POINT WITH ONE PREFABRICATED GALVANIZED METAL ANCHOR. ANCHORS SHALL BE 18 GAGE MINIMUM AND SHALL BE ATTACHED TO HAVE A CAPACITY TO RESIST A 450# UPLIFT LOADING, UNLESS SHOWN OTHERWISE ON DRAWINGS.

I. DO NOT SPLICE STRUCTURAL MEMBERS BETWEEN SUPPORTS.

7. POST-INSTALLED ANCHORS IN CONCRETE AND MASONRY

A. GENERAL

INSTALL ANCHORS IN STRICT CONFORMANCE WITH THE MANUFACTURER'S PUBLISHED INSTALLATION INSTRUCTIONS AND PROCEDURES. ALL POST-INSTALLED ANCHORS IN CONCRETE SHALL HAVE ICC APPROVAL FOR USE IN CRACKED CONCRETE.

SUBSTITUTION REQUESTS FOR ALTERNATE PRODUCTS MUST BE SUBMITTED FOR APPROVAL PRIOR TO USE. CONTRACTOR SHALL PROVIDE LOAD CAPACITIES DEMONSTRATING THAT THE SUBSTITUTED PRODUCT IS CAPABLE OF ACHIEVING THE PERFORMANCE VALUES OF THE SPECIFIED PRODUCT.

PROVIDE STAINLESS STEEL FASTENERS FOR EXTERIOR USE OR WHEN PERMANENTLY EXPOSED TO WEATHER. PROVIDE GALVANIZED CARBON STEEL ANCHORS AT OTHER LOCATIONS, UNLESS OTHERWISE NOTED.

B. PRODUCTS

ANCHORS IN CONCRETE --EXPANSION ANCHORS SHALL BE HILTI KWIK BOLT TZ2. --UNDERCUT ANCHORS SHALL BE HILTI HDA-P.

-- SCREW ANCHORS SHALL BE HILTI KWIK HUS EZ. --ADHESIVE ANCHORS SHALL BE HILTI HIT-HY 200 SAFE SET SYSTEM WITH HILTI HIT-Z ROD OR WITH HILTI HOLLOW DRILL BIT SYSTEM WITH HAS-E THREADED ROD.

ANCHORS IN MASONRY: --EXPANSION ANCHORS SHALL BE HILTI KWIK BOLT TZ2. GROUT MASONRY CELLS SOLID WITH 2000 PSI GROUT AT ANCHOR LOCATIONS. --SCREW ANCHORS SHALL BE HILTI KWIK HUS EZ. GROUT MASONRY CELLS SOLID WITH 2000 PSI GROUT AT ANCHOR LOCATIONS.

--ADHESIVE ANCHORS IN SOLID MASONRY SHALL BE HILTI HIT-HY 270 ADHESIVE ANCHORING

SYSTEM. STEEL ANCHOR ELEMENT SHALL BE HILTI HAS-E CONTINUOUSLY THREADED ROD OR HILTI HIS-N INTERNALLY THREADED INSERT. --ADHESIVE ANCHORS IN HOLLOW OR MULTI-WYTHE MASONRY SHALL BE HILTI HIT-HY 270 ADHESIVE ANCHORING SYSTEM. STEEL ANCHOR ELEMENT SHALL BE HILTI HAS-E CONTINUOUSLY THREADED ROD OR HILTI HIT-IC INTERNALLY THREADED INSERT. THE APPROPRIATE SIZE SCREEN TUBE SHALL BE USED PER THE ADHESIVE MANUFACTURER'S

RECOMMENDATION.

SUBSTITUTIONS: SUBSTITUTIONS FOR THE SPECIFIED ANCHORS SHALL BE SUBMITTED AS REQUESTED ABOVE. FOR ADHESIVE ANCHORS, PROPOSED SUBSTITUTE PRODUCTS SHALL INCLUDE THE FOLLOWING BASIS

OF DESIGN PARAMETERS: ANCHORS IN CONCRETE: -CRACKED CONCRETE

ADHESIVE ANCHORS IN CONCRETE:

-CRACKED CONCRETE -WATER SATURATED CONCRETE

-BASE MATERIAL TEMPERATURE OF 50-100 DEGREES FAHRENHEIT (AT INSTALLATION). -BASE MATERIAL IN-SERVICE TEMPERATURE OF 110 DEGREES FAHRENHEIT (LONG TERM), 130 DEGREES FAHRENHEIT (SHORT TERM)

ADHESIVE ANCHORS IN MASONRY: -BASE MATERIAL TEMPERATURE OF 50-100 DEGREES FAHRENHEIT (AT INSTALLATION). -BASE MATERIAL IN-SERVICE TEMPERATURE OF 110 DEGREES FAHRENHEIT (LONG TERM), 130 DEGREES FAHRENHEIT (SHORT TERM)

C. INSTALLATION

NON-DESTRUCTIVE MEANS.

ALL INSTALLATION PROCEDURES SHALL BE PER MANUFACTURERS RECOMMENDATIONS. COORDINATE AND/OR PROVIDE FOR THIRD PARTY INSPECTION AS REQUIRED BY BUILDING CODE OR LOCAL JURISDICTION.

ANCHOR CAPACITY IS DEPENDENT UPON SPACING BETWEEN ADJACENT ANCHORS AND PROXIMITY OF ANCHOR TO EDGE OF CONCRETE OR MASONRY. INSTALL ANCHORS IN ACCORDANCE WITH SPACING AND EDGE DISTANCE INDICATED ON THE DRAWINGS: IF NOT SHOWN, COMPLY WITH MINIMUM SPACING AND EDGE DISTANCE FOR FULL ANCHOR CAPACITY, AS SPECIFIED BY MANUFACTURER.


EXISTING REINFORCING BARS IN THE CONCRETE OR MASONRY STRUCTURE MAY CONFLICT WITH SPECIFIC ANCHOR LOCATIONS. DO NOT CUT OR DAMAGE REINFORCING BARS UNLESS SPECIFICALLY PERMITTED IN THE DRAWINGS.

PRIOR TO DRILLING, THE CONTRACTOR SHALL LOCATE REINFORCING BAR POSITIONS IN THE IMMEDIATE VICINITY OF PROPOSED POST-INSTALLED ANCHORS USING GPR, X-RAY, OR OTHER

WHEN CONFLICTS BETWEEN PROPOSED ANCHORS AND EXISTING REINFORCING BARS EXIST, SUBMIT RESULTS OF BAR LOCATIONS TO ARCHITECT / ENGINEER FOR REVIEW AND FURTHER DIRECTION.


WARNING: THE STRUCTURAL INTEGRITY OF THE BUILDING SHOWN ON THESE PLANS IS DEPENDENT UPON COMPLETION ACCORDING TO PLANS AND SPECIFICATIONS. STRUCTURAL MEMBERS ARE NOT SELF-BRACING UNTIL PERMANENTLY AFFIXED TO THE STRUCTURE. THE STRUCTURAL ENGINEERS ASSUME NO LIABILITY FOR THE STRUCTURE DURING CONSTRUCTION.



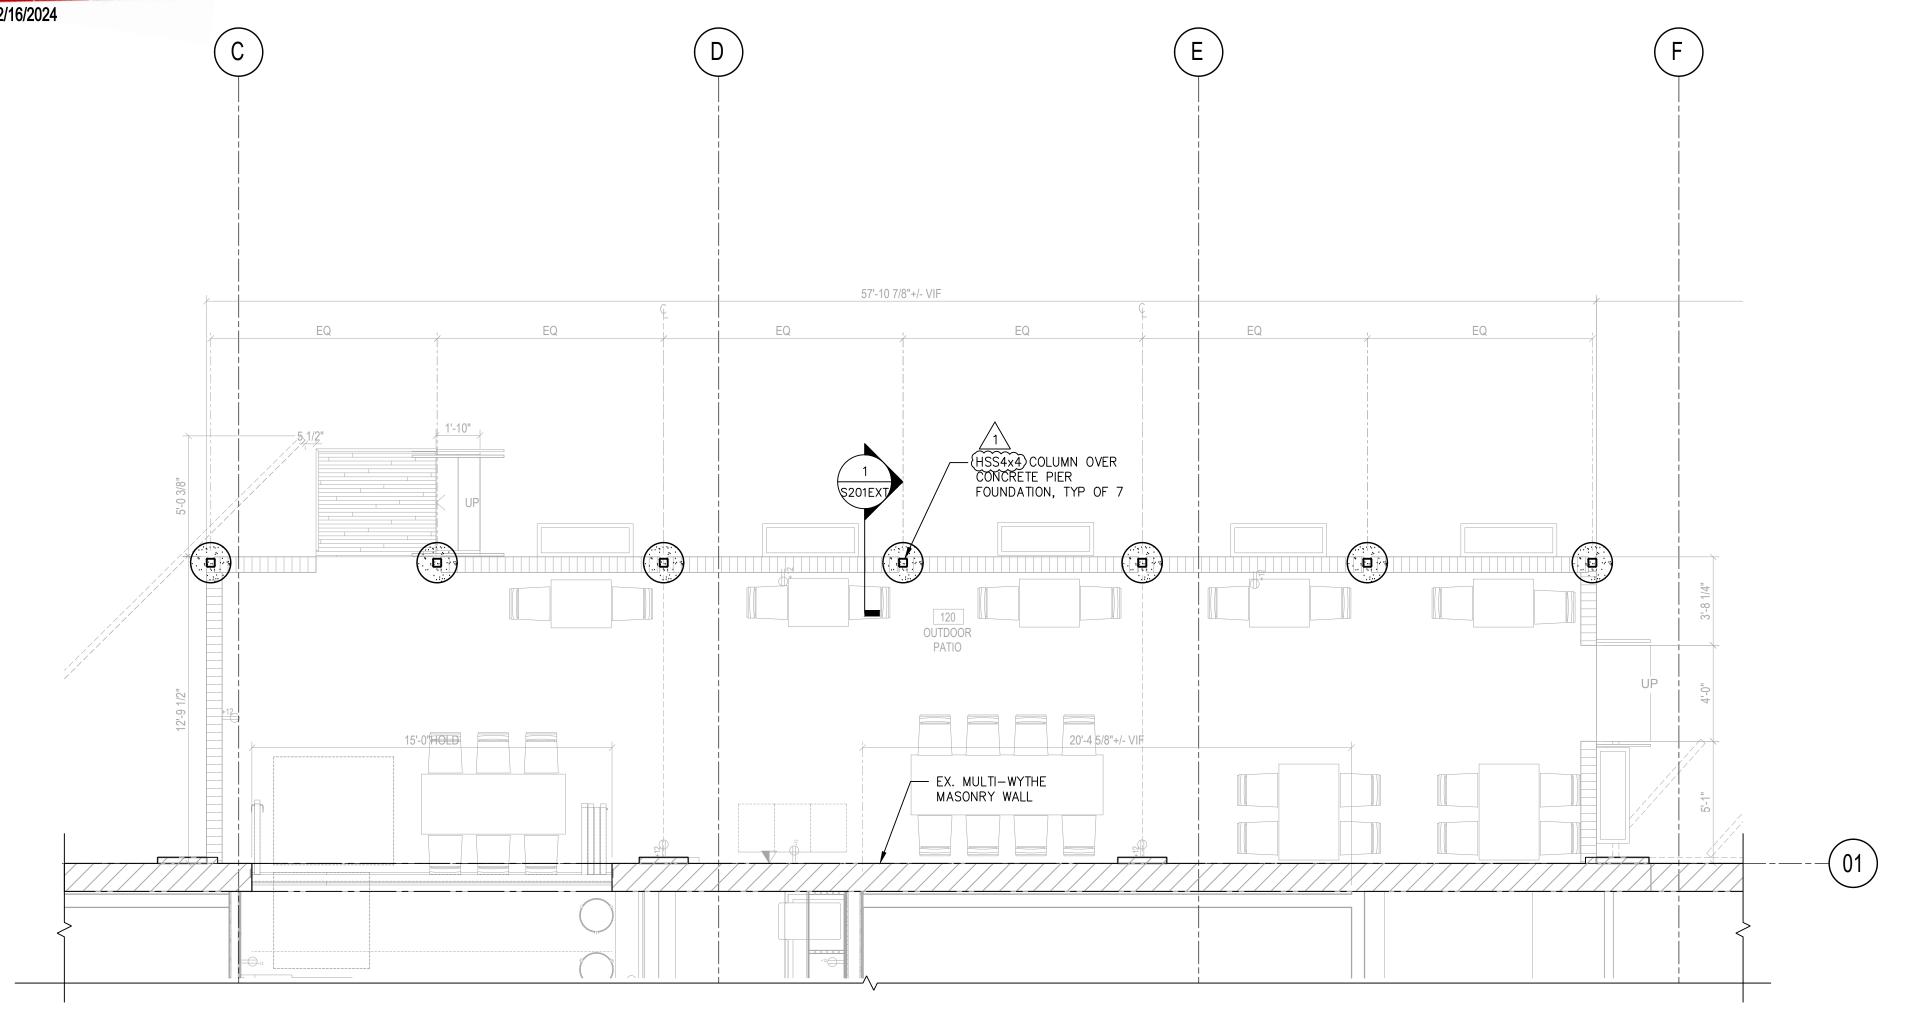

PARTIAL FOUNDATION PLAN

SCALE: 1/4" = 1'-0"

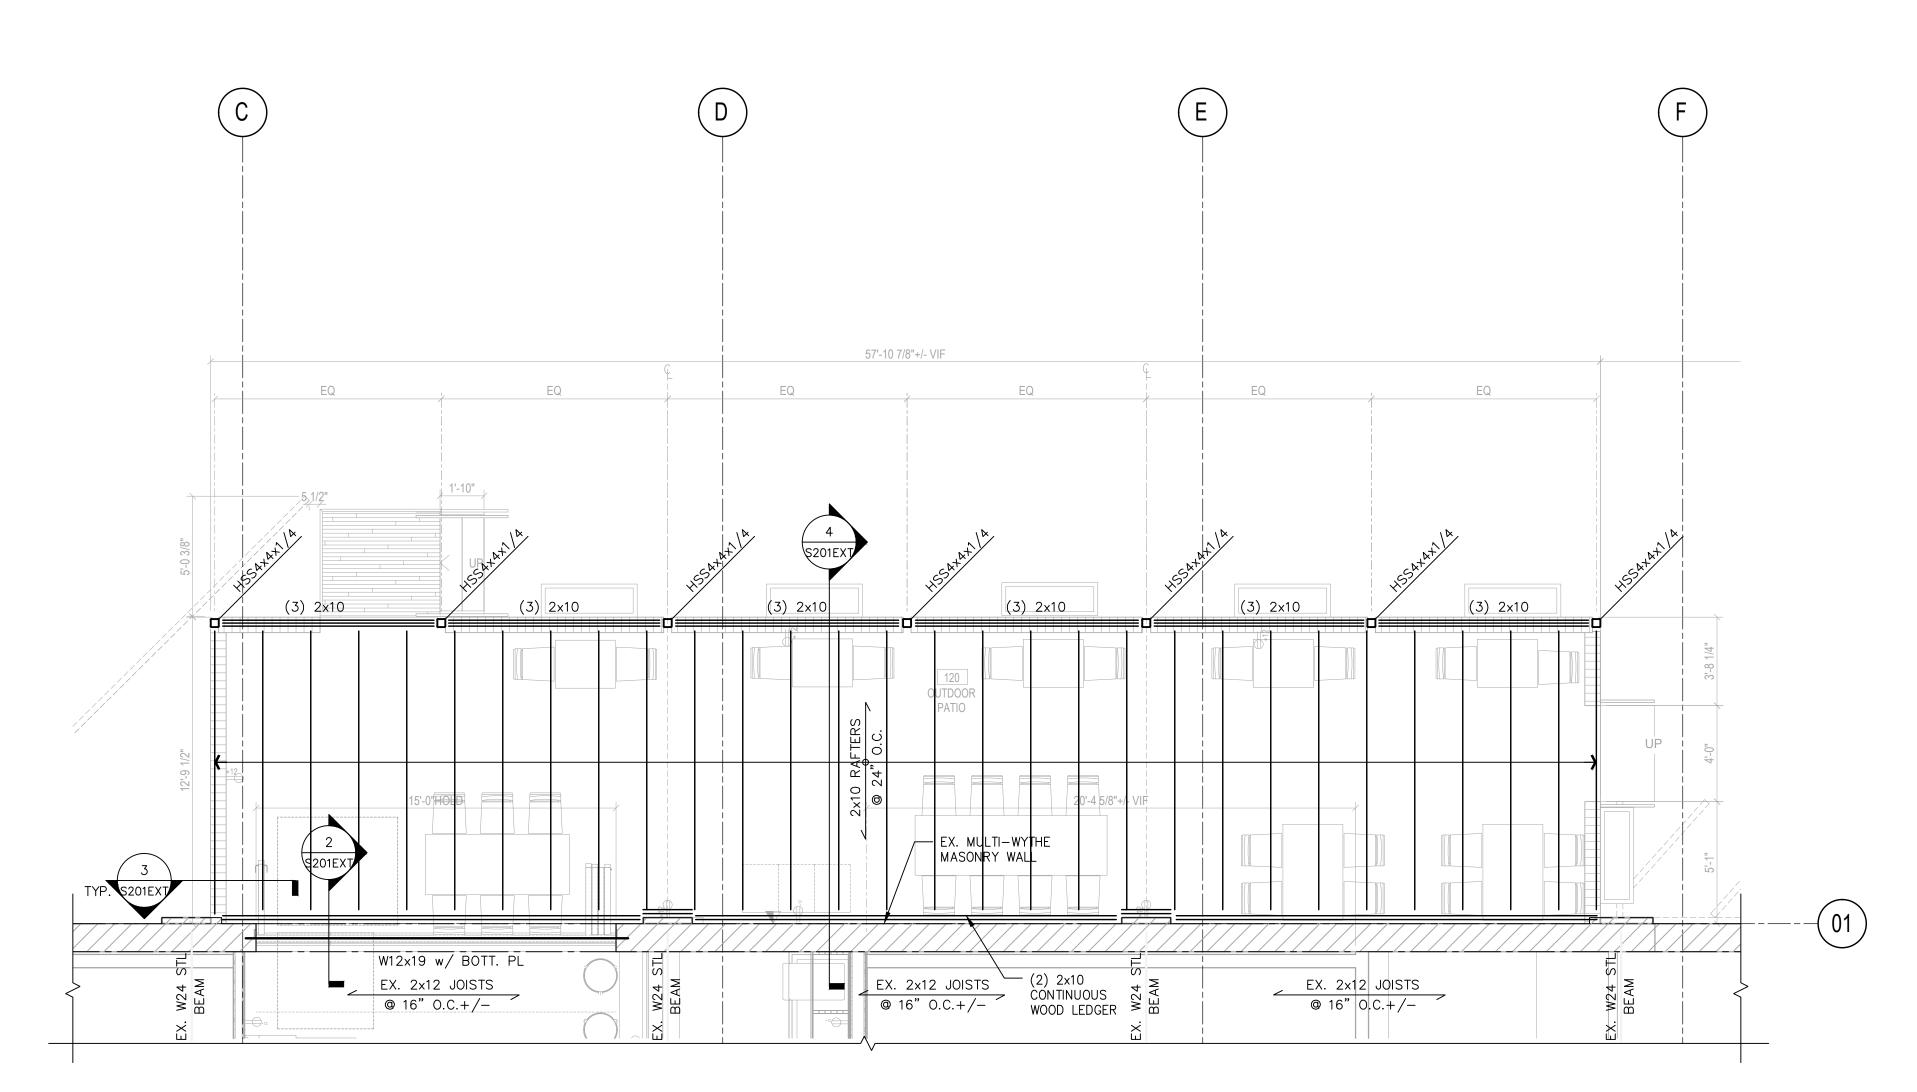

PARTIAL FRAMING PLAN SCALE: 1/4" = 1'-0"SEE ARCH FOR STEEL COATING REQUIREMENTS FOR DURABILITY.



w w w . 3 8 7 7 . d e s i g n

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BAKER'S BREAD LLC

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NOE LANDINI 115 KING STREET ALEXANDIRA, VA 22314 **GENERAL CONTRACTOR** TECH 24 VIC BONOMI 5256 EISENHOWER AVE ALEXANDRIA, VA 22304 [T] 571.233.8585 [W] WWW.TECH24CONSTRUCTION.COM 3333 K STREET NW, SUITE 60 WASHINGTON DC 20007 [T] 202.350.4244 [W] WWW.3877.DESIGN **BUILT ENVIRONMENT ENGINEERS** 6861 ELM STREET SUITE 2D MCLEAN, VA 22101 TT 703.888.0649

[W] WWW.BEENGRS.COM SINGER EQUIPMENT COMPANY 180 HELLER PLACE BELLMAWR, NJ 08031



ISSUED FOR PERMIT

DRAWING DATA

JUNCTION BAKERY -ALEXANDRIA

1508 MT VERNON AVENUE ALEXANDRIA, VA 22301

SHEET SUBMISSION INDEX

REVISION 1 EXTERIOR STRUCTURAL REVISION 06/19/2023


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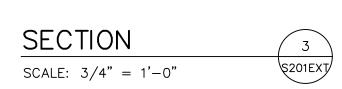



ENTER PROFESSIONAL CERTIFICATION TEXT HERE THAT IS REQUIRED FOR THE JURISDICTION WHERE DRAWINGS WILL BE SUBMITTED.

SHEET TITLE: STRUCTURAL NOTES, PARTIAL FOUNDATION AND FRAMING PLANS PROJECT NO: 2020.72 DATE ISSUED: 06/19/23

SCALE: As indicated



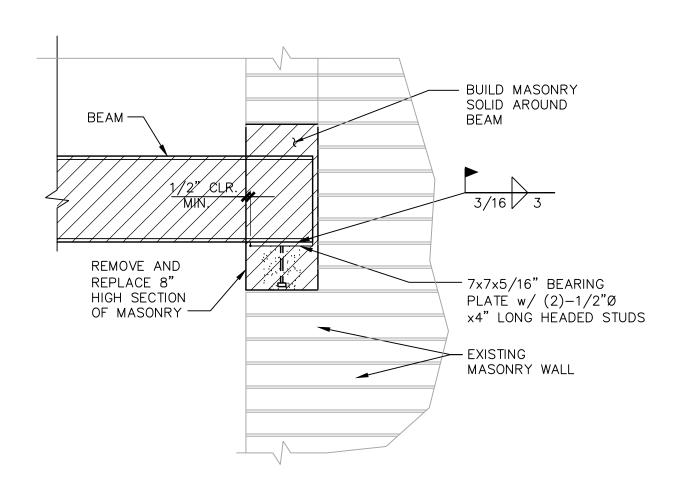

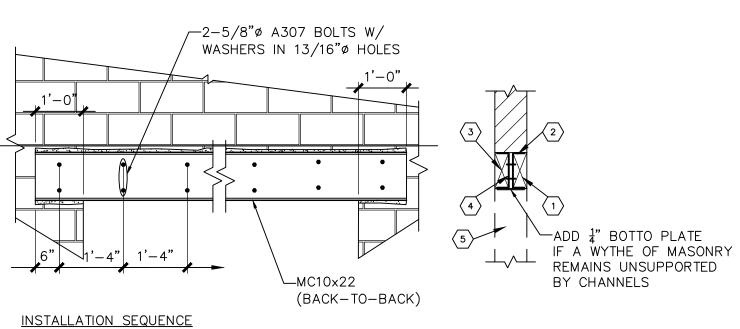

REMOVE 4" WYTHE OF MASONRY FOR FULL LENGTH OF OPENING + SUPPORT LENGTH.

(2) INSTALL STEEL CHANNEL AND MORTAR TIGHT TO BRICK ABOVE AND BELOW BEARING AT END. CURE 2 DAYS.


REMOVE REMAINING 4" WYTHE AND INSTALL SECOND CHANNEL ALIGNING HOLES WITH FIRST CHANNEL.


4 BOLT TO FIRST CHANNEL & MORTAR INTO PLACE.

ALTERNATE LINTEL INSTALLATION IN EXISTING WALL

(5) SAWCUT & REMOVE REMAINDER OF WALL. REPOINT BRICK @ EDGE.

SECTION 2A S201EXT

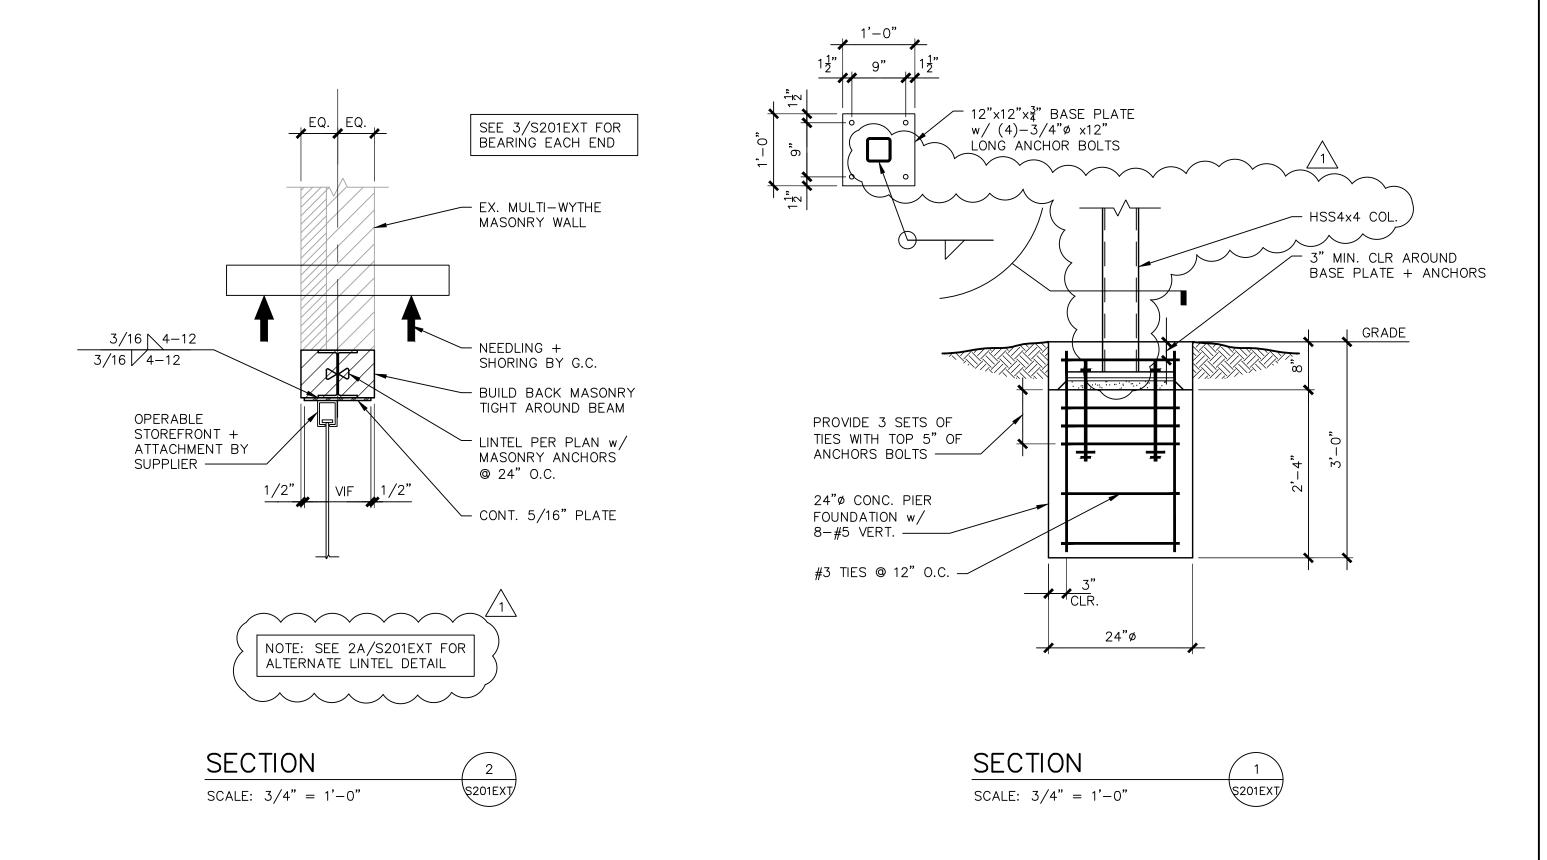

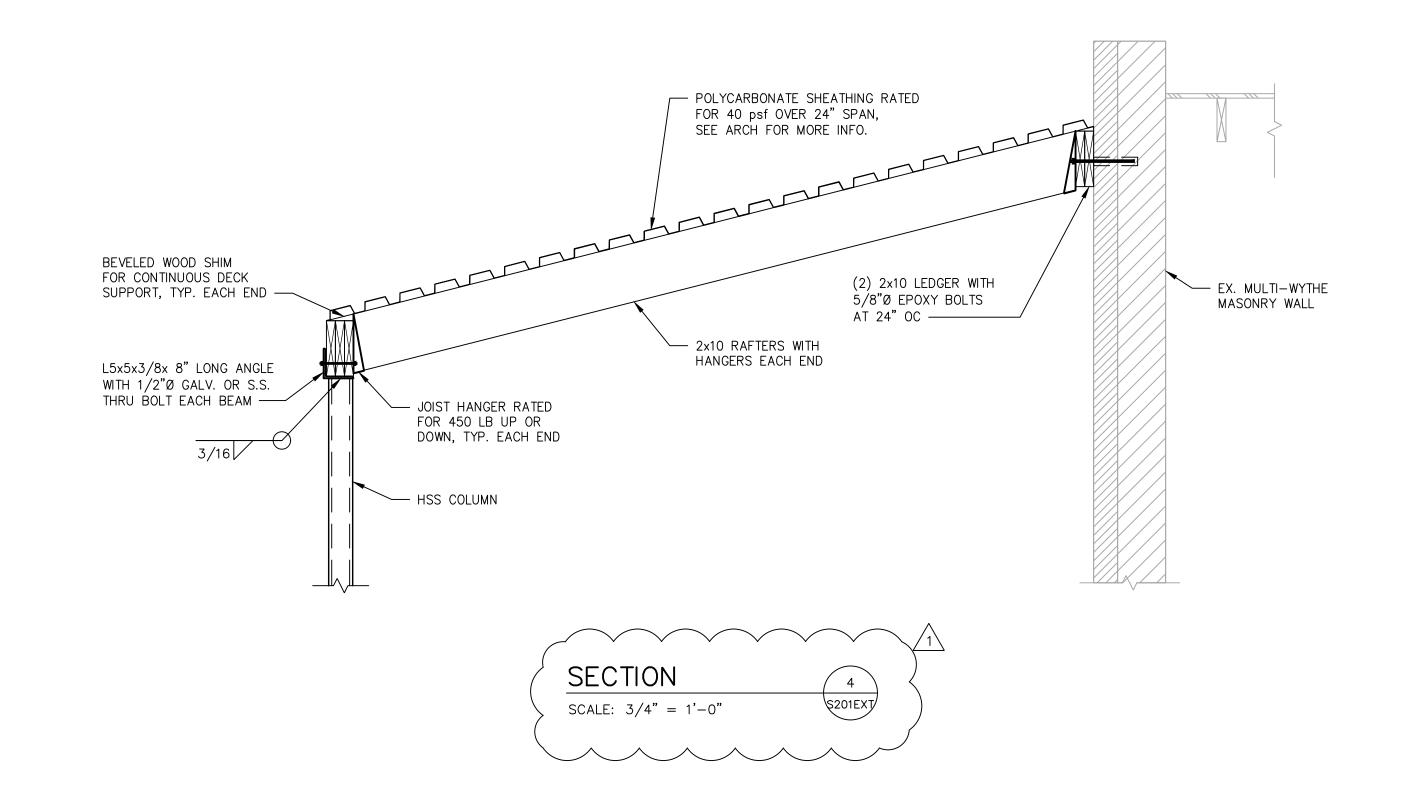



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OWNER:
BAKER'S BREAD LLC
NOE LANDINI
115 KING STREET
ALEXANDIRA, VA 22314

GENERAL CONTRACTOR:
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VIC BONOMI
5256 EISENHOWER AVE
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MEP ENGINEER:
BUILT ENVIRONMENT ENGINEERS
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MCLEAN, VA 22101

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[W] WWW.BEENGRS.COM

FOOD SERVICE:
SINGER EQUIPMENT COMPANY
JAMES FEUSTEL
180 HELLER PLACE

BELLMAWR, NJ 08031



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DRAWING DATA

JUNCTION BAKERY - ALEXANDRIA

ALEXANDRIA, VA 22301

SHEET SUBMISSION INDEX

REV NO. REVISION DATE

1 EXTERIOR STRUCTURAL REVISION 06/19/2023

SEAL & SIGNATURE:



ENTER PROFESSIONAL CERTIFICATION TEXT HERE THAT IS REQUIRED FOR THE JURISDICTION WHERE DRAWINGS WILL BE SUBMITTED.


SHEET TITLE: FRAMING SECTIONS

PROJECT NO: 2020.72

DATE ISSUED: 06/19/23

SCALE: As indicated

2201EXT

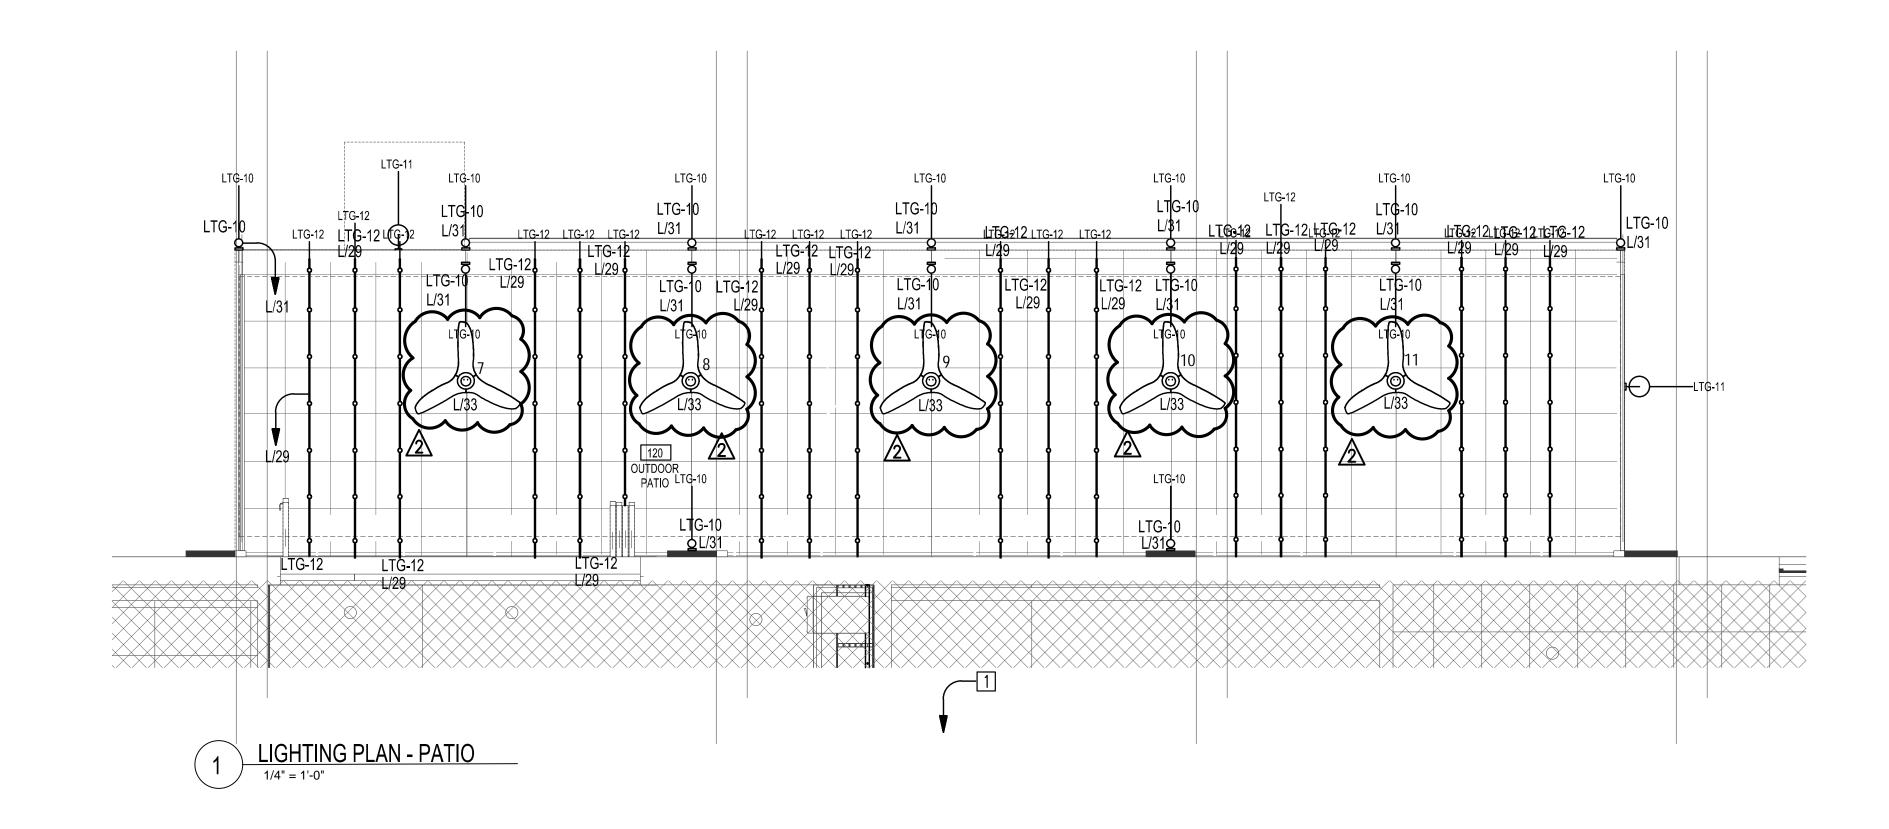

GENERAL NOTES:

- A. REFER TO ARCHITECTURAL PLANS, DETAILS, AND ELEVATIONS FOR LOCATIONS, MOUNTING HEIGHTS, AND FINISHES FOR ALL LIGHTING FIXTURES.
- B. PROVIDE CONDUIT, WIRE, SWITCHES, RELAYS, POWER PACKS, ETC. FOR A COMPLETE LIGHTING INSTALLATION AS DEFINED ON PLANS.
- C. FIELD COORDINATE EXACT ROUTING OF ALL NEW FEEDERS AND BRANCH CIRCUITS.
- D. LIGHTING CONTROL DEVICE MANUFACTURER TO VERIFY ALL INFORMATION INDICATED ON THIS PLAN, AND MODIFY DEVICE TYPE AND LAYOUT AS NEEDED FOR A COMPLETE FUNCTIONAL LIGHTING CONTROL SYSTEM.
- E. ALL LUMINARIES FINISHES TO BE CONFIRMED BY ARCHITECT.
- F. ALL LUMINARIES TO BE UL LISTED FOR THE INTENDED USES.
- G. ALL EXIT SIGNS ARE EQUIPPED WITH 2 HR BATTERY PACK. CONNECT TO NEAREST LIGHTING CIRCUIT AHEAD
- OF SWITCHED LEG. H. ALL EXTERIOR LIGHTING SHALL BE CONTROLLED BY
- ASTRONOMICAL TIMECLOCK AND PHOTOCELL. K. ALL EXTERIOR LIGHT FIXTURES TIME CLOCK SHOULD BE PROGRAMMED TO SHUT OFF FROM 12 MIDNIGHT OR WITHIN ONE (1) HOUR OF THE END OF BUSINESS OPERATIONS, WHICHEVER IS LATER, UNTIL 6 A.M. OR BUSINESS OPENING, WHICHEVER IS EARLIER.

THE INTERIOR BY THE BAR. COORDINATE CONTROL SWITCH LOCATIONS WITH THE ARCHITECT.

			LIGHTING FIXTURE SCHE	DOLL - LATEI		
TYPE	DESCRIPTION	MANUFACTURER	MODEL	FINISH	LAMPING	COMMENTS
TG-10	EXTERIOR CYLINDER SCONCE	REJUVENATION OR APPROVED	THORBURN NARROW WALL SCONCE #A7004, WET RATED	DARK ALUMINUM	5W LED	FIXTURE TO BE DIMMABLE AND HARDWIRED. PROVIDE ALL PARTS AND
~~~	~~~~~~~~~~~~~~~~~~~~~~~~~~~~~~~~~~~~~~	METERNATE TO THE SECOND	~~~~~~~~~~~~~~~~~~~~~~~~~~~~~~~~~~~~~	~~~~	~~~~~~~~~~~~~~~~~~~~~~~~~~~~~~~~~~~~~~	ACCESSORIES FOR SOMPLETE HISTALLATION TO THE PROPERTY OF THE P
ΓG-11	EXTERIOR CAGE LIGHT SCONCE	SCHOOLHOUSE LIGHTING OR APPROVED ALTERNATIVE	FACTORY 4 OUTDOOR SCONCE, WET RATED. PROVIDE CAGE	BLACK BK	MAX WATTAGE 100W, LED LAMP TBD	FIXTURE TO BE DIMMABLE AND HARDWIRED. PROVIDE ALL PARTS AND ACCESSORIES FOR COMPLETE INSTALLATION.
3-12	STRINGLIGHTS	AMERICAN LIGHTHIG OR	LS/LS2-SERIES, NON-SUSPERIDED E26-STRING LIGHTS 24 O.C.	BLACK	1 TWLEDPER SOCKET	PIXTURE TO BE DIMMABLE AND HARDWIRED. PROVIDE ALL PARTS AND
		APPROVED ALTERNATE	SOCKETS, WET RATED. FIXTURE IS CUTTABLE IN FIELD.			ACCESSORIES FOR COMPLETE INSTALLATION. GC TO VERIFY LENGTHS FIELD PRIOR TO ORDERING FIXTURE.



w w w . 3 8 7 7 . d e s i g n

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OWNER : BAKER'S BREAD LLC NOE LANDINI 115 KING STREET ALEXANDIRA, VA 22314 GENERAL CONTRACTOR : 5256 EISENHOWER AVE ALEXANDRIA, VA 22304 [T] 571.233.8585

[W] WWW.TECH24CONSTRUCTION.COM

3333 K STREET NW, SUITE 60 WASHINGTON DC 20007 [T] 202.350.4244 [W] WWW.3877.DESIGN

BUILT ENVIRONMENT ENGINEERS 6861 ELM STREET MCLEAN, VA 22101

[T] 703.888.0649 [W] WWW.BEENGRS.COM SINGER EQUIPMENT COMPANY

JAMES FEUSTEL 180 HELLER PLACE BELLMAWR, NJ 08031 [T] 646-702-9922



ISSUED FOR PERMIT

DRAWING DATA

PROJECT: JUNCTION BAKERY -ALEXANDRIA

ADDRESS: 1508 MT VERNON AVENUE ALEXANDRIA, VA 22301

SHEET SUBMISSION INDEX

INTERIOR PERMIT - 3.31.2023

EXTERIOR PERMIT - 3.31.2023

REV NO. REVISION DATE EXTERIOR PERMIT REVISIONS 31 JULY 2023

SIGNATURE:




ENTER PROFESSIONAL CERTIFICATION TEXT HERE THAT IS REQUIRED FOR THE JURISDICTION WHERE DRAWINGS WILL BE SUBMITTED.


SHEET TITLE: LIGHTING PLAN

PROJECT NO: 2022-46 DATE ISSUED: 03/31/23

SCALE: As indicated



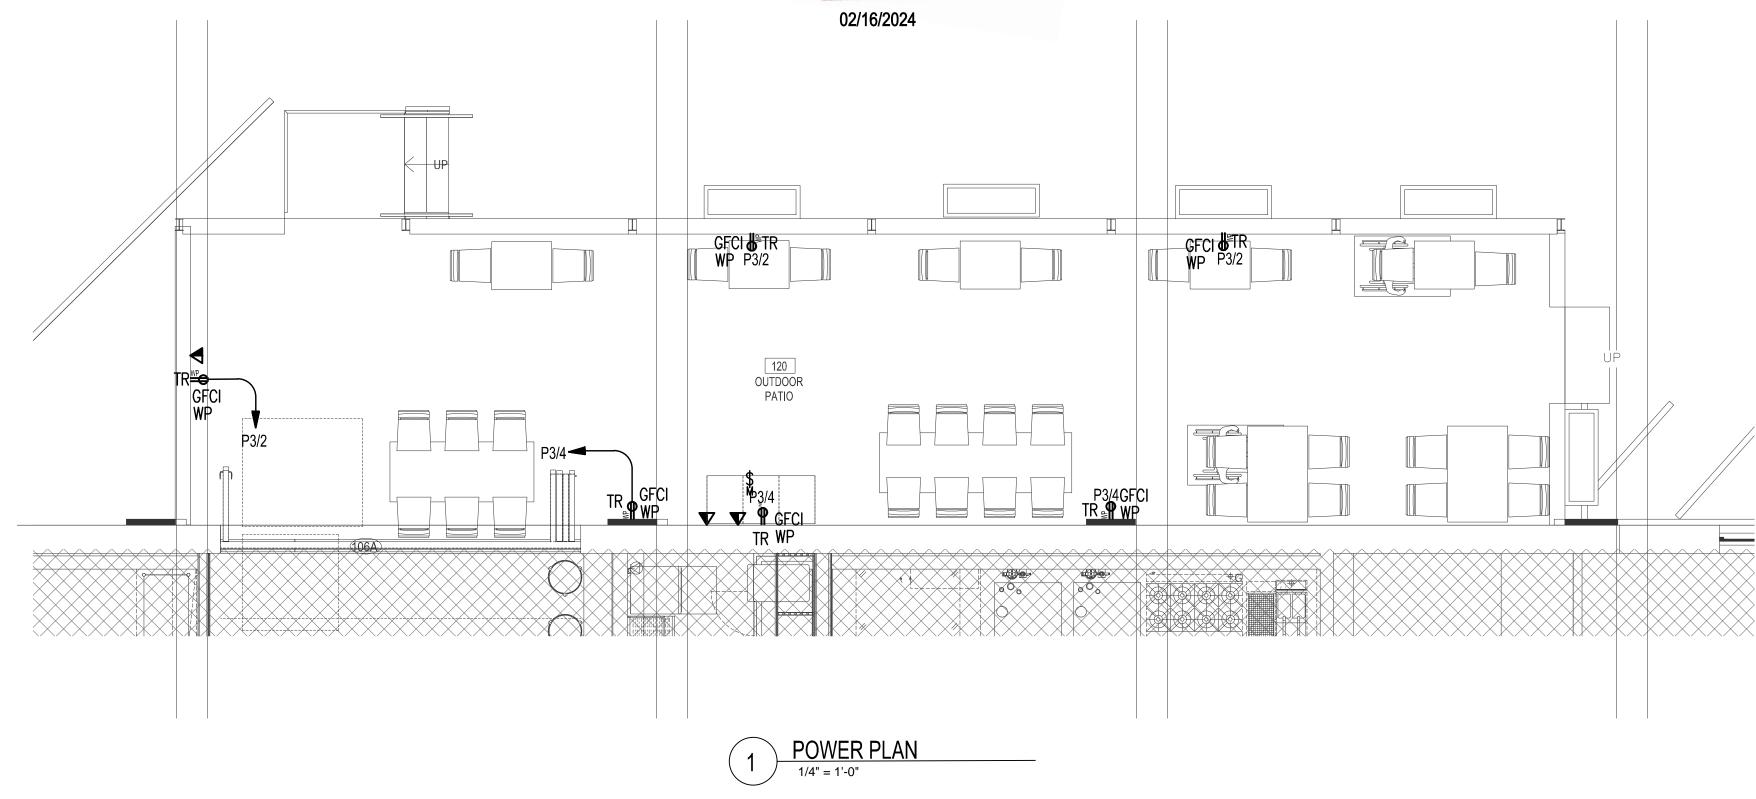

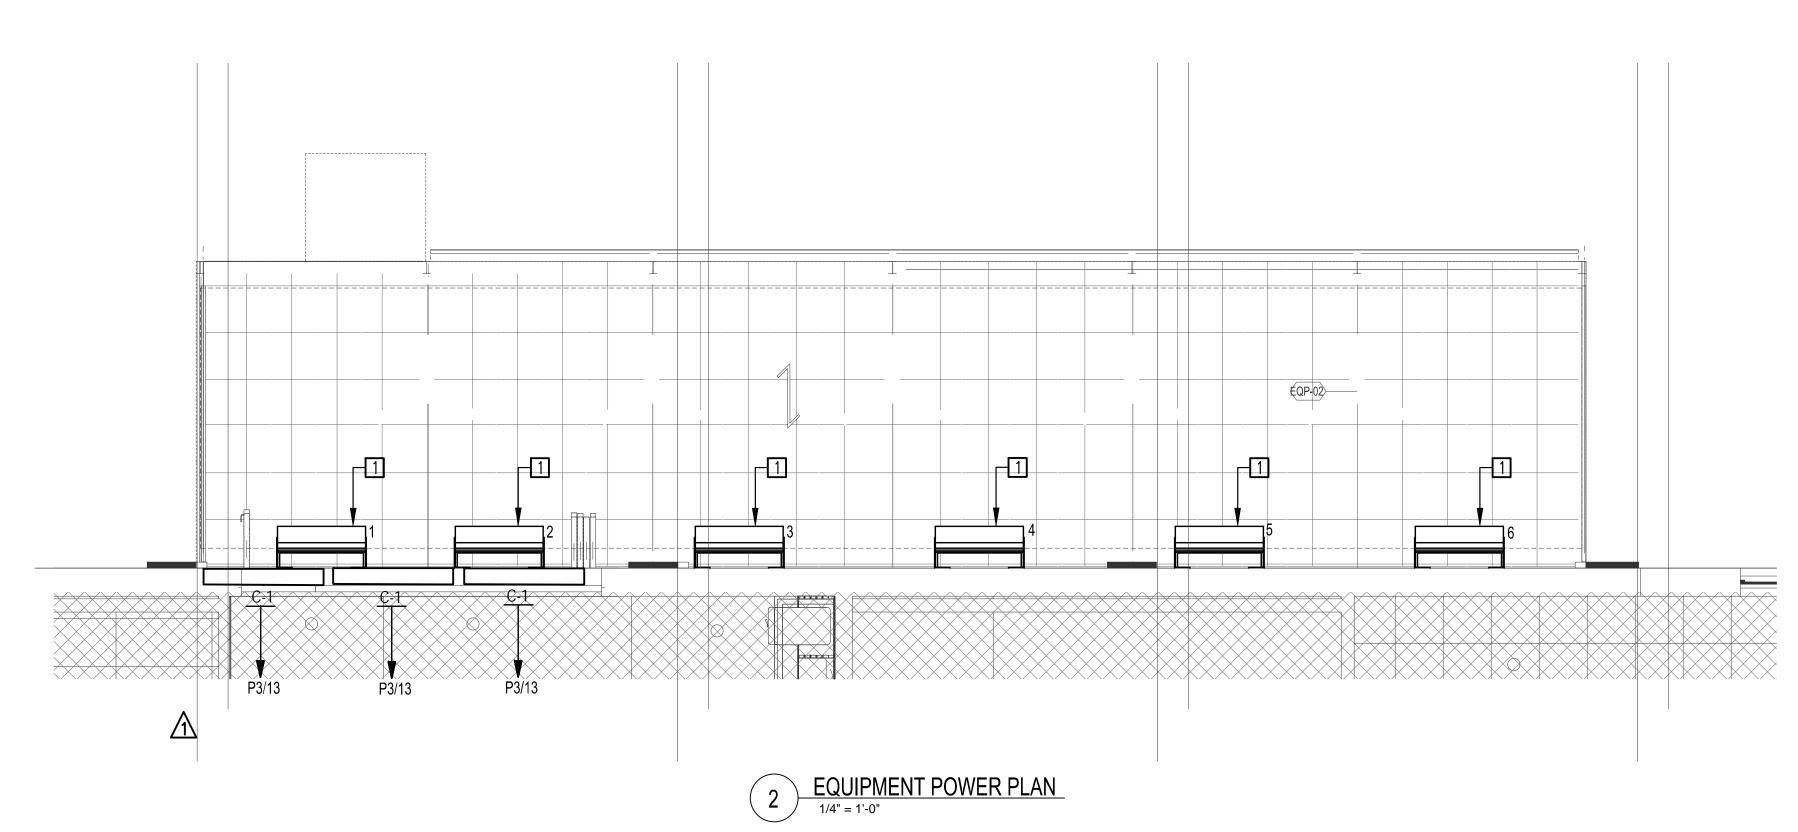

			EQUIPMENT SCHEDULE - EXT	ERIOR	
Type Mark	Description	Manufacturer	Model	Finish	Comments
EQP-01	OUTDOOR WALL HEATERS	SCHWANK	2152-N	BLACK	GC TO PROVIDE: (6) TWO STAGE HEATERS, 30 DEGREE MOUNTING BRACKET; (2) JM-0203-TS 3-GANG SCHWANK 2-STAGE SWITCHES, (ADJACENT TO LIGHTING CONTROLS); (1) MULTI MOUNT 150VA TRANSFORMER FOR ALL 6 HEATERS - MOUNTED WITHIN THE SPACE IN A CONCEALED, DRY AND VENTILATED LOCATION. CONTACT ERIC KAHN FOR PURCHASE: 415-884-2880 ERIC@ALFRESCO-HEATING.COM
EQP-02	Haiku 60In Dia	Big Ass Fans	60" inch MK-HK-4-05-2506-A258-F258. OMIT LIGHTS, COORDINATE DOWNROD ATTACHMENT WITH SLOPED CEILING. COORDINATE CONTROL SPEC WITH OWNER AND INCLUDE IN PURCHASE.		PROVIDE ALL PARTS AND PIECES REQUIRED FOR FULL AND COMPLETE INSTALLATION. PROVIDE STABILIZER KIT.

			AIR C	CURTAIN SCHEDULE			
Type Mark	CFM	HP	MCA	Dimensions (HxLxW)	MOP	Weight (LBS)	Basis of Design (BERNER)
C-1	1680	1/5	1.7	7.5" x 61" x 13.6"	15	57	ALC08-1060A

1. ELECTRICAL BASED IN 208V/1PH/60HZ

GENERAL NOTES:

A. REFER TO ARCHITECTURAL AND KITCHEN PLANS, DETAILS, AND ELEVATIONS FOR LOCATIONS, MOUNTING HEIGHTS, AND FINISHES FOR ALL

ELECTRICAL DEVICES.

B. PROVIDE CONDUIT, WIRE, OVERCURRENT PROTECTION, ETC. FOR COMPLETE ELECTRICAL DEVICE INSTALLATION AS DEFINED ON PLANS.

C. FIELD COORDINATE EXACT ROUTING OF ALL NEW FEEDERS AND BRANCH CIRCUITS.

A KEYED NOTES: #

CONTROL SWITCHES FOR THE HEATERS ARE PLACED IN THE INTERIOR BY THE BAR. COORDINATE CONTROL SWITCH LOCATIONS WITH THE ARCHITECT.

38 7 7 . design

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MEP ENGINEER:
BUILT ENVIRONMENT ENGINEERS

6861 ELM STREET SUITE 2D MCLEAN, VA 22101 [T] 703.888.0649 [W] WWW.BEENGRS.COM

FOOD SERVICE:
SINGER EQUIPMENT COMPANY
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180 HELLER PLACE
BELLMAWR, NJ 08031
[T] 646-702-9922
[W] WWW.SINGEREQUIPMENT.COM



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DRAWING DATA

PROJECT: JUNCTION BAKERY - ALEXANDRIA

ADDRESS: 1508 MT VERNON AVENUE ALEXANDRIA, VA 22301

SHEET SUBMISSION INDEX

• INTERIOR PERMIT - 3.31.2023

EXTERIOR PERMIT - 3.31.2023
 PERMIT RESPONSE - 6.07.2023

REV NO. REVISION DATE

2 EXTERIOR PERMIT REVISIONS 31 JULY 2023

SIGNATURE:



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SHEET TITLE: POWER PLAN

PROJECT NO: 2022-46

DATE ISSUED: 03/31/23

SCALE: As indicated

ΕXI	STING					e-							
PAN	NELBOAR	RD: MDP			FED FROM UTILITY	1 :		M OUN SURI	NΠNG: FACE	BUS AM		JG ONLY Y: 600A	VOLTAGE: 120/208V, 3PH, 4V AIC RMS: 65KAI
T Y [ESCRIPTIC	N	DEV.	C K			LOAD/PH	ASE (VA)			C K	DEV.	DESCRIPTION F
E				T	Α	В	С	Α	В	С	Т		E
				1	16200			5145			2		E
	E	xisting Panel "M"	200/3	3		16200			5145		4	100/3	Existing Panel "L"
				5			16200			5145	6		E
1				7	9000			12468			8		E
1		Existing RTU	150/3	9	ta	9000		1.	12468		10	200/3	Existing Panel "L1"
1			1	11			9000			12468	12		E
	-			13	22090						14		E
E	Exist	ing Panel "P1 & P2"	400/3	15		22090	00000	t.			16		
E		SUBTOTAL (VA)		17	47.000	47.000	22090 47,290	17,613	17,613	17,613	18		SUBTOTAL (VA)
		SUBTUTAL (VA)		-	47,290 47,290 PHASE A			SE B		SE C		*	ARC-FAULT CIRCUIT BREAKER
	SU	IB-TOTAL ALL PHASES (V	A)		64,903		64,903		64,903		,n		** GFCI CIRCUIT BREAKER
	oos to mener moes (m)		,	(8) (1)		.,,							
OAI	DSUMMAR	Y BY TYPE	C	ONNE	CTED	Ī	DEM	IAND					CONNECTED LOAD SUMMARY
₹	=	RECEPTACLE	0		VA		0	VA				194,709	VA
L		LIGHTING	0		VA]	0	VA			Ti da	540	AMPS
Ξ	=	EQUIPMENT	167,7	709	VA		167,709	VA					
<		KITCHEN EQUIP	0		VA		0	VA					
M		MOTOR	0		VA		0	VA					NEC LOAD SUMMARY
Х	=	LARGEST MOTOR	0		VA		0	VA				194,709	VA
H_	=	ELECTRIC HEAT	27,0	00	VA		27,000	VA			11	540	AMPS

PAN	ELBOARD: M			FED FROM MDP			M OUN SURF		MAIN BUS AM		225A/3P Y: 225A	VOLTAGE: 120/208V, 3PH, AIC RMS: 10F
T Y D	ESCRIPTION	DEV.	C			LOAD/PH4	ASE (VA)		200,,,,,	C K	DEV.	DESCRIPTION
E			T	Α	В	С	Α	В	C	Т		Control of Control (Control of Control of Co
М	EXISTING EXHAUST FAN	20/2	1	300	2000		1250	400000		2	40/2	EXISTING WALK IN CU
M	medicanderie eksimiania dilaktore on sabipanda abukatektoriakoa kalini. Der Evaldorit sa i		3		300	500		1250	4000	4	11 2 100 41 51 11	
M	EXISTING MAU	20/2	5 7	500		500	40.00		1000	6 8	20/2	FREEZER CU
M			9	500	2000		1000	750		10	20/1	EXISTING HEATER
M M	EXISTING RTU-2	60/3	11		2000	2000		750	1000	12	20/1	EXISTING HEATER
M	E/131111/31/10-2	00/3	13	2000		2000	1000		1000	14	40/2	EXISTING LOAD
M			15	2000	3000		1000	1000		16		
M	EXISTING RTU	100/3	17		5555	3000		1000	1000	18	30/2	EXISTING FREEZER
M		380 martin 1938	19	3000			500		1700 (AT AMELIE)	20	20/1	EXISTING LIGHTS
M			21	14.79 (486)	1000			500		22	20/1	EXISTING HEATER
M	EXISTING AHU	30/3	23			750			540	24	20/1	EXISTING RECEPTAICLES
M			25	1000			540			26	20/1	EXISTING RECEPTAICLES
M			27		2000			540		28	20/1	EXISTING RECEPTAICLES
M	EXISTING RTU	50/3	29			2000				30	20/1	SPARE
M			31	2000						32	20/1	SPARE
Н			33		3000					34	20/1	SPARE
H	EXISTING DUCT HEATER	70/3	35			3000				36	20/1	SPARE
Н			37	3000						38	20/1	SPARE
	PACE		39							40		SPACE
S	PACE		41							42	6	SPACE
	SUBTOTAL (VA)			11,800	11,300	11,250	4,290	4,040	3,540			SUBTOTAL (VA)
	SUB-TOTAL ALL PHASES (/A)		PHA:	SE A	PHA:	SE B		SE C		* /	ARC-FAULT CIRCUIT BREAKER
				16,090		15,3 <mark>4</mark> 0		14,790)	11		** GFCI CIRCUIT BREAKER
OAE	SUMMARY BY TYPE	C	ONNE	CTED		DEM	AND					CONNECTED LOAD SUMMARY
R	= RECEPTACLE	1,62	20	VA		1,620	VA			4.	46,220	VA
L	= LIGHTING	500)	VA		625	VA				128	AMPS
E	= EQUIPMENT	0		VA		0	VA			12		
K	= KITCHEN EQUIP	0		VA		0	VA					
M	= MOTOR	24,8	50	VA		24,850	VA					NEC LOAD SUMMARY
X	= LARGEST MOTOR	9,00	00	VA		11,250	VA				48,595	VA
H	= ELECTRIC HEAT	10,2	50	VA		10,250	VA				135	AMPS

PAN	ELBOARD: L			FED FRO	M:			VTING:			JG ONLY	VOLTAGE: 120/208V, 3PH,	
			T.	MDP			SURI	FACE	BUS AM	PACII	Y: 225A	AIC RMS: 10K	AIC
P	ESCRIPTION	DEV.	K T			LOAD/PH.			Lia	C K T	DEV.	DESCRIPTION	Y
E	(ISTING LIGHTS	20/1		600	В	С	A 800	В	С		20/1	EXISTING LIGHTS	E
1000	Approximation of the property	100000000000000000000000000000000000000	1	000	200		800	600		2	2000		
	(STING LIGHTS	20/1	3		300	000		600	000	4	20/1	EXISTING LIGHTS	_
	(STING LIGHTS	20/1	5	200		800	4000		300	6	20/1	EXISTING LIGHTS	
Intel District	ISTING LIGHTS	20/1	7	600	200		1200	4000		8	20/1	EXISTING SIGNAGE	
	ISTING LIGHTS	20/1	9		600			1200		10	20/1	EXISTING SHOW WINDOW	_
	ISTING LIGHTS	20/1	11			600			720	12	20/1	EXISTING RECEPTACLES	R
, 1000 N	PARE	20/1	13			, e				14	20/1	SPARE	
	PARE	20/1	15							16	20/1	SPARE	_
SF	PARE	20/1	17							18	20/1	SPARE	
L EX	ISTING LIGHTS	20/1	19	600						20	20/1	SPARE	
L EX	«STING LIGHTS	20/1	21		600					22	20/1	SPARE	
L LIC	GHTS	20/1	23			600				24	20/1	SPARE	
L LIC	GHTS	20/1	25	850						26	20/1	SPARE	
L LIC	GHTS	20/1	27		850					28	20/1	SPARE	
L EX	CTERIOR LIGHTS	20/1	29			455				30	20/1	SPARE	
		20M	V3T	\55\	~~	$\hat{}$	9	+		32	20/1	SPARE	2
E PA	ATIO FANS	15/1	33		120					34	20/1	SPARE	
SE		\	25/				-			36	20/1	SPARE	
SF	PACE		37	-	-	6	27			38		SPACE	
SF	PACE		39			je				40		SPACE	
SF	PACE		41		_					42		SPACE	
	SUBTOTAL (VA)			3,105	2,470	2,455	2,000	1,800	1,020			SUBTOTAL (VA)	
				_	SE A	PHA	SE B	PHA	SEC		* A	RC-FAULT CIRCUIT BREAKER	_
	SUB-TOTAL ALL PHASES (/A)		5, 10	5	4,270		3,475	i			** GFCI CIRCUIT BREAKER	_
					_								_
LOAD	SUMMARY BY TYPE	0	ONNE	CTED	╛	DEM	IAND			3		CONNECTED LOAD SUMMARY	ı
R	= RECEPTACLE	1,92	20	VA		1,920	VA			3) 3)	12,850	VA	ĺ
L	= LIGHTING	10,8	10	VA		13,513	VA				36	AMPS	ı
E	= EQUIPMENT	12	0	VA		120	VA			200			9
K	= KITCHEN EQUIP	0		VA	1	0	VA						
M	= MOTOR	0		VA	1	0	VA					NEC LOAD SUMMARY	ĺ
Х	= LARGEST MOTOR	0		VA	1	177	VA				15,553	VA	
Н	= ELECTRIC HEAT	0		VA	Η		VA	l		5		AMPS	

EXISTING

PANELBOARD: P1-S1			FED FROM	1:		MOUN	NTING: FACE	BUS AM		JG ONLY	VOLTAGE: 120/208V, 3PH AIC RMS: 10	
T Y DESCRIPTION	DEV.	C K	III DI		LOAD/PHA	Water was and	NOL	DOS AIM	c K	DEV.	DESCRIPTION	1
E		T	Α	В	С	Α	В	С	T			E
SPARE	20/1	1				3850			2			1
SPARE	20/1	3					3850		4	50/3	EXISTING SPIRAL MIXER	1
M EXISTING DISPOSAL	25/1	5			1000			3850	6			ŀ
E EXISTING ESPRESSO	20/1	7	500			1910			8	20/2	EMOTING IOE MAIZED	
E EXISTING ESPRESSO MACHINE	30/2	9		1500	1500		1910	750	10 12	30/2	EXISTING ICE MAKER	1
K EXISTING UC REF.	20/1	13	500		1500	750		730	14	20/2	EXISTING WARMER	
K EXISTING REF.	20/1	15		750		100	720		16	20/1	EXISTING RECEPTACLE	-
F		17		100	2000		120	500	18	20/1	EXISTING PROOFER LIGHTS	
EXISTING COFFEE MACHINE	40/2	19	2000		2000	540		-	20	20/1	EXISTING COOLER LIGHTS	
E EXISTING COFFEE GRINDER	20/1	21	2000	500		340	720		22	20/1	EXISTING RECEPTACLES	_
E EXISTING HOOD CONTROL	20/1	23		300	500		120	540	24	20/1	EXISTING RECEPTACLES	
K EXISTING UC REF.	20/1	25	350		300	720		340	26	20/1	EXISTING RECEPTACLES	
K ENSTING CORET	20/1	27	330	1100		120	750		28	20/1	EXISTING REACH IN REF	
K EXISTING DOUGH MOULDER	20/3	29		1100	1100		130	720	30	20/1	EXISTING RECEPTACLES	-
The state of the s	20/3		4400		1100	E40		120	100000	Landa Carlotta		
K E EXISTING ANSUL SYSTEM	20/1	31 33	1100	500		540	500	ł.	32 34	20/1	EXISTING RECEPTAICLES	S
A CONTRACTOR OF THE PROPERTY O	THEOREM AL	35	1	500	500		500	500	36	30/2	EXISTING HOOD FAN DISH RM	
R EXISTING RECEPTABLE RTU K EXISTING REACH IN REF.	20/1	37	750		500	540		500	38	2014	EXISTING RECEPTACLES	_
	20/1	_	750	750		540	700	.c		20/1		+
K EXISTING COUNTER MIX	20/1	39		750	400		720	700	40	20/1	EXISTING RECEPTACLES	
K EXISTING SHEETER	20/1	41	E 000	E 400	480	0.050	0.470	720	42	20/1	EXISTING RECEPTACLES	3
SUBTOTAL (VA)	V		5,200	5,100	7,080	8,850	9,170	7,580	e G	+ 4	SUBTOTAL (VA)	
TOTAL ALL PHASES (VA SECTIONS 1 & 2)		PHA:	2480471040159		SE B	- In this case of	SE C		~ P	ARC-FAULT CIRCUIT BREAKER	
SECTIONS T& 2	2 25,681 25,210 23,180					** GFCI CIRCUIT BREAKER	_					
OAD SUMMARY BY TYPE	C	ONNE	CTED			EMAND				CONNECTED LOAD SUMMARY		
R = RECEPTACLE	12,7	40	VA		11,370	11,370 VA			74,071		_	
L = LIGHTING	1,04	10	VA		1,300	VA				206	AMPS	╛
E = EQUIPMENT	14,0		VA]	14,091							
K = KITCHEN EQUIP	44,0	00	VA]	28,600	VA						_
M = MOTOR	2,20	00	VA]	2,200	VA					NEC LOAD SUMMARY	
X = LARGEST MOTOR	0		VA]	0	VA				57,561	VA	_
H = ELECTRIC HEAT	0		VA		0	VA				160	AMPS	1


ANELBOARD	: P1-S2			FED FROM P1-S1	1:		MOUN SURI	NTING: FACE	BUS AM		IG ONLY Y: 400A	VOLTAGE: 120/208V, 3PI AIC RMS: 10
DESCRIPTION		DEV.	C		1	LOAD/PH/	ASE (VA)		•	C K	DEV.	DESCRIPTION
Ξ.			T	Α	В	C	Α	В	С	T		
EXISTING REF.		20/1	43	750			1000			44	20/1	EXISTING HAND DRYE
EXISTING REF.		20/1	45	4	750			1000		46	20/1	EXISTING HAND DRYE
EXISTING REF.		20/1	47			750			500	48	20/1	EXISTING PO
			49	1191			500			50	20/1	EXISTING PO
The second second second	NG PANEL "P3"	100/3	51	r.	900			540		52	20/1	EXISTING RECEPTAICLE
1			53			0			540	54	20/1	EXISTING RECEPTAICLE
SPACE			55		3		720			56	20/1	EXISTING RECEPTAICLE
EVIS	STING LOAD	20/1	57	4	500			540		58	20/1	EXISTING RECEPTAICLE
C ENS	STING LOAD	20/1	59			500		0	720	60	20/1	EXISTING RECEPTA CLE
R EXISTING RECE	PTACLES	20/1	61	720			750			62	20/1	EXISTING JUICE MIXE
EVICT	ING WARMER	20/2	63		750			540		64	20/1	EXISTING RECEPTAICLE
ENIST	ING WARWER	2012	65			750			540	66	20/1	EXISTING RECEPTAICLE
(Evi	ISTING DW	20/2	67	1500			1000			68	20/2	EXISTING EQUIPMENT
	ISTING DW	20/2	69		1500			1000		70		ENSTING EQUIPMENT
EVICT	NO WADNED	20/2	71			500			1000	72	20/2	EMOTING FOLUDIATION
EXIST	ING WARMER	20/2	73	500			1000			74	2012	EXISTING EQUIPMENT
EXISTING CIRC	JLATING PUMP	20/1	75		200			720		76	20/1	EXISTING RECEPTAICLE
(77			500			1500	78		
EXIS	TING MIIXER	20/3	79	500			1500			80	30/3	EXISTING PROOFER
(81		500			1500		82		
SPARE		20/1	83						720	84	20/1	EXISTING RECEPTAICLE
	SUBTOTAL (VA)			5,161	5,100	3,000	6,470	5,840	5,520			SUBTOTAL (VA)
SUB-T	OTAL ALL PHASES	(VA)		PHA	SEA	PHA	SE B	PHA	SE C		* A	RC-FAULT CIRCUIT BREAKER
	SECTION 2			11,631		10,940		8,520				** GFCI CIRCUIT BREAKER


PA	NELBOARD: L1			FED FROM MDP	1		M OUN SUR		M. BUS AM		IG ONLY Y: 225A	VOLTAGE: 120/208V, 3PH, AIC RMS: 22	
T Y P	DESCRIPTION	DEV.	C K			LOAD/PH	ASE (VA)			C K	DEV.	DESCRIPTION	Ī
E			T	Α	В	С	Α	В	С	T			
K	EXISTING MIXER	20/1	1	1440			720			2	20/1	EXIST. RECEPTACLES	ò
K	EXISTING MIXER	20/2	3 5		1664	1664		720	500	4 6	20/1	EXIST. RECEPTACLES	1
K	EXISTING REACH IN REF.	20/1	7	1488			500			8	20/2	EXIST. RECEPTACLES	
K	EXISTING REACH IN FREEZER	20/1	9		1200			500		10	00/0	EVIOT DE CEDTA OLEO +	1
	SPARE	20/1	11		NUMBER OF THE PROPERTY OF THE			300000	500	12	20/2	EXIST. RECEPTACLES *	
K	EXISTING COMBLOVEN STEAMER	20/1	13	1000			500			14	20/1	EXISTING RECEPTACLES	-
	SHUNT TRIP		15					720		16	20/1	EXISTING RECEPTACLES	3
K	EXISTING EXHAUST HOOD	20/1	17			1000			720	18	20/1	EXISTING RECEPTACLES	3
K	EXISTING EXHAUST HOOD	20/1	19	1000			720			20	20/1	EXISTING RECEPTACLES	3
K	EXISTING WAIT STATION	20/1	21		500			500		22	20/1	EXISTING RECEPTACLES	ì
K	EXIST. REMOTE WATER CHILLER	20/1	23			1200	N		720	24	20/1	EXISTING RECEPTACLES	3
K	EXIST. GLASS WASHER	25/1	25	2000			900			26	20/1	EXISTING RECEPTACLES	3
K	EXIST. POS TERMINAL	20/1	27		500			1200		28	20/1	EXIST. TILTING SKILLET	Ī
K	EXIST. BACK BAR COOLER	20/1	29			720				30		SHUNT TRIP	3
K	EXIST. BACK BAR COOLER	20/1	31	1080			1000			32	20/1	EXIST. COMBI OVEN STREAMER	₹
K	EXIST. COMBIOVEN STEAMER	20/1	33		1000					34		SHUNT TRIP)
	SHUNT TRIP		35						1000	36	20/1	EXIST. COMBI OVEN STREAMER	2
K	EXIST. UCICE MACHINE	20/1	37	950			e			38		SHUNT TRIP)
K	EXIST. UCICE MACHINE	20/1	39		950			720		40	20/1	EXIST. RECEPTACLES	ŝ
R	EXIST. RECEPTACLES	20/1	41			500			200	42	20/1	EXIST. RECEPTACLES- OUTDOOR	2
M	,		43	800			1080			44	7		
M	EXIST. EXHAUST FAN	15/3	45		800			1080		46	20/3	EXIST. MFCU	
M			47			800			1080	48			
M			49	750			1080			50	i		
M	EXIST. MAU	15//3	51		750			1080		52	20/3	EXIST. MFCU	
M			53			750			1080	54			
	SUBTOTAL (VA)			10,508	7,364	6,634	6,500	6,520	5,800			SUBTOTAL (VA)	_
	SUB-TOTAL ALL PHASES (V	A)		PHAS			SE B		SE C		* A	ARC-FAULT CIRCUIT BREAKER	
				17,008		13,884		12,434				** GFCI CIRCUIT BREAKER	_
LO	AD SUMMARY BY TYPE	C	ONNE	CTED	Ē	DEM	IAND	Ti .			1	CONNECTED LOAD SUMMARY	-
R	= RECEPTACLE	4,06		VA		4,060					47,421		-
L	= LIGHTING	0		VA			VA					AMPS	
E	= EQUIPMENT	50		VA		342	VA						•
K	= KITCHEN EQUIP	30,9		VA		20,108							
M	= MOTOR	8,68		VA		8,685	100					NEC LOAD SUMMARY	•
3.6	- LARCEST MOTOR	2.0		MA		4.050	100000				27 402	THE PARTY OF THE P	-

4,050 VA

37,403 VA

104 AMPS

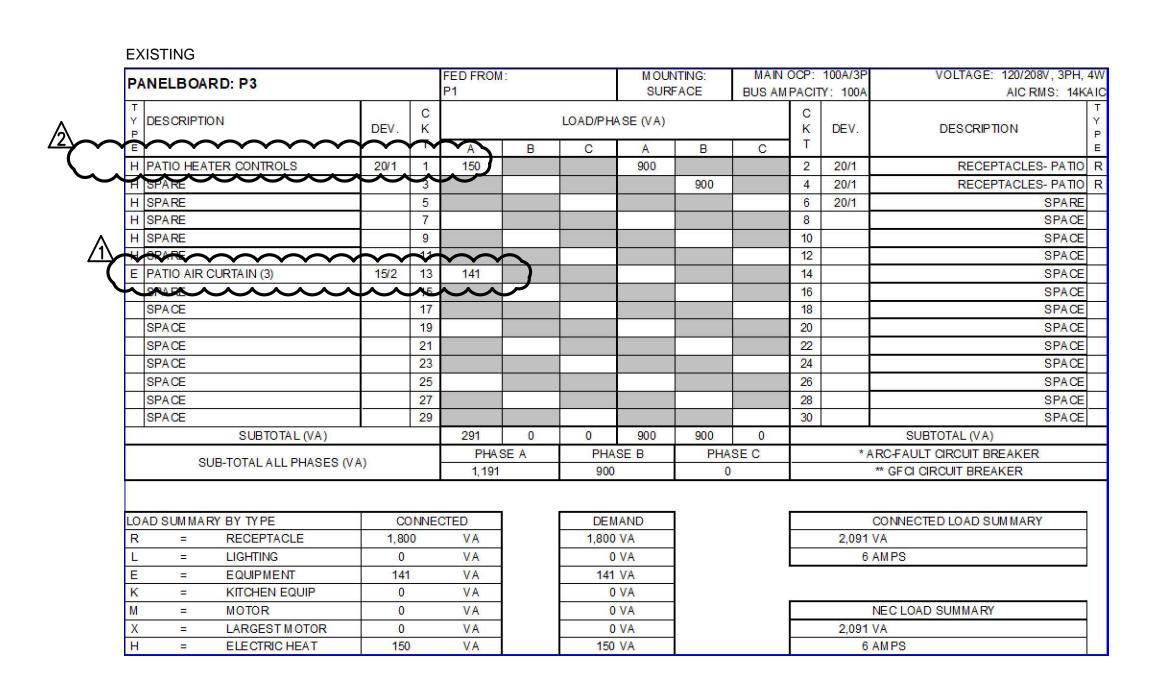

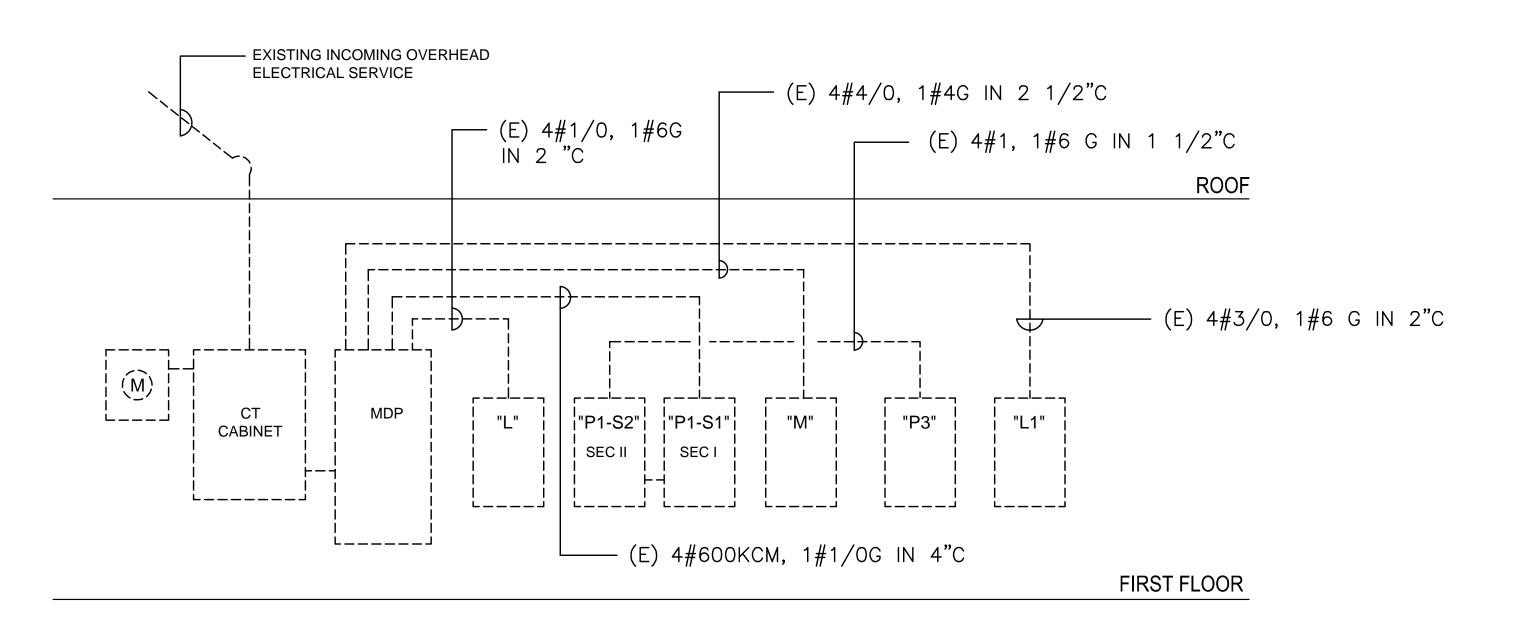

= ELECTRIC HEAT


= LARGEST MOTOR

3,240

POWER RISER DIAGRAM NOT TO SCALE

NOTES:

A) ALL DASHED EQUIPMENT IS EXISTING TO REMAIN.

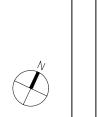

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BAKER'S BREAD LLC NOE LANDINI 115 KING STREET ALEXANDIRA, VA 22314 **GENERAL CONTRACTOR:** TECH 24 5256 EISENHOWER AVE ALEXANDRIA, VA 22304 [T] 571.233.8585 [W] WWW.TECH24CONSTRUCTION.COM 3333 K STREET NW, SUITE 60 WASHINGTON DC 20007 [T] 202.350.4244 [W] WWW.3877.DESIGN MEP ENGINEER : BUILT ENVIRONMENT ENGINEERS 6861 ELM STREET SUITE 2D MCLEAN, VA 22101 [T] 703.888.0649 [W] WWW.BEENGRS.COM FOOD SERVICE : SINGER EQUIPMENT COMPANY JAMES FEUSTEL 180 HELLER PLACE BELLMAWR, NJ 08031 [T] 646-702-9922



ISSUED FOR PERMIT

DRAWING DATA

PROJECT: JUNCTION BAKERY -ALEXANDRIA

ADDRESS: 1508 MT VERNON AVENUE ALEXANDRIA, VA 22301

SHEET SUBMISSION INDEX INTERIOR PERMIT - 3.31.2023

EXTERIOR PERMIT - 3.31.2023

PERMIT RESPONSE - 6.07.2023

DATE REVISION

EXTERIOR PERMIT REVISIONS 31 JULY 2023

SEAL & SIGNATURE:



ENTER PROFESSIONAL CERTIFICATION TEXT HERE THAT IS REQUIRED FOR THE JURISDICTION WHERE DRAWINGS WILL BE SUBMITTED.

> SHEET TITLE: PANEL SCHEDULES AND POWER RISER PROJECT NO: 2022-46 DATE ISSUED: 03/31/23 SCALE: As indicated

GENERAL NOTES

- SCOPE: FURNISH ALL LABOR, MATERIALS, TOOLS, EQUIPMENT, SERVICES AND SKILLED SUPERVISION NECESSARY TO PROVIDE, INSTALL, TEST AND ADJUST HVAC AND PLUMBING SYSTEMS COMPLETE, OPERATIONAL, AND READY FOR USE, AS INDICATED IN THESE DRAWINGS AND SPECIFICATIONS.
- PERMITS, LICENSES & FEES: PAY ALL REQUIRED FEES AND OBTAIN ALL NECESSARY PERMITS AND LICENSES FOR LEGAL REMOVAL AND INSTALLATION OF THE WORK.
- APPLICABLE CODES AND STANDARDS: ALL WORK SHALL BE PERFORMED IN ACCORDANCE WITH THE FOLLOWING CODES AND STANDARDS AND ANY REGULATIONS EFFECTIVE IN THE PROJECT JURISDICTION. ALL CODE CONFLICTS SHALL BE BROUGHT TO THE ATTENTION OF THE OWNER FOR RESOLUTION. APPLICABLE CODES AND STANDARDS ON THIS PROJECT INCLUDE, BUT ARE NOT LIMITED TO, THE FOLLOWING:

A. VIRGINIA BUILDING CODE, 2018 B. VIRGINIA MECHANICAL CODE, 2018 C. VIRGINIA FUEL GAS CODE 2018 D. VIRGINIA ENERGY CONSERVATION CODE 2018 E. NFPA 70, NATIONAL ELECTRICAL CODE 2017 F. NFPA 72, NATIONAL FIRE ALARM CODE G. 2010 ADA STANDARD

- DRAWING ACCURACY: DRAWINGS ARE DIAGRAMMATIC AND NOT INTENDED TO BE SCALED. WHEN INDICATED, ALL WORK SHALL BE PHYSICALLY LOCATED IN ACCORDANCE WITH ANNOTATED DIMENSIONS ON ARCHITECTURAL PLANS, ELEVATIONS AND DETAILS.
- SITE VISIT: THE CONTRACTOR SHALL VISIT THE SITE AND SHALL FAMILIARIZE HIMSELF WITH THE EXISTING CONDITIONS, EQUIPMENT, DUCTWORK, PIPING, WIRING, CONSTRUCTION, FINISHES, AND STRUCTURE PRIOR TO START OF WORK. WHEN ANY DISCREPANCY OR CONFLICT IS DETECTED AT THE PROJECT SITE, THE OWNER SHALL BE NOTIFIED IMMEDIATELY PRIOR TO COMMENCING WORK.
- COORDINATION: CONTRACTOR SHALL COORDINATE AND SEQUENCE THE WORK OF ALL DIVISIONS AND TRADES PRIOR TO FABRICATION AND INSTALLATION OF DUCTWORK AND RACEWAYS. COORDINATE THE LOCATION OF ALL NEW EQUIPMENT, DUCTWORK, AND DEVICES WITH NEW STRUCTURE AND EQUIPMENT BEFORE FABRICATION. MAKE NECESSARY ACCOMMODATIONS TO MEET THE INTENT OF THE DRAWINGS AND ENSURE A COORDINATED INSTALLATION.
- SUBMITTALS AND SUBSTITUTIONS: CONTRACTOR SHALL PROVIDE PRODUCT INFORMATION, SHOP DRAWINGS, DOCUMENTS AND WARRANTIES FOR MATERIALS AND SERVICES TO THE OWNER FOR APPROVAL. NO SUBSTITUTION WILL BE ALLOWED WITHOUT PERMISSION OF THE OWNER'S REPRESENTATIVE IN WRITING. SUBSTITUTE MATERIAL SHALL BE COMPATIBLE WITH OTHER COMPONENTS OF THE SYSTEM.
- INSTALLATION OF NEW WORK: INSTALLATION OF EQUIPMENT, DUCTWORK, PIPING, FIXTURES, ETC. SHALL BE DONE IN NEAT AND WORKMANLIKE MANNER, AND SHALL CONFORM TO THE LATEST TRADE PRACTICES. REFER TO ARCHITECTURAL DRAWINGS TO VERIFY EXACT LOCATION OF EQUIPMENT, FIXTURES, ETC. COORDINATE DUCTWORK AND PIPING WITH THE WORK OF OTHER TRADES PRIOR TO FABRICATION. MAKE NECESSARY ACCOMMODATIONS TO MEET THE INTENT OF THE DRAWINGS AND ENSURE A COORDINATED INSTALLATION.
- DRAWINGS ARE DIAGRAMMATIC AND REPRESENT THE INTENT OF THE CONTRACT. DESIGN DRAWINGS ARE NOT TO BE CONSIDERED AS SUBSTITUTION TO SHOP DRAWINGS. DRAWINGS SHALL BE FOLLOWED AS CLOSELY AS CONDITIONS ALLOW TO COMPLETE THE INTENT OF THE CONTRACT. THE RIGHT IS RESERVED BY THE ENGINEER TO MAKE MINOR CHANGES IN LOCATIONS AND ARRANGEMENTS WHEN REQUIRED BY JOB DEVELOPMENT WITHOUT ADDITIONAL COMPENSATION TO THE CONTRACTOR.
- 10. MOUNTING HEIGHTS: COORDINATE MOUNTING HEIGHTS OF DEVICES ON FINISHED WALLS TO PROVIDE A NEAT AND SYMMETRICAL APPEARANCE. SEE ARCHITECTURAL PLANS, ELEVATIONS AND DETAILS FOR HEIGHTS AND LOCATIONS OF EQUIPMENT. DIMENSIONS, UNLESS OTHERWISE NOTED, ARE TO CENTERLINE OF EQUIPMENT.
- 11. WARNING SIGNS: PROVIDE SIGNS, BARRICADES, GUARDS, AND PROTECTION FOR SAFETY DURING CONSTRUCTION. WORK AREA SHALL BE KEPT CLEAN, CLEAR OF OBSTRUCTIONS, WELL ILLUMINATED, AND UNDER ORGANIZED MATERIAL STORAGE.
- 12. FIRE STOPPING: REFER TO ARCHITECTURAL PLANS FOR DETAILS AND REQUIREMENTS FOR CONDUIT AND PIPING PENETRATIONS THROUGH WALLS, FLOORS AND CEILINGS.
- 13. REPAIR: ALL WORK SHALL BE DONE IN SUCH A MANNER TO MINIMIZE DAMAGE TO ADJACENT EQUIPMENT, PIPING, DUCTWORK, WIRING, FIXTURES, CONSTRUCTION, FINISHES AND STRUCTURE. ANY DAMAGE RESULTING FROM WORK UNDER THIS PROJECT SHALL BE REPAIRED OR REPLACED BY THE CONTRACTOR TO THE SATISFACTION OF THE OWNER AT NO ADDITIONAL COST.
- 14. <u>CLEANING & MATERIAL DISPOSITION:</u> CLEAR ALL DEBRIS FROM THE AREA OF WORK AND LEAVE SITE IN CLEAN CONDITION. CLEAN ALL EQUIPMENT ENCLOSURES, INSIDE AND OUTSIDE. ALL DEMOLISHED EQUIPMENT AND DEBRIS NOT TO BE REUSED OR SALVAGED SHALL BE REMOVED FROM THE SITE AND PROPERLY DISPOSED OF IN ACCORDANCE WITH APPLICABLE REGULATIONS.
- 15. <u>HAZARDOUS MATERIALS:</u> IF SUSPECTED HAZARDOUS MATERIALS ARE ENCOUNTERED IN AREAS EXPECTED TO CONTAIN ACMs, PCBs, OR LEAD, THE CONTRACTOR SHALL CEASE DEMOLITION ACTIVITIES AND NOTIFY THE
- 16. PROVIDE DIELECTRIC PIPING UNIONS BETWEEN DISSIMILAR METALS.
- 17. PIPING SHALL NOT COME INTO DIRECT CONTACT WITH CONCRETE OR STRUCTURE IN ANY LOCATION.
- 18. VALVES AND PIPING ACCESSORIES SHALL BE IN LINE SIZE. PROVIDE SUPPLY STOP VALVES AT ALL NON-FLUSH VALVE TYPE FIXTURES.
- 19. PROVIDE CODE COMPLIANT (ASSE) BACKFLOW PREVENTER WITH SHUT OFF VALVES, UNION, AND ESCUTCHEON AT EACH EQUIPMENT CONNECTION THAT REQUIRES A POTABLE WATER CONNECTION.
- 20. CONTRACTOR IS PROHIBITED FROM USING LEAD-BASED SOLDER.
- 21. ALL PIPING PENETRATING CEILINGS AND WALLS SHALL BE INSTALLED WITH ESCUTCHEONS AT PENETRATION. PIPING PENETRATING EXTERIOR WALLS. ROOFS AND FLOOR AND CEILING SHALL BE FLASHED IN APPROVED MANNER AND SHALL BE SEALED WATERTIGHT TO MAINTAIN INTEGRITY OF SEPARATION. PIPING PENETRATING FIRE RATED PARTITIONS SHALL BE INSTALLED WITH FIRE RATED SEALS AS REQUIRED BY ARCHITECT AND AUTHORITY HAVING JURISDICTION.
- 22. PROVIDE ACCESS TO SYSTEM COMPONENTS THAT ARE CONCEALED AND REQUIRE PERIODIC SERVICE.
- 23. PLUMBING EQUIPMENT, PIPING, INSULATION, ETC., INSTALLED IN HVAC PLENUM SPACES SHALL MEET CODE REQUIREMENTS FOR SMOKE DEVELOPMENT AND COMBUSTIBILITY.

GENERAL NOTES

- 24. PROVIDE SHUTOFF VALVES ON BRANCH PIPING AND SUPPLIES TO INDIVIDUAL FIXTURES AND EQUIPMENT PROVIDE VALVES ON ALL WATER, ETC, MAIN BRANCHES IN CORRIDORS AND WHERE INDICATED ON DRAWINGS. VALVES SHALL BE INSTALLED WITH STEM UP. VALVES INSTALLED SHALL BE PERMANENTLY ACCESSIBLE FOR VALVES 3" DIAMETER AND SMALLER AND SHALL BE CHAIN OPERATED FOR VALVES LARGER THAN 3" DIAMETER.
- 25. VERIFY EXACT SIZES, LOCATIONS, INVERTS AND ARCHITECTURAL & CIVIL DRAWINGS FOR EXACT
- 26. SLOPE HORIZONTAL WASTE PIPING AS FOLLOW LARGER AT 1% IN DIRECTION OF FLOW.
- 27. GUARANTEE: ALL PLUMBING WORK SHALL BE ACCEPTANCE OF THE FINAL INSTALLATION BY
- 28. ALL ABANDONED PLUMBING PIPING SHALL BE

CT LOCATIONS C	PRIOR TO RUNNING ANY PIPING. REFER TO OF FIXTURES AND EQUIPMENT. AMETER AND SMALLER AT 2%, 3" DIAMETER AND						
GUARANTEED F THE OWNER'S	OR A PERIOD OF ONE YEAR FROM THE DATE OF REPRESENTATIVE. TH FROM ABOVE CEILINGS AND BELOW SLAB).						
		_					
	PIPE LINE TYPES			A	BBREVIATION	IS	
	SANITARY PIPE ABOVE FLOOR		ABV	ABOVE			

EXTP-001

EXTP-101

	PIPE LINE TYPES
	SANITARY PIPE ABOVE FLOOR
	SANITARY PIPE BELOW FLOOR
	VENT
	COLD WATER
	HOT WATER
	HOT WATER RETURN
	EXISTING SANITARY PIPE ABOVE FLOOR
	EXISTING PIPE BELOW FLOOR
=======	EXISTING VENT
======	EXISTING COLD WATER
=:===	EXISTING HOT WATER
======	EXISTING HOT WATER RETURN
— 	STORM
—	FIRE PROTECTION
— \$P —— \$P ——	SPRINKLER PIPE
ee	GAS PIPE
G G	EXISTING GAS PIPE

	SYMBOLS
$-\infty$	P TRAP
5—	PIPE BREAK (SINGLE LINE)
G	PIPE FITTING DOWN OR DROP
	PIPE FITTING TEE DOWN
0	PIPE FITTING UP
• ⋈	SHUT OFF VALVE
	CHECK VALVE - BACKFLOW PREVENTER
\dashv	CLEANOUT
<u></u>	CAP OR END OF PIPE
	OS&Y
•	POINT OF RECONNECTION
S	EXTENT OF DEMOLITION
M	REGULATOR
®	METER

	ABBREVIATIONS
ABV	ABOVE
ASME	AMERICAN SOC. OF MECHANICAL ENGINEERS
ASTM	AMERICAN SOC. FOR TESTING & MATERIAL
BEL	BELOW
BLDG	BUILDING
СО	CLEANOUT
CW	COLD WATER
DF	DRINKING FOUNTAIN
DN	DOWN
DW	DISHWASHER
DWG	DRAWING
ED	EMERGENCY FLOOR DRAIN
ET	EXPANSION TANK
(E)	EXISTING
EX	EXISTING
ETR	EXISTING TO REMAIN
EWH	ELECTRIC WATER HEATER
FC0	FLOOR CLEANOUT
FD	FLOOR DRAIN
GWH	GAS WATER HEATER
HW	HOT WATER
HWR	HOT WATER RETURN
LAV	LAVATORY
NIC	NOT IN CONTRACT
NTS	NOT TO SCALE
PSK	PANTRY SINK
REF	REFRIGERATOR
SD	SHOWER DRAIN
SH	SHOWER
TV	TEMPERING VALVE

URINAL

UNLESS OTHERWISE NOTED

VERIFY IN FIELD

WATER CLOSET

DRAWING LIST

LEVEL 1 - NEW WORK PLAN

GENERAL NOTES, SYMBOLS, AND ABBREVIATIONS



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BAKER'S BREAD LLC NOE LANDINI 115 KING STREET ALEXANDIRA, VA 22314 **GENERAL CONTRACTOR** 5256 EISENHOWER AVE ALEXANDRIA, VA 22304 [T] 571.233.8585 [W] WWW.TECH24CONSTRUCTION.COM

3333 K STREET NW, SUITE 60 WASHINGTON DC 20007 [T] 202.350.4244 [W] WWW.3877.DESIGN

MEP ENGINEER **BUILT ENVIRONMENT ENGINEERS** 6861 ELM STREET MCLEAN, VA 22101 [T] 703.888.0649 [W] WWW.BEENGRS.COM

SINGER EQUIPMENT COMPANY JAMES FEUSTEL 180 HELLER PLACE BELLMAWR, NJ 08031 [T] 646-702-9922



ISSUED FOR PERMIT

DRAWING DATA

PROJECT: JUNCTION BAKERY -**ALEXANDRIA**

ADDRESS: 1508 MT VERNON AVENUE **ALEXANDRIA, VA 22301**

SHEET SUBMISSION INDEX

INTERIOR PERMIT - 3.31.2023


 EXTERIOR PERMIT - 3.31.2023 PERMIT RESPONSE - 6.07.2023

REVISION

EXTERIOR PERMIT REVISIONS

DATE 31 JULY 2023

SIGNATURE:

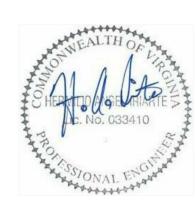


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SHEET TITLE: GENERAL NOTES, SYMBOLS, &

DATE ISSUED: 03/31/23 SCALE: As indicated

PROJECT NO: 2022-46

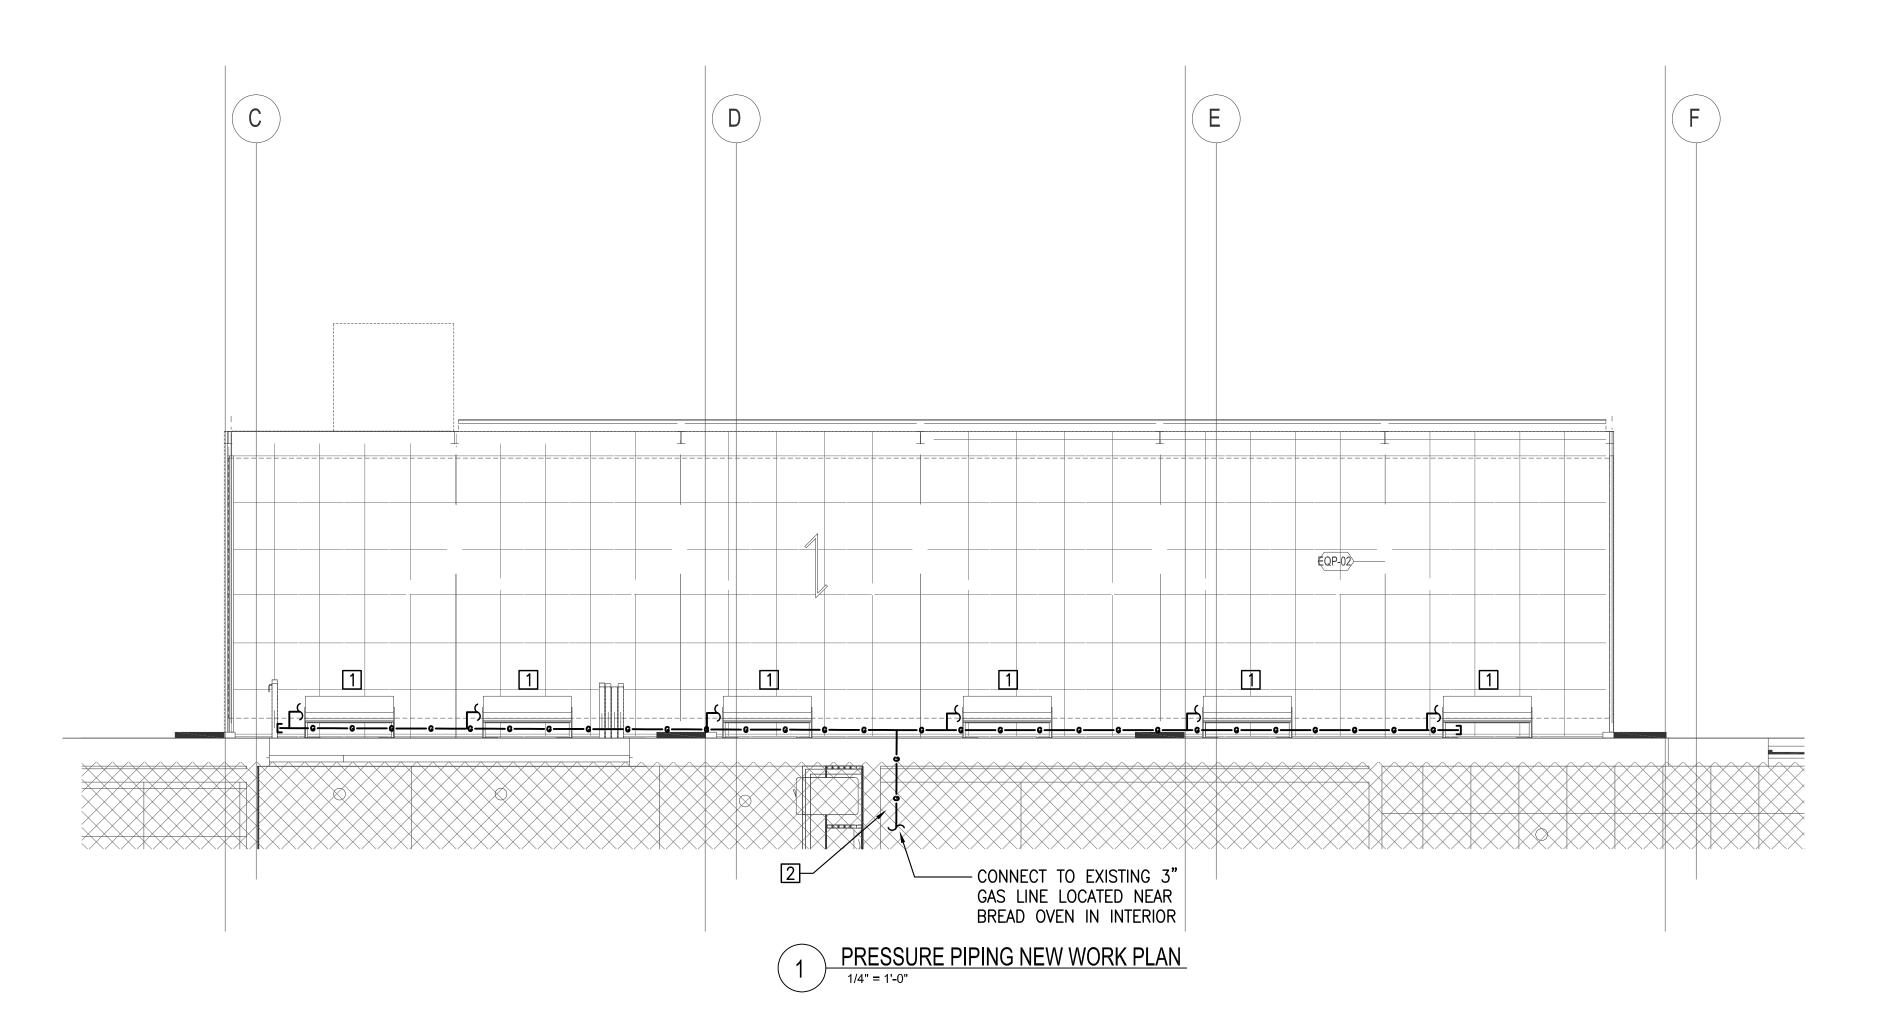

GENERAL NOTES:

A. SEE DRAWING POO1 FOR GENERAL NOTES,

SYMBOLS, & ABBREVIATIONS. B. FIELD VERIFY ADDITIONAL PIPING NOT SHOWN ON PLAN. VARIATIONS MAY BE ENCOUNTERED DURING

DEMOLITION/CONSTRUCTION. C. CONTRACTOR IS TO REPAIR WALLS, SLAB, & CEILING AREAS AFFECTED BY PLUMBING WORK. 1. PATIO HEATER (50 MBH) REFER TO ARCHITECTURAL DWGS FOR DETAILS.

2. PIPING TO BE ABOVE FINISHED CEILING INSIDE BLDG.

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BAKER'S BREAD LLC NOE LANDINI 115 KING STREET ALEXANDIRA, VA 22314 **GENERAL CONTRACTOR:** 5256 EISENHOWER AVE ALEXANDRIA, VA 22304

[T] 571.233.8585 [W] WWW.TECH24CONSTRUCTION.COM

3333 K STREET NW, SUITE 60 WASHINGTON DC 20007 [T] 202.350.4244 [W] WWW.3877.DESIGN MEP ENGINEER: BUILT ENVIRONMENT ENGINEERS

6861 ELM STREET MCLEAN, VA 22101 [T] 703.888.0649 [W] WWW.BEENGRS.COM FOOD SERVICE:

SINGER EQUIPMENT COMPANY JAMES FEUSTEL 180 HELLER PLACE BELLMAWR, NJ 08031



ISSUED FOR PERMIT

DRAWING DATA

PROJECT: JUNCTION BAKERY -**ALEXANDRIA**

ADDRESS: 1508 MT VERNON AVENUE **ALEXANDRIA, VA 22301**

SHEET SUBMISSION INDEX

 INTERIOR PERMIT - 3.31.2023 ISSUED FOR CONSTRUCTION INTERIOR - 08.11.2023

REVISION DATE EXTERIOR PERMIT REVISIONS EXTERIOR PERMIT REVISIONS

REVISED 1/25/2024

SIGNATURE:




ENTER PROFESSIONAL CERTIFICATION TEXT HERE THAT IS REQUIRED FOR THE JURISDICTION WHERE DRAWINGS WILL BE SUBMITTED.

SHEET TITLE: LEVEL 1 - NEW WORK PLAN

PROJECT NO: 2022-46 DATE ISSUED: 03/31/23

SCALE: As indicated

/ IS II MICHAELEU

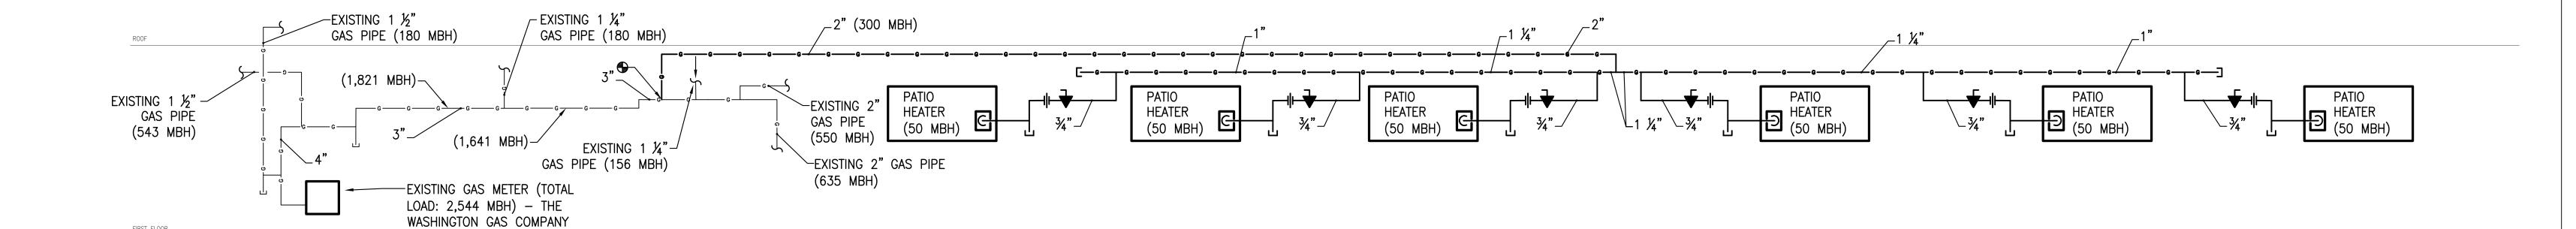

GAS RISER NOTES: 1. PLUMBING GAS WORK BEGINS AFTER POINT OF CONNECTION ON SHOWN RISER DIAGRAM AFTER GAS METER AND REGULATOR. WASHINGTON GAS TO PROVIDE GAS

METER AND REGULATOR (OUTDOORS). BASIS OF DESIGN IS SCHEDULE 40 BLACK STEEL. BASIS OF DESIGN IS LONGEST LENGTH METHOD FROM 2018 VFGC. 3.1. DESIGN BASIS = 2015 IFGC, TABLE 402.4(1)

INLET PRESSURE = LESS THAN 2.0 PSI PRESSURE DROP = 0.3 IN WC SPECIFIC GRAVITY = 0.60 GAS PIPE MEASURED LENGTH = 125 FT

4. SHUTOFF VALVES SHALL BE ACCESSIBLE.

5. PROVIDE SHUTOFF VALVES FOR ALL APPLIANCES AND EQUIPMENT AS REQUIRED.

6. PROVIDE DIRT LEGS AS REQUIRED.

7. REFER TO FLOOR PLANS FOR ADDITIONAL PIPING AND OFFSETS NOT SHOWN.

8. PROVIDE EXPANSION/DEFLECTION FITTINGS AS REQUIRED FOR ALL PIPING THAT PASSES ACROSS BLDG WALLS (OR JOINTS) AS WELL AS ROOFS (WHERE HORIZONTAL OFFSETS ARE NOT PROVIDED).

9. PROVIDE KICK PLATES AS REQUIRED FOR GAS PIPING IN WALLS AS PER IFGC

FIRST FLOOR