BAR CASE# BAR2025-00292 & BAR2025-00301
(OFFICE USE ONLY)

ADDRESS OF PROJECT: 1001 PRINCE STREET
DISTRICT: ■ Old & Historic Alexandria □ Parker – Gray □ 100 Year Old Building
TAX MAP AND PARCEL: $074.01-05-16$ ZONING: $CD$
APPLICATION FOR: (Please check all that apply)
■ CERTIFICATE OF APPROPRIATENESS
PERMIT TO MOVE, REMOVE, ENCAPSULATE OR DEMOLISH (Required if more than 25 square feet of a structure is to be demolished/impacted)
□ WAIVER OF VISION CLEARANCE REQUIREMENT and/or YARD REQUIREMENTS IN A VISION CLEARANCE AREA (Section 7-802, Alexandria 1992 Zoning Ordinance)
WAIVER OF ROOFTOP HVAC SCREENING REQUIREMENT (Section 6-403(B)(3), Alexandria 1992 Zoning Ordinance)
Applicant: Property Owner Business (Please provide business name & contact person)
Name: Virginia Tech Foundation
Address:_
City:
Phone:
Authorized Agent (if applicable): Attorney Architect
Name: Jonathan Rodgers Phone:
E-mail:
Legal Property Owner:
Name: Virgina Tech Foundation, Inc.
Address:
City: Zip:
Phone: 'F-mail:

	CASE#
DAK	CASE#

(OFFICE USE ONLY)

NATURE OF PROPOSED WORK: Please check all that apply
NEW CONSTRUCTION         EXTERIOR ALTERATION: Please check all that apply.         awning       fence, gate or garden wall       HVAC equipment       shutters         doors       windows       siding       shed         lighting       pergola/trellis       painting unpainted masonry         other       New ADA Ramp & new stair below grade to sprinkler room         ADDITION         DEMOLITION/ENCAPSULATION         SIGNAGE
<b>DESCRIPTION OF PROPOSED WORK:</b> Please describe the proposed work in detail (Additional pages may be attached).
The building at 1001 Prince Street will be renovated to improve accessibility and life safety. Interior alterations include the addition of
a new elevator to provide accessible access to all floors, as well as excavation of an existing crawl space to create a new sprinkler
room - the building will be fully sprinklered as part of the renovations. Exterior atlerations include modifying an existing concrete and
masonry stair to add a new concrete and masonry ADA ramp up to the 1st floor, new ramp to be located on the North (rear) of the
building facing the existing parking lot. A new exterior stair will be added on the East side of the building provide access to a new
sprinkler room, this stair will be below grade and excavation will only disturb the existing concrete parking area.
SUBMITTAL REQUIREMENTS:  Check this box if there is a homeowner's association for this property. If so, you must attach a copy of the letter approving the project.  Items listed below comprise the minimum supporting materials for BAR applications. Staff may request additional information during application review. Please refer to the relevant section of the Design Guidelines for further information on appropriate treatments.  Applicants must use the checklist below to ensure the application is complete. Include all information and material that are necessary to thoroughly describe the project. Incomplete applications will delay the docketing of the application for review. Pre-application meetings are required for all proposed additions. All applicants are encouraged to meet with staff prior to submission of a completed application.
<b>Demolition/Encapsulation</b> : All applicants requesting 25 square feet or more of demolition/encapsulation must complete this section. Check N/A if an item in this section does not apply to your project.
N/A Survey plat showing the extent of the proposed demolition/encapsulation. Existing elevation drawings clearly showing all elements proposed for demolition/encapsulation. Clear and labeled photographs of all elevations of the building if the entire structure is proposed to be demolished. Description of the reason for demolition/encapsulation. Description of the alternatives to demolition/encapsulation and why such alternatives are not

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**Additions & New Construction:** Drawings must be to scale and should not exceed 11" x 17" unless approved by staff. Check N/A if an item in this section does not apply to your project.

	N/A	
		Scaled survey plat showing dimensions of lot and location of existing building and other structures on the lot, location of proposed structure or addition, dimensions of existing structure(s), proposed addition or new construction, and all exterior, ground and roof mounted
		equipment. FAR & Open Space calculation form. Clear and labeled photographs of the site, surrounding properties and existing structures, if
		applicable.  Existing elevations must be scaled and include dimensions.  Proposed elevations must be scaled and include dimensions. Include the relationship to
		adjacent structures in plan and elevations.  Materials and colors to be used must be specified and delineated on the drawings. Actual samples may be provided or required.
		Manufacturer's specifications for materials to include, but not limited to: roofing, siding, windows, doors, lighting, fencing, HVAC equipment and walls.  For development site plan projects, a model showing mass relationships to adjacent properties
Ш	Ш	and structures.
illun	ninate	& Awnings: One sign per building under one square foot does not require BAR approval unless ed. All other signs including window signs require BAR approval. Check N/A if an item in this section does / to your project.
		Linear feet of building: Front:Secondary front (if corner lot):  Square feet of existing signs to remain:  Photograph of building showing existing conditions.  Dimensioned drawings of proposed sign identifying materials, color, lettering style and text.  Location of sign (show exact location on building including the height above sidewalk).  Means of attachment (drawing or manufacturer's cut sheet of bracket if applicable).  Description of lighting (if applicable). Include manufacturer's cut sheet for any new lighting fixtures and information detailing how it will be attached to the building's facade.
Alt	erat	ions: Check N/A if an item in this section does not apply to your project.
х	N/A	Clear and labeled photographs of the site, especially the area being impacted by the alterations, all sides of the building and any pertinent details.
		doors, lighting, fencing, HVAC equipment and walls.
x x		Drawings accurately representing the changes to the proposed structure, including materials and overall dimensions. Drawings must be to scale.  An official survey plat showing the proposed locations of HVAC units, fences, and sheds.  Historic elevations or photographs should accompany any request to return a structure to an earlier appearance.

### BAR CASE# <u>BAR2025-00292 & BAR20</u>25-00301

(OFFICE USE ONLY)

#### ALL APPLICATIONS: Please read and check that you have read and understand the following items:

X	I understand that after reviewing the proposed alterations, BAR staff will invoice the appropriate filing fee in APEX. The application will not be processed until the fee is paid online.
Х	I understand the notice requirements and will return a copy of the three respective notice forms to BAR staff at least five days prior to the hearing. If I am unsure to whom I should send notice I will contact Planning and Zoning staff for assistance in identifying adjacent parcels.
X	I, the applicant, or an authorized representative will be present at the public hearing.
Х	I understand that any revisions to this initial application submission (including applications deferred for restudy) must be accompanied by the BAR Supplemental form and revised materials.

The undersigned hereby attests that all of the information herein provided including the site plan, building elevations, prospective drawings of the project, and written descriptive information are true, correct and accurate. The undersigned further understands that, should such information be found incorrect, any action taken by the Board based on such information may be invalidated. The undersigned also hereby grants the City of Alexandria permission to post placard notice as required by Article XI, Division A, Section 11-301(B) of the 1992 Alexandria City Zoning Ordinance, on the property which is the subject of this application. The undersigned also hereby authorizes the City staff and members of the BAR to inspect this site as necessary in the course of research and evaluating the application. The applicant, if other than the property owner, also attests that he/she has obtained permission from the property owner to make this application.

#### APPLICANT OR AUTHORIZED AGENT:

Signature: Jonathan Rodgers
Rodgers
Date: 2025.07.21.15:55:30-04'00'

Printed Name: Jonathan Rodgers

Date: July 21, 2025

# OWNERSHIP AND DISCLOSURE STATEMENT Use additional sheets if necessary

		,
an interest in the applicant, uncase identify each owner of include any legal or equitable which is the subject of the applicant.		ion or partnership, in which erm ownership interest shall application in the real property
Name	Address	Percent of Ownership
1.		
2.		
3.		
an interest in the property locate entity is a corporation or partne percent. The term ownership in time of the application in the rea	rship, in which case identify each terest shall include any legal or e al property which is the subject of	(address), unless the owner of more than three quitable interest held at the the application.
Name	Address	Percent of Ownership
1.		
2.		
3.		
ownership interest in the applicationship business or financial relationship existing at the time of this applications.	ionships. Each person or entity list ant or in the subject property is rep, as defined by Section 11-350 cation, or within the 12-month perior of the Alexandria City Council, Is of Architectural Review.	equired to disclose <b>any</b> of the Zoning Ordinance, od prior to the submission of
Name of person or entity	Relationship as defined by Section 11-350 of the Zoning Ordinance	Member of the Approving Body (i.e. City Council, Planning Commission, etc.)
1.		
2.		
3.		
	relationships of the type descr tion and before each public hea	
As the applicant or the applicant the information provided above	t's authorized agent, I hereby atto	est to the best of my ability that
•	N RODGERS	
Date Printed	d Name	Signature

# VIRGINIA TECH WASHINGTON-ALEXANDRIA ARCHITECTURE CENTER

1001 PRINCE STREET ALEXANDRIA, VIRGINIA 22134

SCOPE OF WORK

HE SCOPE OF WORK FOR THIS PERMIT IS FOR RENOVATIONS TO ALL FLOORS OF AN EXISTING BUILDING, OCCUPIED BY A SINGLE TENAN

REFER TO ENGINEERING PLANS FOR SCOPE OF STRUCTURAL, MECHANICAL, ELECTRICAL AND PLUMBING WORK

**ARCHITECT** 

architecture+design

4601 N. FAIRFAX DRIVE ARLINGTON, VA 22203 MEP ENGINEER



5628 FOXCROFT WAY COLUMBIA, MD 21045 (T): 202-674-4481

STRUCTURAL ENGINEER



240 SUNCREST ST JOHNSON CITY, TN 37615 (T): 423-477-8314

CIVIL ENGINEER



625 N WASHINGTON ST SUITE 250 ALEXANDRIA, VA 22314 (T): 703-549-6422

# **ARCHITECTURAL**

CODE & OCCUPANCY ANALYSIS CODE & OCCUPANCY ANALYSIS

PARTITION TYPE DETAILS & NOTES DOOR & HARDWARE SCHEDULE

DEMOLITION BASEMENT & FIRST FLOOR DEMOLITION SECOND FLOOR & ATTIC

CEILING DEMOLITION BASEMENT & FIRST FLOOR

CEILING DEMOLITION SECOND FLOOR & ATTIC

ARCHITECTURAL PLAN BASEMENT & FIRST FLOOR

ARCHITECTURAL PLAN SECOND FLOOR & ATTIC

CEILING PLAN BASEMENT & FIRST FLOOR

CEILING PLAN SECOND FLOOR & ATTIC

EQUIPMENT PLAN BASEMENT EQUIPMENT PLAN FIRST & SECOND FLOOR

EXTERIOR ELEVATIONS BUILDING SECTIONS

EXTERIOR RAMP ELEVATIONS

**ELEVATIONS & DETAILS** 

GENERAL NOTES

EXTERIOR STAIR DETAILS

A302 GENERAL SPECIFICATIONS

STRUCTURAL

STRUCTURAL DETAILS

STRUCTURAL NOTES STRUCTURAL NOTES

SCHEDULE OF SPECIAL INSPECTIONS

SCHEDULE OF SPECIAL INSPECTIONS

STRUCTURAL PLANS

STRUCTURAL PLANS

NEW RAMP FOUNDATION PLAN

STRUCTURAL SECTIONS STRUCTURAL SECTIONS

STRUCTURAL SECTIONS

S502 STRUCTURAL DETAILS STRUCTURAL DETAILS

# **ENGINEERING**

GENERAL NOTES, SYMBOLS AND ABBREVIATIONS - MECHANICAL

BASEMENT FLOOR PLAN - DEMOLITION - MECHANICAL

2ND FLOOR PLAN - DEMOLITION - MECHANICAL

**EQUIPMENT SCHEDULES - MECHANICAL** 

GENERAL NOTES, SYMBOLS AND ABBREVIATIONS - PLUMBING

BASEMENT FLOOR PLAN - DEMOLITION - PLUMBING

1ST FLOOR FLOOR PLAN - DEMOLITION - PLUMBING

1ST FLOOR FLOOR PLAN - NEW WORK - PLUMBING

GENERAL NOTES, SYMBOLS AND ABBREVIATIONS - ELECTRICAL


1ST FLOOR PLAN NEW WORK LIGHTING - ELECTRICAL

2ND FLOOR PLAN NEW WORK POWER - ELECTRICAL

2ND FLOOR PLAN NEW WORK FIRE ALARM - ELECTRICAL

POWER RISER DIAGRAM - DEMOLITION - ELECTRICAL

POWER RISER DIAGRAM - NEW WORK ELECTRICAL PANEL SCHEDULES - ELECTRICAL

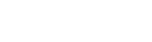

1ST FLOOR FLOOR PLAN - NEW WORK - MECHANICAL

2ND FLOOR PLAN - NEW WORK - MECHANICAL

ATTIC FLOOR PLAN - NEW WORK - MECHANICAL

2ND FLOOR PLAN - DEMOLITION - PLUMBING

BASEMENT FLOOR PLAN - NEW WORK - PLUMBING

2ND FLOOR PLAN - NEW WORK - PLUMBING

2ND FLOOR PLAN NEW WORK LIGHTING - ELECTRICAL

1ST FLOOR PLAN NEW WORK POWER - ELECTRICAL

BASEMENT FLOOR PLAN NEW WORK FIRE ALARM - ELECTRICAL

1ST FLOOR PLAN NEW WORK FIRE ALARM - ELECTRICAL

1ST FLOOR FLOOR PLAN - DEMOLITION - MECHANICAL

BASEMENT FLOOR PLAN - NEW WORK - MECHANICAL


**VENTILATION SCHEDUILES - MECHANICAL** 

DETAILS - MECHANICAL

SCHEDULES AND DETAILS - PLUMBING

BASEMENT FLOOR PLAN NEW WORK LIGHTING - ELECTRICAL

BASEMENT FLOOR PLAN NEW WORK POWER - ELECTRICAL

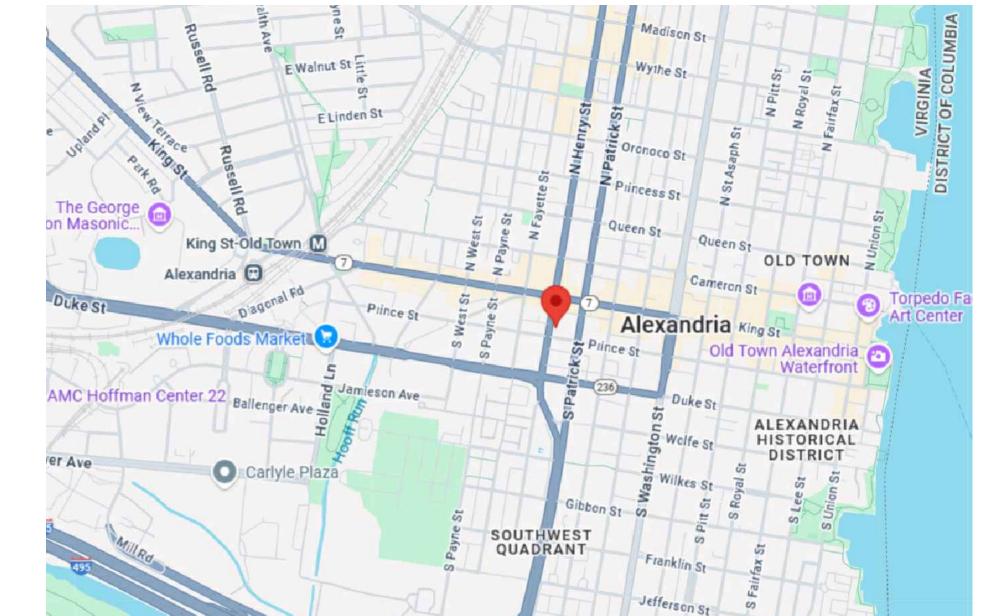




Jones



4601 FAIRFAX DRIVE ARLINGTON, VIRGINIA 22203 (T): 703-527-2280

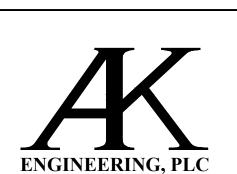

5628 FOXCROFT WAY COLUMBIA, MD 21045 (T): 202-674-4481



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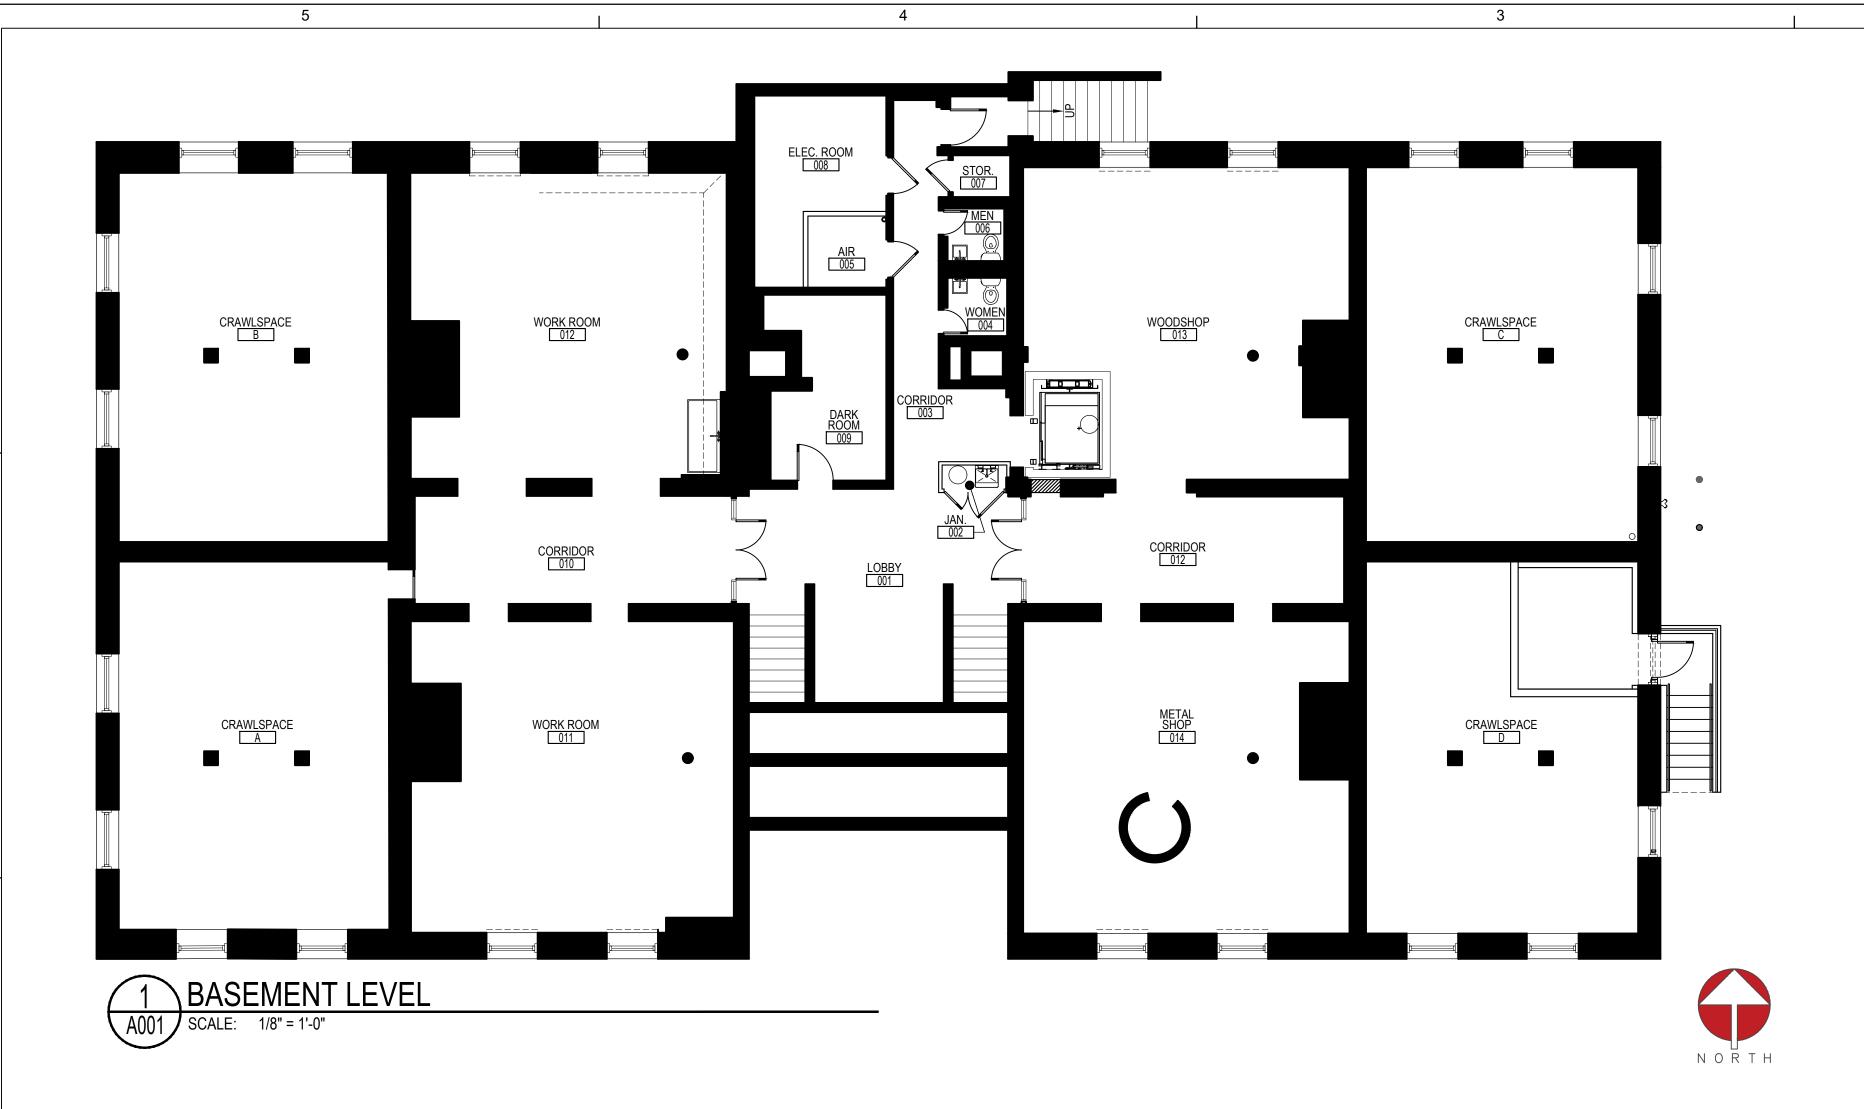
ISSUED	DATE
DESIGN INTENT DRAWINGS	03.28.2025
PERMIT & BID	07.18.2025

PROJECT NO:

DESIGNED/DRAWN BY:

REVIEWED/APPROVED BY: PE

SHEET TITLE: **COVER SHEET** 



		JUPANC	Y LOAD	CALCULA			5 2021 I	ABLE 10	JU4.5	
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							PER		TABULAR	LOAD
							PERSON		IF SAME	
BUSINESS A							150			_
ENTRY / LOI		<u>IEN/MEN/</u>	CORRIDO	RS		913		6	SAME	6
DARKROOM						158		1	SAME	1
WORK ROC						650		4	SAME	4
WORK ROC						635		4	SAME	4
WOODSHO						603		4	SAME	4
METAL SHO	.⊃ 014					650		4	SAME	4
TOTAL						3,609		23	SAME	23
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STORAGE/L	ITII ITV AD	E 16.				Τ	300			1
ELEC ROOM		LAS.				175	300	0.58	SAME	0.58
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								0.00	OAME	0.00
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		DOOR WI	1	ACTUAL			INCLIEC	STAIR WID		ACTUAL
DOOD #1	INCHES	RATIO	LOAD	ACTUAL		STAIR #1	INCHES	RATIO	LOAD	ACTUAL
DOOR #1	56	0.15	373	12			108	0.2	540	12
DOOR #2	34	0.15	227	12		STAIR #2	62	0.2	310	12
	L ALLOWE	-D =	600	24		TOT	AL ALLOW	FD =	850	24
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тот	PLU	MBING F	FIXTURE	CALCUL	ATION	5 PER IB	C 2021 I	ADLE 2	902.1	
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USE	<b>PLU</b> LOAD	MBING F		CLOSETS	ATION	SPERIB		ORIES	902.1	DRINKING
			WATER	CLOSETS			LAVAT	ORIES		DRINKING FOUNTAIN
USE								ORIES	902.1 MALE	

PER IEBC 2021 SECTION 810.1: OCCUPANT LOAD OF THE STORY HAS NOT INCREASED BY MORE THAN 20%; PLUMBING FIXTURE COUNT IS NOT REQUIRED TO INCREASE. NOTE: NEW HIGH-LOW DRINKING FOUNTAIN WITH BOTTLE FILLER IS LOCATED ON FIRST FLOOR AND IS AVAILABLE TO ALL OCCUPANTS.

# APPLICABLE CODES

BUILDING:	VIRGINIA CONSTRUCTION CODE (IBC) VIRGINIA EXISTING BUILDING CODE	2021 2021
MECHANICAL:	VIRGINIA EXISTING BOILDING CODE	2021
PLUMBING/GAS:	VIRGINIA PLUMBING CODE	2021
	VIRGINIA FUEL GAS CODE	2021
ELECTRICAL:	NFPA NATIONAL ELECTRICAL CODE	2020
ENERGY:	VIRGINIA ENERGY CONSERVATION CODE	2021
LIFE SAFETY:	NFPA-13	2019
	NFPA-72	2019
FIRE ALARM:	INTERNATIONAL FIRE CODE	2021
	VIRGINIA STATEWIDE FIRE PREVENTION CODE	2021
ACCESSIBILITY:	ICC/ ANSI A117.1	2017

# CODE ANALYSIS (PER TABLE 601)

3

CONSTRUCTION TYPE: USE GROUP: BUILDING FOOTPRINT: HEIGHT/STORIES: SUPPRESSION: CENTRAL MONITORING STATION: PRIMARY STRUCTURAL FRAME: BEARING WALLS (EXTERIOR): BEARING WALLS (INTERIOR): NONBEARING WALLS AND PARTITIONS (EXTERIOR): NONBEARING WALLS AND PARTITIONS (INTERIOR):	IIIB B - BUSINESS 8,278 SF 2 FLOORS ABOVE GRADE,BASEMENT LEVEL & ATTIC (NOT OCCUPIED SPACE) FULLY SPRINKLERED YES 0 HR 2 HR (MASONRY) 2 HR (MASONRY) 0 HR

\*\*CONCRETE FIRE RATING PER IBC 2018 TABLE 721.1 ITEM NUMBER 4-1.1

architecture+design

4601 FAIRFAX DRIVE SUITE 1000 ARLINGTON, VIRGINIA 22203 (T): 703-527-2280

ENGINEERING, PLC


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VIRGINIA TECH ASHINGTON-ALEXANDRIA ARCHITECTURE CENTER

1 PER 1000 0.01

1 PER 100



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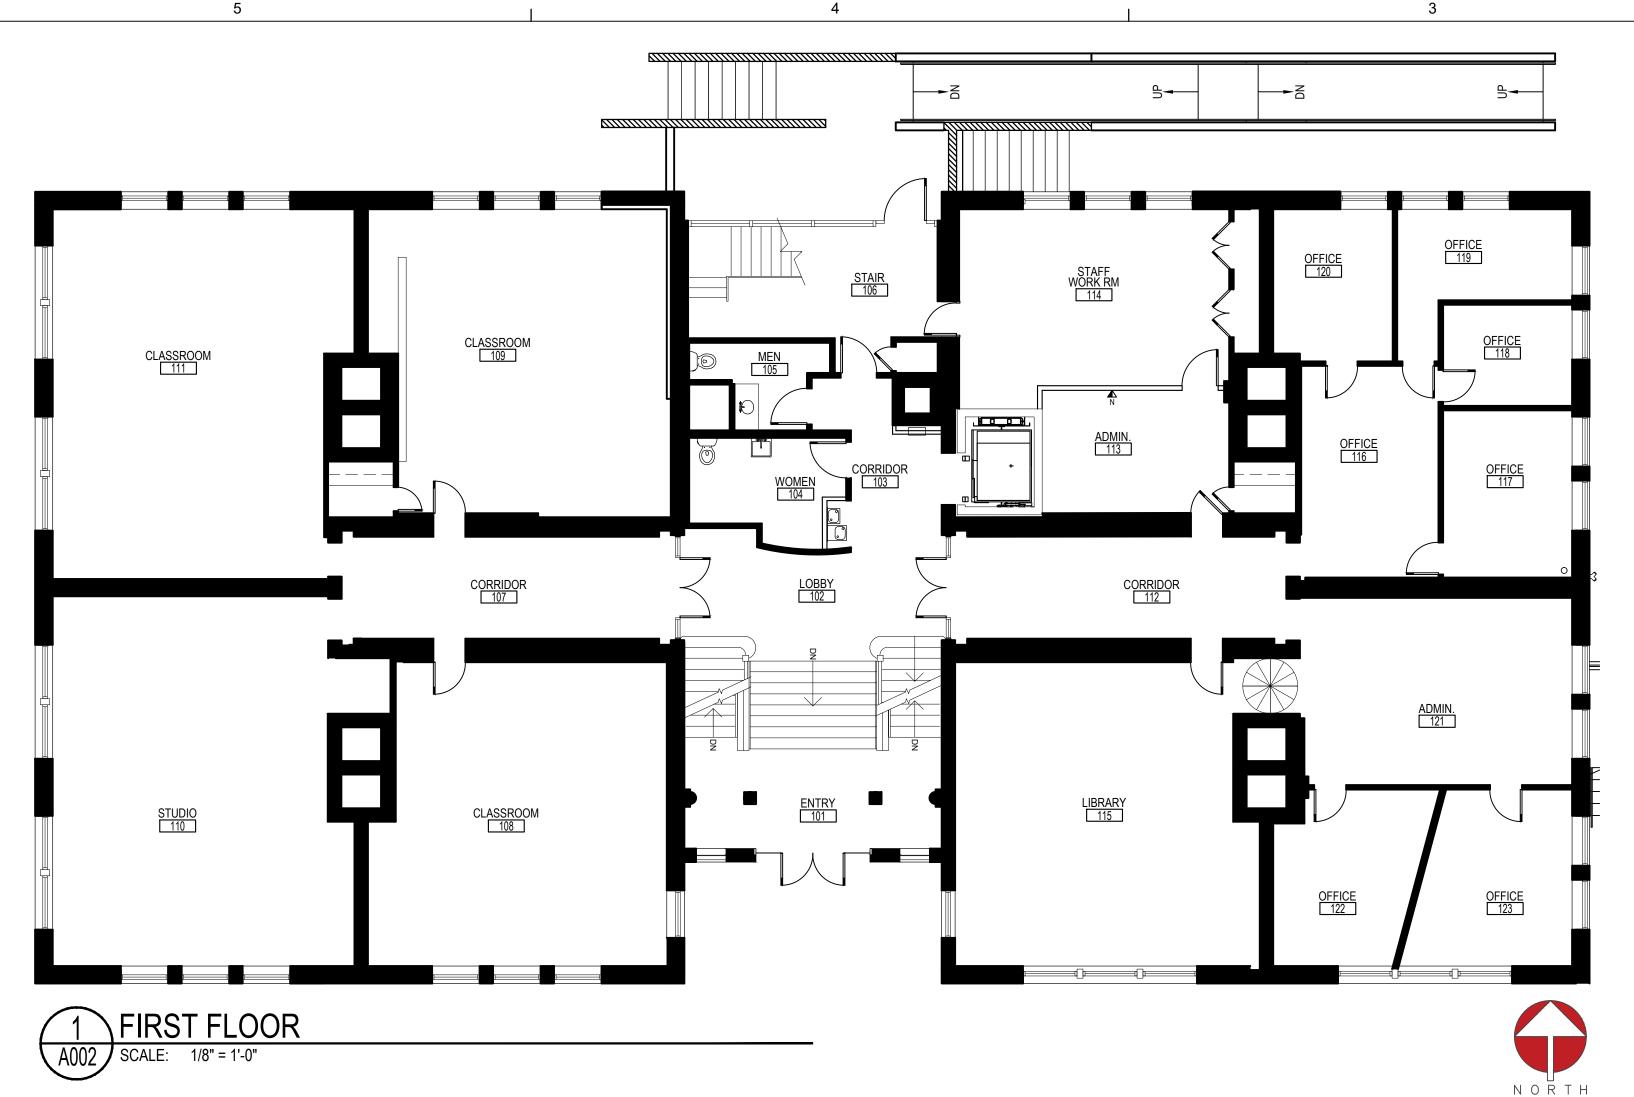
ISSUED	DATE
DESIGN INTENT DRAWINGS	03.28.2025
PERMIT & BID	07.18.2025

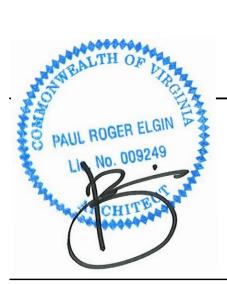DESIGNED/DRAWN BY: DESIGNED/DRAWN D. .

REVIEWED/APPROVED BY: PE

24-152

CODE & OCCUPANCY ANALYSIS



							PER PERSON	LOAD	TABULAR IF SAME	LOAD
BUSINESS A	AREAS (UN	CONCENT	RATED):				150			
ENTRY / LOE	•			RS		1,052		7	SAME	7
STUDIO 110						728		5	SAME	5
ADMIN 113						159		1	SAME	1
LIBRARY 115	5					613		4	SAME	4
OFFICE 116						202		1	SAME	1
OFFICE 117						149		1	SAME	1
OFFICE 118						90		1	SAME	1
OFFICE 119						128		1	SAME	1
OFFICE 120						124		1	SAME	1
ADMIN 121						613		4	SAME	4
OFFICE 122						613		4	SAME	4
OFFICE 123						613		4	SAME	4
OFFICE 116						747		5	SAME	5
TOTAL						1,939		39	SAME	39
BUSINESS A	AREAS (CO	NCENTRA	TED):				50		$\overline{}$	1
STAFF WOR		1102111101	120).			341	"	7	SAME	7
TOTAL	A CONTRACTOR					341		7	SAME	7
									1 5,	
ASSEMBLY	AREAS (UN	CONCENT	RATED):				20			
CLASSROO	M 108					600		30	SAME	30
CLASSROO	M 109					612		31	SAME	31
CLASSROO	M 111					727		36	SAME	36
CLASSROO	M 111					748		37	SAME	37
TOTAL						2,687		134	SAME	134
ASSEMBLY	AREAS (CC	ONCENTRA	ATED):			<u> </u>	7		<del></del>	1
,,,,,,,,,,,,,,,,,,,,,,,,,,,,,,,,,,,,,,,	<u> </u>	2110211110	··						+	
TOTAL						0		0	SAME	0
										1
STORAGE/U	ITILITY AR	EAS:					300			
								0.00	SAME	0.00
TOTAL						0		0	SAME	0
TOTAL TEN	ANT ADEA					4.007				100
TOTAL TEN			1105/			4,967	450	0		180
N.I.C. SPACE			-USE)				150	0	<del>                                     </del>	180
TOTAL FLO	<u>OR OCCOP</u>	ANCI								100
	ſ	REQUIRE	ED EGRE	ESS WID	THPER	IBC 2018	SECTIO	N 1005.	.3	
	OTAID	- BOOD \4"	DTU					OTAID VAUE		
		DOOR WI		ACTUAL				STAIR WIE		LACTUAL
DOOR #1	INCHES 56	0.15	LOAD 373	ACTUAL 90	-	STAIR #1	INCHES	RATIO	LOAD	ACTUAL
	<b>+</b>			+					<del> </del>	
DOOR #2	40	0.15	267	90	-	STAIR #2			-	
TOTA	AL ALLOWE	D =	640	180		тот	AL ALLOW	ED =	0	0
	PLU	MBING F	FIXTURE	CALCU	LATIONS	PER IB	C 2018 T	ABLE 2	902.1	
			WATER	CLOSETS			LAVAT	ORIES		DRINKING
USE	LOAD									FOUNTAINS
USE GROUP	LOAD		ALE.	FEM	<b>MALE</b>	M/	ALE	FEN	MALE	
	LOAD	M/-				1 DED //		FIRST 80	1 PFR 80	
	LOAD		5 FOR THE	FIRST 50	1 PFR 50	1 PER 40 FOR THE FIRST 80; 1 PER 80 THEREAFTER 1 PER				1 PER 100
GROUP				FIRST 50;	1 PER 50	IFLIX 4		AFTFR	EAFTER	
	LOAD 46	1 PER 2	THERE	EAFTER			THERE			
GROUP		1 PER 2		EAFTER	1 PER 50 92				.58	0.46
GROUP		1 PER 29	THERE	EAFTER 0.	92		THERE	0	.58	,
GROUP BUSINESS	46	1 PER 29	THERE 92 R 125	EAFTER 0.	92 ER 65		THERE	0 ₹ 200	.58	1 PER 500
GROUP		1 PER 29	THERE	EAFTER 0.	92		THERE	0	.58	,
GROUP BUSINESS	46	1 PER 29	THERE 92 R 125 54	0. 1 PE	92 ER 65		THERE .58 1 PEF 0.0	0 R 200 87	.58	1 PER 500 0.27
GROUP BUSINESS	46	1 PER 29	THERE 92 R 125 54 1 PE	0. 1 PE 1. R 100	92 ER 65		THERE .58  1 PEF 0.0	0 R 200 67 R 100	.58	1 PER 500 0.27
GROUP BUSINESS ASSEMBLY	46	1 PER 29	THERE 92 R 125 54 1 PE	0. 1 PE	92 ER 65		THERE .58 1 PEF 0.0	0 R 200 67 R 100	.58	1 PER 500 0.27
GROUP BUSINESS ASSEMBLY STORAGE	46 134	1 PER 29	THERE 92 R 125 54 1 PE 0	0. 1 PE 1. R 100 .00	92 ER 65 03	0.	THERE .58  1 PEF 0.0	0 R 200 67 R 100		1 PER 500 0.27 1 PER 1000 0.00
GROUP BUSINESS ASSEMBLY	46 134 0	1 PER 2:	THERE 92 R 125 54 1 PE 0	0. 1 PE 1. R 100 .00	92 ER 65 03	0.92	THERE .58  1 PEF 0.0	0 R 200 67 R 100 00		1 PER 500 0.27

2

OCCUPANCY LOAD CALCULATIONS PER IBC 2021 TABLE 1004.5						OCCUPANCY LOAD CALCULATIONS PER IBC 2021 TABLE 1004.5								
FIRST F	FLOOR				SECOND FLOOR									
USAGE BY OCCUPANCY CLASSIFICATION		TABULAR LOAD	BY SEAT OR TABULAR IF SAME	COMPARED				CY CLASSI		USF	SQUARE FOOT PER PERSON	TABULAR LOAD	BY SEAT OR TABULAR IF SAME	GREATER COMPARED LOAD
SS AREAS (UNCONCENTRATED):	150				BUSINESS A				20	4.050	150	7	0.4845	
LOBBY/WOMEN/MEN/CORRIDORS	1,052	7	SAME	7	ENTRY / LOE		EN/MEN/	CORRIDO	र8	1,052		7	SAME	7
110	728	5	SAME	5	STUDIO 208/ STUDIO 209/					603 731		<u>4</u> 5	SAME	4 5
13	159	1	SAME	1	STUDIO 209/					731		5 	SAME	5
/ 115	613	4	SAME	4	STUDIO 211/		/2110			576		4	SAME	4
116	202	1	SAME	1	310010 211/	1211742110	2110			370		0	SAME	0
117	149	1	SAME	1	TOTAL					2,641		25	SAME	25
	90	1	SAME	· -	IOIAL					2,041		20	O/ WIL	20
118		·	<u> </u>	1	BUSINESS A	AREAS (C.C.	NCENTRA	TED):			50			
119	128	1	SAME	1	LIBRARY 213		THO EITH O	120).		608		12	SAME	12
120	124	1	SAME	1	LIBRARY 214					590		12	SAME	12
21	613	4	SAME	4	LIBRARY 215					753		15	SAME	15
122	613	4	SAME	4	COPY 216					558		11	SAME	11
123	613	4	SAME	4	PRINT 217					753		15	SAME	15
116	747	5	SAME	5	TOTAL					3,262		65	SAME	65
	1,939	39	SAME	39						•				
					ASSEMBLY	AREAS (UN	CONCENT	RATED):			20			
SS AREAS (CONCENTRATED):	50											0		0
VORK RM 114	341	7	SAME	7	TOTAL					0		0	SAME	0
	341	7	SAME	7										
		ı			ASSEMBLY	AREAS (CO	DNCENTRA	ATED):			7			
BLY AREAS (UNCONCENTRATED):	20													
ROOM 108	600	30	SAME	30	TOTAL					0		0	SAME	0
COM 109	612	31	SAME	31										
ROOM 111	727	36	SAME	36	STORAGE/U						300			
ROOM 111	748	37	SAME	37	CLOSET 211		1F			48		0.16	SAME	0.16
COOM III	2,687	134	SAME		CLOSET 216	SA/216B				53		0.18	SAME	0.18
	2,007	134	SAIVIE	134	TOTAL					101				
DLV ADEAC (CONCENTRATER).	7		1		<del> </del>						450			
BLY AREAS (CONCENTRATED):	/				TOTAL TEN			LIOE)		6,004	150	0		0
			0.1145		N.I.C. SPACE	•		-USE)						0
	0	0	SAME	0	TOTAL FLO	OR OCCUI	ANCY							
		1	1											
GE/UTILITY AREAS:	300				1		REQ	UIRED E	<b>GRESS WIDTH F</b>	PER IBC	2018 SEC	TION 1005.3		
		0.00	SAME	0.00										
	0	0	SAME	0		STAIR	DOOR W	DTH				STAIR WIDTH		
						INCHES	RATIO	LOAD	ACTUAL		INCHES	RATIO	LOAD	ACTUAL
TENANT AREA	4,967			180	DOOR #1	56	0.15	373	0	STAIR #1	108	10.010	LOAD	/\C\O\L
PACE (CALCULATED AS B-USE)	150	0		0	DOOR #2	40	0.15	267	0	STAIR #2	49			
FLOOR OCCUPANCY				180	]	10	0.10	201		017411172	10			
					TOTA	AL ALLOWE	D =	640	0		TOTAL ALI	LOWED =	0	0
REQUIRED EGRESS WIDTH P	ER IBC 2018 SECTION	ON 1005.	3						URE CALCULAT	IONS DE				
STAIR DOOR WIDTH		STAIR WID	)TH		<del></del>		LONBI	ING FIAT	ONE CALCULAT	IONS PE	IN IBC 201	10 IADLE 2302.	. 1	
INCHES RATIO LOAD ACTUAL	INCHES	RATIO	LOAD	ACTUAL	USE	LOAD		WATER (	CLOSETS		Ι Δ	AVATORIES		DRINKING
	STAIR #1	RAIIU	LOAD	ACTUAL	GROUP			AAVI FIZ (	JLJOL 10		-ك	W/ (I OI (ILO		FOUNTAINS
				1		l .	MA	ALE	FEMALE	M/	LE T	FEMALE		
OTAL ALLOWED = 640 180	STAIR #2   TOTAL ALLOW	ED =	0	0	BUSINESS	15		5 FOR THE	FIRST 50; 1 PER 50 EAFTER		ER 40 FOR	THE FIRST 80; 1 PER IEREAFTER		1 PER 100
							0	.30	0.30	n	19	0.19		0.15
-							<u>.                                     </u>		1 0.00	<u> </u>		0.10		0.10

NOTE: NEW HIGH-LOW DRINKING FOUNTAIN WITH BOTTLE FILLER IS LOCATED ON FIRST FLOOR AND IS AVAILABLE TO ALL OCCUPANTS.

0.00 (0) 0.19 (1)

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ENGINEERING, PLC

5628 FOXCROFT WAY

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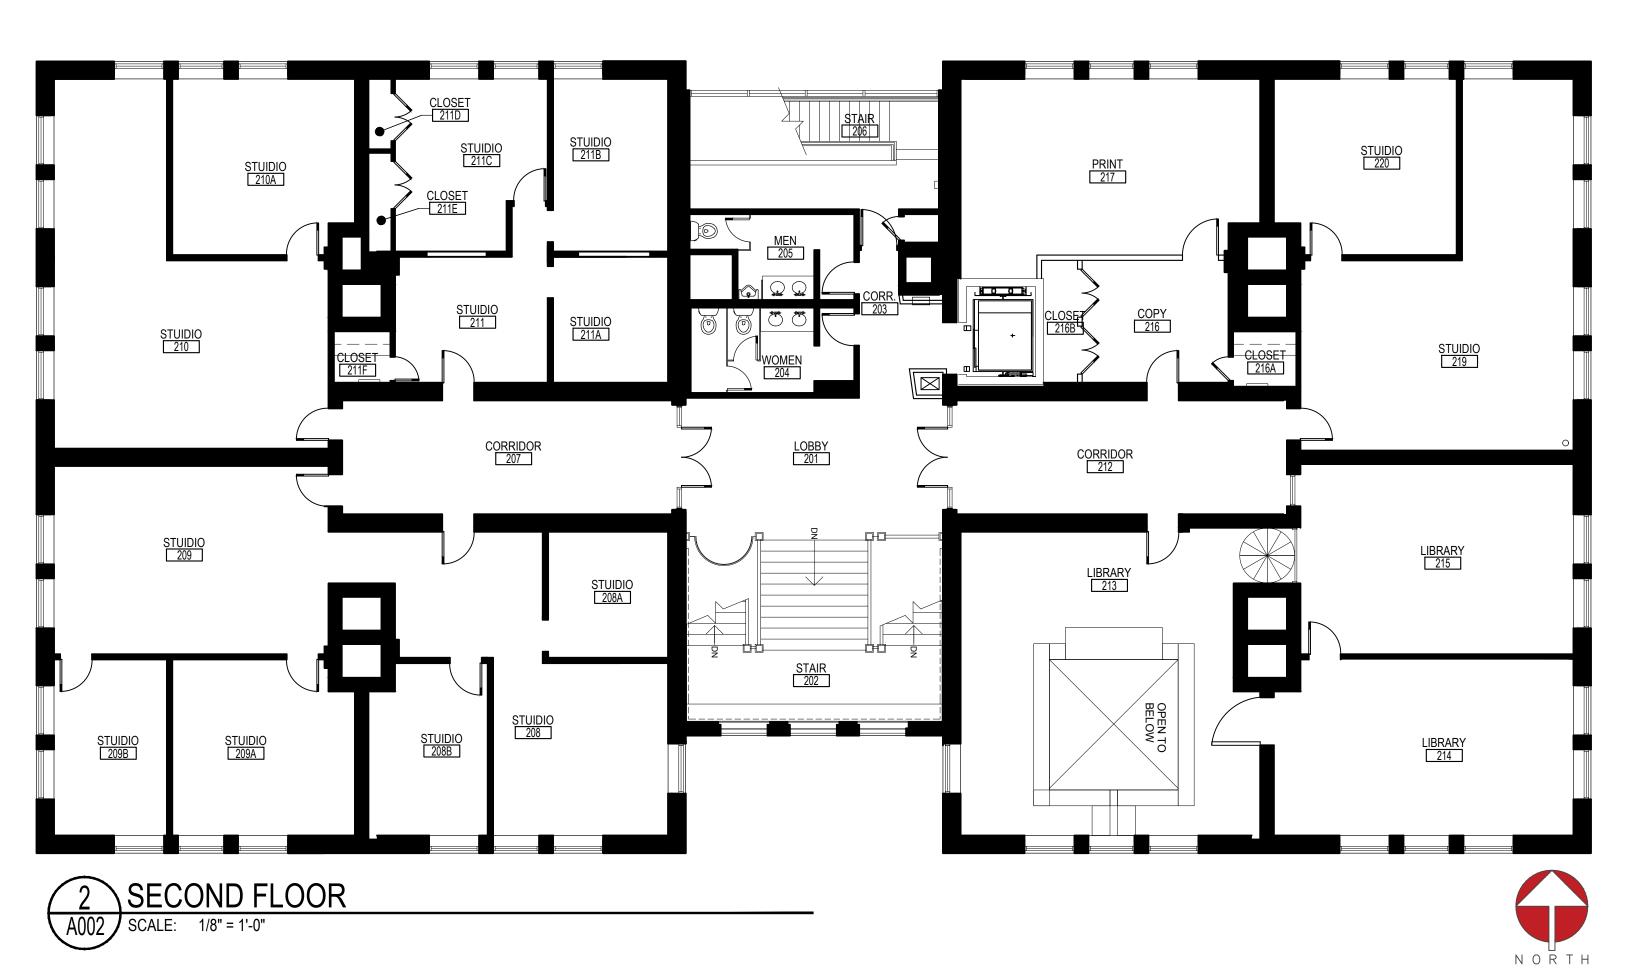
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DESIGNED/DRAWN BY: REVIEWED/APPROVED BY: PE PROJECT NO:

SHEET TITLE:


OCCUPANCY **ANALYSIS** 


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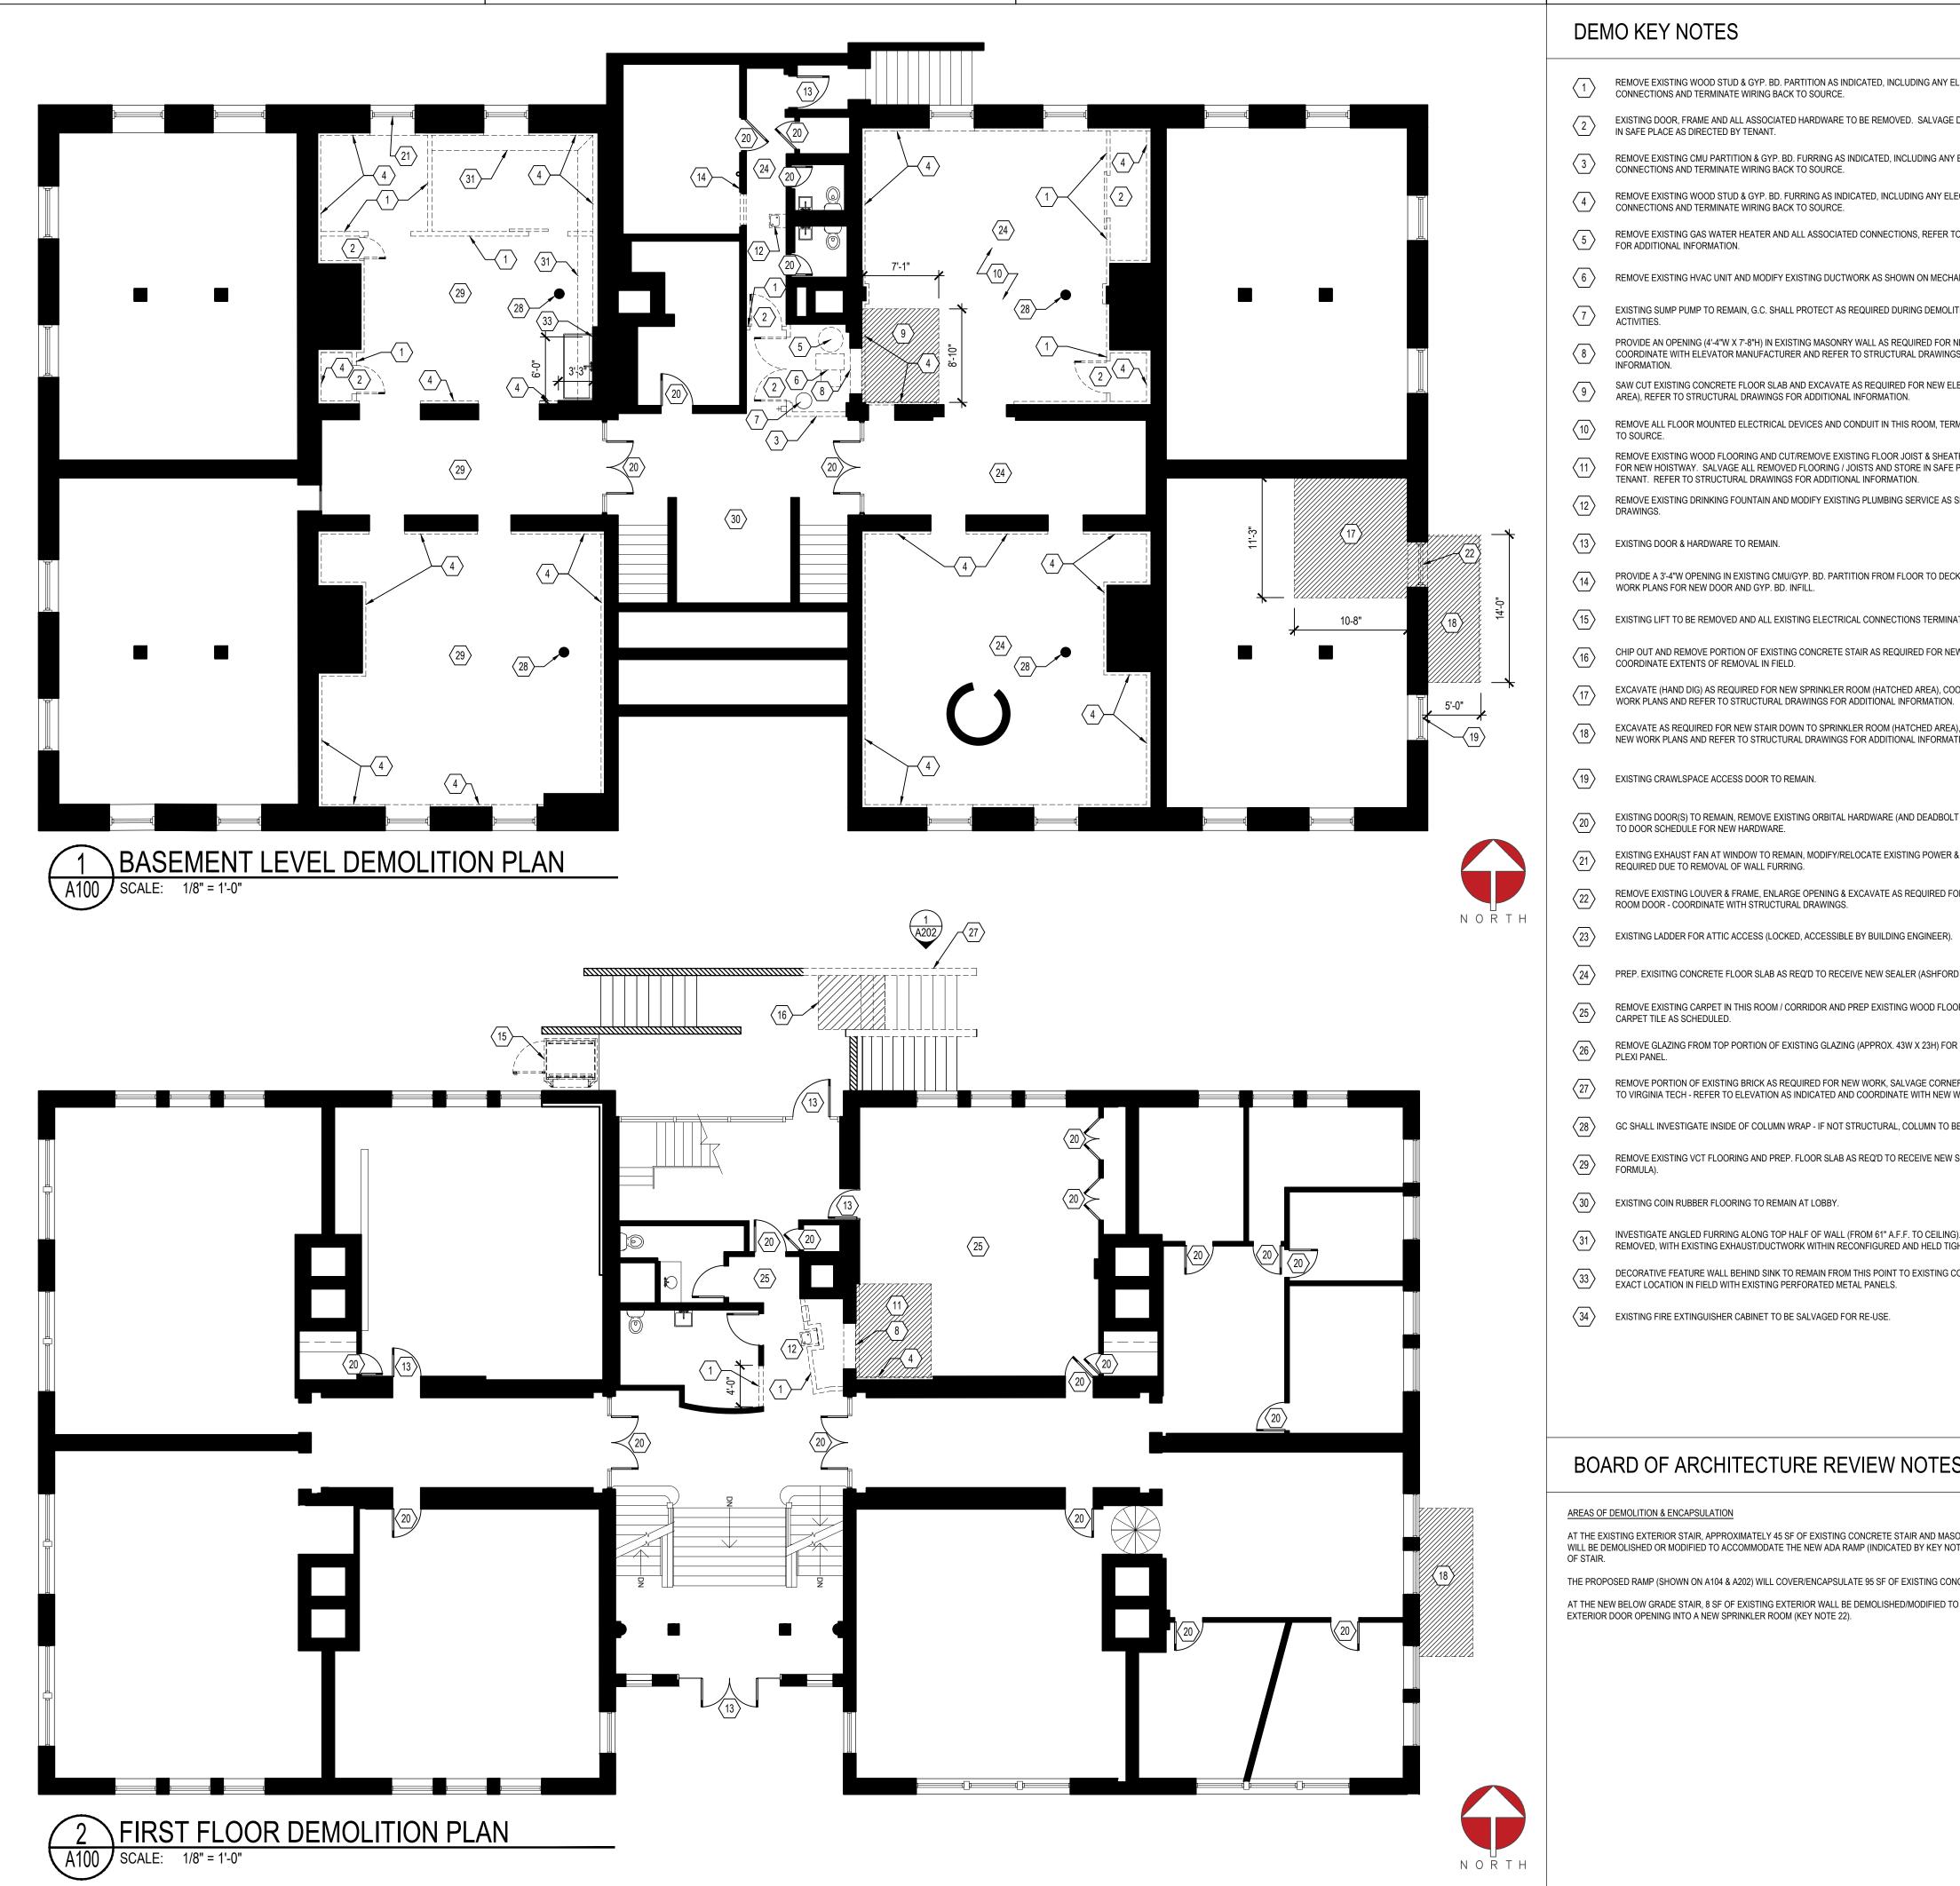


3

5



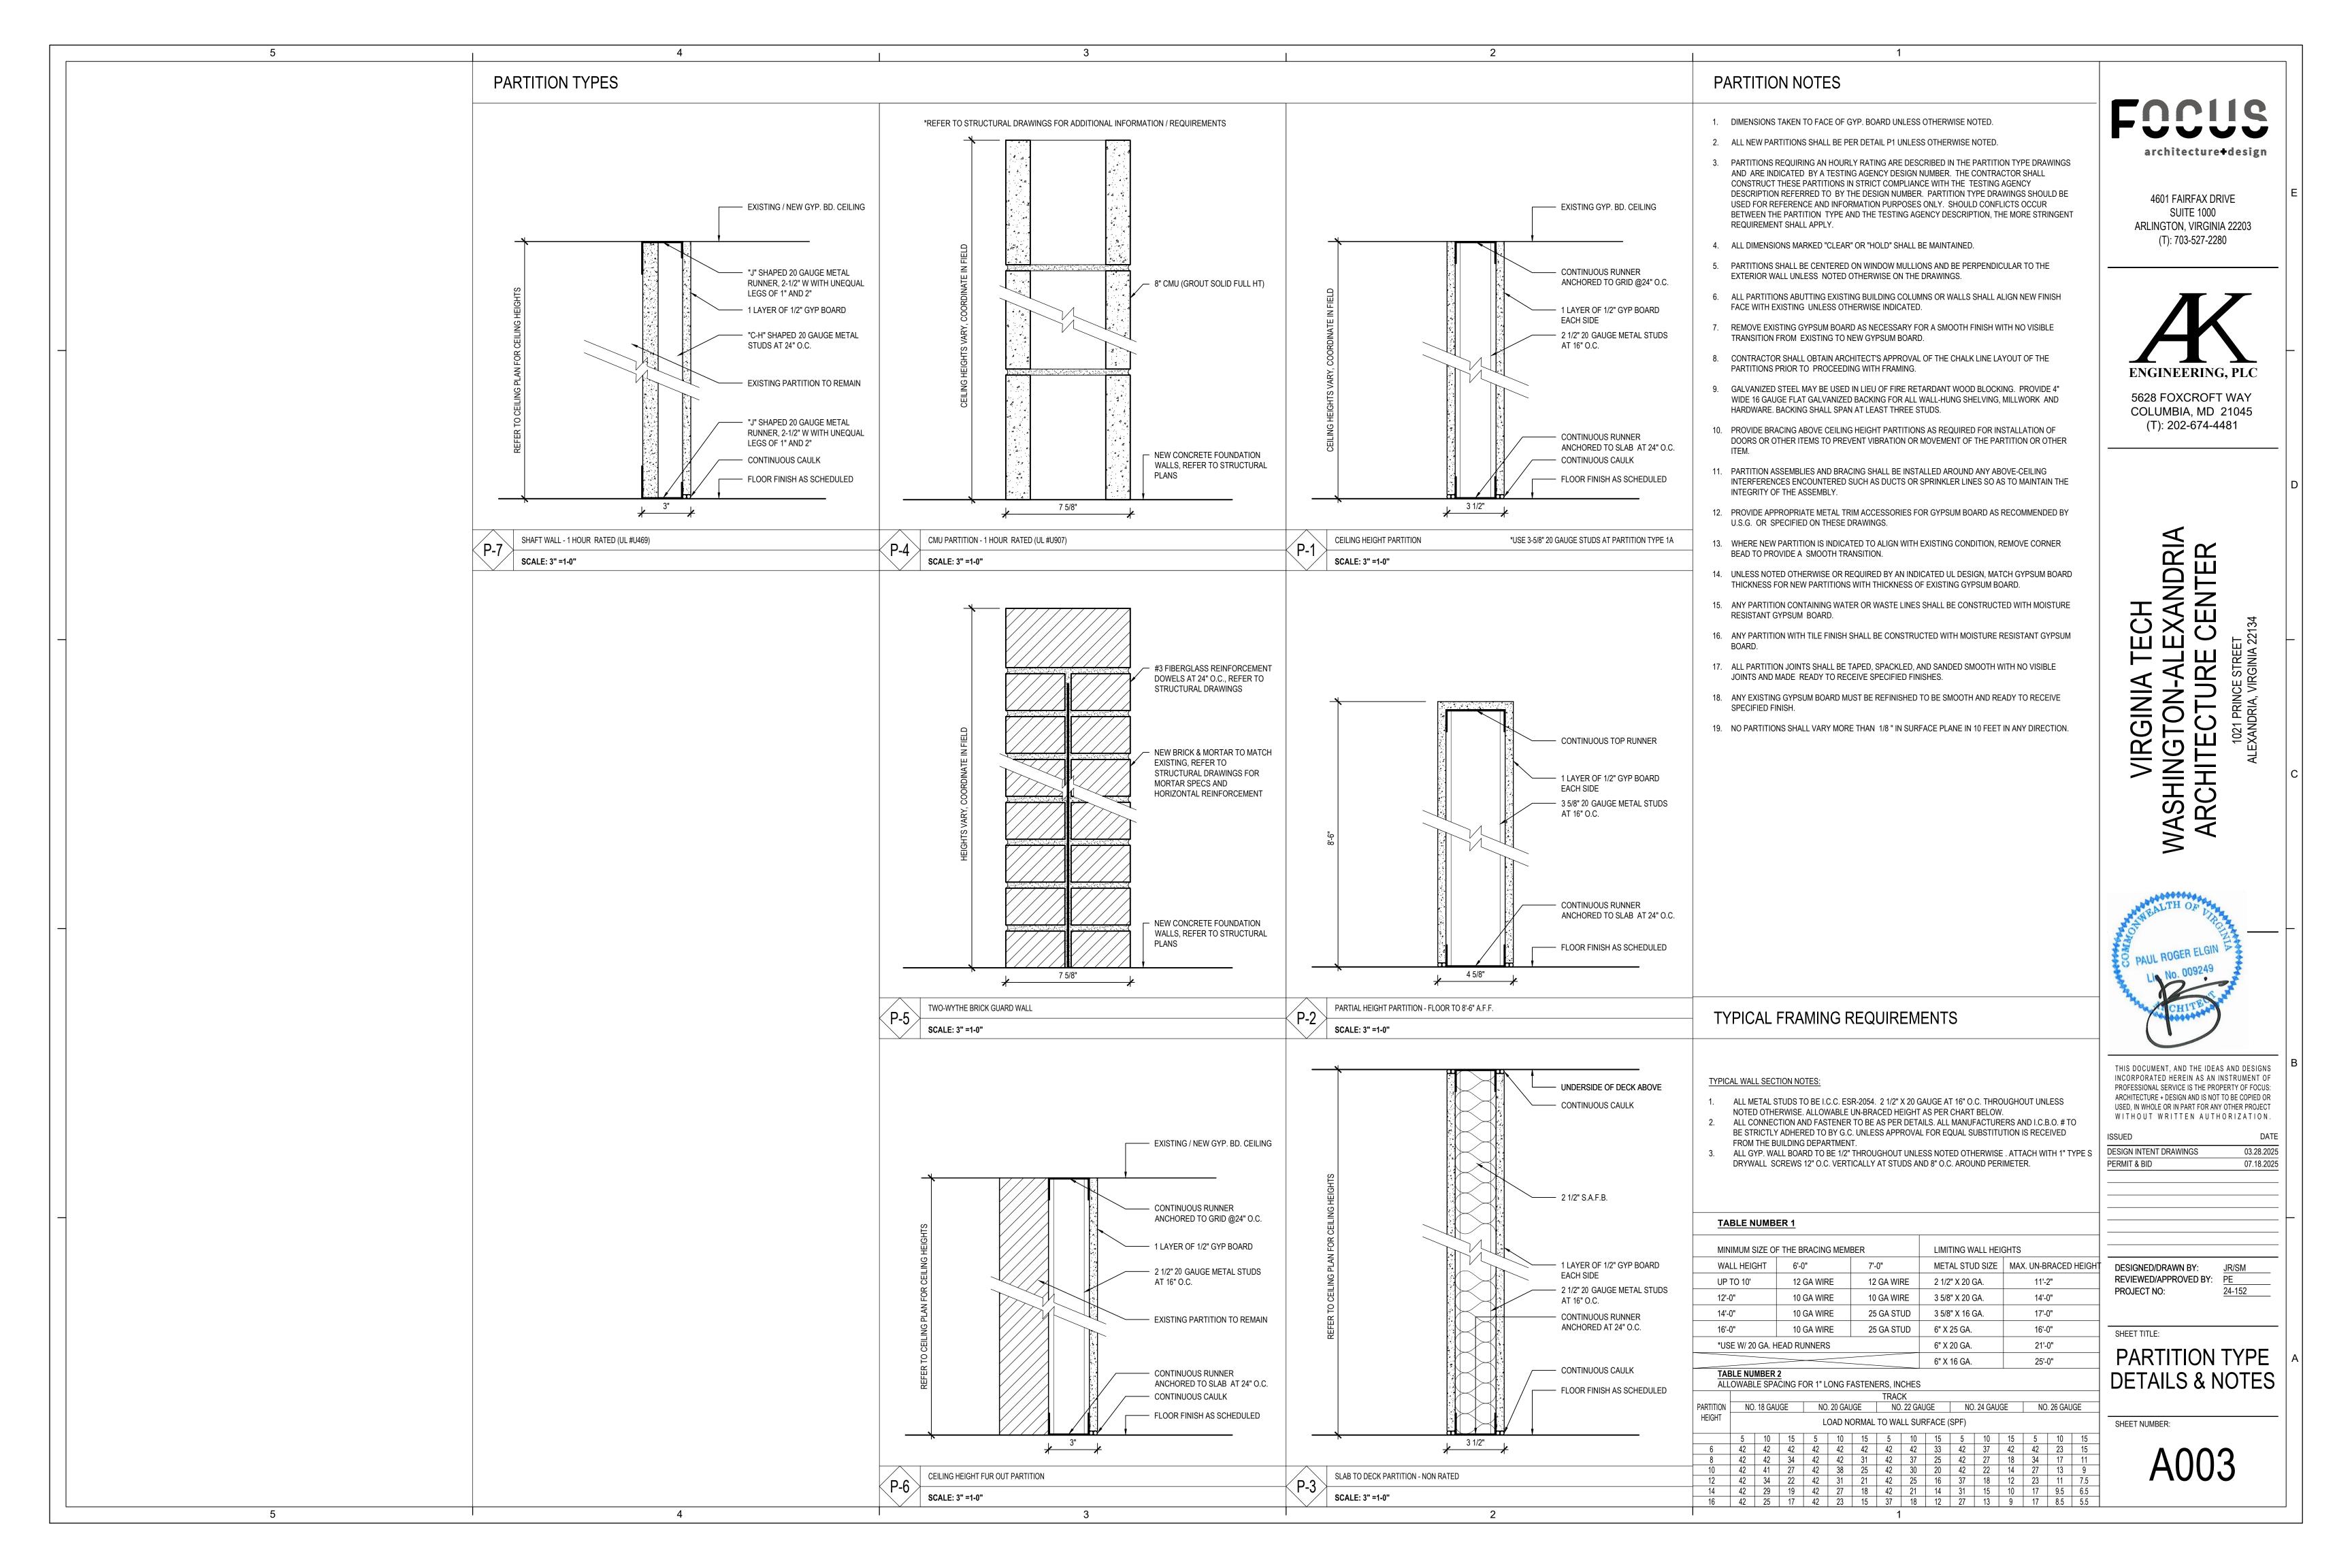

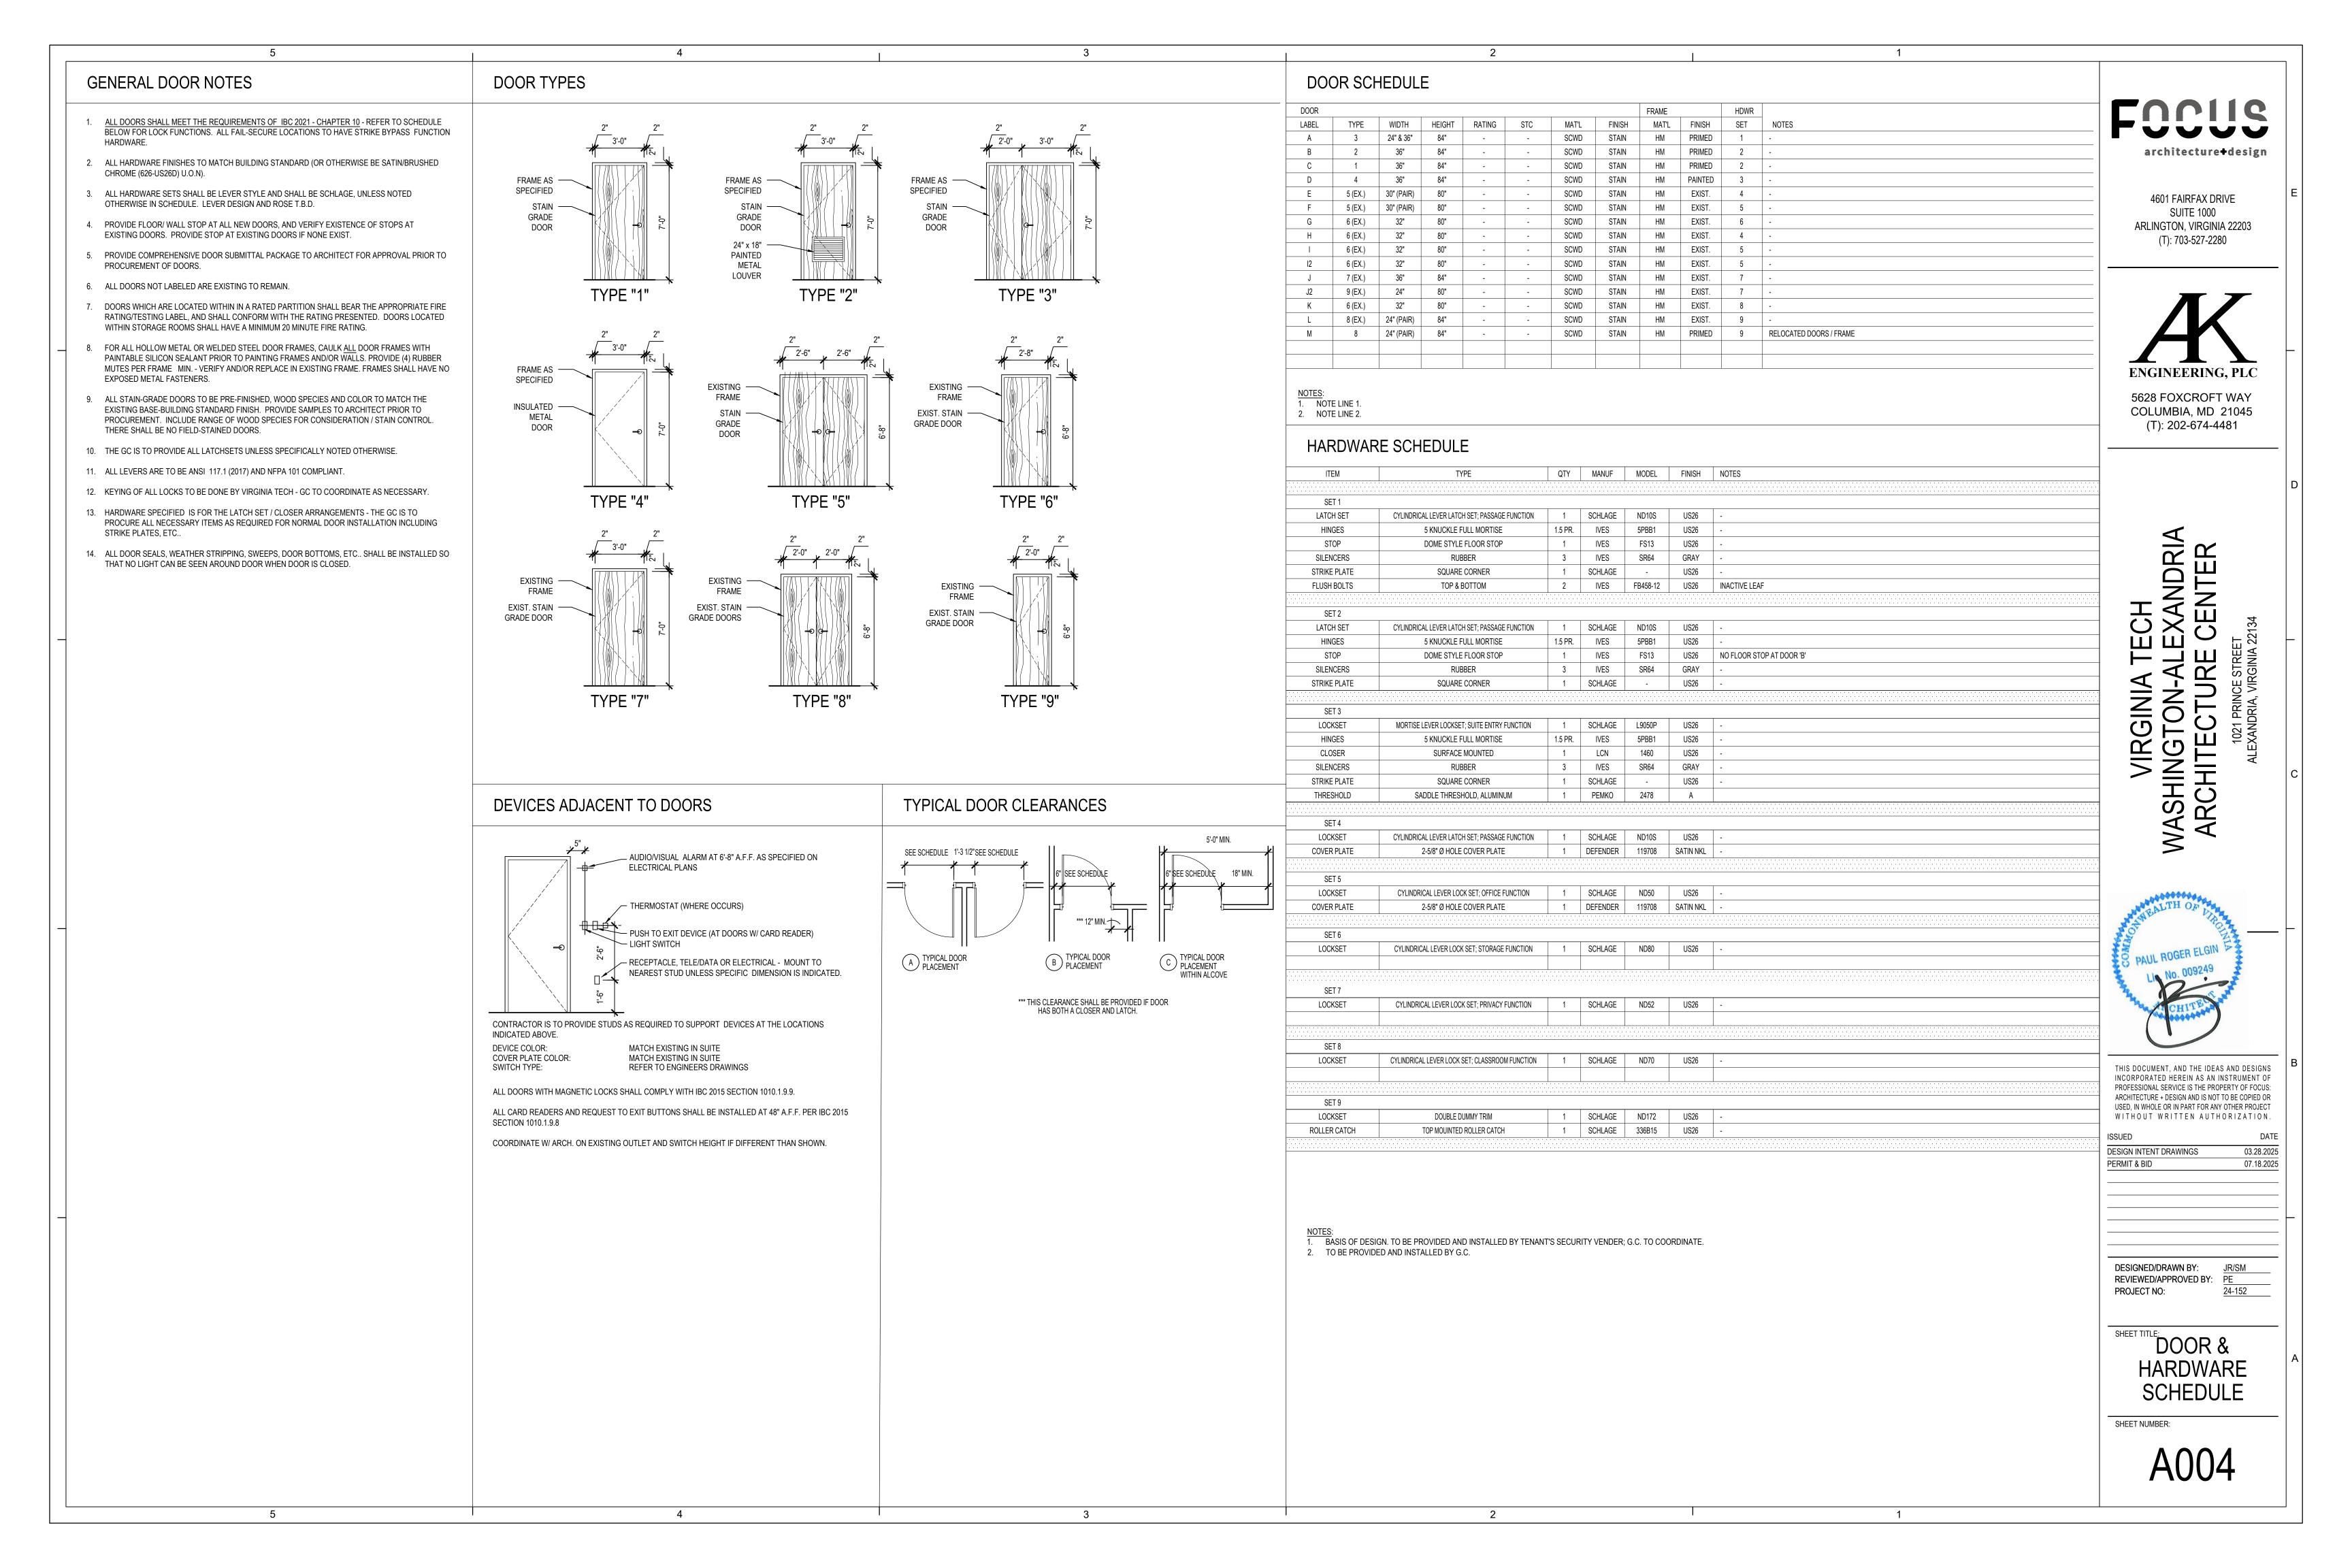

# **DEMO KEY NOTES**

- REMOVE EXISTING WOOD STUD & GYP. BD. PARTITION AS INDICATED, INCLUDING ANY ELECTRICAL CONNECTIONS AND TERMINATE WIRING BACK TO SOURCE.
- EXISTING DOOR, FRAME AND ALL ASSOCIATED HARDWARE TO BE REMOVED. SALVAGE DOOR LEAF AND STORE IN SAFE PLACE AS DIRECTED BY TENANT.
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- REMOVE EXISTING HVAC UNIT AND MODIFY EXISTING DUCTWORK AS SHOWN ON MECHANIAL DRAWINGS.
- EXISTING SUMP PUMP TO REMAIN, G.C. SHALL PROTECT AS REQUIRED DURING DEMOLITION & CONSTRUCTION
- PROVIDE AN OPENING (4'-4"W X 7'-8"H) IN EXISTING MASONRY WALL AS REQUIRED FOR NEW ELEVATOR ENTRY, COORDINATE WITH ELEVATOR MANUFACTURER AND REFER TO STRUCTURAL DRAWINGS FOR ADDITIONAL
- SAW CUT EXISTING CONCRETE FLOOR SLAB AND EXCAVATE AS REQUIRED FOR NEW ELEVATOR PIT (HATCHED
- REMOVE ALL FLOOR MOUNTED ELECTRICAL DEVICES AND CONDUIT IN THIS ROOM, TERMINATE WIRING BACK
- REMOVE EXISTING WOOD FLOORING AND CUT/REMOVE EXISTING FLOOR JOIST & SHEATHING AS REQUIRED FOR NEW HOISTWAY. SALVAGE ALL REMOVED FLOORING / JOISTS AND STORE IN SAFE PLACE AS DIRECTED BY TENANT. REFER TO STRUCTURAL DRAWINGS FOR ADDITIONAL INFORMATION.
- REMOVE EXISTING DRINKING FOUNTAIN AND MODIFY EXISTING PLUMBING SERVICE AS SHOWN ON PLUMBING
- EXISTING DOOR & HARDWARE TO REMAIN.
- PROVIDE A 3'-4"W OPENING IN EXISTING CMU/GYP. BD. PARTITION FROM FLOOR TO DECK. REFER TO NEW WORK PLANS FOR NEW DOOR AND GYP. BD. INFILL.
- EXISTING LIFT TO BE REMOVED AND ALL EXISTING ELECTRICAL CONNECTIONS TERMINATED BACK TO SOURCE.
- CHIP OUT AND REMOVE PORTION OF EXISTING CONCRETE STAIR AS REQUIRED FOR NEW RAMP DESIGN, COORDINATE EXTENTS OF REMOVAL IN FIELD.
- EXCAVATE (HAND DIG) AS REQUIRED FOR NEW SPRINKLER ROOM (HATCHED AREA), COORDINATE WITH NEW
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- EXISTING CRAWLSPACE ACCESS DOOR TO REMAIN.
- EXISTING DOOR(S) TO REMAIN, REMOVE EXISTING ORBITAL HARDWARE (AND DEADBOLT IF EXISTING). REFER TO DOOR SCHEDULE FOR NEW HARDWARE.
- EXISTING EXHAUST FAN AT WINDOW TO REMAIN, MODIFY/RELOCATE EXISTING POWER & CONTROL SWITCH AS REQUIRED DUE TO REMOVAL OF WALL FURRING.
- REMOVE EXISTING LOUVER & FRAME, ENLARGE OPENING & EXCAVATE AS REQUIRED FOR NEW SPRINKLER ROOM DOOR - COORDINATE WITH STRUCTURAL DRAWINGS.
- EXISTING LADDER FOR ATTIC ACCESS (LOCKED, ACCESSIBLE BY BUILDING ENGINEER).
- PREP. EXISITNG CONCRETE FLOOR SLAB AS REQ'D TO RECEIVE NEW SEALER (ASHFORD FORMULA).
- REMOVE EXISTING CARPET IN THIS ROOM / CORRIDOR AND PREP EXISTING WOOD FLOOR TO RECEIVE NEW
- REMOVE GLAZING FROM TOP PORTION OF EXISTING GLAZING (APPROX. 43W X 23H) FOR INSTALLATION OF NEW
- REMOVE PORTION OF EXISTING BRICK AS REQUIRED FOR NEW WORK, SALVAGE CORNER STONE AND RETURN TO VIRGINIA TECH - REFER TO ELEVATION AS INDICATED AND COORDINATE WITH NEW WORK PLANS.
- GC SHALL INVESTIGATE INSIDE OF COLUMN WRAP IF NOT STRUCTURAL, COLUMN TO BE REMOVED.
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- INVESTIGATE ANGLED FURRING ALONG TOP HALF OF WALL (FROM 61" A.F.F. TO CEILING). FURRING TO BE REMOVED, WITH EXISTING EXHAUST/DUCTWORK WITHIN RECONFIGURED AND HELD TIGHT TO CEILING.
- DECORATIVE FEATURE WALL BEHIND SINK TO REMAIN FROM THIS POINT TO EXISTING CORNER. COORDINATE EXACT LOCATION IN FIELD WITH EXISTING PERFORATED METAL PANELS.
- EXISTING FIRE EXTINGUISHER CABINET TO BE SALVAGED FOR RE-USE.

# BOARD OF ARCHITECTURE REVIEW NOTES

AREAS OF DEMOLITION & ENCAPSULATION

AT THE EXISTING EXTERIOR STAIR, APPROXIMATELY 45 SF OF EXISTING CONCRETE STAIR AND MASONRY GUARD WALLS WILL BE DEMOLISHED OR MODIFIED TO ACCOMMODATE THE NEW ADA RAMP (INDICATED BY KEY NOTES 16 & 27). THIS AREA

THE PROPOSED RAMP (SHOWN ON A104 & A202) WILL COVER/ENCAPSULATE 95 SF OF EXISTING CONCRETE STAIR. AT THE NEW BELOW GRADE STAIR, 8 SF OF EXISTING EXTERIOR WALL BE DEMOLISHED/MODIFIED TO CREATE THE NEW EXTERIOR DOOR OPENING INTO A NEW SPRINKLER ROOM (KEY NOTE 22).

# SYMBOLS LEGEND

EXISTING WALL TO REMAIN.





EXISTING DOOR TO BE REMOVED




EXISTING FIRE ALARM PULL STATION TO BE REMOVED

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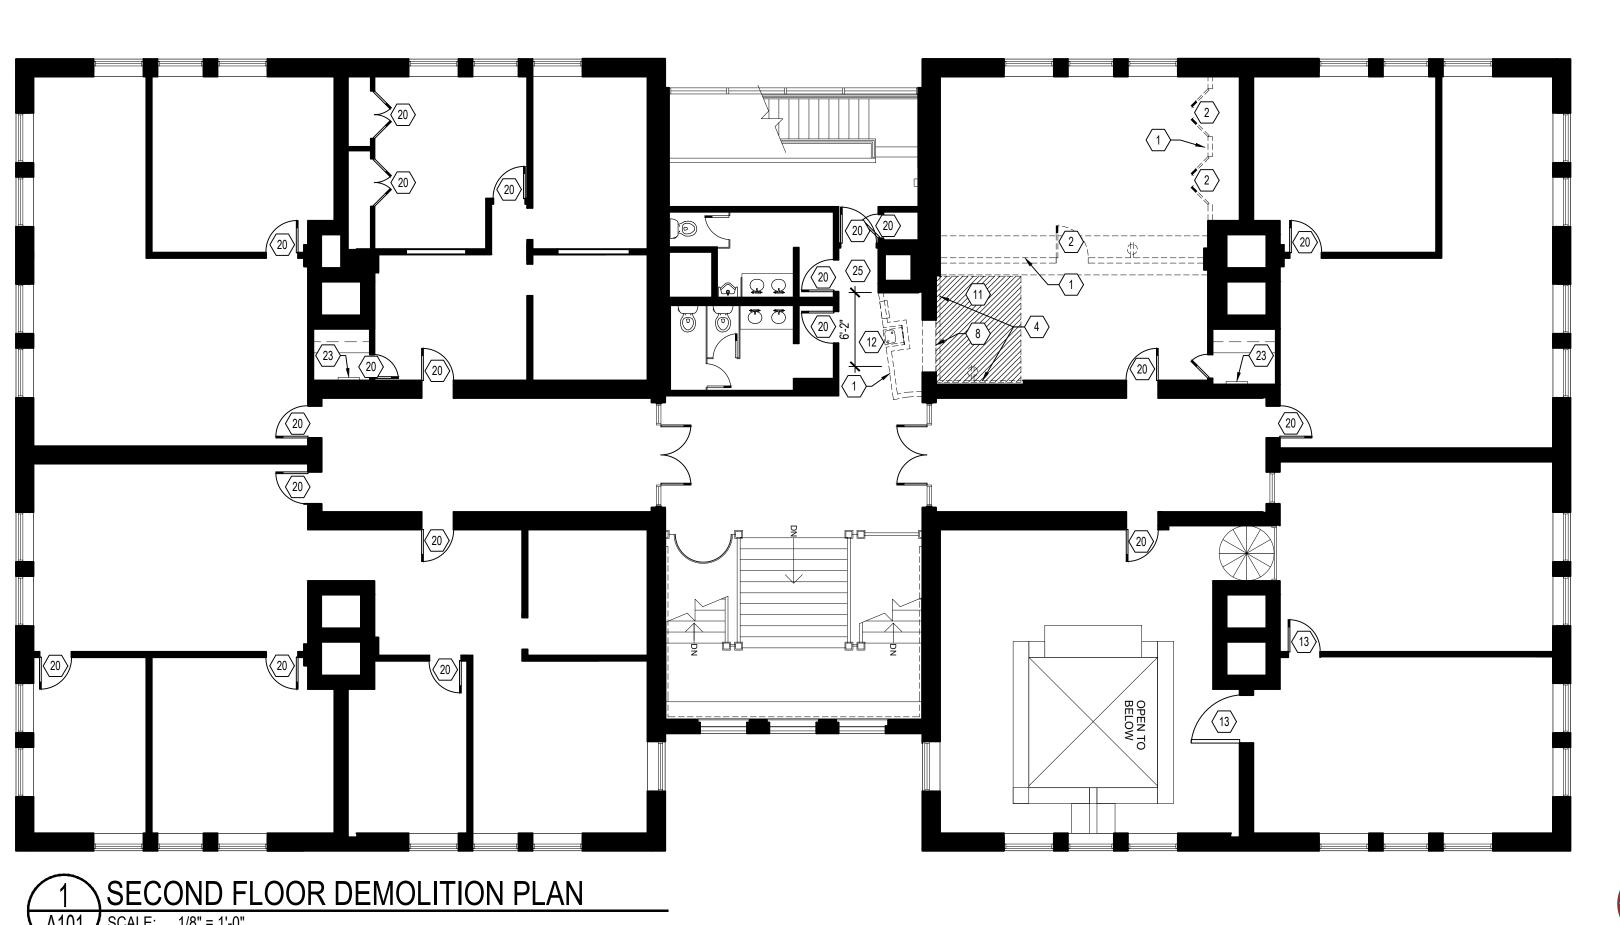
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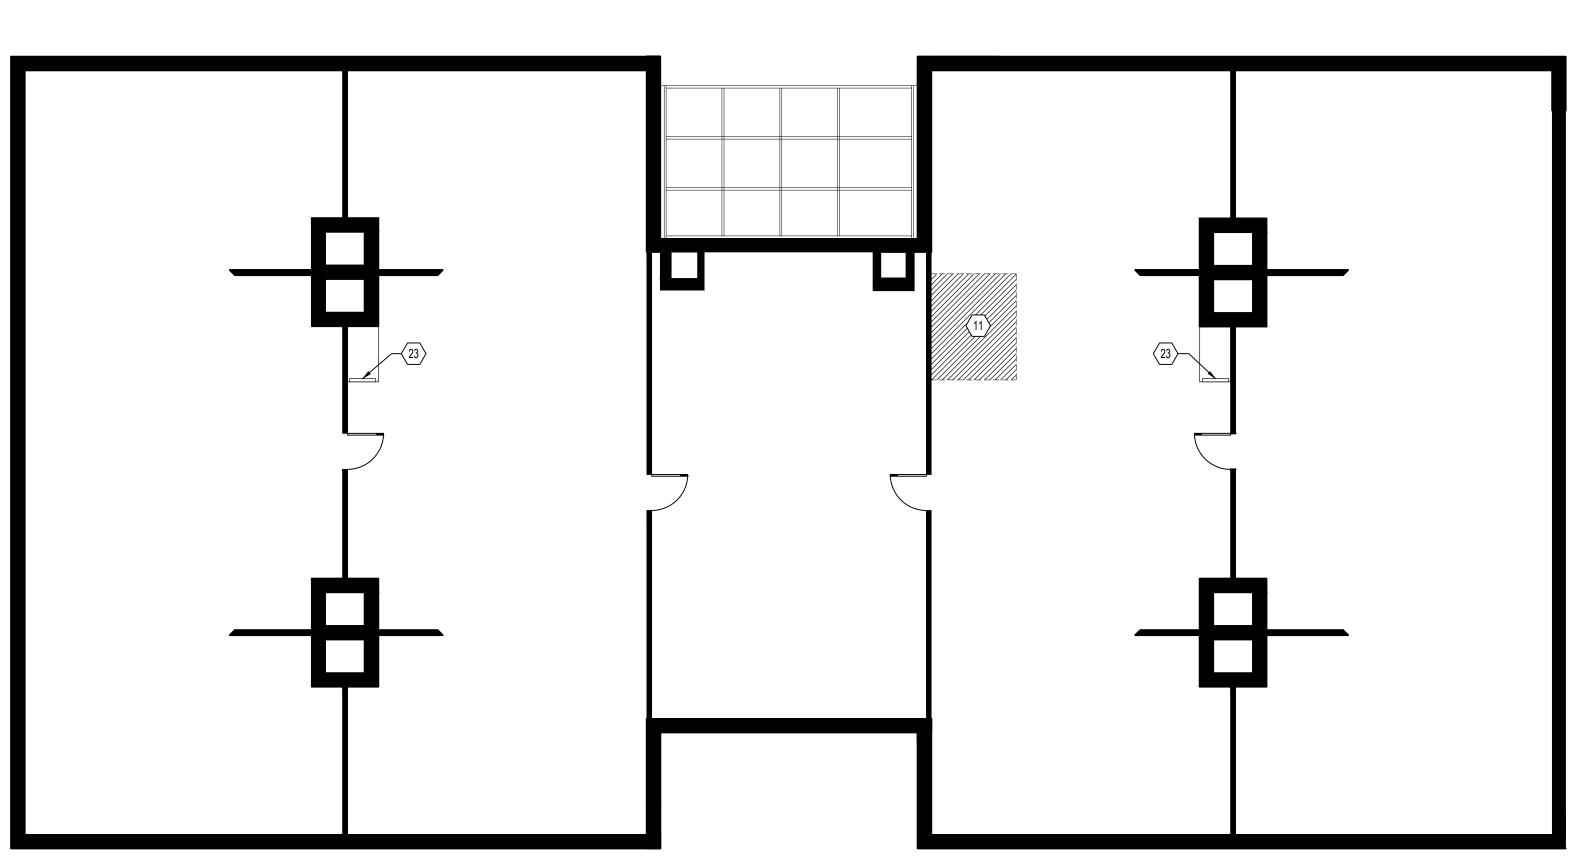
DESIGNED/DRAWN BY: REVIEWED/APPROVED BY: PE PROJECT NO:

**DEMOLITION BASEMENT &** 

FIRST FLOOR SHEET NUMBER:



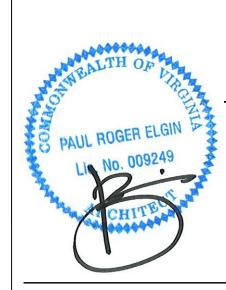



ATTIC DEMOLITION PLAN

5



# **DEMO KEY NOTES**

- REMOVE EXISTING WOOD STUD & GYP. BD. PARTITION AS INDICATED, INCLUDING ANY ELECTRICAL CONNECTIONS AND TERMINATE WIRING BACK TO SOURCE.
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- EXISTING FIRE EXTINGUISHER CABINET TO BE SALVAGED FOR RE-USE.

# SYMBOLS LEGEND

EXISTING WALL TO REMAIN.



EXISTING DOOR TO BE REMOVED

EXISTING FIRE ALARM PULL STATION TO BE REMOVED

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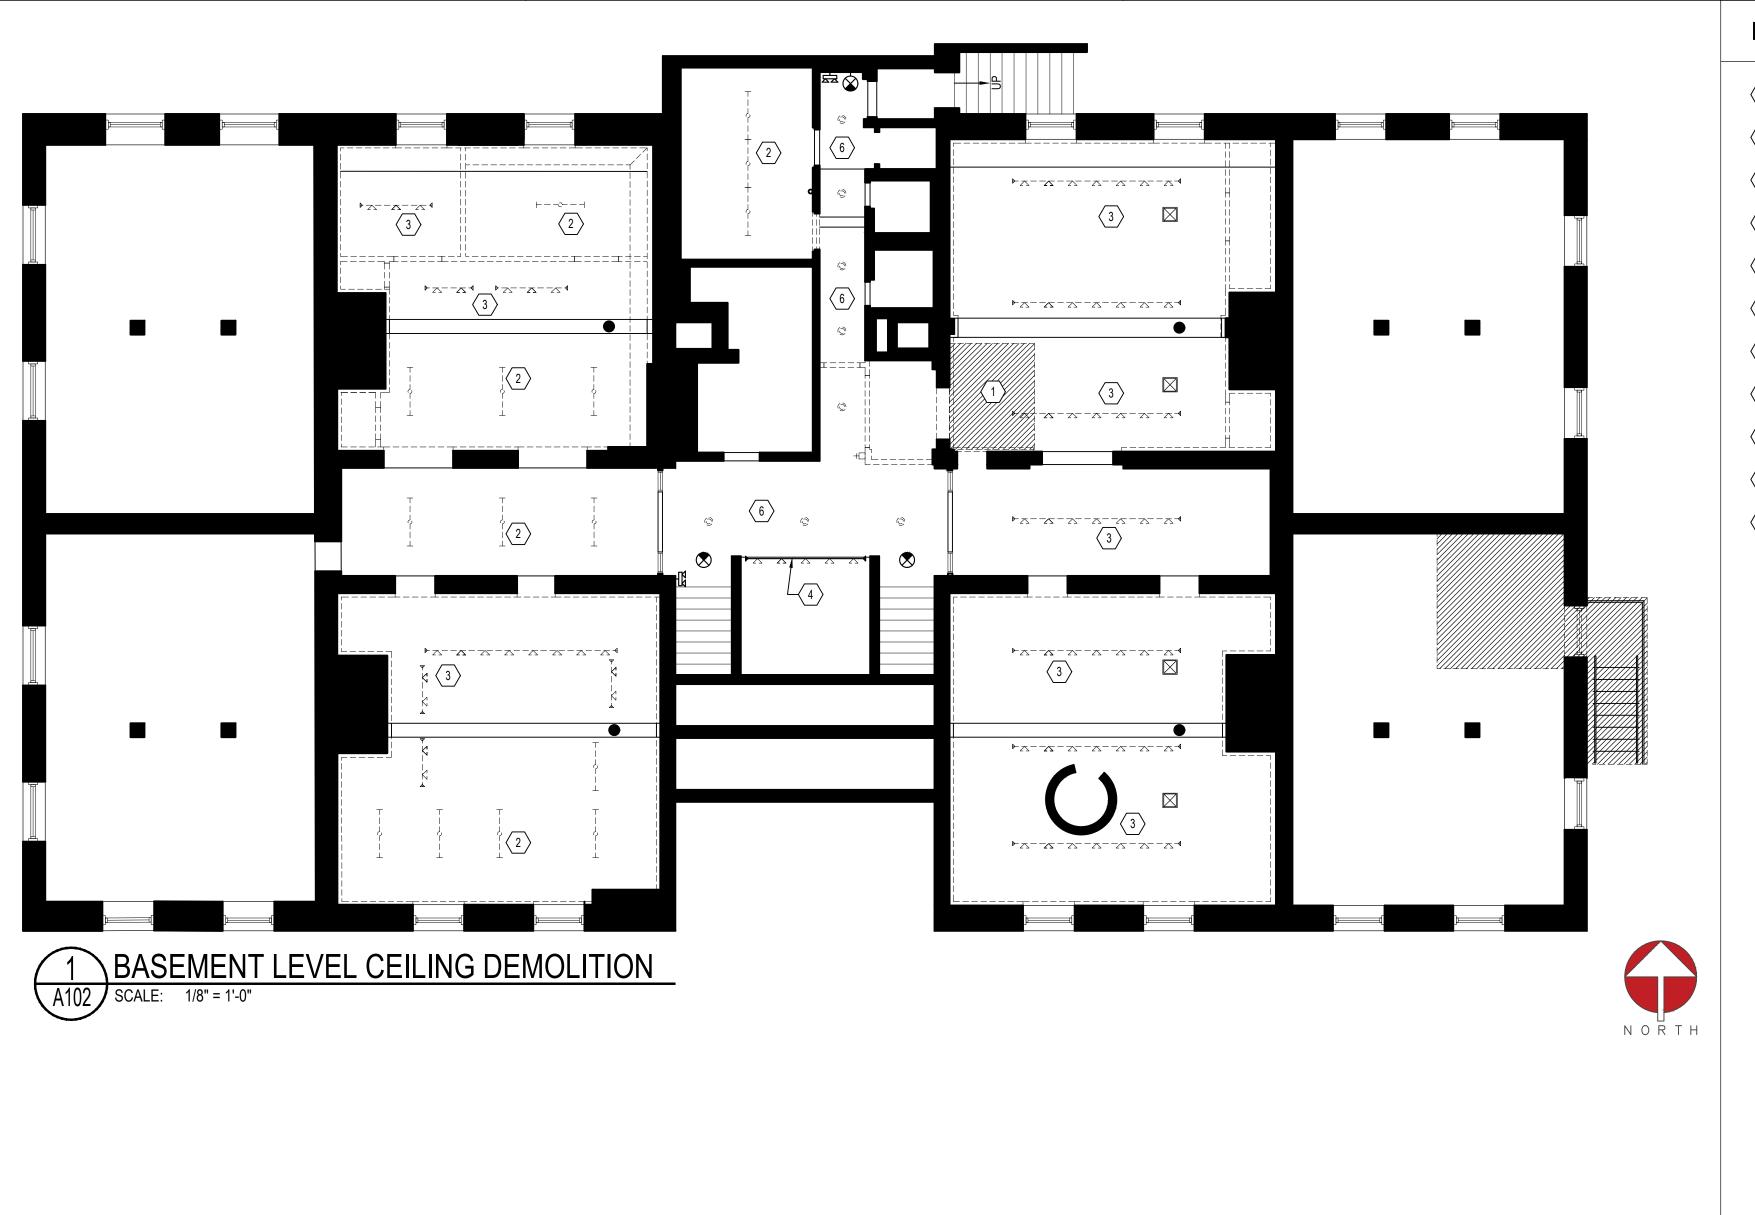
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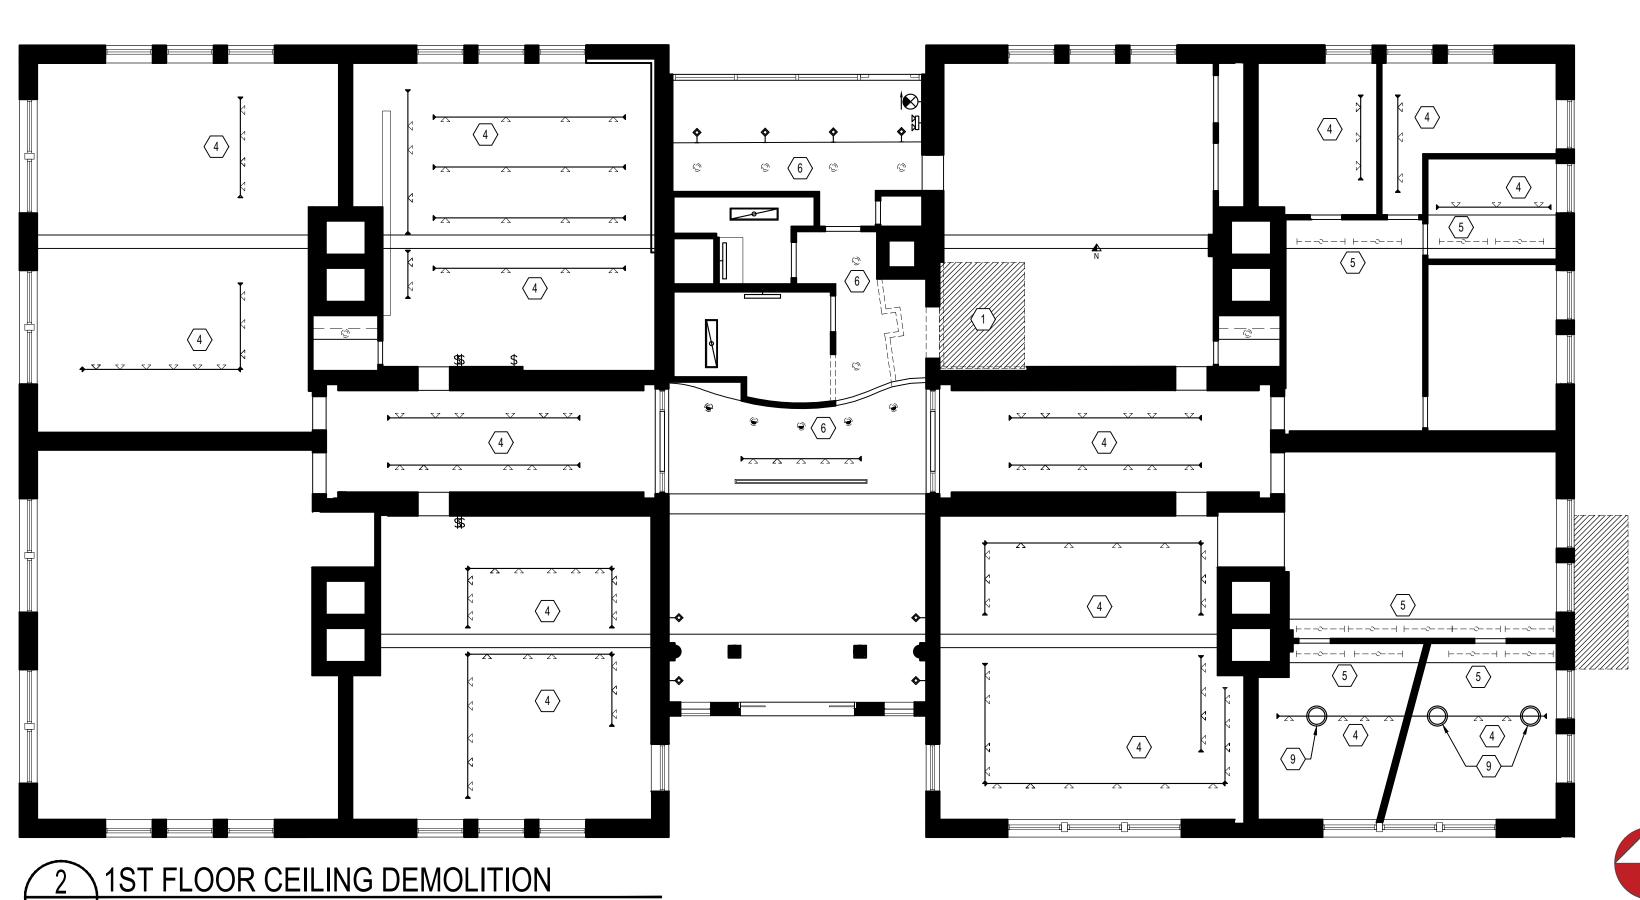
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DESIGNED/DRAWN BY:

REVIEWED/APPROVED BY: PE PROJECT NO:

DEMOLITION SECOND FLOOR & ATTIC





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# **DEMO KEY NOTES**

- REMOVE PORTION OF EXISTING DRYWALL CEILING AS REQUIRED TO CONSTRUCT NEW HOISTWAY, COORDINATE EXTENTS OF REMOVAL WITH NEW WORK PLANS.
- REMOVE ALL EXISTING SURFACE MOUNTED FLUORESCENT LIGHT FIXTURE AS SHOWN, REFER TO ELECTRICAL DRAWINGS FOR ADDITIONAL INFORMATION.

2

- REMOVE EXISTING TRACK LIGHTING AS SHOWN (TYPICAL THROUGHOUT BASEMENT LEVEL, U.O.N.), REFER TO ELECTRICAL DRAWINGS FOR ADDITIONAL INFORMATION .
- REMOVE EXISTING TRACK HEADS AS SHOWN, EXISTING TRACK TO REMAIN FOR RE-USE. REFER TO ELECTRICAL DRAWINGS FOR ADDITIONAL INFORMATION (TYPICAL THROUGH FIRST AND SECOND FLOORS).
- REMOVE ALL EXISTING LIGHT FIXTURES ABOVE BULKHEAD AS SHOWN, EXISTING CIRCUITING TO REMAIN FOR
- REMOVE ALL EXISTING RECESSED DOWNLIGHTS AS SHOWN, EXISTING CIRCUITING TO REMAIN FOR REUSE,
- REFER TO ELECTRICAL DRAWINGS FOR ADDITIONAL INFORMATION.

REMOVE EXISTING PERIMETER COVE LIGHTING, EXISTING CIRCUIT TO REMAIN FOR RE-USE.

- EXISTING PENDANT FIXTURES TO REMAIN.
- EXISTING TRACK MOUNTED PENDANT TO REMAIN.
- REMOVE EXISTING BULKHEAD & ASSOCIATED LIGHT FIXTURES AT THIS ROOM ONLY.

REUSE, REFER TO ELECTRICAL DRAWINGS FOR ADDITIONAL INFORMATION.

EXISTING CURVED BULKHEAD TO REMAIN.

# SYMBOLS LEGEND

EXISTING WALL TO REMAIN.

□□□□□□ EXISTING CONSTRUCTION TO BE REMOVED.

 $\vdash - \multimap - \lnot$  EXISTING SURFACE MOUNTED FLUORESCENT FIXTURE TO BE REMOVED

EXISTING RECESSED DOWNLIGHT TO BE REMOVED

EXISTING RECESSED WALL WASHER TO BE REMOVED

► ZZ - ZZ - ZZ 4 EXISTING TRACK LIGHTING TO BE REMOVED

EXISTING TRACK TO REMAIN, HEADS TO BE REMOVED

**EXISTING PERIMETER COVE LIGHTING TO BE REMOVED** 

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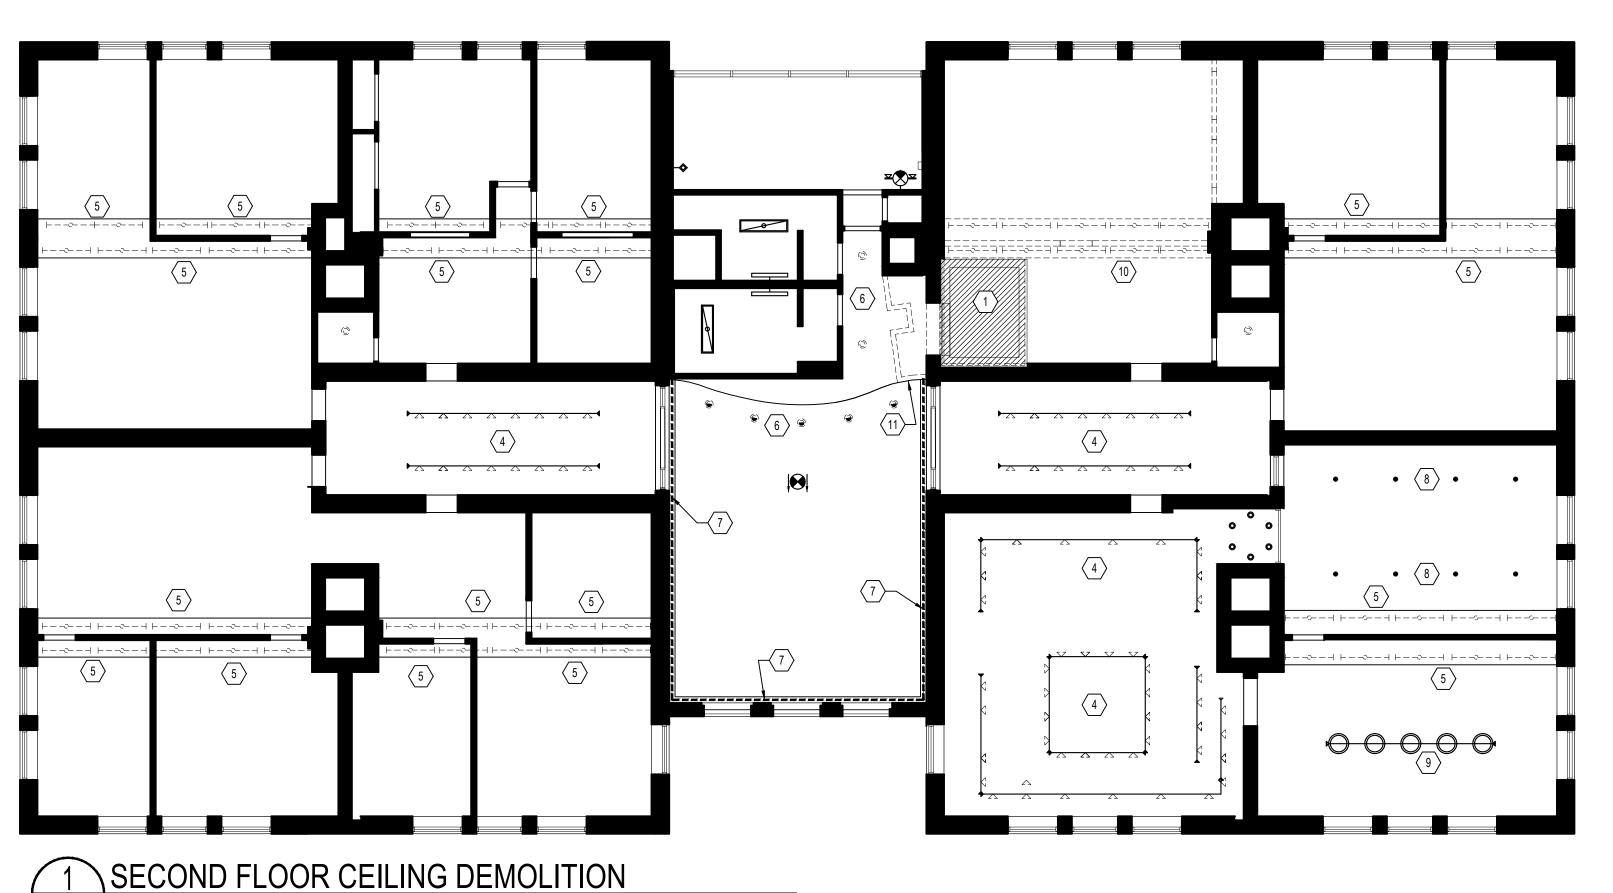
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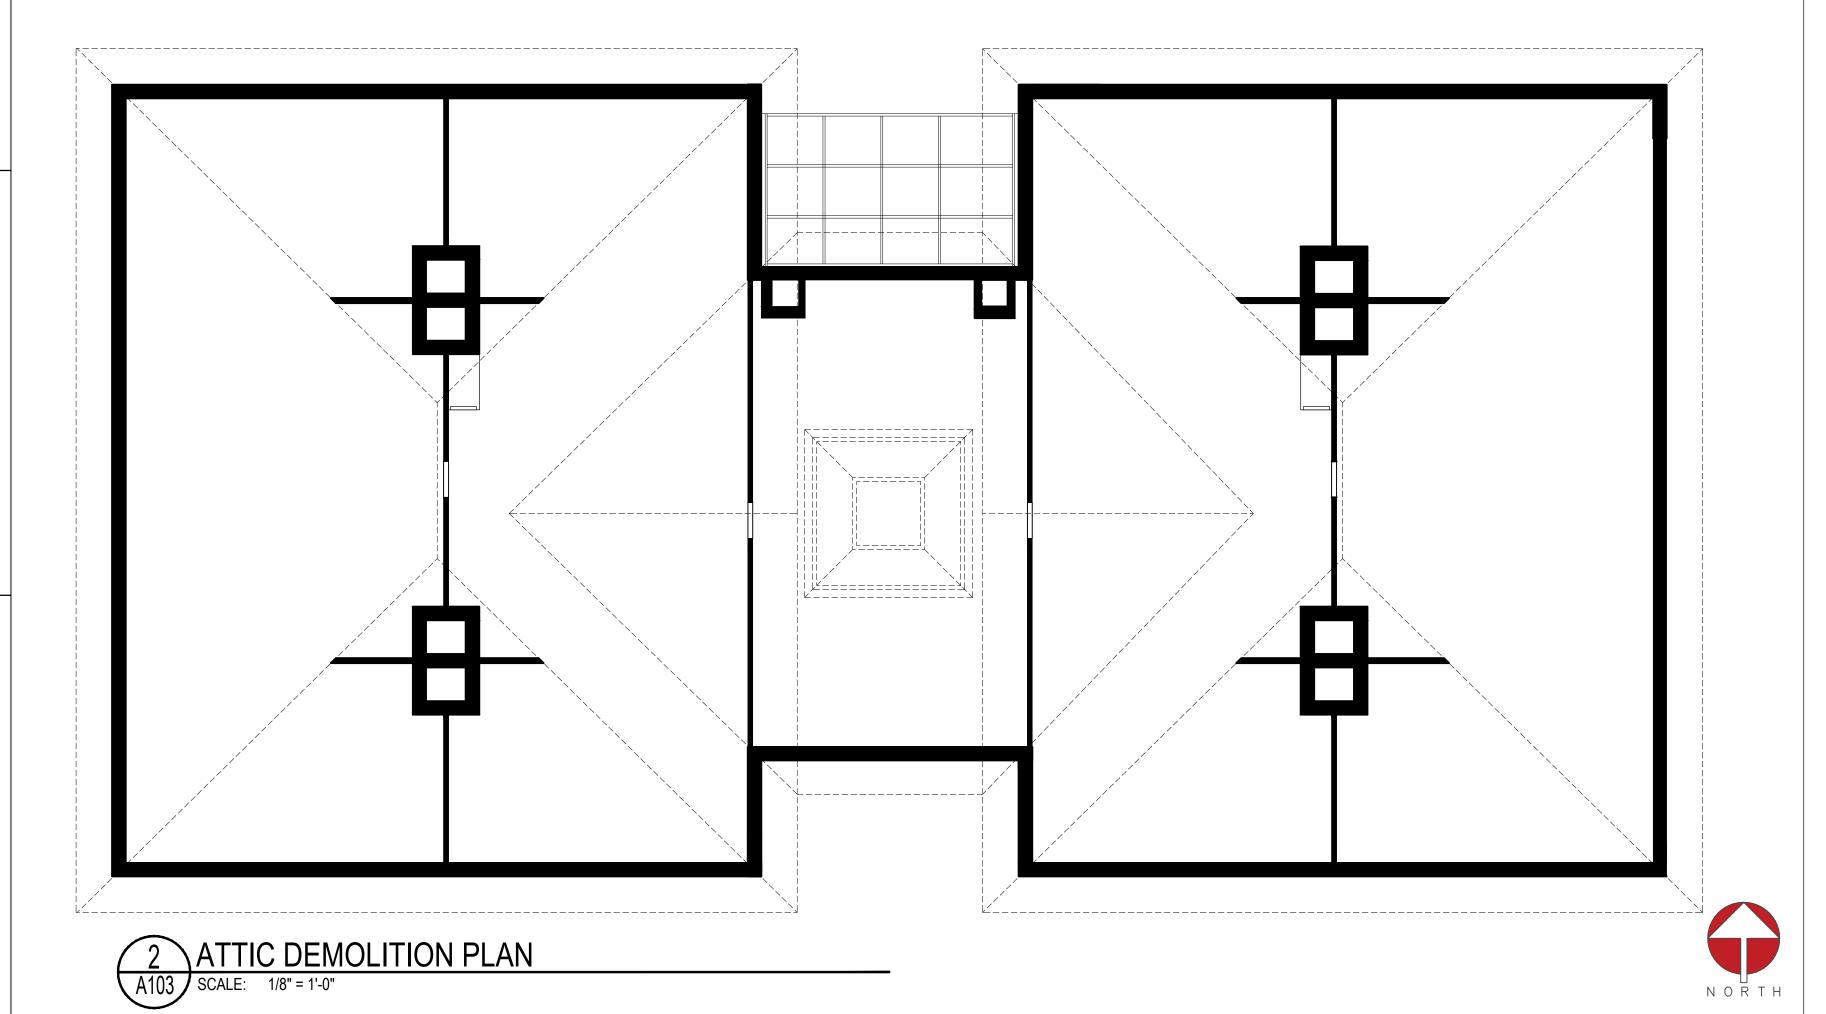
SHEET TITLE: CEILING DEMO.

BASEMENT & FIRST FLOOR

SHEET NUMBER:







5

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- REMOVE EXISTING BULKHEAD & ASSOCIATED LIGHT FIXTURES AT THIS ROOM ONLY.
- EXISTING CURVED BULKHEAD TO REMAIN.

# SYMBOLS LEGEND

EXISTING WALL TO REMAIN.

EXISTING SURFACE MOUNTED 1X4 FIXTURE TO REMAIN

EXISTING VANITY FIXTURE TO REMAIN

 $\vdash - \neg \neg \neg \neg$  EXISTING SURFACE MOUNTED FLUORESCENT FIXTURE TO BE REMOVED

EXISTING RECESSED DOWNLIGHT TO REMAIN

EXISTING RECESSED DOWNLIGHT TO BE REMOVED

EXISTING RECESSED WALL WASHER TO BE REMOVED

► ZZ - ZZ - ZZ • EXISTING TRACK LIGHTING TO BE REMOVED

EXISTING TRACK TO REMAIN, HEADS TO BE REMOVED

EXISTING TRACK AND PENDANTS TO REMAIN **EXISTING PERIMETER COVE LIGHTING TO BE REMOVED** 

EXISTING WALL SCONCE TO REMAIN

EXISTING PENDANT FIXTURE TO REMAIN

EXISTING EXIT LIGHT TO REMAIN

EXISTING EXIT LIGHT WITH EMERGENCY LIGHT TO REMAIN

EXISTING EMERGENCY LIGHT WITH BATTER PACK TO REMAIN

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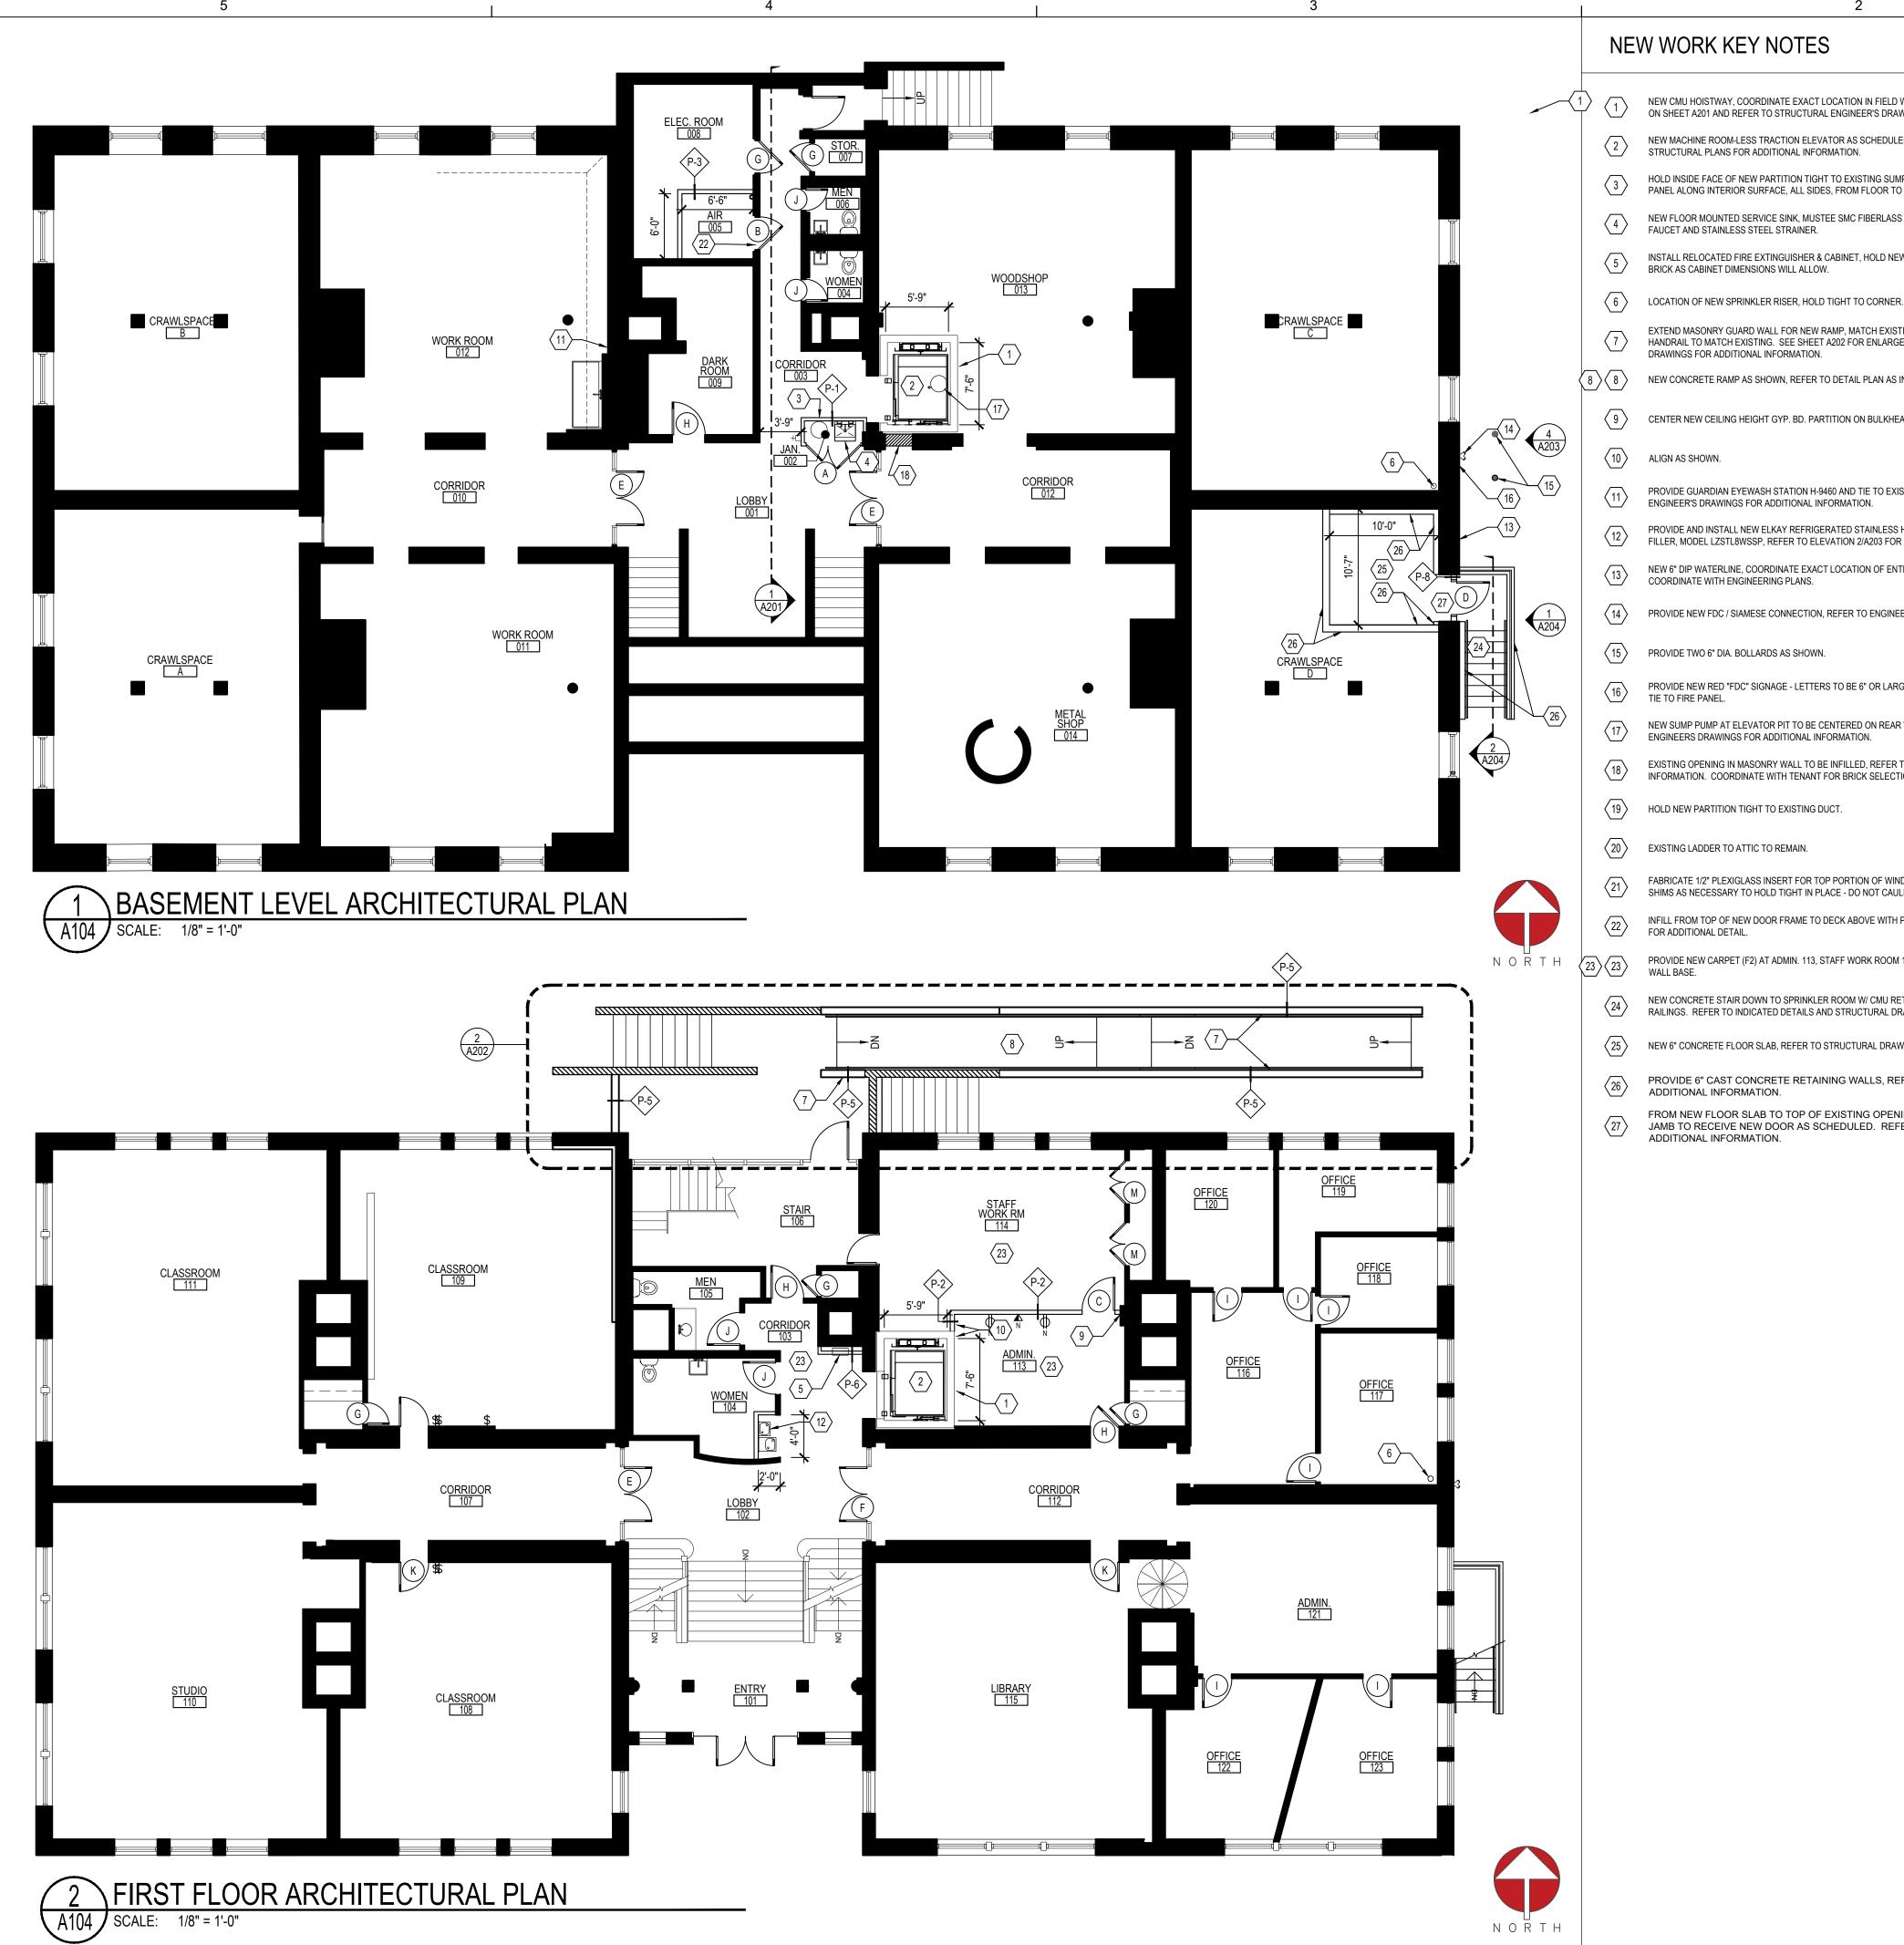


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DESIGNED/DRAWN BY: REVIEWED/APPROVED BY: PE PROJECT NO:

SHEET TITLE:
CEILING DEMO. SECOND FLOOR & ATTIC




# NEW WORK KEY NOTES

- NEW CMU HOISTWAY, COORDINATE EXACT LOCATION IN FIELD WITH EXISTING MASONRY WALLS. SEE DETAILS ON SHEET A201 AND REFER TO STRUCTURAL ENGINEER'S DRAWINGS FOR ADDITIONAL INFORMATION.
- NEW MACHINE ROOM-LESS TRACTION ELEVATOR AS SCHEDULED, SEE SHEET A201 AND REFER TO STRUCTURAL PLANS FOR ADDITIONAL INFORMATION.
- HOLD INSIDE FACE OF NEW PARTITION TIGHT TO EXISTING SUMP PUMP AS SHOWN, PROVIDE ACROVYN WALL PANEL ALONG INTERIOR SURFACE, ALL SIDES, FROM FLOOR TO 4'-0" AFF.
- NEW FLOOR MOUNTED SERVICE SINK, MUSTEE SMC FIBERLASS MODEL 63CM, INCLUDES DUAL HANDLE
- INSTALL RELOCATED FIRE EXTINGUISHER & CABINET, HOLD NEW FURRING PARTITION AS TIGHT TO EXISTING
- EXTEND MASONRY GUARD WALL FOR NEW RAMP, MATCH EXISTING BRICK. PROVIDE 121 Ø PAINTED STEEL HANDRAIL TO MATCH EXISTING. SEE SHEET A202 FOR ENLARGED PLAN AND DETAILS, REFER TO STRUCTURAL
- NEW CONCRETE RAMP AS SHOWN, REFER TO DETAIL PLAN AS INDICATED FOR ADDITIONAL INFO.
- CENTER NEW CEILING HEIGHT GYP. BD. PARTITION ON BULKHEAD ABOVE.
- ALIGN AS SHOWN.
- PROVIDE GUARDIAN EYEWASH STATION H-9460 AND TIE TO EXISTING PLUMBING SERVICE, REFER TO ENGINEER'S DRAWINGS FOR ADDITIONAL INFORMATION.
- PROVIDE AND INSTALL NEW ELKAY REFRIGERATED STAINLESS HIGH-LOW DRINKING FOUNTAIN WITH BOTTLE FILLER, MODEL LZSTL8WSSP, REFER TO ELEVATION 2/A203 FOR ADDITIONAL INFORMATION.
- NEW 6" DIP WATERLINE, COORDINATE EXACT LOCATION OF ENTRY POINT IN FIELD. SEE DETAIL 3/A203 AND COORDINATE WITH ENGINEERING PLANS.
- PROVIDE NEW FDC / SIAMESE CONNECTION, REFER TO ENGINEERS PLANS FOR ADDITIONAL INFORMATION.
- PROVIDE TWO 6" DIA. BOLLARDS AS SHOWN.
- PROVIDE NEW RED "FDC" SIGNAGE LETTERS TO BE 6" OR LARGER AND NEW STROBE LIGHT ABOVE FDC AND TIE TO FIRE PANEL.
- NEW SUMP PUMP AT ELEVATOR PIT TO BE CENTERED ON REAR WALL OF HOISTWAY AS SHOWN, REFER TO ENGINEERS DRAWINGS FOR ADDITIONAL INFORMATION.
- EXISTING OPENING IN MASONRY WALL TO BE INFILLED, REFER TO STRUCTURAL DRAWINGS FOR ADDITIONAL INFORMATION. COORDINATE WITH TENANT FOR BRICK SELECTION AT THIS LOCATION.
- HOLD NEW PARTITION TIGHT TO EXISTING DUCT.
- EXISTING LADDER TO ATTIC TO REMAIN.
- FABRICATE 1/2" PLEXIGLASS INSERT FOR TOP PORTION OF WINDOW (APPROX. 43"W X 23"H) AND PROVIDE SHIMS AS NECESSARY TO HOLD TIGHT IN PLACE - DO NOT CAULK, PLEXIGLASS MUST BE REMOVABLE.
- INFILL FROM TOP OF NEW DOOR FRAME TO DECK ABOVE WITH PARTITION TYPE 3, REFER TO ELEVATION 3/A203 FOR ADDITIONAL DETAIL.
- PROVIDE NEW CARPET (F2) AT ADMIN. 113, STAFF WORK ROOM 114, CORRIDOR 103, AND CORRIDOR 203. NO
- NEW CONCRETE STAIR DOWN TO SPRINKLER ROOM W/ CMU RETAINING WALL & PAINTED STEEL HAND/GUARD RAILINGS. REFER TO INDICATED DETAILS AND STRUCTURAL DRAWINGS FOR ADDITIONAL INFORMATION.
- NEW 6" CONCRETE FLOOR SLAB, REFER TO STRUCTURAL DRAWINGS FOR ADDITIONAL INFORMATION.
- PROVIDE 6" CAST CONCRETE RETAINING WALLS, REFER TO STRUCTURAL DRAWINGS FOR
- FROM NEW FLOOR SLAB TO TOP OF EXISTING OPENING, PROVIDE CAST CONCRETE DOOR JAMB TO RECEIVE NEW DOOR AS SCHEDULED. REFER TO STRUCTURAL DRAWINGS FOR

# SYMBOLS LEGEND

EXISTING WALL TO REMAIN.


EXISTING WOOD CORE DOOR TO REMAIN. G.C. TO PROTECT EXISTING DOORS TO REMAIN DURING CONSTRUCTION.

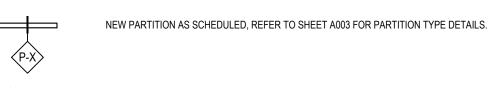

NEW DOOR OR EXISTING DOOR W/ NEW HARDWARE, REFER TO DOOR SCHEDULE ON SHEET A004 FOR



ADDITIONAL INFORMATION.

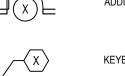

KEYED NOTE TAG.

# (T): 703-527-2280

architecture+design

4601 FAIRFAX DRIVE

SUITE 1000

ARLINGTON, VIRGINIA 22203

5628 FOXCROFT WAY COLUMBIA, MD 21045 (T): 202-674-4481

ENGINEERING, PLC

# FINISH SCHEDULE

		MANUFACTURER:	ASHFORD FORMULA
F4	CONCRETE	PRODUCT:	ASHFORD FORMULA
F1	SEALER	COLOR:	N/A
		NOTE:	BASEMENT LEVEL ONLY
		MANUFACTURER:	TBD
F2	CARPET TILE	PRODUCT:	TBD
F2	CARPET TILE	COLOR:	TBD
		NOTE:	ALLOW \$35 / SF INSTALLED COST

		MANUFACTURER:	SHERWIN WILLIAMS
		PRODUCT NO.:	B28W18150
		COLOR:	WHITE
P1	PRIMER	FINISH:	-
		NOTE:	ALL NEW DRYWALL PARTITIONS SHALL BE PRIMED AND READY TO RECEIVE NEW PAINT FINISH (FINAL PAINTING TO

DONE BY TENANT).

CEILING

CEILING				
		MANUFACTURER:	SHERWIN WILLIAMS	
C1	EXISTING GYP. BD.	PRODUCT NO.:	TBD	
Ci	CEILINGS	COLOR:	WHITE (MATCH EXISTING )	
	02,2,1,100	FINSH:	MATCH EXISTING	

# INTERIOR FINISH CRITERIA

ALL INTERIOR FINISHES SHALL MEET THE FOLLOWING REQUIREMENTS: VIRGINIA CONSTRUCTION CODES - 2021, CHAPTER 8 AND IBC 2018 SECTION 603 AND CHAPTER 8.

# WALLS & CEILINGS: SPRINKLERED

EXIT ENCLOSURE AND EXIT PASSAGEWAYS CORRIDORS ROOMS AND ENCLOSED SPACE

ROOMS AND ENCLOSED SPACE

CORRIDORS

CLASS C CLASS C

CLASS B

CLASS C

WALLS & CEILINGS: NONSPRINKLERED EXIT ENCLOSURE AND EXIT PASSAGEWAYS CLASS A

IN ALL AREAS, FLOOR COVERING MATERIALS SHALL COMPLY WITH THE DOC FF=1 "PILL TEST" (LPSC 16 CFR, PART 1630)

NOTE: CLASSIFICATIONS FOR WALLS AND CEILINGS IN ACCORDANCE WITH ASTM E84. FLAMESPREAD 0-25; SMOKE DEVELOPED: 0-450 CLASS B FLAMESPREAD 26-75; SMOKE DEVELOPED: 0-450 CLASS B FLAMESPREAD 76-200; SMOKE DEVELOPED: 0-450

NOTE: CLASSIFICATION FOR FLOORS IN ACCORDANCE WITH ASTM E648

0.45 WATTS/SQUARE CM. CLASS I CLASS II 0.22 WATTS/SQUARE CM.

NOTE: ALL DECORATIVE MATERIALS AND TRIM (SECTION 806) THE PERMISSIBLE AMOUNT OF COMBUSTIBLE DECORATIVE MATERIALS MEETING THE FLAME PROPAGATION PERFORMANCE CRITERIA OF NFPA 701 SHALL NOT EXCEED 10 PERCENT OF THE SPECIFIC WALL OR CEILING AREA TO WHICH IT IS ATTACHED. MATERIALS OTHER THAN FOAM PLASTIC USED AS INTERIOR TRIM SHALL MEET THE FOLLOWING CRITERIA.

FLAMESPREAD 76-200; SMOKE DEVELOPED: 0-450

DECORATIVE FABRICS SHALL CONFORM TO IBC 2018 SECTION 806.3 AND NFPA 701.

FOAM PLASTIC SHALL COMPLY WITH SECTION 2604.2

# SPECIAL FINISH & INSULATION NOTES

SPECIAL LIFE-SAFETY FINISH / CODE NOTES

- PER IBC 2018 SECTION 720.2: INSULATING MATERIALS, WHERE CONCEALED AS INSTALLED IN BUILDINGS OF ANY TYPE OF CONSTRUCTION, SHALL HAVE A FLAME SPREAD INDEX OF NOT MORE THAN 25 AND A SMOKE-DEVELOPED INDEX OF NOT MORE THAN 450.
- ALL INSTALLED INTERIOR FINISHES AS SPECIFIED IN THESE PLANS SHALL HAVE SMOKE AND FLAME SPREAD RATINGS THAT CONFORM WITH IBC 2018, SECTIONS 803.1 & 804. WALL AND CEILING FINISHES SHALL BE TYPE "B" OR GREATER, AND FLOOR FINISHES SHALL BE OF CLASS I OR II.



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ISSUED DESIGN INTENT DRAWINGS 03.28.2025 PERMIT & BID 07.18.2025


DESIGNED/DRAWN BY: REVIEWED/APPROVED BY: PE

ARCHITECTURAL

PLAN BASEMENT & FIRST FLOOR

SHEET NUMBER:

PROJECT NO:

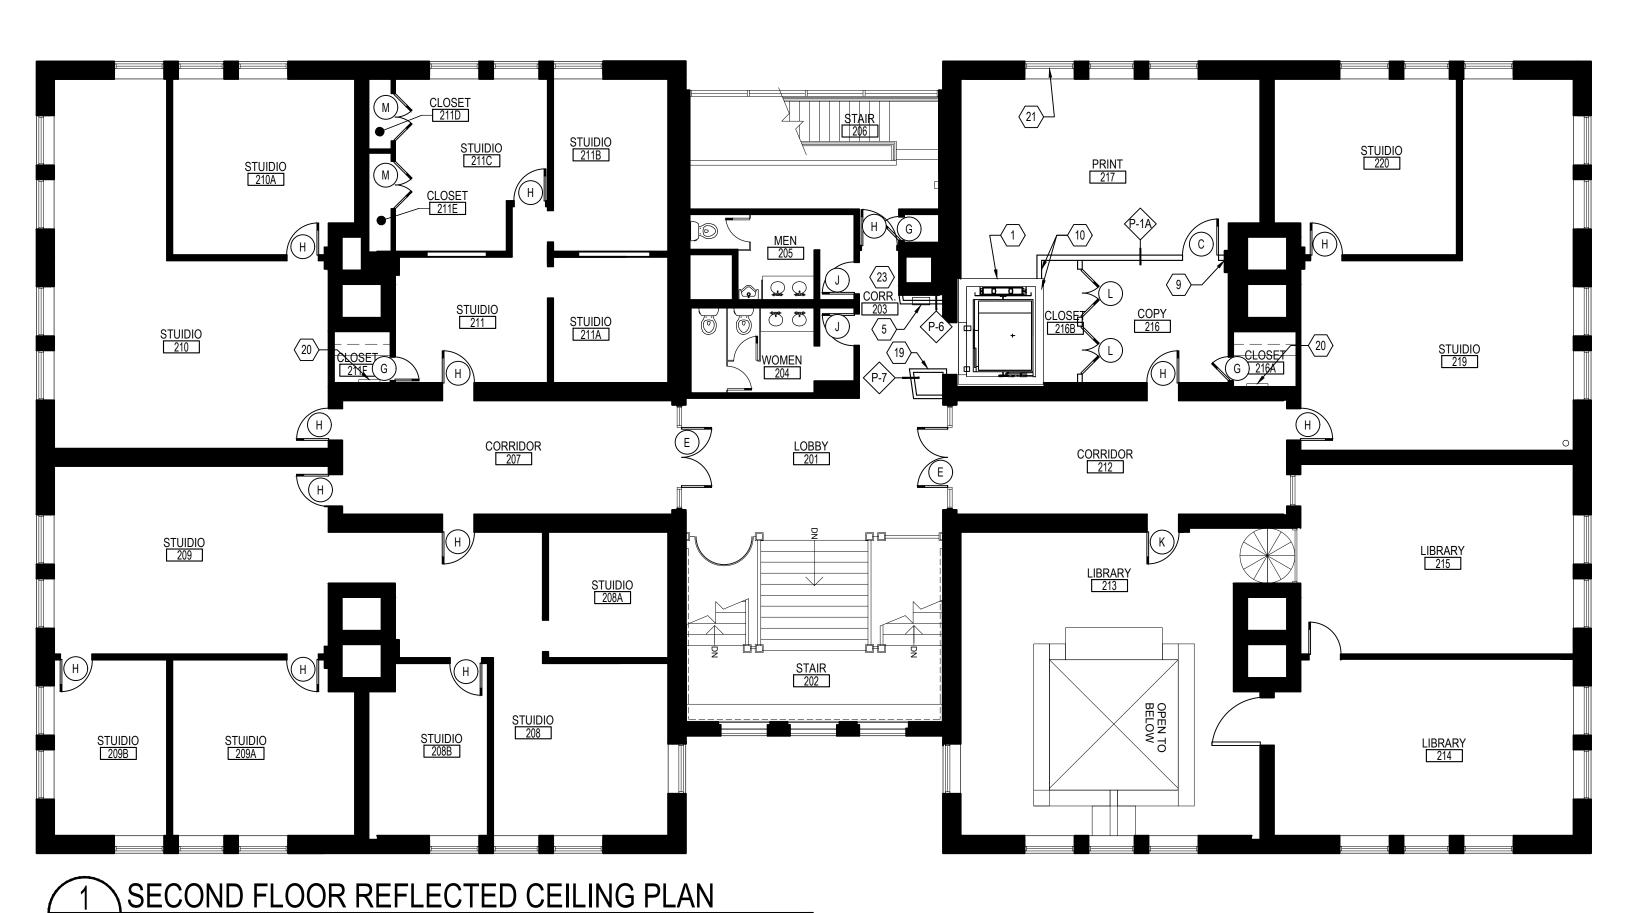








- NEW CMU HOISTWAY, COORDINATE EXACT LOCATION IN FIELD WITH EXISTING MASONRY WALLS. SEE DETAILS AS INDICATED AND REFER TO STRUCTURAL ENGINEER'S DRAWINGS FOR ADDITIONAL INFORMATION.
- NEW MACHINE ROOM-LESS TRACTION ELEVATOR SCHINDLER 3300 (2100 LB CAPACITY, TWO-SPEED RIGHT OPENING) OR APPROVED EQUAL.
- HOLD INSIDE FACE OF NEW PARTITION TIGHT TO EXISTING SUMP PUMP AS SHOWN.
- NEW FLOOR MOUNTED SERVICE SINK, MUSTEE SMC FIBERLASS MODEL 63CM , INCLUDES DUAL HANDLE
- INSTALL RELOCATED FIRE EXTINGUISHER & CABINET, HOLD NEW FURRING PARTITION AS TIGHT TO EXISTING BRICK AS CABINET DIMENSIONS WILL ALLOW.
- LOCATION OF NEW SPRINKLER RISER, HOLD TIGHT TO CORNER.
- EXTEND MASONRY LOW-WALL FOR NEW RAMP, MATCH EXISTING BRICK. REFER TO ELEVATIONS FOR ADDITIONAL DETAIL.
- NEW CONCRETE RAMP WITH MASONRY GUARD WALLS AS SHOWN, REFER TO ELEVATIONS FOR ADDITIONAL
- CENTER NEW CEILING HEIGHT GYP. BD. PARTITION ON BULKHEAD ABOVE.
- ALIGN AS SHOWN.
- NEW CAP AT HOISTWAY, 2 LAYERS 5 8" TYPE X GYP. BD. OVER 2" PAN DECK, REFER TO STRUCTURAL DRAWINGS FOR HOISTBEAM AND OTHER DETAILS.
- PROVIDE AND INSTALL NEW ELKAY HIGH-LOW DRINKING FOUINTAIN WITH BOTTLE FILLER, REFER TO ELEVATION X/AXXX FOR ADDITIONAL INFORMATION.
- NEW 6" DIP WATERLINE, REFER TO X/AXXX FOR PENETRATION DETAIL. COORDINATE WITH ENGINEERING
- PROVIDE NEW FDC / SIAMESE CONNECTION, REFER TO ENGINEERS PLANS FOR ADDITIONAL INFORMATION.
- PROVIDE TWO 6" DIA. BOLLARDS AS SHOWN.
- PROVIDE NEW RED "FDC" SIGNAGE LETTERS TO BE 6" OR LARGER AND NEW STROBE LIGHT ABOVE FDC AND TIE TO FIRE PANEL.
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- FABRICATE 1/2" PLEXIGLASS INSERT TO REPLACE TOP PORTION OF WINDOW GLAZING (APPROX. 43"W X 23"H) AND PROVIDE SHIMS AS NECESSARY TO HOLD TIGHT IN PLACE - DO NOT CAULK, PLEXIGLASS MUST BE
- INFILL FROM TOP OF NEW DOOR FRAME TO DECK ABOVE WITH PARTITION TYPE 3, REFER TO ELEVATION 3/A203
- FOR ADDITIONAL DETAIL. PROVIDE NEW CARPET (F2) AT ADMIN. 113, STAFF WORK ROOM 114, CORRIDOR 103, AND CORRIDOR 203. NO

# SYMBOLS LEGEND


EXISTING WALL TO REMAIN.

EXISTING WOOD CORE DOOR TO REMAIN. G.C. TO PROTECT EXISTING DOORS TO REMAIN DURING CONSTRUCTION.

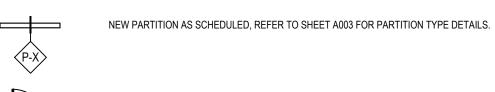



NEW DOOR OR EXISTING DOOR W/ NEW HARDWARE, REFER TO DOOR SCHEDULE ON SHEET A004 FOR ADDITIONAL INFORMATION.

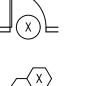

KEYED NOTE TAG.

architecture+design 4601 FAIRFAX DRIVE SUITE 1000

> ARLINGTON, VIRGINIA 22203 (T): 703-527-2280



5628 FOXCROFT WAY COLUMBIA, MD 21045 (T): 202-674-4481

# FINISH SCHEDULE

		MANUFACTURER:	ASHFORD FORMULA
	CONCRETE	PRODUCT:	ASHFORD FORMULA
F1	SEALER	COLOR:	N/A
		NOTE:	BASEMENT LEVEL ONLY
		MANUFACTURER:	TBD
F2	CARPET TILE	PRODUCT:	TBD
FZ		COLOR:	TBD
		NOTE:	ALLOW \$35 / SF INSTALLED COST
WALLS			
		MANUFACTURER:	SHERWIN WILLIAMS
		PRODUCT NO.:	B28W18150

		COLOR:	WHITE
P1	PRIMER	FINISH:	•
		NOTE:	ALL NEW DRYWALL PARTITIONS SHALL BE PRIMED AND READY TO RECEIVE NEW PAINT FINISH (FINAL PAINTING TO DONE BY TENANT).

CEILING	

CEILING			
		MANUFACTURER:	SHERWIN WILLIAMS
C1	EXISTING GYP. BD. CEILINGS	PRODUCT NO.:	TBD
CI		COLOR:	WHITE (MATCH EXISTING )
		FINSH:	MATCH EXISTING

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# WALLS & CEILINGS: SPRINKLERED

CLASS C

WALLS & CEILINGS: NONSPRINKLERED

EXIT ENCLOSURE AND EXIT PASSAGEWAYS CORRIDORS ROOMS AND ENCLOSED SPACE

CLASS C

EXIT ENCLOSURE AND EXIT PASSAGEWAYS CORRIDORS

ROOMS AND ENCLOSED SPACE

CLASS A CLASS B CLASS C

IN ALL AREAS, FLOOR COVERING MATERIALS SHALL COMPLY WITH THE DOC FF=1 "PILL TEST" (LPSC 16 CFR, PART 1630)

NOTE: CLASSIFICATIONS FOR WALLS AND CEILINGS IN ACCORDANCE WITH ASTM E84. FLAMESPREAD 0-25; SMOKE DEVELOPED: 0-450 CLASS B FLAMESPREAD 26-75; SMOKE DEVELOPED: 0-450 CLASS B FLAMESPREAD 76-200; SMOKE DEVELOPED: 0-450

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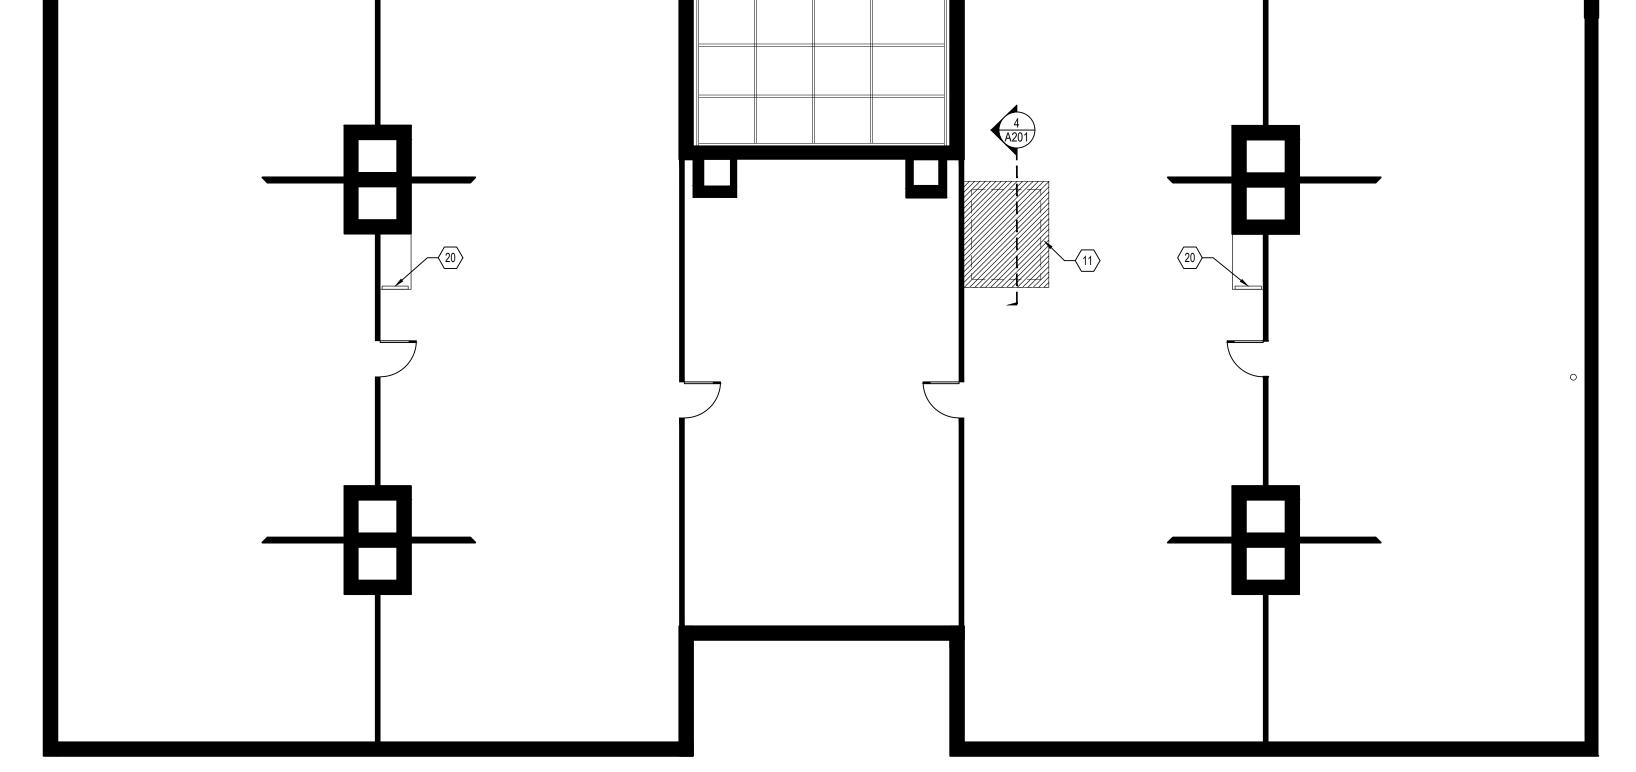
ISSUED	DA
DESIGN INTENT DRAWINGS	03.28.20
PERMIT & BID	07.18.20

DESIGNED/DRAWN BY: REVIEWED/APPROVED BY: PE

ARCHITECTURAL PLAN SECOND FLOOR & ATTIC

SHEET NUMBER:


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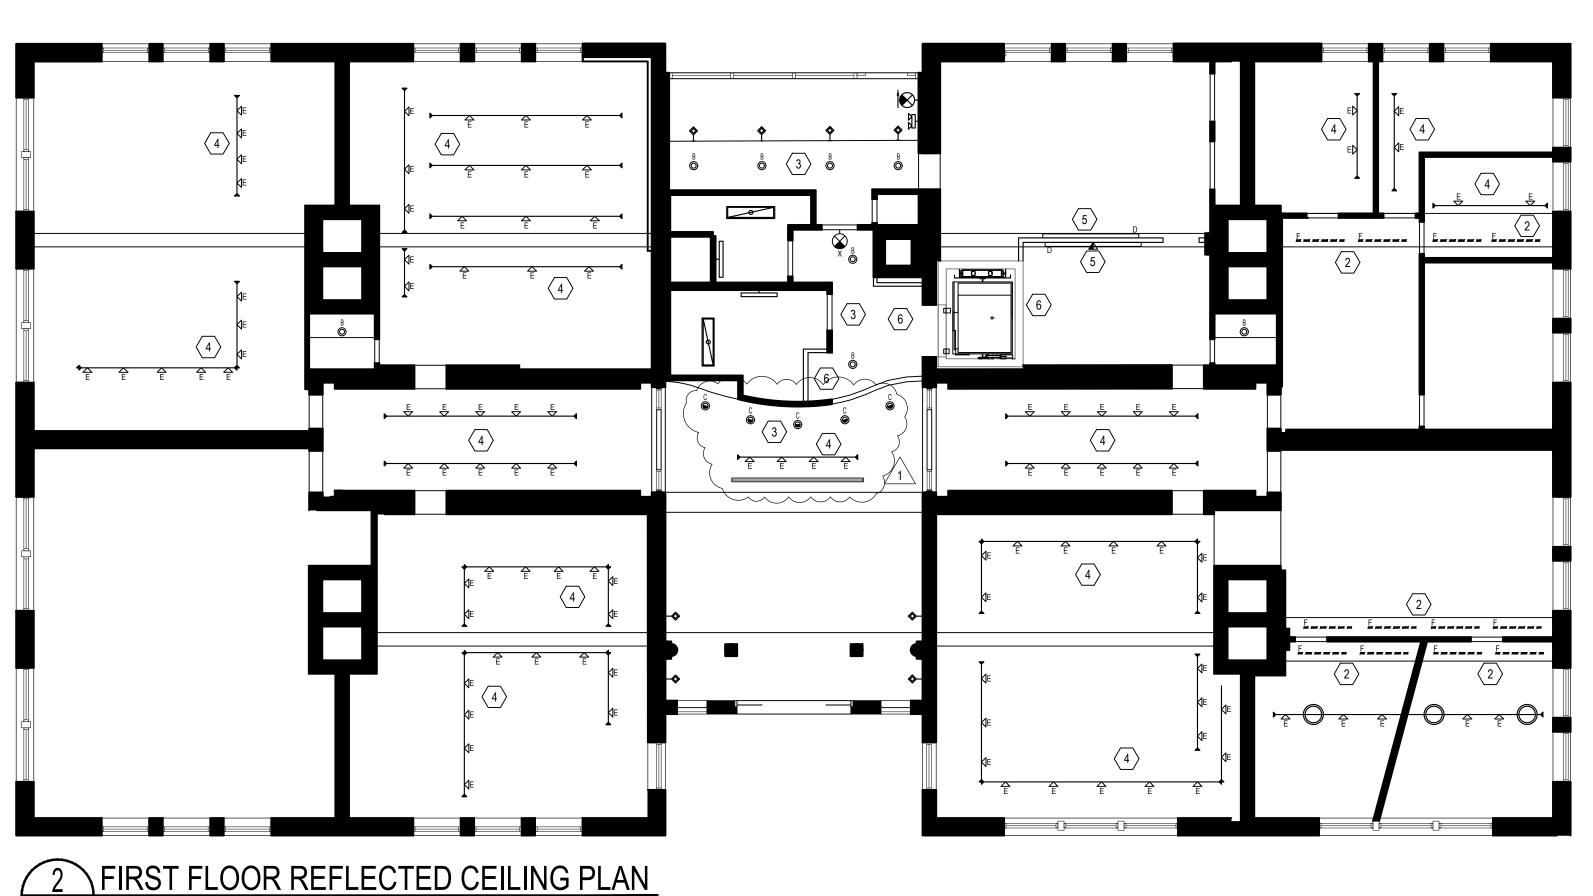




ATTIC REFLECTED CEILING PLAN

5



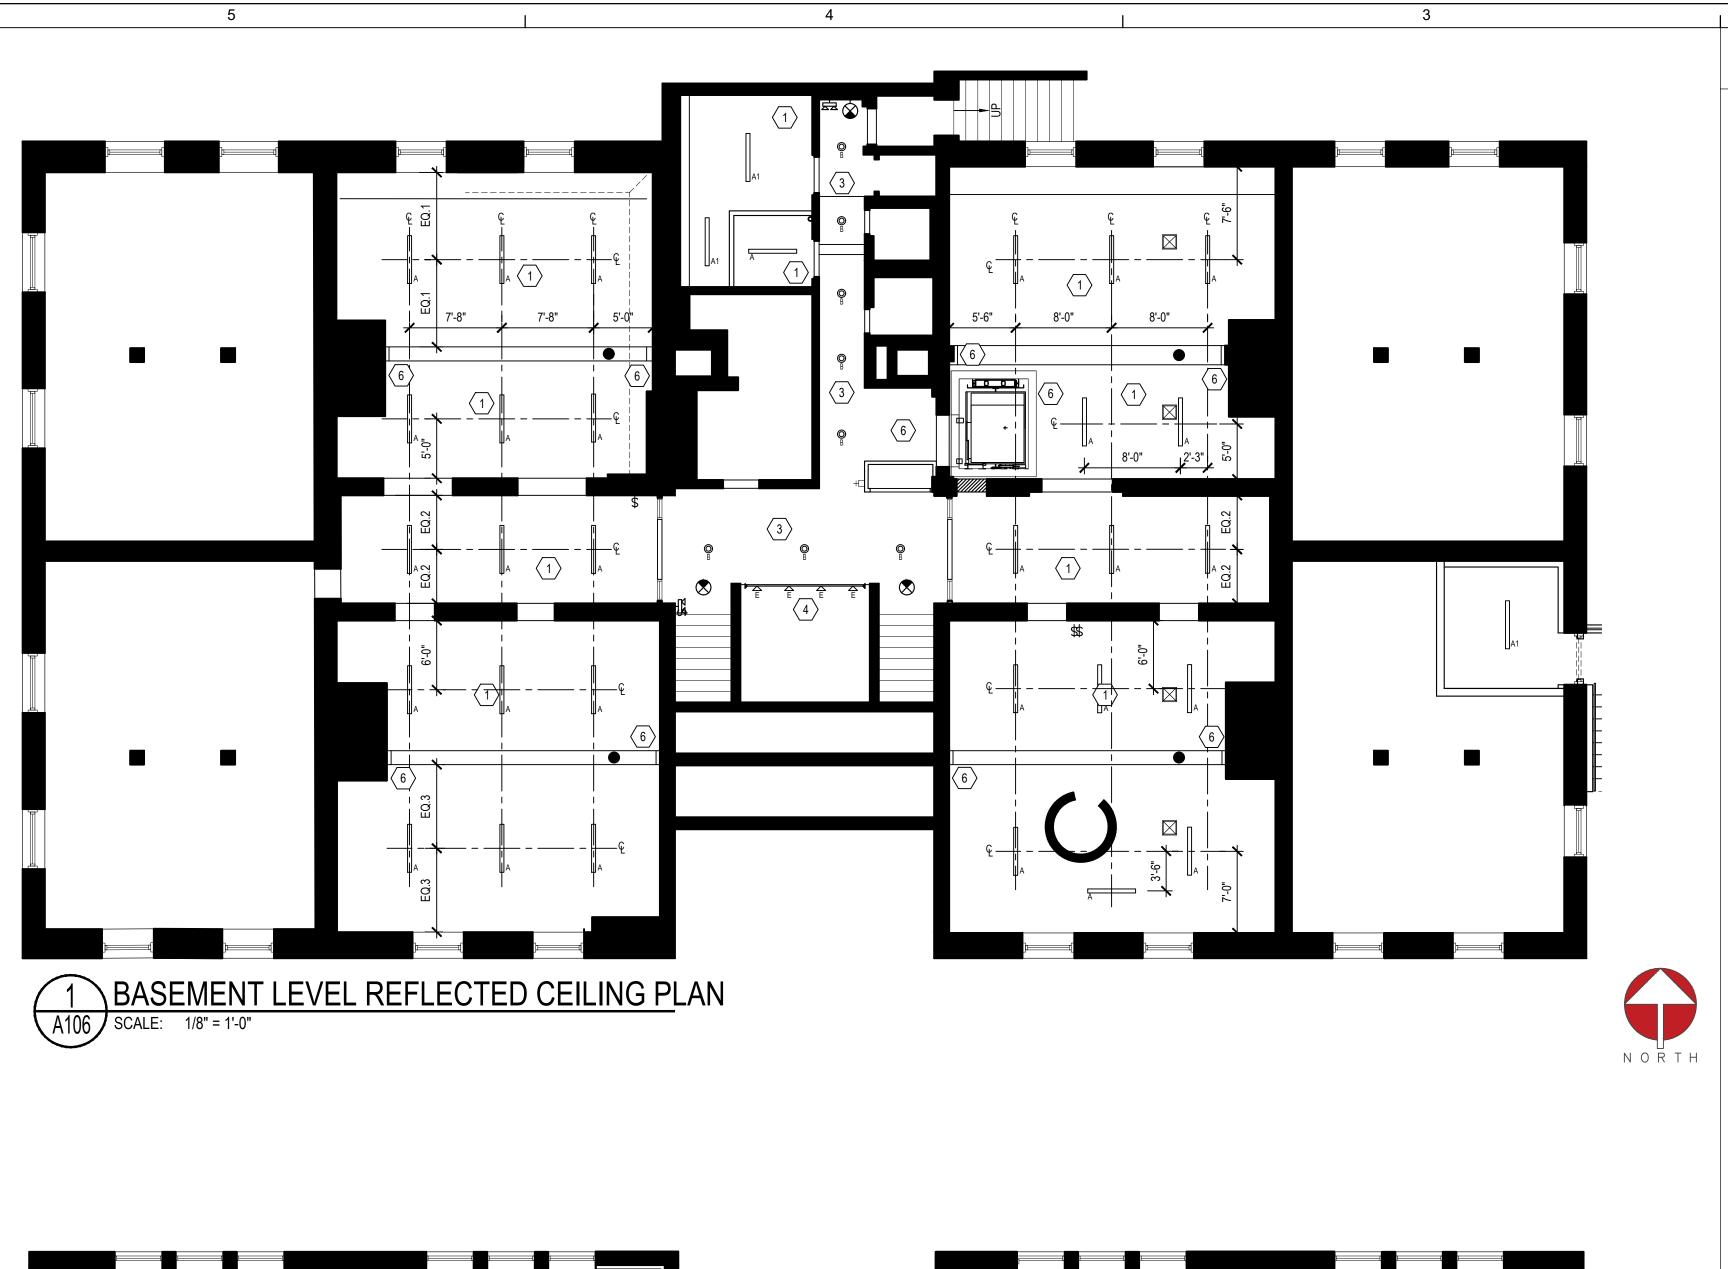

3

5

# NEW WORK KEY NOTES

- PROVIDE AND INSTALL NEW SURFACE MOUNTED LED LIGHTING AS SCHEDULED.
- PROVIDE AND INSTALL NEW LINEAR LED UPLIGHT AS SCHEDULED, RE-USE EXISTING CIRCUITING.
- PROVIDE AND INSTALL NEW RECESSED LED DOWNLIGHT OR WALLWASHER AS SCHEDULED, LOCATION TO BE SAME AS PREVIOUSLY DEMOLISHED FIXTURES, RE-USE EXISTING CIRCUITING.

2

- PROVIDE AND INSTALL NEW LED TRACK HEADS ON EXISTING TRACK AS SCHEDULED.
- PROVIDE AND INSTALL NEW WALL MOUNTED LINEAR LED FIXTURE AS SCHEDULED, MOUNT AT 8'-0" AND CENTER ON AS SHOWN.
- PATCH / REPAIR / EXTEND GYP. BD. CEILING OR BULKHEAD AS REQUIRED DUE TO DEMO. & CONSTRUCTION ACTIVITIES.

2

SYMBOLS LEGEND

EXISTING CONSTRUCTION TO BE REMOVED.

EXISTING WALL TO REMAIN.

- EXISTING SURFACE MOUNTED 1X4 FIXTURE TO REMAIN

- EXISTING RECESSED DOWNLIGHT TO REMAIN

EXISTING VANITY FIXTURE TO REMAIN

- EXISTING TRACK AND PENDANTS TO REMAIN
- ►◆ EXISTING WALL SCONCE TO REMAIN
- EXISTING PENDANT FIXTURE TO REMAIN

EXISTING EXIT LIGHT TO REMAIN

- EXISTING EXIT LIGHT WITH EMERGENCY LIGHT TO REMAIN
- EXISTING EMERGENCY LIGHT WITH BATTER PACK TO REMAIN

# architecture+design

4601 FAIRFAX DRIVE SUITE 1000 ARLINGTON, VIRGINIA 22203 (T): 703-527-2280



5628 FOXCROFT WAY COLUMBIA, MD 21045 (T): 202-674-4481

VIRGINIA TECH ASHINGTON-ALEXANDRIA ARCHITECTURE CENTER

# LIGHTING SCHEDULE

		MANUFACTURER:	BIRCHWOOD LIGHTING	
		MODEL:	KEL-LED-225 / SM	
Α	• •	PRODUCT NO.:	KEL-LED-225-IB-SLO-40-4-MW-FW-120-D1-SM	
		SIZE:	48"	
		NOTE:		
		MANUFACTURER:	CG7 DESIGN	-
		MODEL:	E904	
A1	• •	PRODUCT NO.:	E904-SKIT-LPA-LED50-CT35-UNV-WHT	
^'		SIZE:	47"	
		NOTE:	-	
		MANUFACTURER:	INTENSE	
		MODEL:	SD6DR	
_				
В	0	PRODUCT NO.:	SD6DRL4359-D101-NF	
		SIZE:	6"	
		NOTE:	INSTALL AT ORIGINAL LOCATION OF REMOVED DOWNLIGHTS	_
		MANUFACTURER:	INTENSE	
		MODEL:	SD6WR	
С	•	PRODUCT NO.:	SD6WRL4359-D101	
		SIZE:	6"	
		NOTE:	INSTALL AT ORIGINAL LOCATION OF REMOVED WALL WASHERS	
		MANUFACTURER:	INTERLUX	
		MODEL:	WEDGECOVE INDOOR	
D		PRODUCT NO.:	WG-WC-SM-S-96-M-935-D010-SDC-W	
		SIZE:	96"	
		NOTE:	-	
		MANUFACTURER:	SISTEMALUX	
		MODEL:	STUDIO PROJECTOR LED	
E	$\nabla$	PRODUCT NO.:	1770S1-BO-935-50-UNV-01-D10	
-	·	SIZE:	SMALL	
		NOTE:	_	
		MANUFACTURER:	OMNILIGHT	
		MODEL:	OCH-45	
F		PRODUCT NO.:	OCH-45-4-CL-AL	
r		SIZE:	48"	
		NOTE:	PROVIDE OMNILIGHT GEN2-30-SHO LED TAPE	
		MANUFACTURER:	BEULUX	
		MODEL:	REGRAZER	
G		PRODUCT NO.:	RG-D1035-CB-BR-DTR-XX'-W-RD	
		SIZE:	VARIES	
		NOTE:	•	
		MANUFACTURER:	LITHONIA	
		MODEL:	EDG EXIT SIGN	
X	igotimes	PRODUCT NO.:	EDG1R	
		SIZE:	•	
		NOTE:	DED LETTEDO ON OLEAD	- 1

RED LETTERS ON CLEAR FOR PRICING, PLEASE CONTACT GREG HORGAN AT ALLIANCE LIGHTING:

202.669.5717 greg.horgan@alliancelighting.com




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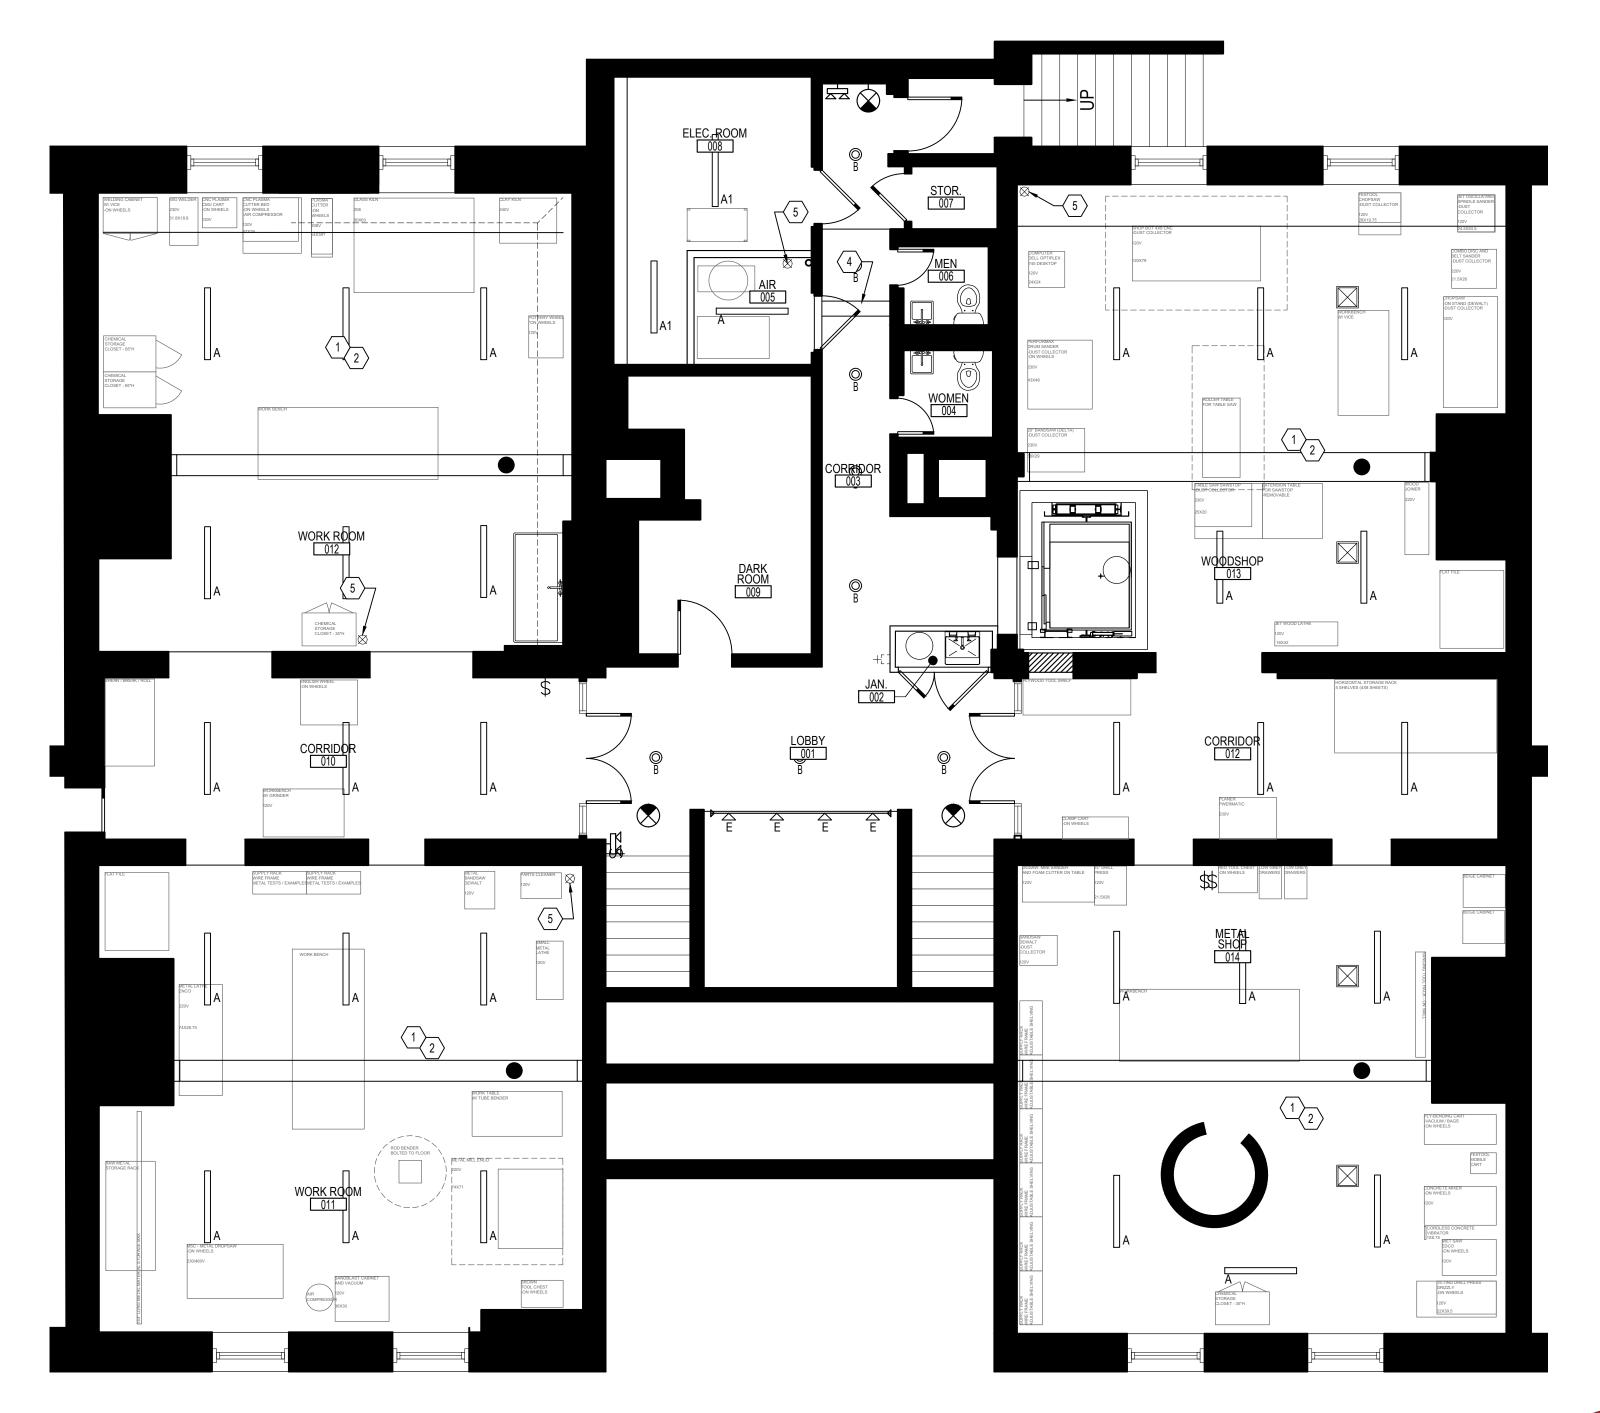
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SSUED	DATE
ESIGN INTENT DRAWINGS	03.28.2025
ERMIT & BID	07.18.2025

DESIGNED/DRAWN BY: REVIEWED/APPROVED BY: PE PROJECT NO:

SHEET TITLE:
CEILING PLAN **BASEMENT &** FIRST FLOOR



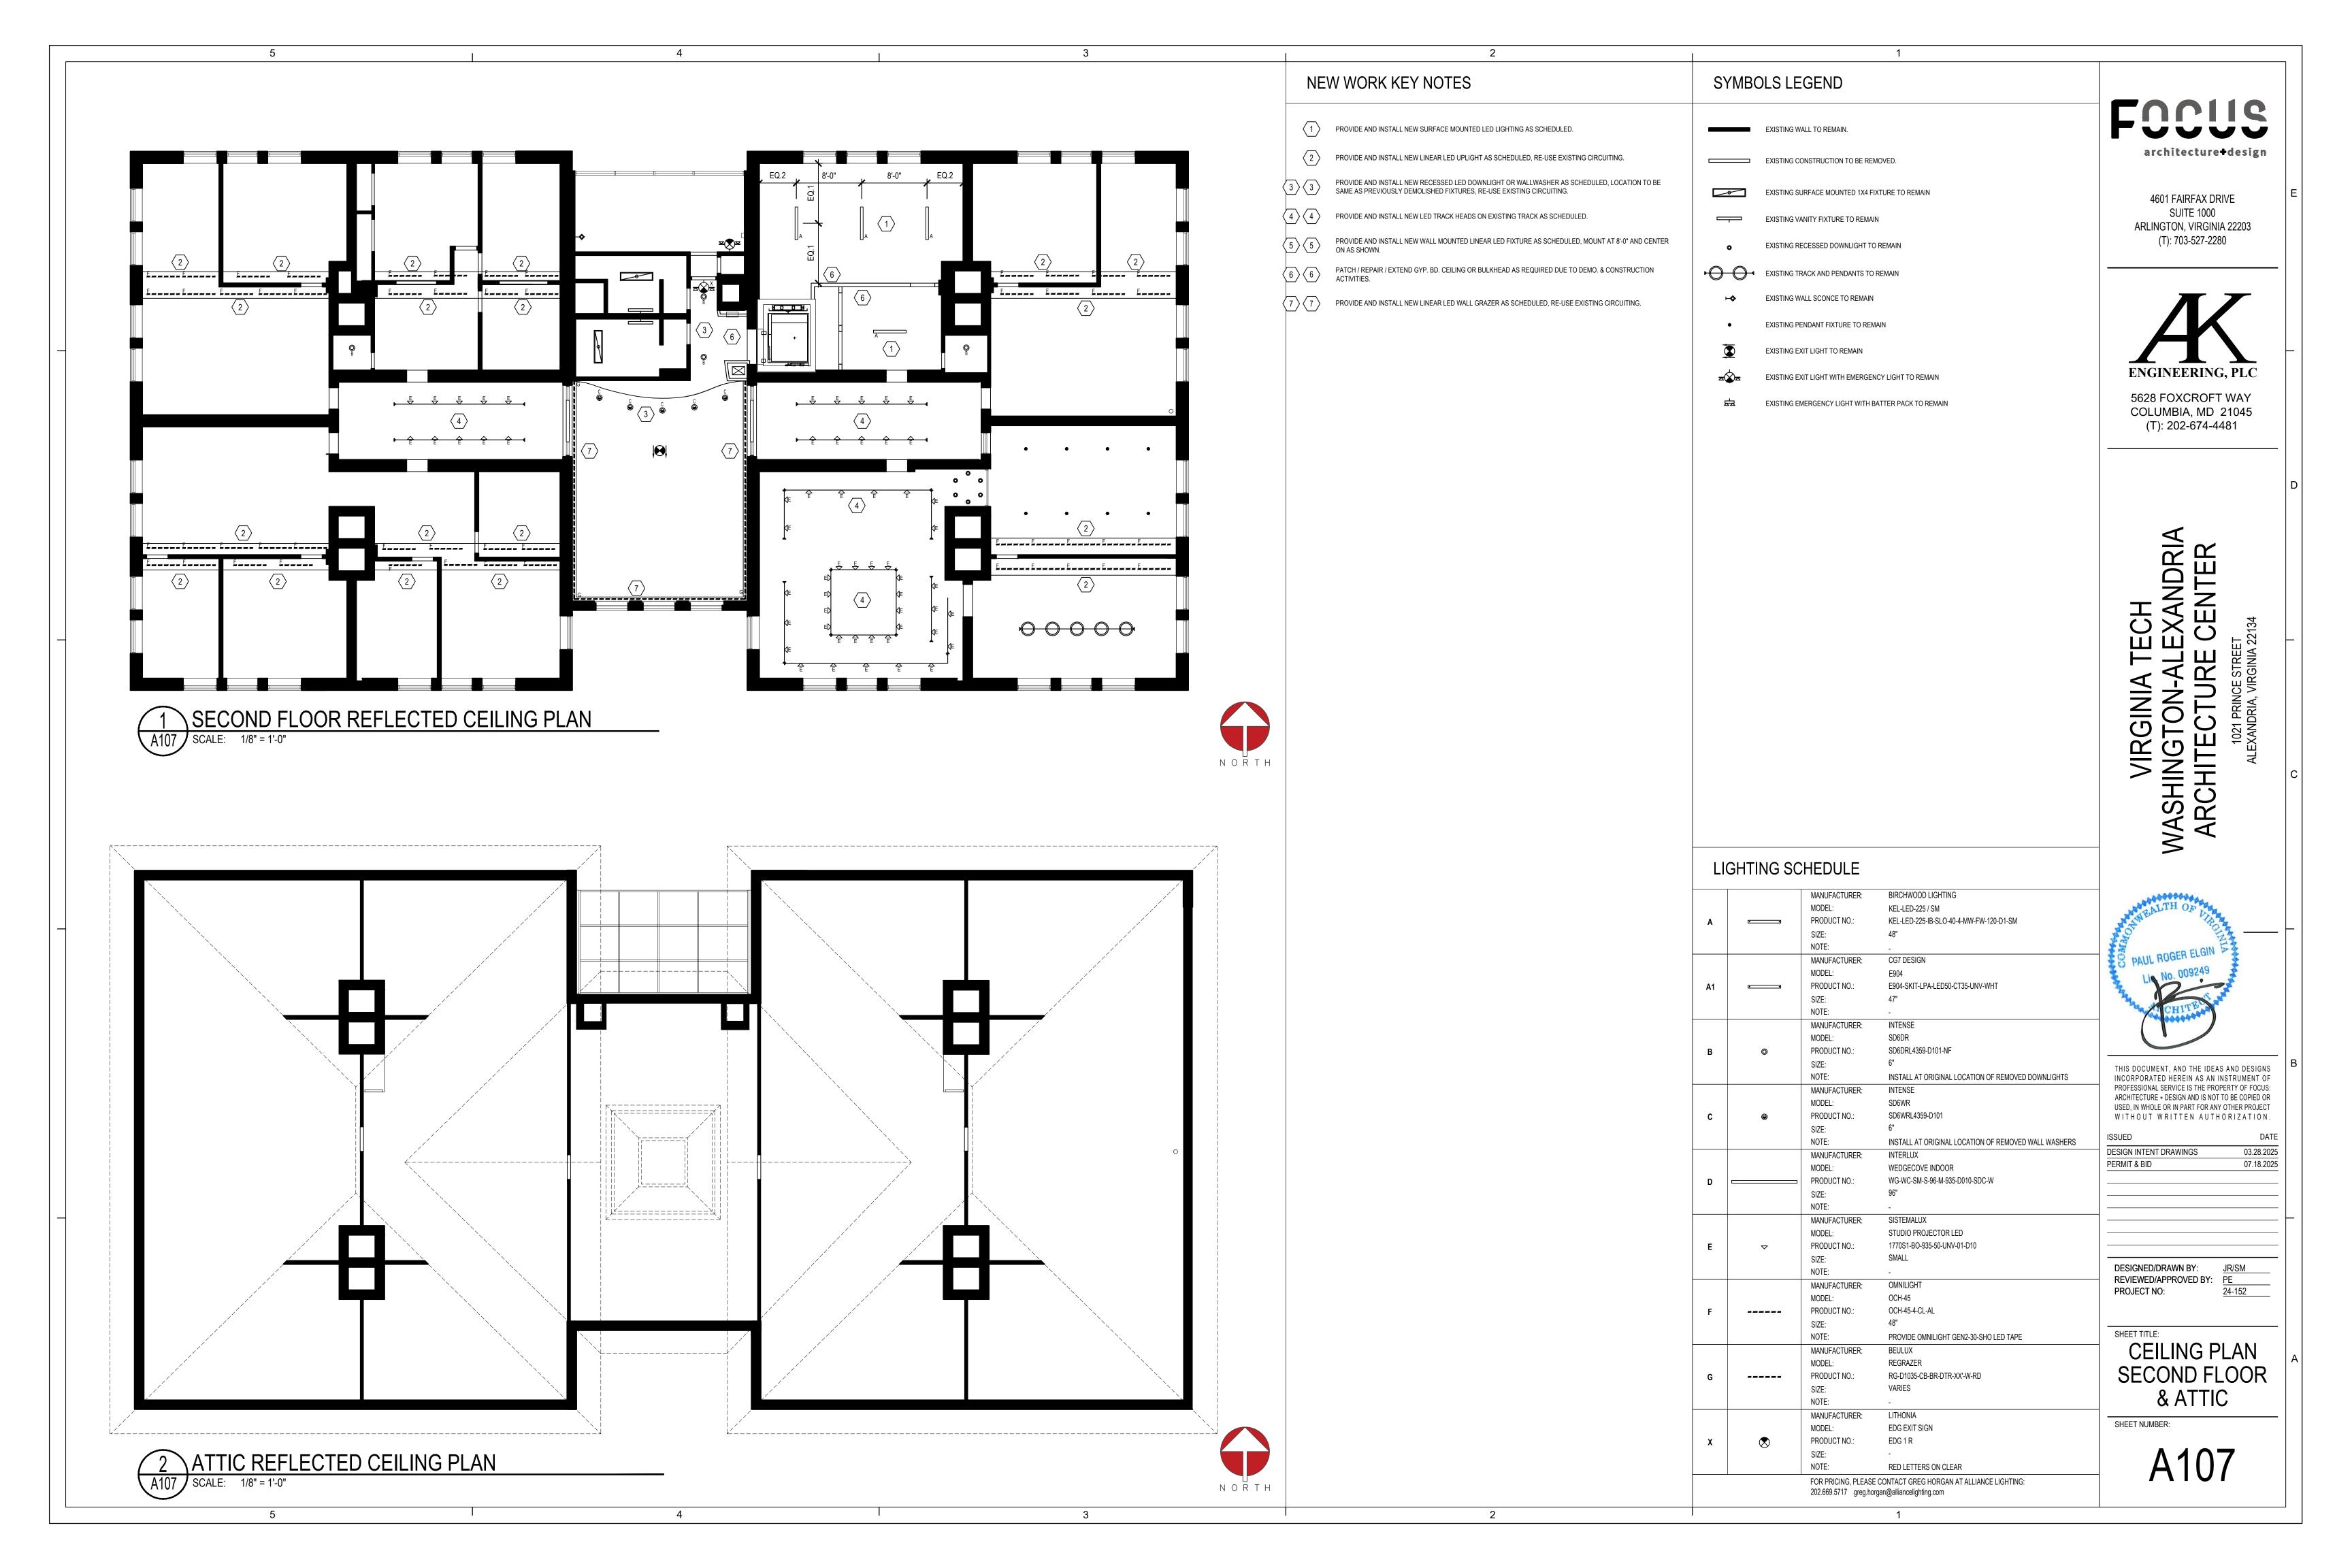

**\BASEMENT LEVEL QUIPMENT & POWER PLAN** 

5



3

#### NEW WORK KEY NOTES SYMBOLS LEGEND

- ALL EQUIPMENT SHALL BE PROVIDED AND INSTALLED BY TENANT, SHOW FOR REFERENCE ONLY.
- PROVIDE AND INSTALL SURFACE MOUNTED ELECTRICAL DEVICES AS SHOWN, TYPICAL THROUGHOUT BASEMENT LEVEL. COORDINATE WITH ENGINEER'S DRAWINGS FOR ADDITIONAL INFORMATION.
- PROVIDE AND INSTALL SURFACE MOUNTED ELECTRICAL DEVICES AS SHOWN, TYPICAL THROUGHOUT BASEMENT LEVEL. COORDINATE WITH ENGINEER'S DRAWINGS FOR ADDITIONAL INFORMATION.
- PROVIDE AND INSTALL FASTPIPE 3/4" BLUE ALUMINUM AIR LINES AS SHOWN, INCLUDING ALL ELBOWS AND TEES AS REQUIRED. ROUTE THROUGH NEW GYP. BD. HEADER ABOVE DOOR AND SECURE NEW LINES TO WALLS/CEILING USING MANUFACTURER'S MOUNTING CLIPS. AIR COMPRESSOR AND FINAL CONNECTIONS BY TENANT. (APPROXIMATELY 115'L OF FASTPIPE SHOWN - COORDINATE EXACT FINAL IN FIELD).
- TERMINATE FASTPIPE AT 48" A.F.F. AND PROVIDE  $\frac{3}{4}$ " MALE NPT ADAPTER.

EXISTING WALL TO REMAIN.

EXISTING WOOD CORE DOOR TO REMAIN. G.C. TO PROTECT EXISTING DOORS TO REMAIN DURING CONSTRUCTION.

EXISTING CONSTRUCTION TO BE REMOVED.



NEW DOOR AS SCHEDULED.

NEW DUPLEX RECEPTACLE, REFERENCE ENGINEERING DRAWINGS

NEW QUADUPLEX RECEPTACLE, REFERENCE ENGINEERING DRAWINGS

N 220 NEW 220V SIMPLEX RECEPTACLE, REFERENCE ENGINEERING DRAWINGS

NEW CEILING MOUNTED DUPLEX RECEPTACLE, REFERENCE ENGINEERING DRAWINGS

NEW CEILING MOUNTED 220V SIMPLEX RECEPTACLE, REFERENCE ENGINEERING DRAWINGS

NEW JUNCTION BOX & CONDUIT WITH PULL STRING FOR TENANT'S DATA CONNECTION


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VIRGINIA TECH ASHINGTON-ALEXANDRIA ARCHITECTURE CENTER




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DESIGN INTENT DRAWINGS 03.28.2025 PERMIT & BID 07.18.2025

DESIGNED/DRAWN BY: JR/S
REVIEWED/APPROVED BY: PE PROJECT NO:

SHEET TITLE:

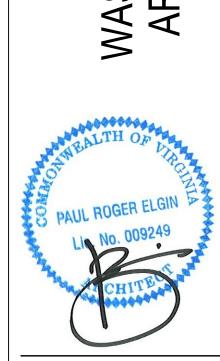**EQUIPMENT PLAN BASEMENT** 




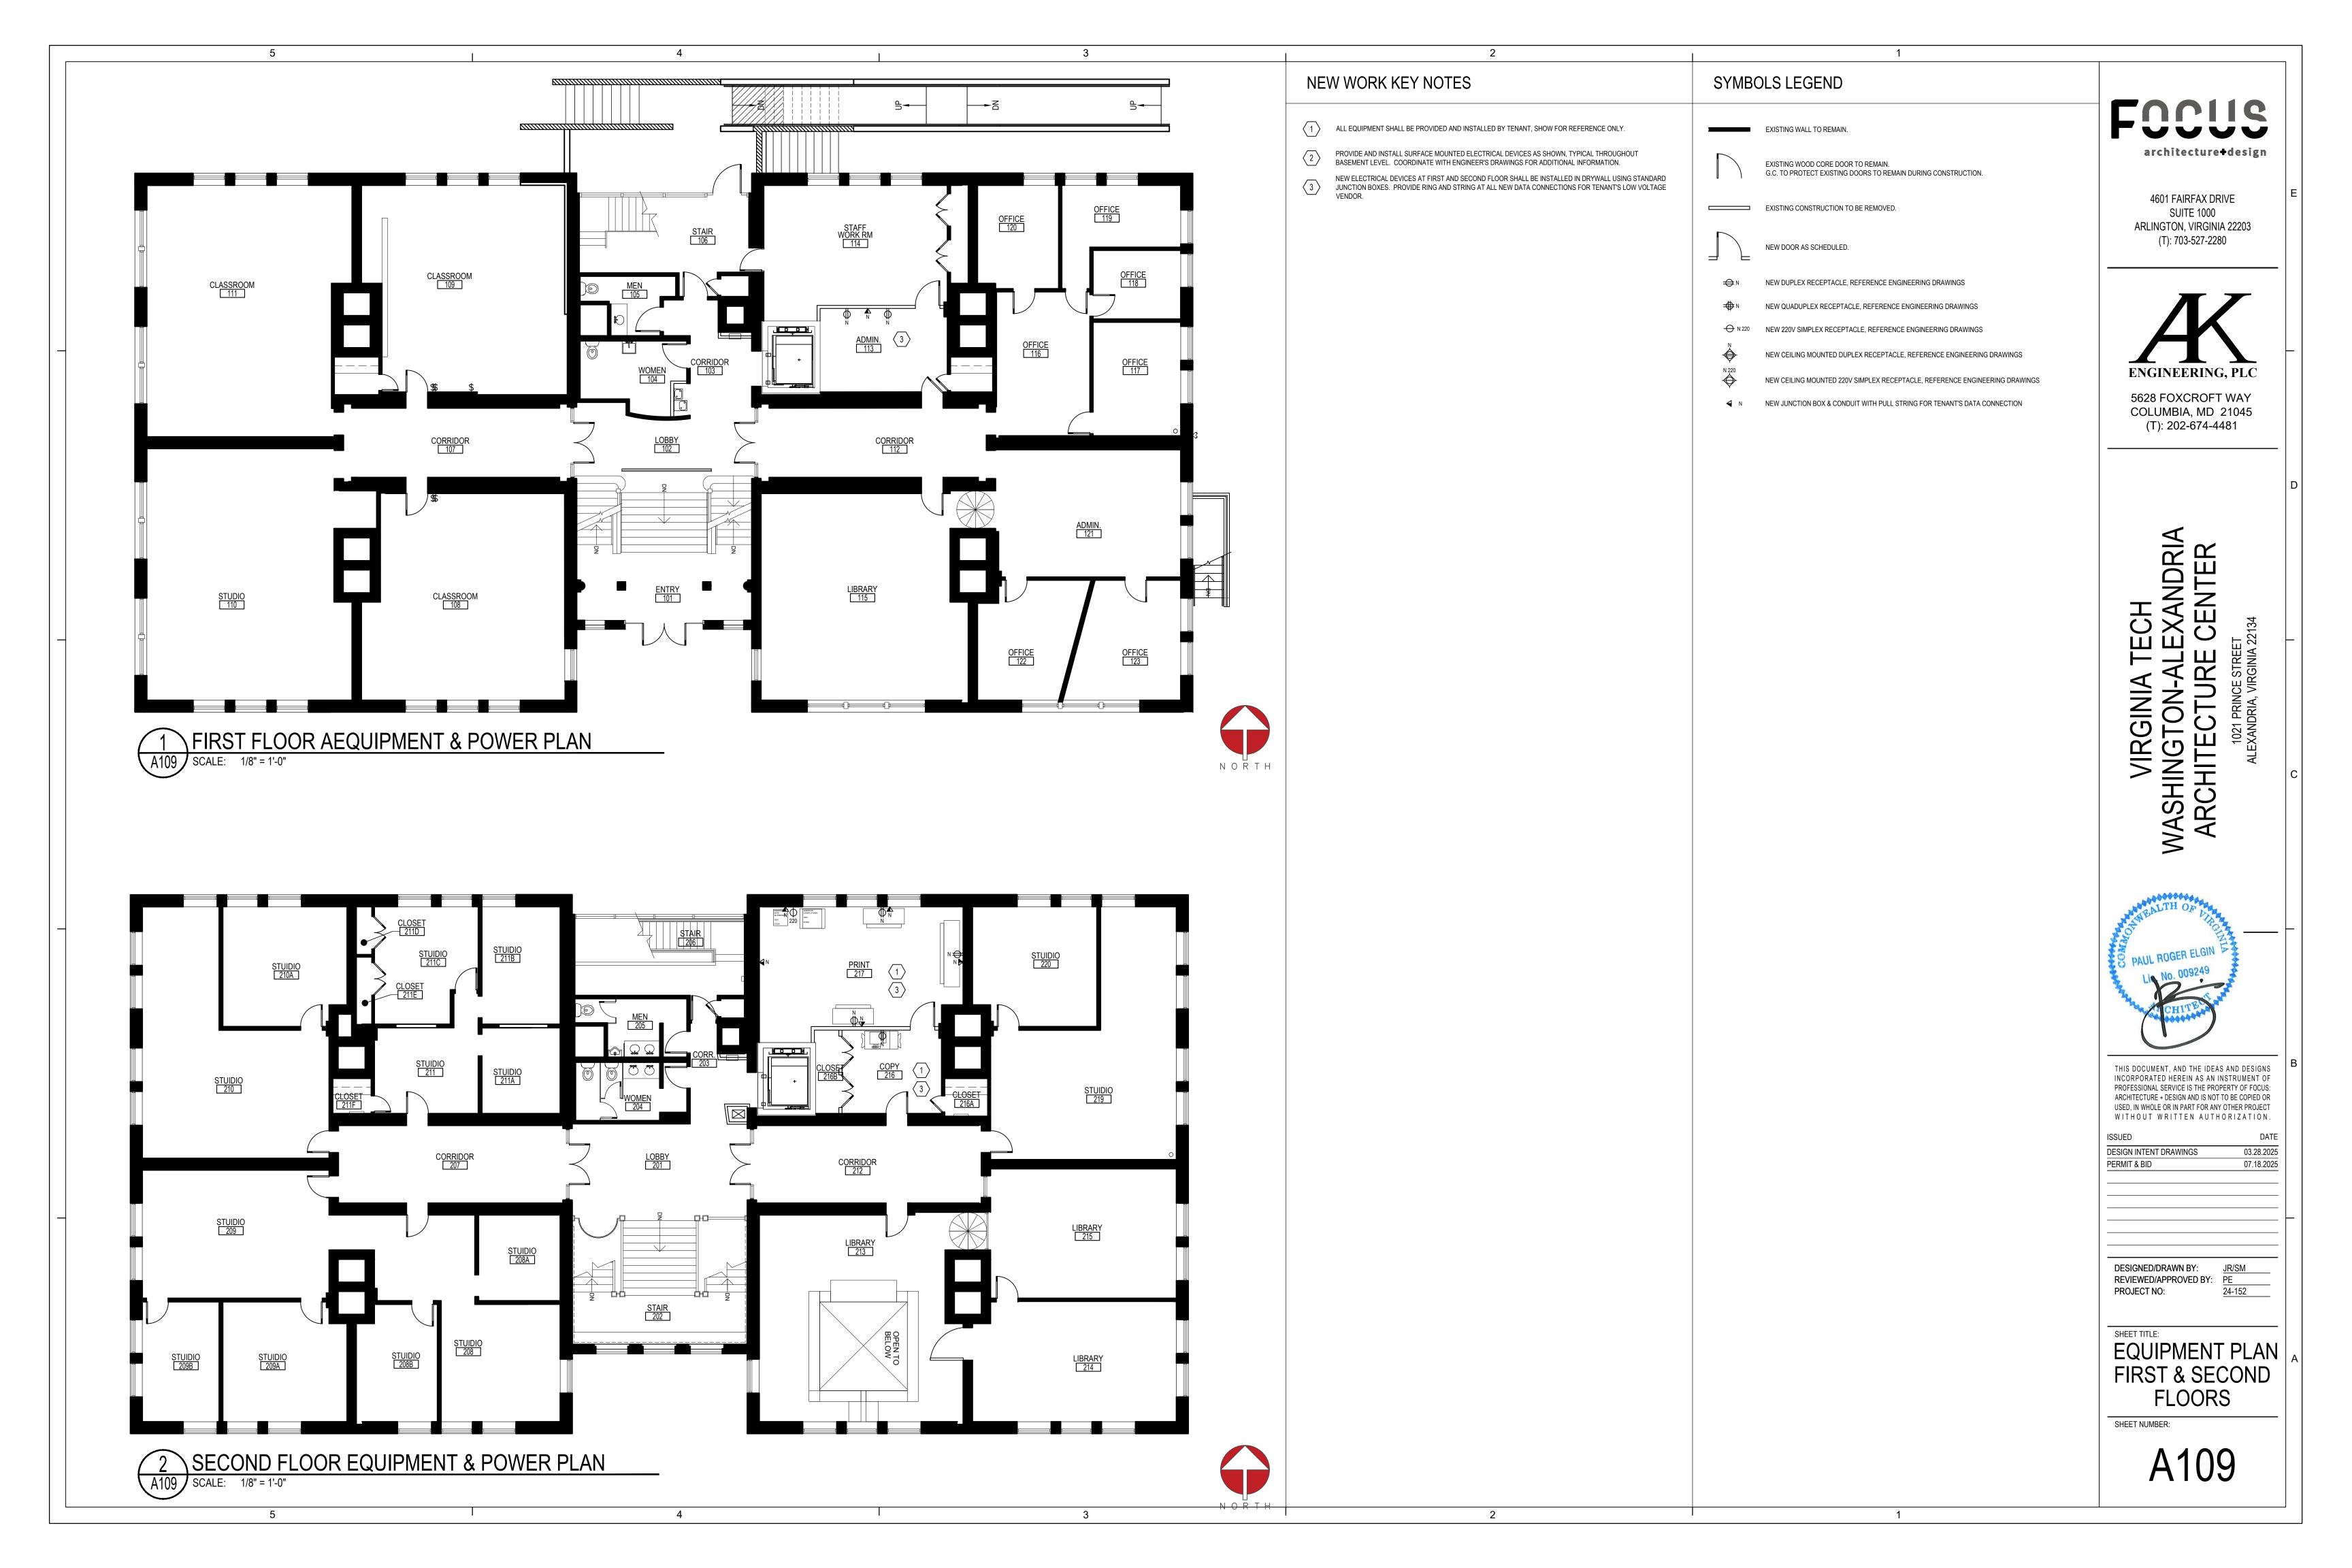


EAST ELEVATION AT EXTERIOR (EXISTING)

NOTE: REFER TO SHEET A203 & A204 FOR NEW STAIR DETAILS AND SECTIONS



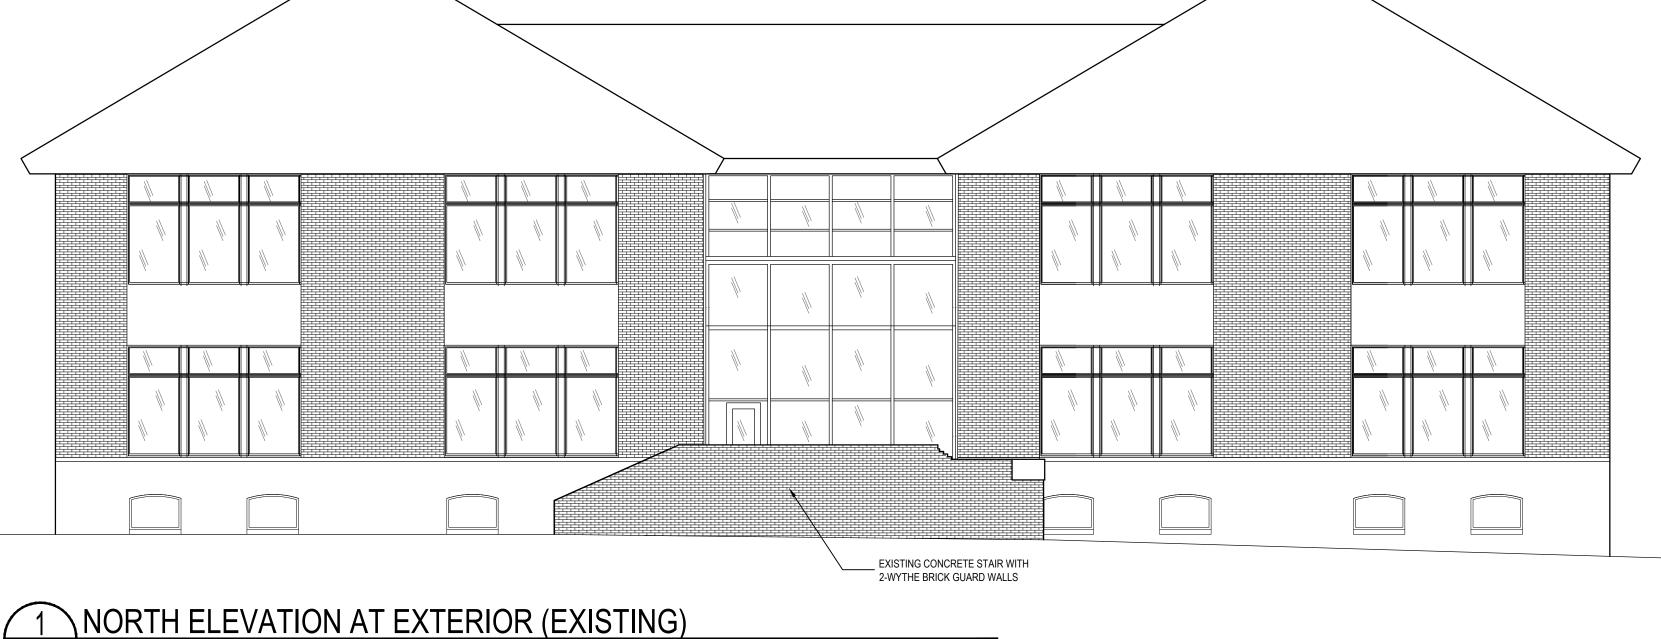

A200 SCALE: 1/8" = 1'-0"

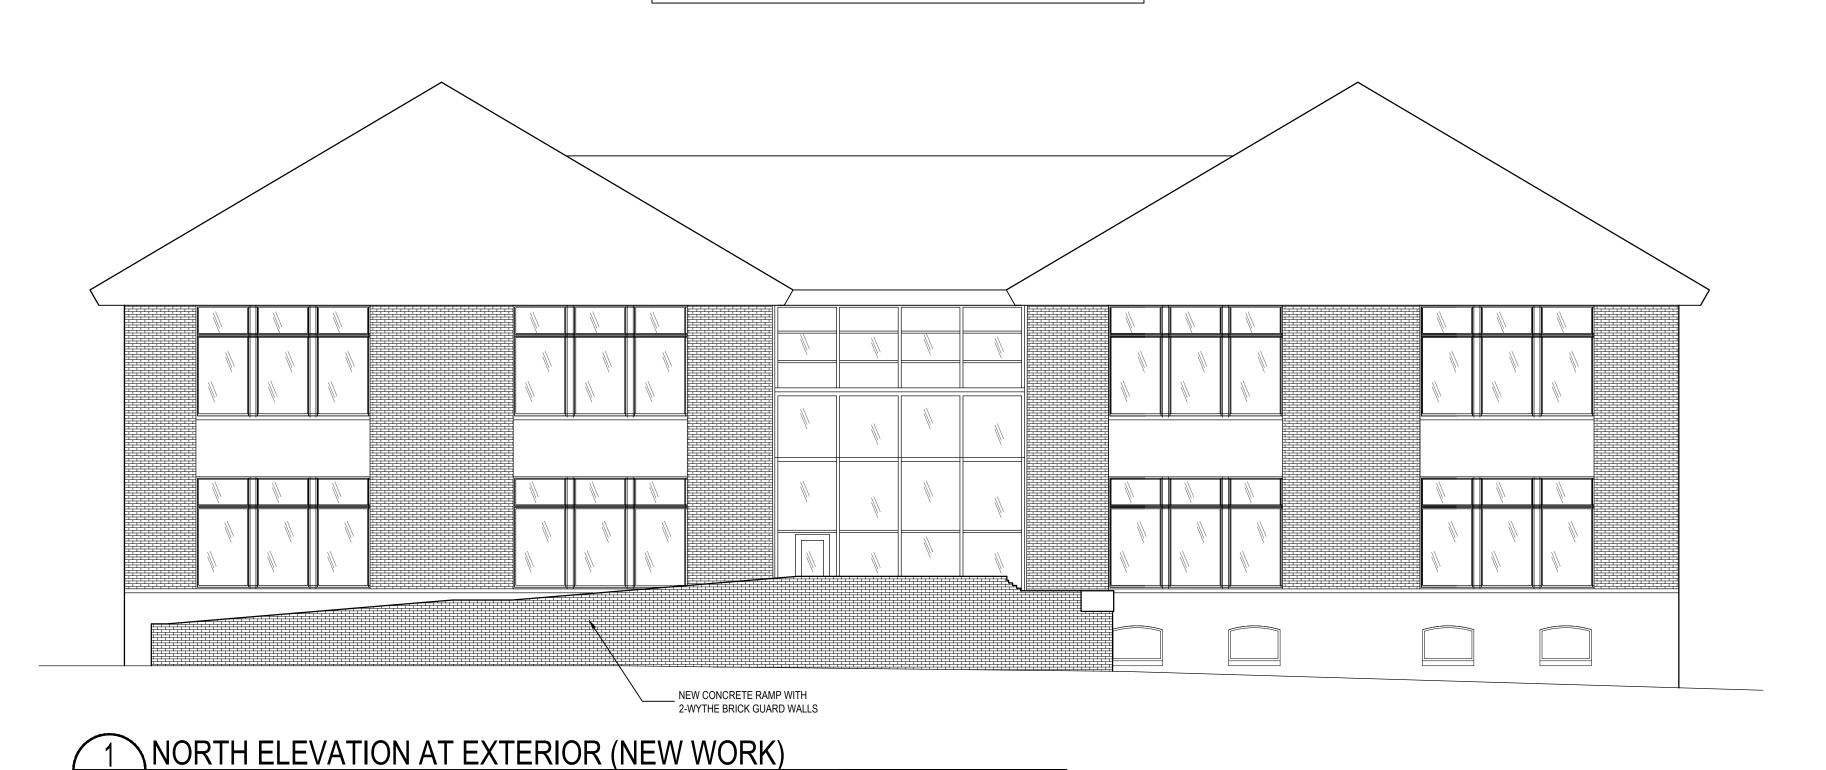

NOTE: REFER TO SHEET A202 FOR NEW RAMP DETAILS AND SECTIONS

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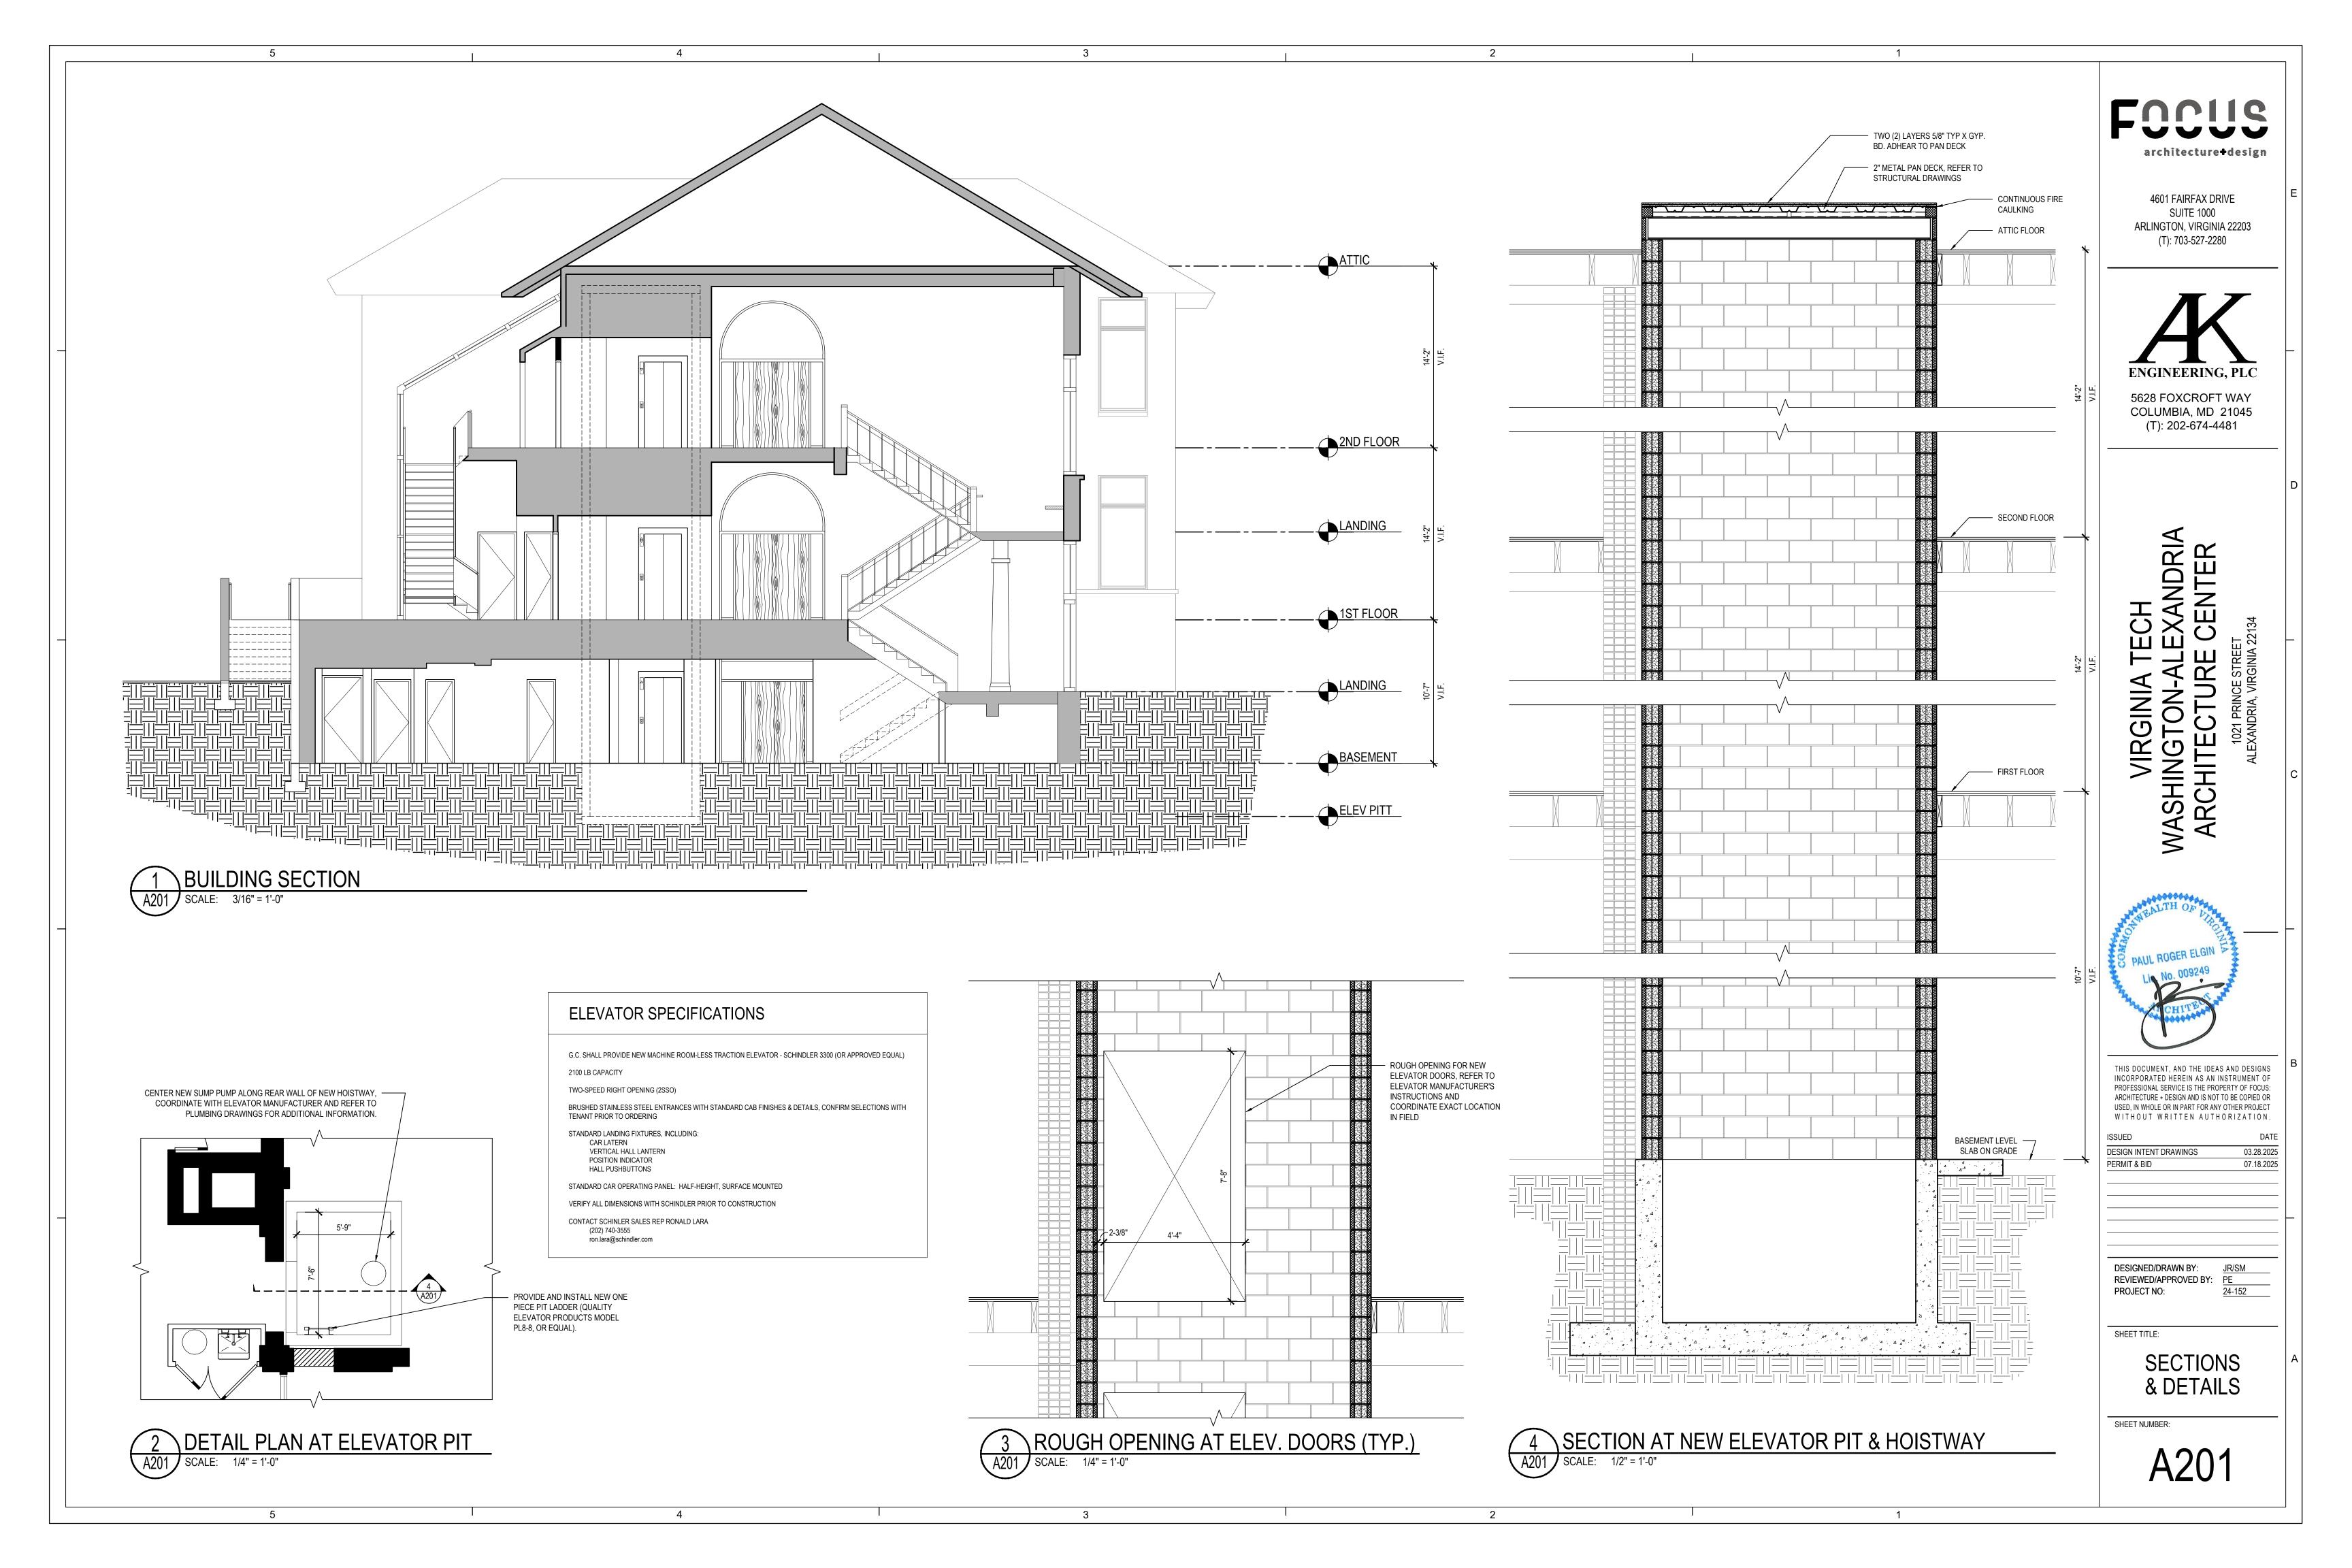
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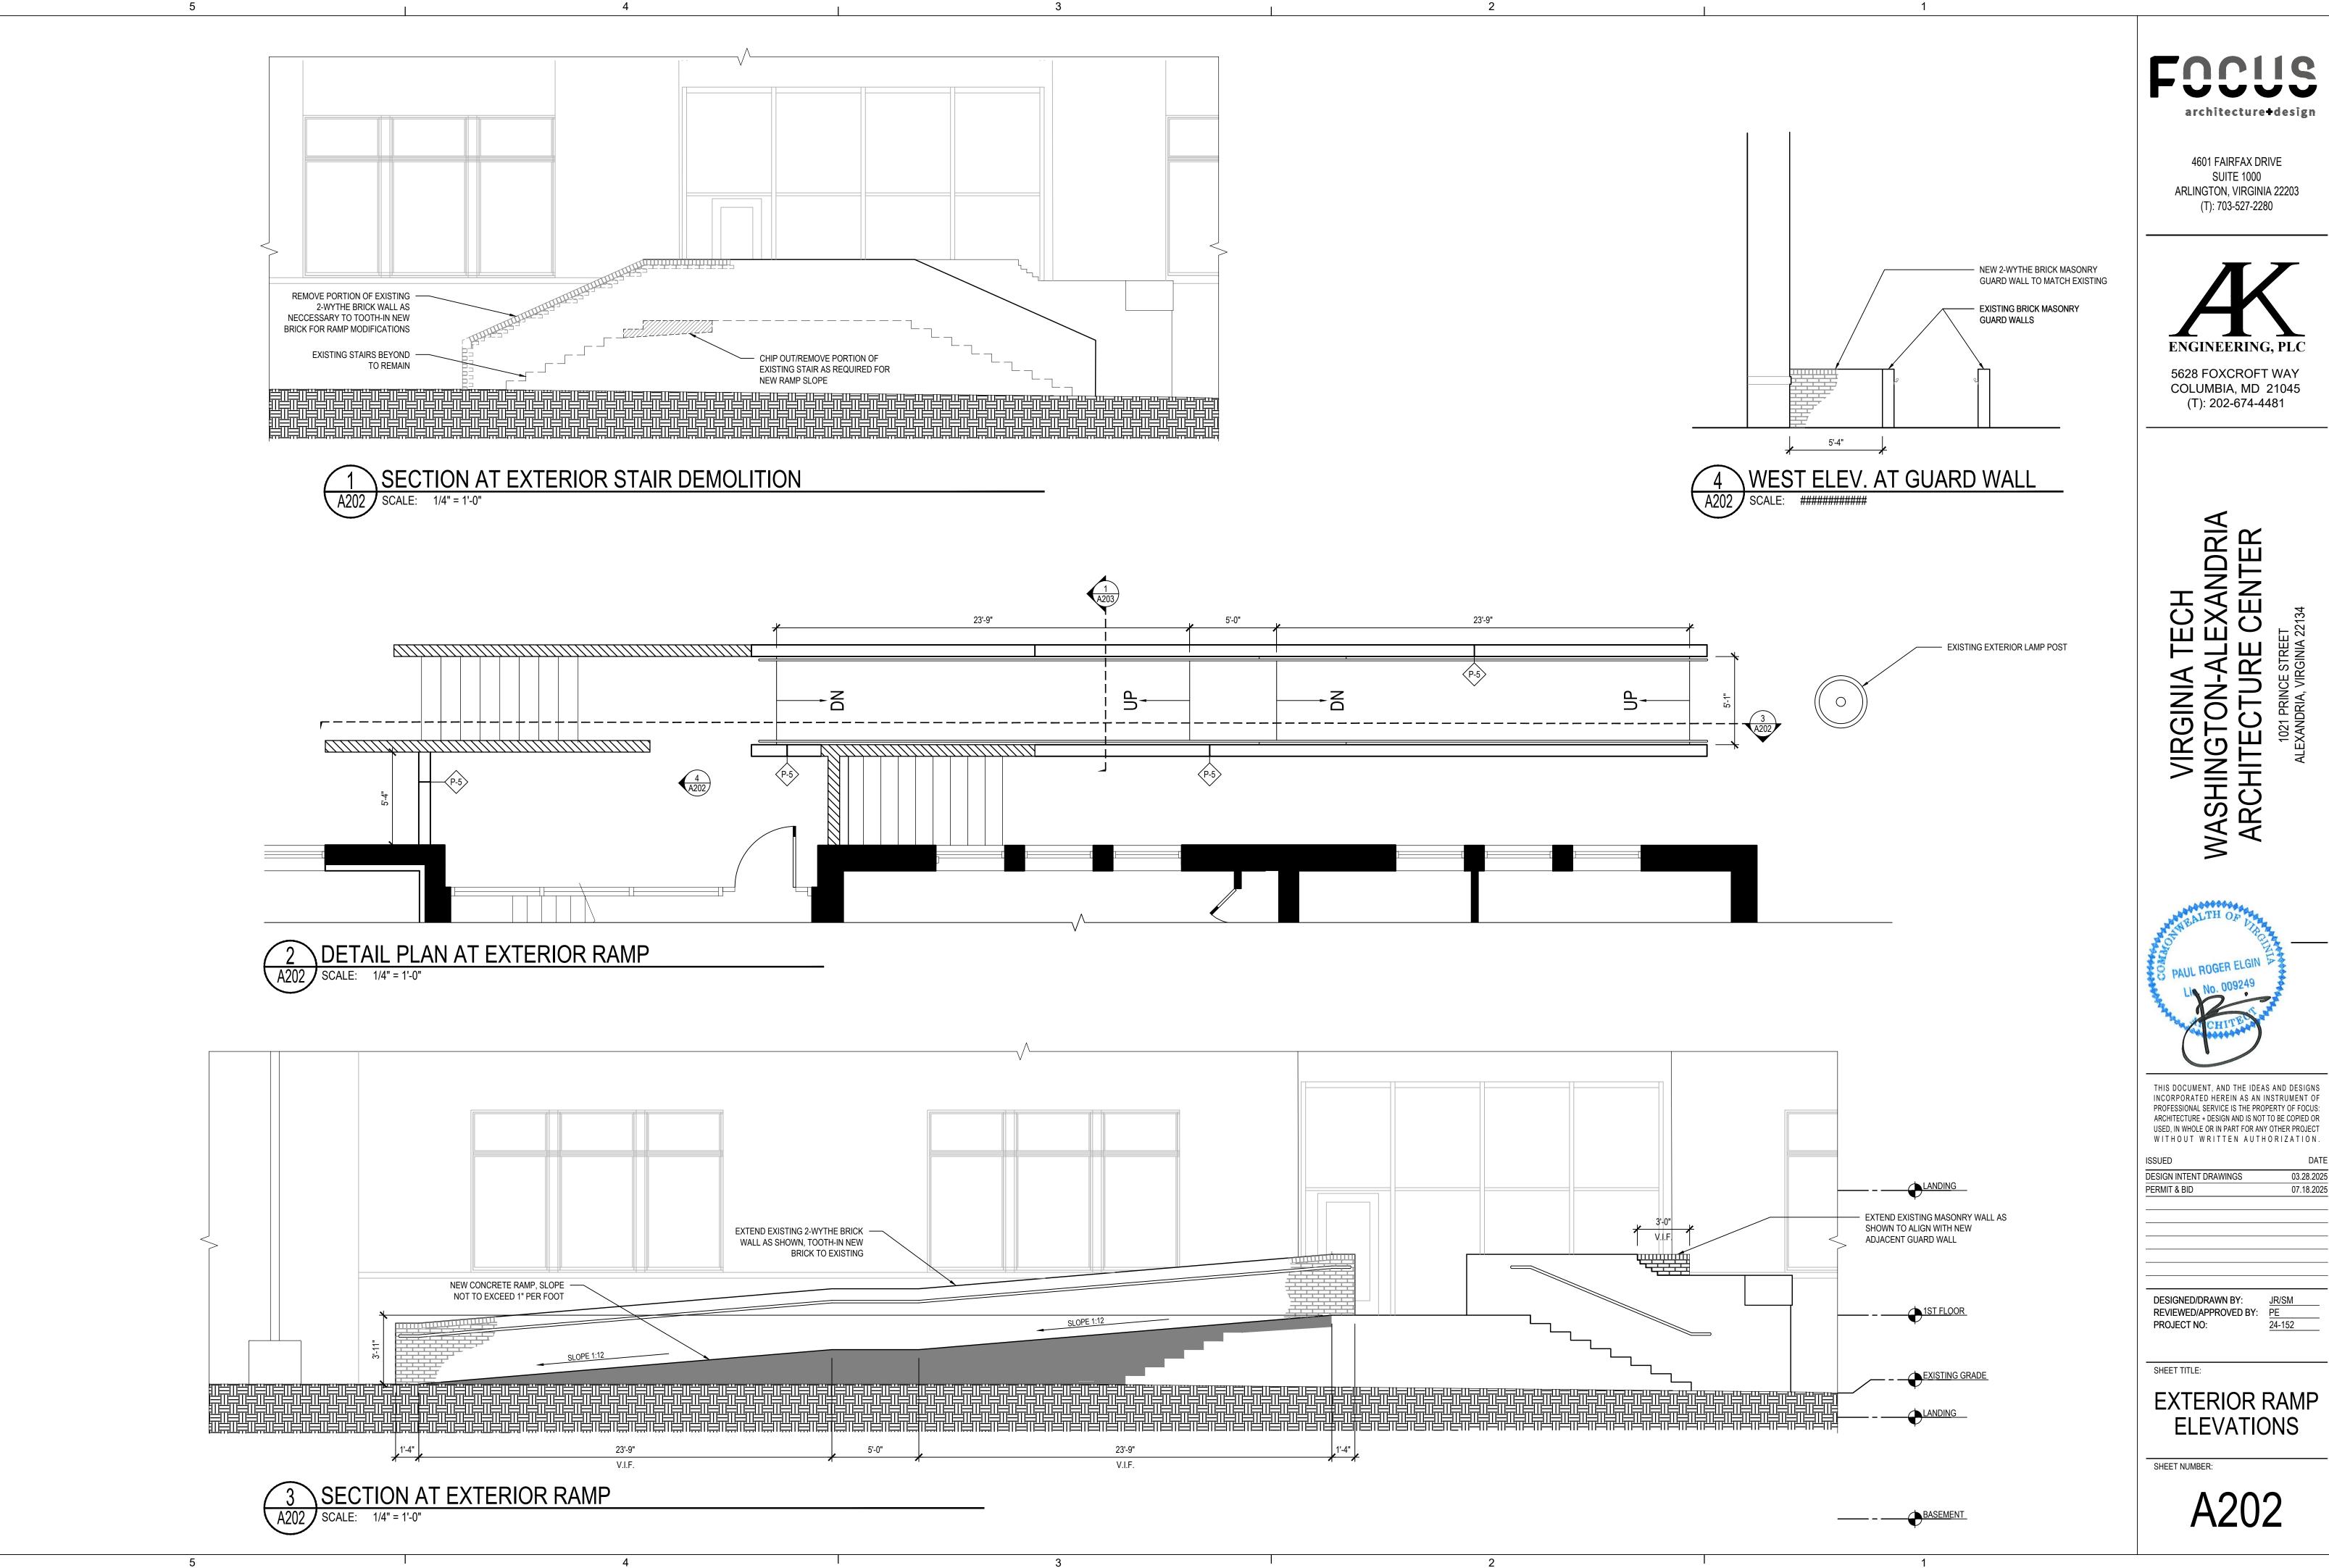
DESIGN INTENT DRAWINGS 03.28.2025 PERMIT & BID 07.18.2025

DESIGNED/DRAWN BY: REVIEWED/APPROVED BY: PE PROJECT NO:

SHEET TITLE:

**EXTERIOR ELEVATIONS** 





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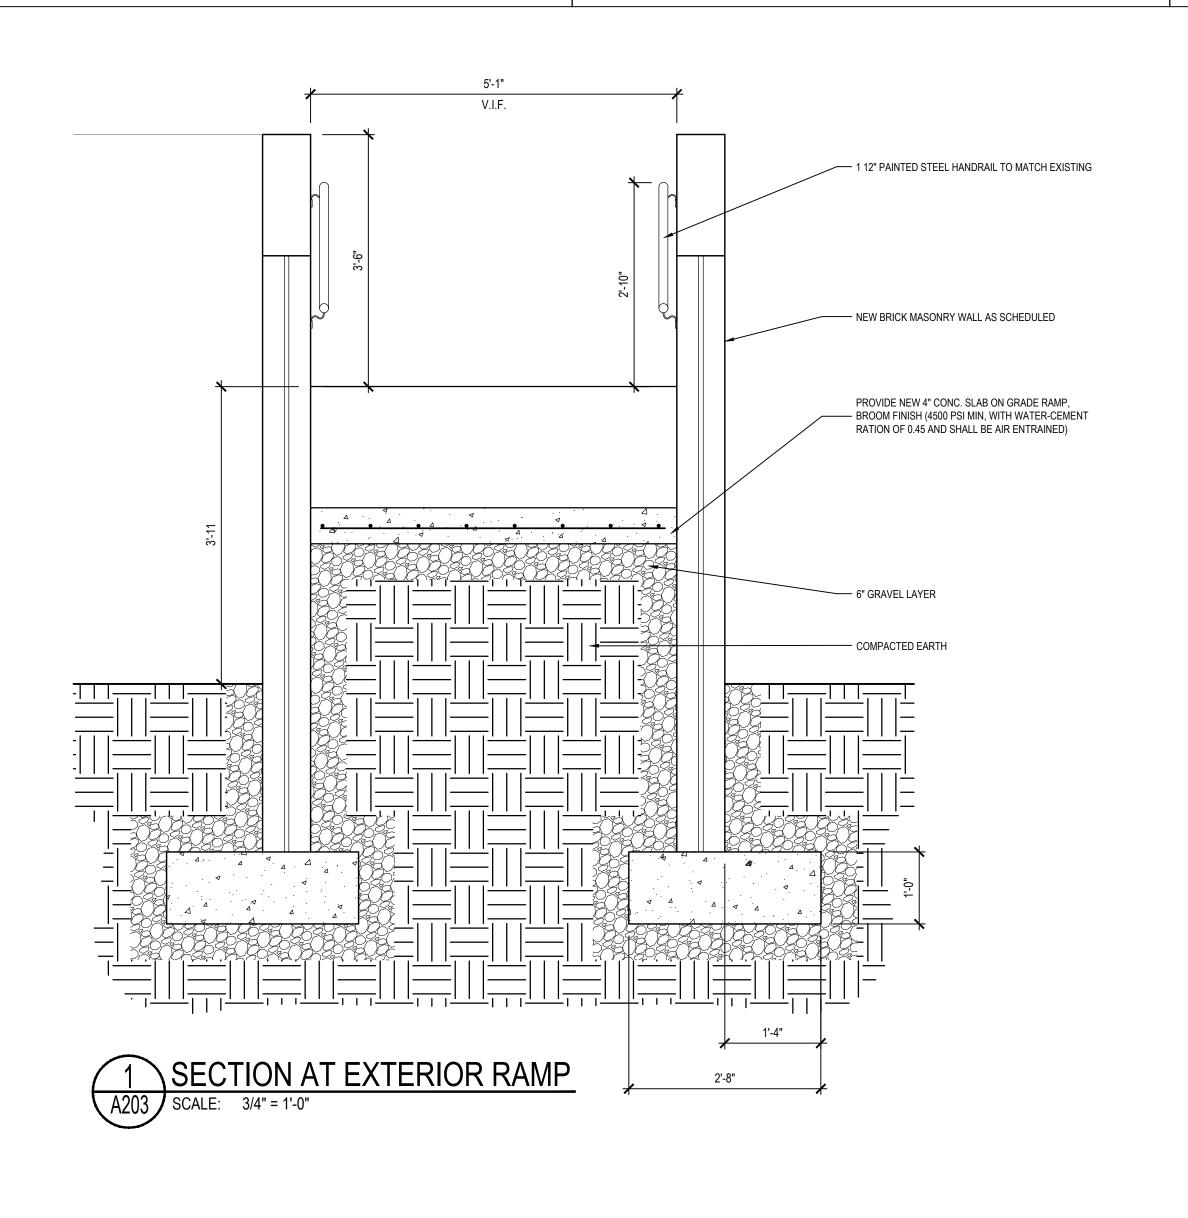
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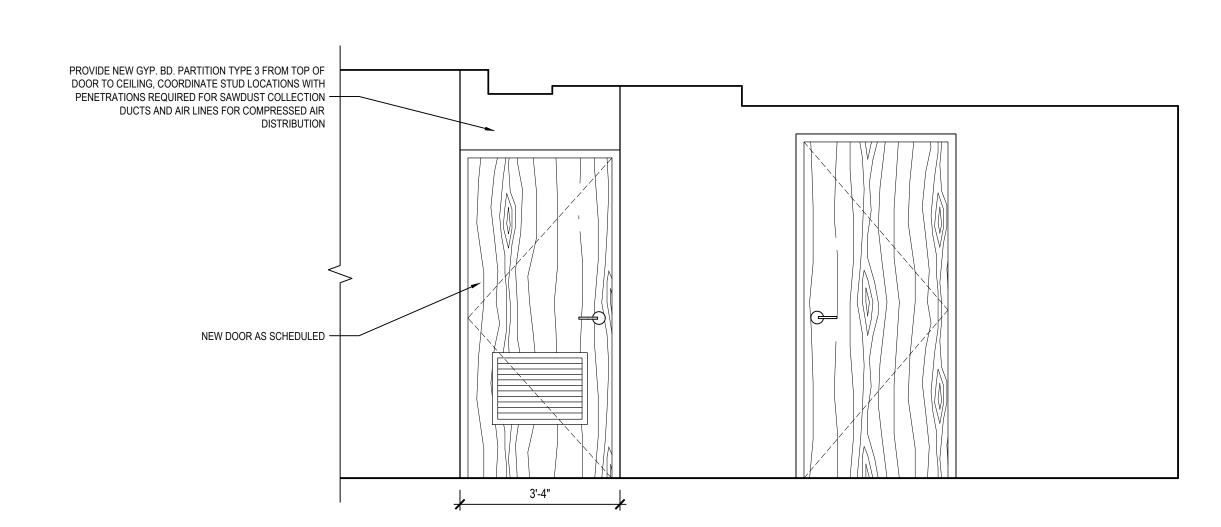


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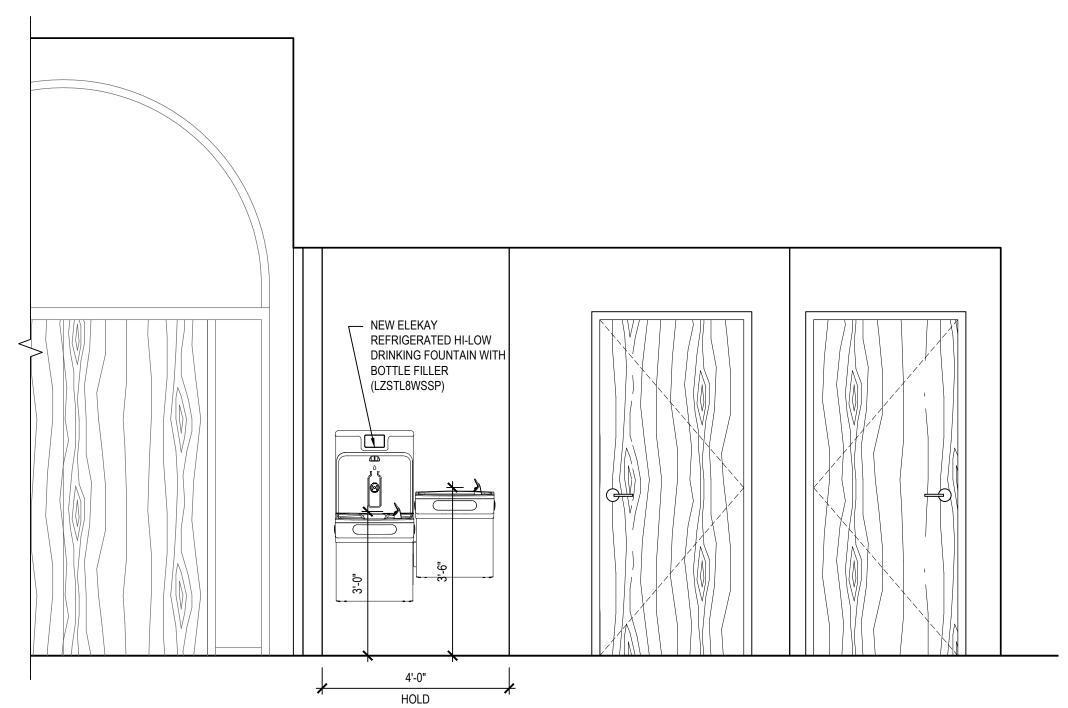
03.28.2025 07.18.2025

**ELEVATIONS** 






3 ELEVATION AT SAWDUST COLLECTION ROOM DOOR
A203 SCALE: 1/2" = 1'-0"



4

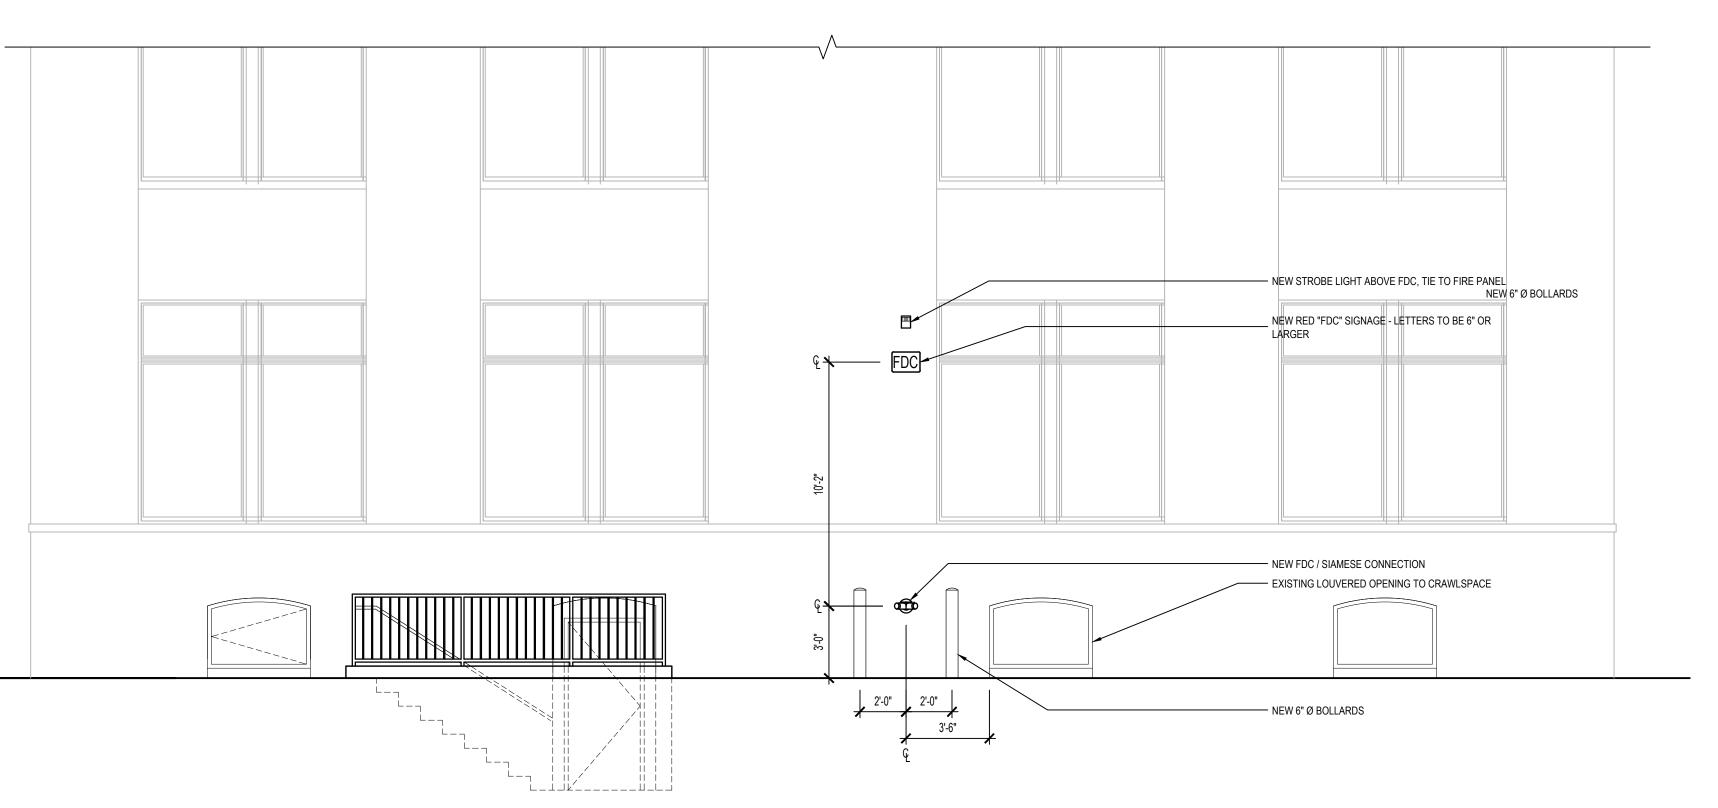

DETAIL AT ELECTRIC WATER COOLER

5

4 EAST ELEVATIONA AT EXTERIOR
A203 SCALE: 1/4" = 1'-0"

3

3

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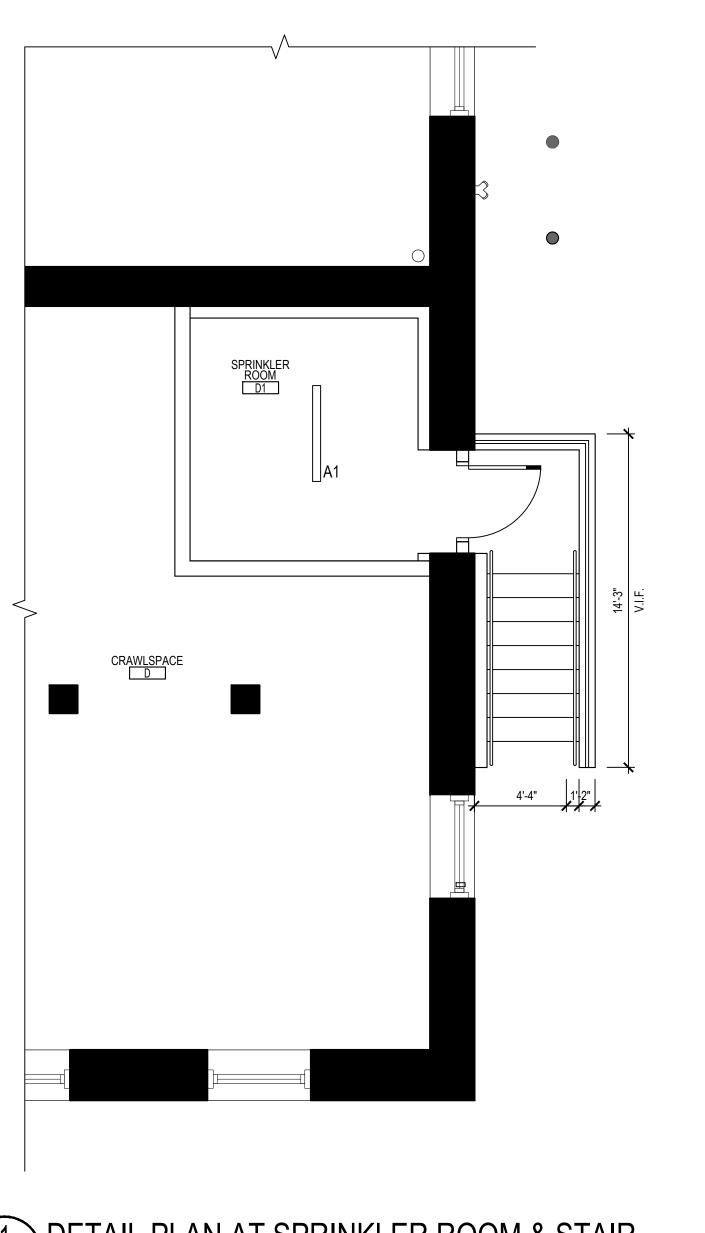
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DATE ISSUED DESIGN INTENT DRAWINGS 03.28.2025 PERMIT & BID 07.18.2025

DESIGNED/DRAWN BY: REVIEWED/APPROVED BY: PE PROJECT NO:


SHEET TITLE:

**ELEVATIONS** & DETAILS



DETAIL PLAN AT SPRINKLER ROOM & STAIR A204 SCALE: 1/4" = 1'-0"

5

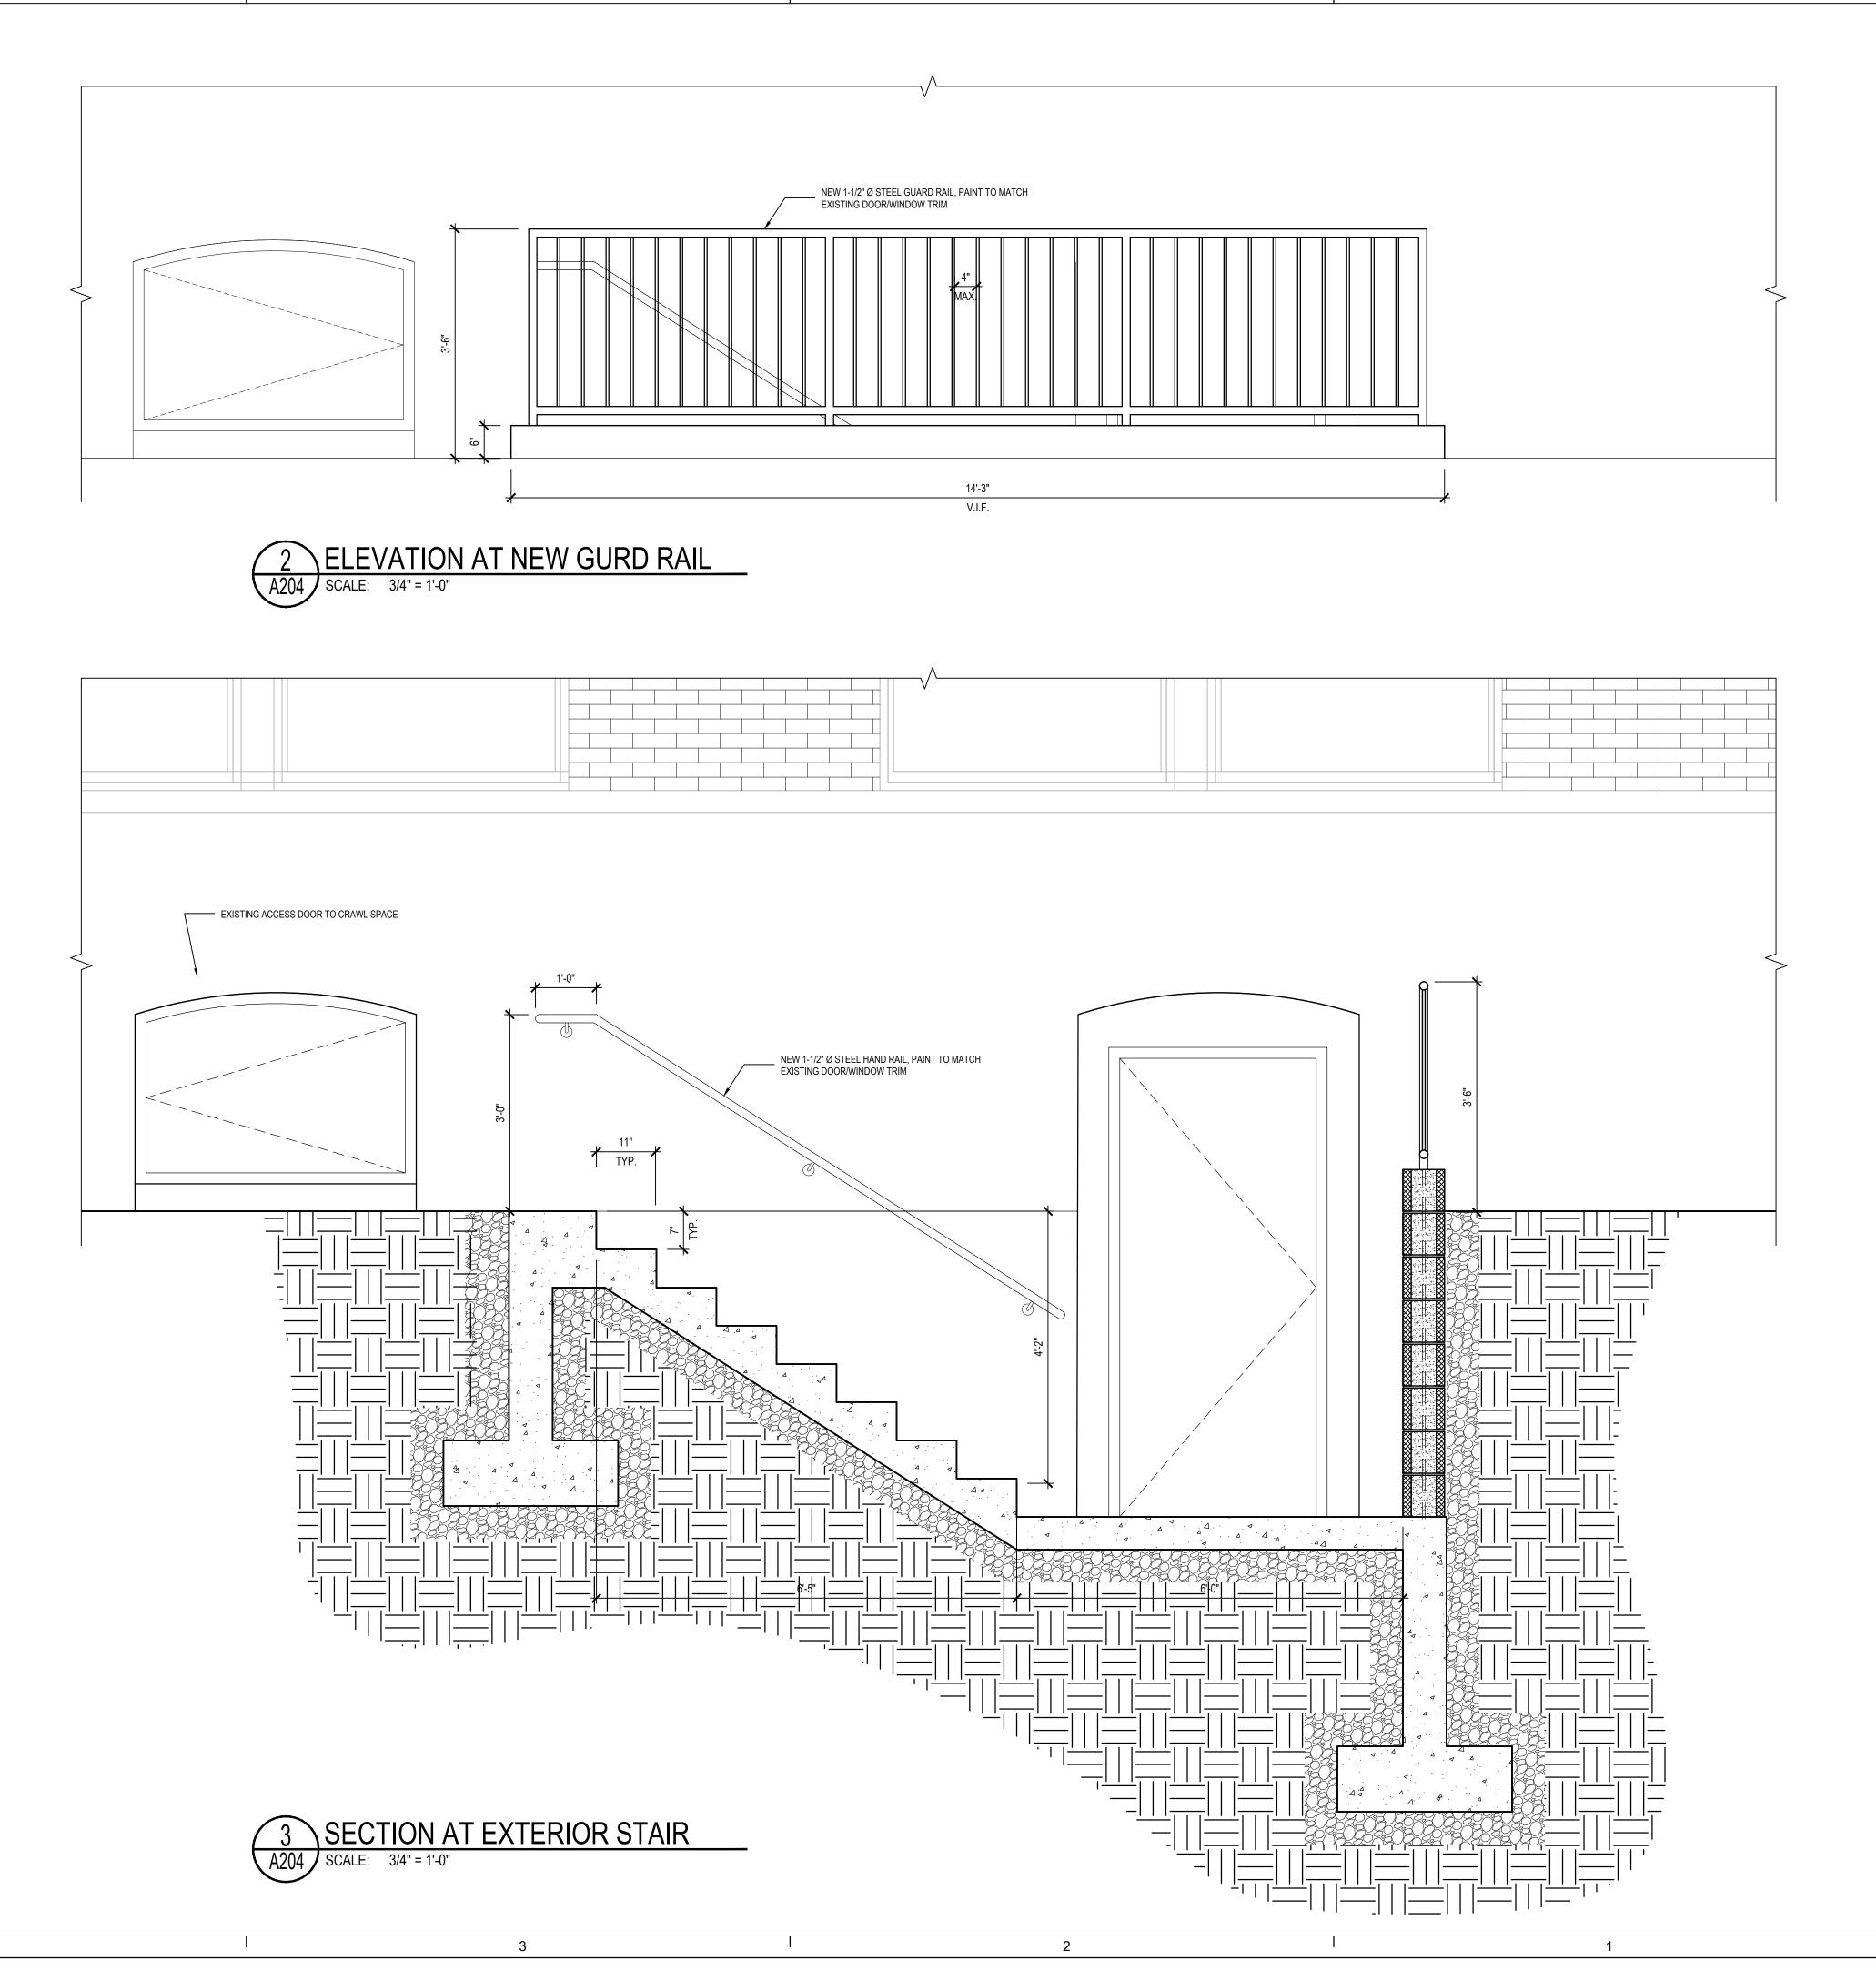

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DESIGN INTENT DRAWINGS 03.28.2025 PERMIT & BID 07.18.2025

DESIGNED/DRAWN BY: JR/SM REVIEWED/APPROVED BY: PE PROJECT NO: 24-152

SHEET TITLE:

EXTERIOR STAIR DETAILS

SHEET NUMBER:

HAZARDOUS MATERIALS ARE ENCOUNTERED, GENERAL CONTRACTOR SHALL CEASE WORK AND CONTACT THE BUILDING

- 2. BEFORE BEGINNING DEMOLITION, CONTRACTOR SHALL VERIFY UTILITY LINE LOCATIONS AND SERVICE. IF UNANTICIPATED
- 3. THE CONTRACTOR SHALL REMOVE ALL ITEMS SHOWN AS DASHED LINES ON THE DEMOLITION PLAN(S) UNLESS OTHERWISE NOTED.
- 4. THE CONTRACTOR SHALL BE RESPONSIBLE FOR THE INTEGRITY OF THE BUILDING STRUCTURAL, MECHANICAL, ELECTRICAL, PLUMBING AND FIRE SAFETY CONDITIONS UNCOVERED DURING DEMOLITION AND DURING NEW CONSTRUCTION WHICH ARE NOT ADDRESSED IN THE CONSTRUCTION DOCUMENTS.
- 5. SALVAGED ITEMS OF VALUE SHALL REMAIN THE PROPERTY OF THE TENANT AND WILL BE PLACED IN STORAGE ON SITE AS DESIGNATED BY THE TENANT. BUILDING MANAGEMENT RESERVES THE RIGHT TO HAVE ANY, ALL OR NONE OF THE REMOVED MATERIALS WHICH IS NOT REUSED IN NEW CONSTRUCTION TO BE RETURNED TO THE BUILDING MANAGER. THE G.C. IS RESPONSIBLE FOR COORDINATING THE LIST OF WHAT IS TO BE SAVED WITH THE BUILDING MANAGEMENT. ALL ITEMS TO BE REMOVED AND REUSED IN NEW CONSTRUCTION SHALL BE CAREFULLY REMOVED FREE OF DAMAGE AND STORED IN ONE AREA OF EACH FLOOR. INSPECT SALVAGED ITEMS AND REPORT ANY DAMAGE TO THE ARCHITECT. PREPARE AN INVENTORY OF ITEMS TO BE SALVAGED AND REUSED AND CONFIRM QUANTITIES INDICATED ON THE CONTRACTOR'S BID.
- 6. THE CONTRACTOR SHALL COORDINATE ALL DEMOLITION WORK WITH THE SUBCONTRACTORS TO BE AFFECTED BY THE
- . THE CONTRACTOR SHALL BRACE ALL ELEMENTS DURING DEMOLITION AND NEW CONSTRUCTION WHERE REQUIRED. THE CONTRACTOR SHALL RESTRUCTURE AND REFRAME ALL COMPONENTS DISTURBED DURING DEMOLITION AND NEW CONSTRUCTION IN ACCORDANCE WITH APPLICABLE CODES.
- 8. EXTENT OF WORK IS TO BE ASCERTAINED BY CONTRACTOR AT SITE VISIT AND SHALL BE SUFFICIENT TO ACCOMMODATE THE DEMOLITION SCOPE AS SHOWN
- ). BEFORE BEGINNING DEMOLITION, CONTRACTOR SHALL VERIFY UTILITY LINE LOCATIONS AND SERVICE. IF UNANTICIPATED HAZARDOUS MATERIALS ARE ENCOUNTERED, GENERAL CONTRACTOR SHALL CEASE WORK AND CONTACT THE BUILDING MANAGER IMMEDIATELY
- 10. ALL ITEMS TO BE REMOVED AND REUSED IN NEW CONSTRUCTION SHALL BE CAREFULLY REMOVED FREE OF DAMAGE AND STORED IN ONE AREA OF EACH FLOOR. INSPECT SALVAGED ITEMS AND REPORT ANY DAMAGE TO THE ARCHITECT. PREPARE AN INVENTORY OF ITEMS TO BE SALVAGED AND REUSED AND CONFIRM QUANTITIES INDICATED ON THE CONTRACTOR'S BID
- 11. THE CONTRACTOR SHALL STRICTLY ADHERE TO THE BUILDING RULES AND REGULATIONS CONCERNING ALLOWABLE HOURS FOR NOISY WORK AND SHALL COORDINATE REMOVAL OF ALL DEBRIS FROM THE SPACE WITH BUILDING
- 12. THE CONTRACTOR SHALL EXPOSE FRAMING PRIOR TO ANY DEMOLITION. DO NOT ENDANGER ANY EXISTING STRUCTURAL SYSTEM.
- 13.. THE CONTRACTOR SHALL NOTIFY ARCHITECT OF ANY STRUCTURAL IMPLICATIONS OF SCHEDULED DEMOLITION.
- 14. THE CONTRACTOR SHALL PROTECT EXISTING SURFACES AND FINISHES TO REMAIN, BOTH INSIDE THE AREA OF WORK AND ALONG THE PATH FROM THE EXTERIOR OF THE BUILDING TO THE AREA OF WORK. THE CONTRACTOR IS RESPONSIBLE FOR THE REPLACEMENT OF ITEMS/REPAIR OF ANY DAMAGE DUE TO CONSTRUCTION ACTIVITIES.
- 15. ANY EXISTING DUCT WORK, PIPING, PLUMBING AND CONDUITS TO BE ABANDONED SHALL BE REMOVED TO THE POINT OF ORIGIN AND CAPPED. NO SERVICES OR EQUIPMENT SHALL BE ABANDONED IN PLACE OR LEFT IN THE CEILING PLENUM. SEE ENGINEER'S DRAWINGS FOR EXTENT OF WORK.
- 16. THE CONTRACTOR SHALL CLEAN AREAS NOT IN CONTRACT OF DUST, DIRT, AND DEBRIS CAUSED BY DEMOLITION AND CONSTRUCTION OPERATIONS. ALL AREAS NOT IN CONTRACT SHALL BE RETURNED TO A CONDITION EXISTING PRIOR TO THE START OF WORK, INCLUDING ALL FINISHES.
- I7. THE CONTRACTOR SHALL ERECT TEMPORARY PARTITIONS AS REQUIRED TO SEPARATE THE AREA OF WORK FROM THE REST OF THE BUILDING IN ORDER TO CONTAIN DUST AND NOISE.
- 18. PRIOR TO ANY DEMOLITION, THE G.C. IS TO INVENTORY THE EXISTING PERIMETER WINDOW BLINDS, AND REPORT ANY DAMAGED BLINDS TO THE TENANT. THEN, THE G.C. IS TO PUT BLINDS IN OPEN POSITION, AND WRAP WITH PLASTIC.

# I. THE CONTRACTOR SHALL REMOVE ALL INTERIOR PARTITIONS INCLUDED UNDER DEMOLITION WORK AND AS NECESSARY

- TO ACCOMPLISH THE TOTAL SCOPE OF WORK. 2. THE CONTRACTOR SHALL REMOVE ALL EXISTING DOORS, FRAMES AND HARDWARE INCLUDED UNDER THE DEMOLITION WORK AND STORE IN A SAFE PLACE.
- 3. THE CONTRACTOR SHALL COORDINATE WITH THE CONSTRUCTION DRAWINGS FOR PARTITIONS TO REMAIN.
- 4. THE CONTRACTOR SHALL PATCH, TAPE, SAND SMOOTH AND PAINT ANY EXISTING TO REMAIN WALL SURFACES DISTURBED BY DEMOLITION ACTIVITIES. PAINT TO MATCH ADJACENT WALL SURFACES.
- THE CONTRACTOR SHALL REMOVE EXISTING FLOOR FINISHES INCLUDED UNDER DEMOLITION WORK AND AS NECESSARY
- 2. THE CONTRACTOR SHALL REMOVE ALL RESIDUAL RESIDUES AND ADHESIVES FROM THE FLOOR SLAB AS REQUIRED TO CREATE A SMOOTH AND LEVEL SURFACE FOR THE INSTALLATION OF NEW FLOORING MATERIALS AS SPECIFIED IN THE
- 3. THE CONTRACTOR SHALL REMOVE ALL ANCHORS, STUB-UPS, CONDUITS, ETC... NO LONGER IN USE. LARGE HOLES AND OR DAMAGE TO THE FLOOR SLAB SHALL BE PATCHED FLUSH WITH ADJACENT.

TO ACCOMPLISH THE TOTAL SCOPE OF WORK

- . THE CONTRACTOR SHALL REMOVE LIGHT FIXTURES, G.W.B. CEILINGS, ETC. INCLUDED UNDER DEMOLITION WORK AND AS NECESSARY TO ACCOMPLISH THE TOTAL SCOPE OF WORK.
- 2. THE CONTRACTOR SHALL REMOVE OR CUT EXISTING PLUMBING OR ELECTRICAL STUB UPS, BELOW SLAB SURFACE AND SHALL PREPARE FLOOR TO ACCEPT NEW SPECIFIED FLOOR FINISH.
- 3. THE CONTRACTOR SHALL REMOVE ANY ABANDONED EQUIPMENT, SERVICES, CABLING, ETC... ABOVE THE CEILING, NOTHING SHALL BE ABANDONED IN PLACE IN THE CEILING PLENUM.

I. THE CONTRACTOR SHALL REMOVE OR RELOCATE OR DEMOLISH THE EXISTING HVAC SYSTEM DUCT WORK AS SHOWN ON THE ENGINEER'S MECHANICAL DRAWINGS AND COORDINATE WITH NEW DIFFUSER FOR NEW DUCT WORK. REFER TO ENGINEER'S MECHANICAL DRAWINGS PRIOR TO START OF DEMOLITION WORK.

# ELECTRICAL

- . THE CONTRACTOR SHALL REMOVE ALL EXISTING ELECTRICAL WIRING, OUTLETS, ELECTRICAL PANELS, SPECIAL EQUIPMENT OUTLETS, CONNECTIONS AND SWITCHES IN DEMOLISHED AND FURRED-OUT WALLS INCLUDED UNDER THE DEMOLITION WORK. COORDINATE WORK WITH THE ENGINEER'S ELECTRICAL DRAWINGS.
- THE CONTRACTOR SHALL REFER TO THE ARCHITECTURAL DRAWING FOR EXTENT OF RENOVATION WORK.
- 3. THE CONTRACTOR SHALL REMOVE ALL BLANK PLATES THROUGHOUT THE SCOPE OF WORK; PATCH AND REPAIR EXISTING WALLS TO REMAIN FLUSH AND SMOOTH WITH EXISTING SURFACES
- 4. THE CONTRACTOR SHALL MAINTAIN CONTINUITY OF ALL CIRCUITS OUTSIDE THE DEMOLISHED AREA AFFECTED BY THE DEMOLITION. INTEGRITY TO OTHER AREAS SHALL NOT BE DAMAGED.
- 5. THE CONTRACTOR SHALL COMPLY AND COORDINATE ALL OTHER REQUIREMENTS WITH THE BUILDING OWNER/TENANT REPRESENTATIVE AND BUILDING ENGINEERS PRIOR TO THE START OF THE PROJECT. MISCELLANEOUS ITEMS
- THE CONTRACTOR SHALL PROTECT OR COVER EXISTING WALLS AND FLOOR FINISHES TO REMAIN NEAR DEMOLITION AND CONSTRUCTION AREAS. THE CONTRACTOR SHALL PATCH AND REPAIR OR PROVIDE NEW ANY FINISHES TO REMAIN DAMAGED DURING CONSTRUCTION

# **GENERAL PROJECT NOTES**

- THE CONTRACTOR SHALL VISIT SITE AND VERIFY ALL DIMENSIONS. GRADES AND ALL OTHER CONSTRUCTION CONDITIONS BEFORE THE BID. THE CONTRACTOR SHALL BE HELD RESPONSIBLE FOR A THOROUGH KNOWLEDGE OF ALL OBSERVABLE BUILDING CONDITIONS & SYSTEMS. THE CONTRACTOR SHALL IMMEDIATELY REPORT ANY DISCREPANCIES UNCOVERED TO THE ARCHITECT
- THE CONTRACTOR SHALL SECURE AND PAY FOR ALL PERMITS, FEES, LICENSES AND INSPECTIONS NECESSARY FOR A PROPER COMPLETION OF ALL WORK REQUIRED BY THESE DOCUMENTS. ALL (SUB) CONTRACTORS MUST VISIT THE PROJECT TO FAMILIARIZE THEMSELVES WITH SITE CONDITIONS PRIOR TO BIDDING OR CONSTRUCTION, OTHERWISE THE BID WILL SUBJECT TO FORFEITURE AFTER BIDS ARE RECEIVED.
- ALL WORK SHALL CONFORM TO ALL APPLICABLE BUILDING CODES AND ORDINANCES OF CITY OF ALEXANDRIA AND THE STATE OF VIRGINIA. CABO ANSI A117.1-2017. AND VCC 2021. THE RULES AND REGULATIONS OF OSHA SHALL BE ADHERED TO FOR THIS PROJECT.
- WORK SHALL INCLUDE ALL LABOR, ASSEMBLIES, AND FINISH WORK INCLUDING ALL PARTS AND

MATERIALS NECESSARY TO PROVIDE FOR A COMPLETE INSTALLATION.

- THE CONTRACTOR IS RESPONSIBLE FOR CONSTRUCTION MEANS, METHODS, TECHNIQUES, SEQUENCES AND PROCEDURES, AND FOR THE COORDINATION OF WORK AND FOR THE WORK PERFORMED BY HIS SUBCONTRACTORS.
- . THE CONTRACTOR SHALL VERIFY THAT DRAWINGS ARE THE LATEST ISSUE PRIOR TO COMMENCING
- DO NOT SCALE DRAWINGS. CLARIFICATION OR INFORMATION REQUIRED BY THE CONTRACTOR SHALL BE FURNISHED, UPON WRITTEN REQUEST, BY THE OWNER.
- DIMENSIONS ARE FROM FINISHED FACE TO FINISHED FACE UNLESS NOTED OTHERWISE.
- 2. ALL DIMENSIONS, NOTES, FINISHES, AND FIXTURES SHOWN ON TYPICAL PLANS, SECTIONS OR DETAILS SHALL APPLY TO ALL SIMILAR SYMMETRICAL OR OPPOSITE HAND PLANS, SECTIONS, OR DETAILS, EXCEPT AS NOTED. ALL NOTES, MATERIALS, AND DETAILS SHALL GOVERN SUBSEQUENT SECTIONS AND DETAILS DRAWN FOR EXPLANATORY PURPOSES.
- 10. CONTRACTOR SHALL SUBMIT PRODUCT DATA & SHOP DRAWINGS FOR ARCHITECT REVIEW AND APPROVAL INCLUDING SUBMITTALS ORDER AND SCHEDULE DELIVERY OF MATERIALS IN AMPLE TIME TO AVOID DELAYS IN CONSTRUCTION. SHOP DRAWINGS SHALL BE SUBMITTED IN A FORM OF THREE (3) SETS OF PRINTS. IF AN ITEM IS FOUND TO BE UNAVAILABLE OR TO HAVE A LONG LEAD TIME, THE GENERAL CONTRACTOR SHALL NOTIFY THE ARCHITECT IMMEDIATELY WITH A PROPOSED ALTERNATIVE.
- I. PERFORM ALL WORK AND INSTALL MATERIALS IN STRICT ACCORDANCE WITH MANUFACTURERS SPECIFICATIONS AND INSTRUCTIONS AND IN A MANNER CONSISTENT WITH INDUSTRY STANDARDS OF WORKMANSHIP. FABRICATION SHALL BEGIN ONLY AFTER OWNER'S REVIEW AND APPROVAL OF SHOP DRAWINGS.
- 12. CONTRACTOR SHALL VERIFY EXTENT OF ENGINEERING DRAWINGS WITH ARCHITECT PRIOR TO CONSTRUCTION / BIDDING.
- 13. REQUESTS FOR SUBSTITUTIONS OF SPECIFIED ITEMS SHALL BE SUBMITTED IN WRITING WITHIN TEN (10) WORKING DAYS OF THE AWARD OF THE CONTRACT FOR CONSTRUCTION TO THE OWNER AND WILL BE CONSIDERED ONLY IF THEY PROVIDE BETTER SERVICES, HAVE A MORE ADVANTAGEOUS DELIVERY DATE, OR HAVE A LOWER PRICE PROVIDING A CREDIT TO THE OWNER AND WILL NOT SACRIFICE QUALITY, APPEARANCE OR FUNCTION. UNDER NO CIRCUMSTANCES WILL THE OWNER BE REQUIRED TO PROVE THAT A PRODUCT PROPOSED FOR SUBSTITUTION IS OR IS NOT OF EQUAL QUALITY TO THE SPECIFIED PRODUCT.
- CONTRACTOR SHALL PROVIDE ALL MISCELLANEOUS BLOCKING, FRAMING FASTENERS, CLIPS, ADHESIVES AND SEALANTS AS REQUIRED FOR COMPLETION OF DETAILS EVEN THOUGH NOT SPECIFICALLY INDICATED ON DRAWINGS. DETAILS ARE NOT INTENDED TO SPECIFICALLY DIRECT CONTRACTOR AS TO METHOD OF FRAMING OR SUPPORT.
- 15. WOOD MATERIALS SHALL MEET ALL APPLICABLE CODES. THEY SHALL BE FIRE RETARDANT TREATED IN ACCORDANCE WITH LOCAL BUILDING CODES.
- 16. U.O.N. ALL PIPES AND WIRING SHALL BE CONCEALED AND LOCATED WITHIN THE CEILING PLENUM. WALL THICKNESS. OR OTHER FURRED LOCATIONS, AS INDICATED ON THE PLANS, PROVIDE URRING AROUND DUCTWORK,PIPING, ETC. WITH MATERIAL TO MATCH SURROUNDING FINISHES. COORDINATE ATYPICAL SITE CONDITIONS WITH ARCHITECT PRIOR TO ENCAPSULATION.
- 17. CONSULT ELECTRICAL, MECHANICAL, AND PLUMBING DRAWINGS FOR LOCATION OF OPENINGS OR RECESSES FOR PANELS, FIXTURES, LOUVERS, DUCTS, ETC. PROVIDE SUCH PANELS AS
- 18. ALL DUCT PENETRATIONS THROUGH WALLS, RATED OR OTHERWISE, SHALL BE FULLY FRAMED AND SEALED AT PERIMETER.
- 19. ALL OPENINGS PENETRATING ROOF SHALL BE THOROUGHLY FLASHED AND SEALED TO ENSURE WATERPROOF SEAL.
- 20. ANY AND ALL MATERIALS AND INSTALLATION METHODS USED IN THE MODIFICATION OF THE EXISTING ROOF SYSTEM SHALL BE IN CONFORMANCE WITH THE REQUIREMENTS OF THE ROOF
- 21. THE CONTRACTOR SHALL NOT PROCEED WITH WORK FOR WHICH HE EXPECTS ADDITIONAL COMPENSATION BEYOND THE CONTRACT AMOUNT WITHOUT WRITTEN AUTHORIZATION FROM THE
- 22. THE CONTRACTOR SHALL COORDINATE WORK WITH OWNER INCLUDING BUT NOT LIMITED TO SCHEDULING TIME AND LOCATIONS FOR DELIVERIES, BUILDING ACCESS & BUILDING FACILITIES, AND SHALL REVIEW AND ABIDE BY ALL APPLICABLE LANDLORD RULES AND REGULATIONS.
- 23. THE CONTRACTOR SHALL IDENTIFY DELIVERY TIMES FOR ALL ITEMS AND PLACE THE ORDERS FOR THE LONG LEAD TIME ITEMS SO AS NOT TO DELAY THE PROJECT.
- 24. THE CONTRACTOR SHALL BE RESPONSIBLE FOR ADEQUATELY BRACING AND PROTECTING WORK DURING CONSTRUCTION AGAINST DAMAGE, BREAKAGE, COLLAPSE, DISTORTION, AND/OR MISALIGNMENT IN ACCORDANCE WITH APPLICABLE CODES, STANDARDS, AND GOOD PRACTICE.
- 25. WORK AND/OR CONSTRUCTION OPERATIONS SHALL NOT UNDERMINE THE STRUCTURAL INTEGRITY OF THE BUILDING.
- 26. WORK AREAS SHALL REMAIN SECURE AND LOCKABLE DURING CONSTRUCTION. THE CONTRACTOR SHALL PROVIDE, WHERE NECESSARY, TEMPORARY LOCKABLE DOORS TO PROVIDE THE OWNER & TENANT'S CONSTANT ACCESS TO SPACES NOT UNDER CONSTRUCTION. CONTRACTOR SHALL PROVIDE KEYS FOR TEMPORARY DOORS.
- 27. THE CONTRACTOR SHALL COORDINATE AND SCHEDULE WORK BY OTHERS INCLUDING BUT NOT LIMITED TO TELEPHONE, DATA AND "FURNISHED-AND/OR-INSTALLED-OWNER-PROVIDED" ITEMS. CONTRACTOR SHALL COORDINATE EXACT LOCATIONS AND SHALL DO THE CUTTING, FITTING, AND PATCHING THAT MAY BE REQUIRED TO MAKE THE PARTS OF THE WORK WHICH WILL RECEIVE THE WORK OF OTHERS AS SHOWN OR REASONABLY IMPLIED BY THE DRAWINGS AND SPECIFICATIONS.
- 28. CONTACT ARCHITECT FOR CLARIFICATION IF EXISTING OUTLET HEIGHTS OR LOCATIONS DO NOT MATCH THAT INDICATED IN THE ELECTRICAL DRAWINGS. REPLACE EXISTING ELECTRICAL DEVICES AND COVER PLATES TO MATCH THOSE SPECIFIED. CONTACT THE ARCHITECT PRIOR TO PROCEEDING WITH REPLACEMENT.
- 29. THE CONTRACTOR SHALL USE AND PROTECT THE EXISTING BUILDING AND EXISTING FINISHES SCHEDULED TO REMAIN IN A MANNER WHICH WILL NOT SOIL, DEFACE OR DAMAGE THE EXISTING FACILITIES, FINISHES OR FIXTURES IN ANY FASHION. PROVIDE PROTECTIVE MATERIALS AS NECESSARY. DAMAGE BY THE CONTRACTOR SHALL BE REPAIRED OR REPLACED BY THE CONTRACTOR TO THE COMPLETE SATISFACTION OF AND AT NO COST TO THE OWNER. AFTER ANY WORK HAS BEEN COMPLETED WITHIN ANY OCCUPIED SPACE(S), THE CONTRACTOR SHALL CLEAN THE SPACE OF ALL CONSTRUCTION DUST, TOOLS, STAINS AND DEBRIS.
- 30. THE CONTRACTOR SHALL PROTECT THE BUILDING PREMISES AND OCCUPANTS ON THE PROJECT SITE FROM DAMAGE. THE CONTRACTOR SHALL PROVIDE AND MAINTAIN NECESSARY COVERINGS, BOARDS, TEMPORARY PARTITIONS, AND DOORS AS REQUIRED TO PROTECT EXISTING WORK. MATERIALS, AND FINISHES TO REMAIN AT THE JOB SITE. THE CONTRACTOR SHALL BE HELD RESPONSIBLE FOR DAMAGES ATTRIBUTABLE TO HIS OPERATION, REPAIRS, OR REPLACEMENT WITHOUT ADDITIONAL CHARGE TO THE PARTY AFFECTED.
- 31. REMOVE ALL CONSTRUCTION DEBRIS AS REQUIRED TO MAINTAIN A CLEAN ENVIRONMENT AND TO

# PREVENT THE POSSIBILITY OF ACCIDENT OR FIRE.

- . IMMEDIATELY PRIOR TO THE OCCUPANCY OF ANY PHASE, THE CONTRACTOR SHALL CLEAN SURFACES OF DUST, DEBRIS, LOOSE CONSTRUCTION MATERIAL AND EQUIPMENT AND SHALL LEAVE FLOORS VACUUMED AND CLEAN. REMAINING CONSTRUCTION MATERIAL AND EQUIPMENT, IF ANY, SHALL BE MOVED AND TEMPORARILY SECURED IN AN AREA DIRECTED BY THE OWNER.
- 33. THE CONTRACTOR SHALL CLEAN WINDOWS AND WINDOW COVERINGS IMMEDIATELY PRIOR TO OCCUPANCY.
- PRIOR TO FINAL PAYMENT, THE CONTRACTOR SHALL ASSEMBLE ORIGINAL COPIES OF ALL NEW EQUIPMENT AND MATERIALS WARRANTIES AND OPERATIONAL INFORMATION AND DELIVER TO THE TENANT OR BUILDING MANAGER (AS APPROPRIATE) IN A NEATLY INDEXED AND LABELED 3-RING
- 35. ALL MATERIALS AND SYSTEMS SHALL BE INSTALLED AS PER MANUFACTURER'S SPECIFICATIONS AND ALL CONSTRUCTION SHALL BE OF INDUSTRY STANDARD OR BETTER. THE ARCHITECT SHALL BE ULTIMATE JUDGE OF QUALITY.
- . CONTRACTOR SHALL VERIFY THAT NO CONFLICTS EXIST IN LOCATIONS OF ANY AND ALL MECHANICAL, TELEPHONE, ELECTRICAL, PLUMBING AND SPRINKLER EQUIPMENT (TO INCLUDE ALL PIPING, DUCT WORK, SPRINKLERS STRUCTURAL MEMBERS AND CONDUIT) AND THAT ANY CLEARANCES FOR INSTALLATION AND MAINTENANCE OF ABOVE EQUIPMENT IS PROVIDED. ELEMENTS IN CONFLICT SHALL BE DETERMINED AND REVIEWED WITH THE ARCHITECT PRIOR TO WORK PROCEEDING. CONTRACTOR TO COORDINATE NEW WORK WITH EXISTING CONDITIONS.
- . NOTIFY ARCHITECT OF ANY ACCESS PANELS WHICH MAY BE REQUIRED BEFORE PROCEEDING WITH THE WORK. NO ACCESS PANELS SHALL BE INSTALLED IN GWB CEILINGS WITHOUT ARCHITECT'S REVIEW AND APPROVAL. CONTRACTOR SHALL BE RESPONSIBLE FOR COORDINATING ALL TRADES. REQUIRED ACCESS PANELS SHALL BE INCLUDED IN THE CONTRACTOR'S SCOPE. ( REFER TO DRYWALL SECTION FOR ACCESS PANEL NOTES)
- 38. PROVIDE PROTECTION FOR EXISTING FINISHES TO REMAIN, INCLUDING RESTROOMS, LOBBIES AND CORRIDORS AND REPAIR DAMAGES AS A RESULT OF ANY DEMOLITION OR CONSTRUCTION. DOCUMENT ANY EXISTING CONDITIONS OR DAMAGES PRIOR TO THE START OF CONSTRUCTION.
- ALL EXISTING DAMAGES TO FIRE RATED CONSTRUCTION SHALL BE REPAIRED AND/OR REPLACED BY THE CONTRACTOR TO MATCH EXISTING RATED CONDITIONS, PATCH ALL DRYWALL HOLES APPROPRIATELY AND SMOOTH ROUGH SURFACES.
- 40. THE ARCHITECT AND LANDLORD SHALL BE NOTIFIED WHEN FIELD CONDITIONS NECESSITATE CHANGES TO CRITICALLY DIMENSIONED PARTITIONS AND MILLWORK LOCATIONS. REVISED LOCATIONS SHALL BE CHALKED FOR SITE INSPECTION PRIOR TO FABRICATION & INSTALLATION.
- 41. ALL NEW OPENINGS RECEIVING DOOR FRAMES SHALL RECEIVE DOUBLE STUDS FLOOR TO BOTTOM OF STRUCTURE ABOVE, AT EACH SIDE OF OPENING.
- 42. FLOOR SLAB SHALL BE FLASH PATCHED SMOOTH AND READY TO ACCEPT NEW FLOOR FINISH. CONTRACTOR SHALL INSTALL PATCHING COMPOUND OR SELF LEVELING UNDERLAYMENT INSTALLED PER MANUFACTURER'S RECOMMENDATIONS. ANY ABANDONED OPENINGS AND EXISTING GAPS IN THE STRUCTURAL SLAB ABOVE AND BELOW SHALL BE STRUCTURALLY FILLED. PATCHED AND PROPERLY SEALED TO MEET EXISTING SLAB FIRE RATING REQUIREMENTS.
- 13. ALL VERTICAL DIMENSIONS TO BE MADE FROM THE HIGHEST POINT OF FLOOR SLAB TO ENSURE PROPER ALIGNMENT OF ALL DOORS, BULKHEADS, CEILINGS, ETC.
- 44. ALL PENETRATIONS TO FIRE RATED ASSEMBLIES OF WALLS, INCLUDING SLAB CUTTING REQUIRED FOR WORK SHOWN ON THE DRAWINGS FOR PIPES, OR CONDUIT SHALL BE PROVIDED WITH FIRE STOPPING MATERIAL TO MEET UL RATING REQUIREMENTS. CONTRACTOR SHALL COORDINATE PENETRATIONS WITH MECHANICAL, ELECTRICAL, PLUMBING AND STRUCTURAL INFORMATION FOR REQUIRED CUT-OUT SIZES, SLAB THICKNESS, REINFORCING AND SUB GRADE PREPARATION.
- 5. CONTRACTOR SHALL COORDINATE ALL DIMENSIONS, DETAILS, FINISHES, EQUIPMENT, POWER AND SPECIFICATIONS WITH MILLWORK, ELECTRICAL, AND COMMUNICATION SUBCONTRACTOR. DISCREPANCIES FOUND IN DRAWINGS BETWEEN ARCHITECTURE, ENGINEERING OR SITE CONDITIONS SHALL NOTIFY THE ARCHITECT PRIOR TO PROCEEDING WITH WORK.
- 46. WHERE DIMENSIONS ARE OMITTED ON DRAWINGS, REFER TO LARGE SCALE DRAWINGS, AS NOTED. LOCATE NEW WALLS. PARTITIONS OR OTHER FEATURES AS INDICATED OR IN SELF-EVIDENT POSITION (I.E. ALIGNED WITH FACE OR EXISTING WALLS, PARTITION OR COLUMN, CENTERED ON OPENINGS, COLUMNS, MULLIONS OR SPACE, ETC.) NOTIFY ARCHITECT OF ANY DISCREPANCIES. USE SAFB AT SOUND AND FIRE RATED PARTITIONS ONLY
- 47. ALL PARTITIONS SHALL BE ERECTED AS INDICATED IN PARTITION TYPES USING SPECIFIED STUD SIZE. SPACING. AND DEFLECTION LIMITS AS RECOMMENDED BY MANUFACTURER INCLUDING CONCEALED SUPPORT BLOCKING AND SOUND ATTENUATION BLANKETS.
- 48. UNLESS NOTED OTHERWISE. GENERAL CONTRACTOR SHALL "X-RAY" CONCRETE SLAB AT ALL LOCATION WHERE NEW CORE DRILLS ARE SPECIFIED. CONTRACTOR SHALL LOCATE NEW CORE DRILLS BETWEEN EXISTING STEEL BARS. IF AFTER REVIEW OF X-RAYS, NEW CORE DRILL LOCATIONS REQUIRE CUTTING OF REINFORCING STEEL BARS, CONTRACTOR SHALL CONSULT WITH THE BUILDING'S STRUCTURAL ENGINEERS BEFORE ANY RE-BARS ARE CUT.
- IP. CONTRACTOR SHALL PROVIDE AND INSTALL ALL NEW FRAMES, DOORS, AND HARDWARE IN ACCORDANCE WITH MANUFACTURER INSTRUCTION AND SPECIFICATIONS USING PROPER TEMPLATES AND INSTRUCTION SHEETS
- WHERE ELECTRICAL FIXTURES OR EQUIPMENT AND THE LIKE OCCUR IN THE MILLWORK, GENERAL CONTRACTOR SHALL PROVIDE ROUGH-INS FOR THESE ITEMS AND SHALL COORDINATE INSTALLATION WITH WALL ELEVATIONS AND EQUIPMENT REQUIREMENTS TO ASSURE PROPER LOCATION.
- LOCATE INSIDE EDGE OF ALL DOOR FRAMES 6" (152MM) FROM THE ADJACENT, PERPENDICULAR PARTITION, U.O.N. ALL DOORS SIZES, AND APPROACH SHALL BE IN ACCORDANCE WITH IBC AND ANSI A117.1, FOR ACCESSIBILITY REQUIREMENTS.

# SPECIAL GENERAL CONTRACTOR NOTE

THE GC SHALL DISSEMINATE ALL SETS OF **ALL PLANS TO ALL PROPOSED SUBCONTRACTORS** FOR BID PURPOSES. AFTER AWARD, THE GC SHALL DISSEMINATE ALL SETS OF ALL REVISED PLANS TO AWARDED/APPROVIED SUBCONTRACTORS FOR COORDINATION PURPOSES.

DURING THE BID PROCESS, QUESTIONS MAY BE RAISED THAT IMPACT ONE TRADE OR ANOTHER, AND THEREFORE, ALL SHEETS MUST BE REVIEWED FOR APPROPRIATE TRADES AND COORDINATION.

# **GENERAL PROJECT NOTES**

- 1. ALL SUBMITTALS SHALL BE CHECKED BY THE G.C. FOR COMPLIANCE WITH THE CONTRACT DOCUMENTS PRIOR TO SUBMITTING THEM TO THE ARCHITECT FOR REVIEW. THE G.C. SHALL NOTIFY THE ARCHITECT OF ANY CONFLICTS BETWEEN TRADES PRIOR TO COMMENCING ANY FABRICATION OR OF PURCHASING ANY ITEMS.
- THE G.C. SHALL SUBMIT SHOP DRAWINGS FOR REVIEW BY ARCHITECT IN ACCORDANCE WITH THE REQUIREMENTS OF THE CONTRACT DOCUMENTS. SHOP DRAWINGS SHALL SHOW THE DESIGN DIMENSIONS, AND CLEARLY INDICATE IN LARGE SCALE THE CONSTRUCTION OF VARIOUS COMPONENTS, METHODS OF ASSEMBLY, THICKNESS OF MATERIALS, FINISHES, REINFORCEMENTS AND ALL OTHER PERTINENT DATA AND INFORMATION REQUESTED.
- ANY VARIATION IN THE SHOP DRAWINGS FROM THE ARCHITECT'S DRAWINGS MUST BE CLEARLY NOTED ON THE SUBMITTAL AS A VARIATION FROM THE REQUIREMENTS. FABRICATION SHALL NOT PROCEED UNTIL THE CONTRACTOR RECEIVES SHOP DRAWINGS STAMPED BY THE ARCHITECT. THE G.C. SHALL BE RESPONSIBLE TO REPLACE ANY INSTALLED FABRICATIONS, AT NO COST, THAT DEVIATE FROM THE ORIGINAL DESIGN IN THE CONTRACT DOCUMENTS IF VARIATIONS FROM THE ORIGINAL DESIGN WERE NOT CLEARLY NOTED IN THE SUBMITTAL.
- REQUESTS FOR SUBSTITUTIONS OF SPECIFIED ITEMS SHALL BE SUBMITTED IN WRITING WITHIN TEN (10) WORKING DAYS OF THE AWARD OF THE CONTRACT FOR CONSTRUCTION TO THE ARCHITECT AND WILL BE CONSIDERED ONLY IF THEY PROVIDE BETTER SERVICES, HAVE A MORE ADVANTAGEOUS DELIVERY DATE, OR HAVE A LOWER PRICE PROVIDING A CREDIT TO THE OWNER/TENANT AND WILL NOT SACRIFICE QUALITY, APPEARANCE OR FUNCTION. UNDER NO CIRCUMSTANCES WILL THE ARCHITECT BE REQUIRED TO PROVE THAT A PRODUCT PROPOSED FOR SUBSTITUTION IS OR IS NOT OF EQUAL QUALITY TO THE SPECIFIED PRODUCT.
- PROPOSED CHANGES TO ANY PRODUCTS SPECIFIED IN THE CONTRACT DOCUMENTS MUST CLEARLY BE NOTED ON THE SUBMITTAL AS CHANGES FROM THE ORIGINAL DESIGN. THE G.C. SHALL BE RESPONSIBLE TO REPLACE ANY PURCHASED/ INSTALLED ITEMS, AT NO COST, THAT DEVIATE FROM THE ORIGINAL SPECIFICATION IN THE CONTRACT DOCUMENTS IF VARIATIONS FROM THE ORIGINAL DESIGN WERE NOT CLEARLY NOTED IN THE SUBMITTAL OR DO NOT MEET THE PERFORMANCE OR AESTHETICS OF THE ORIGINAL SPECIFICATION.

PROVIDE FOUR (4) SETS OF BLUE OR BLACK LINE PRINTS OR ELECTRONIC FILES FOR ALL SHOP DRAWINGS. THE GC WILL SPECIFY AMOUNT OF COPIES TO THAT WILL BE RETURNED WITH COMMENTS AND STAMPS ATTACHED. PROVIDE (4) COPIES OF EACH SAMPLE.

# SUBMIT SHOP DRAWINGS AND / OR SAMPLES FOR THE FOLLOWING:

- B. CONCRETE & REINFORCING STEEL C. ROOFING PRODUCT DATA
- D. MASONRY & VENEER MASONRY E. MISC. METALS
- F. MILLWORK, CASEWORK & WOODWORK
- G. THERMAL & SOUND INSULATING MATERIALS H. FIRESTOPPING
- I. INSULATED GLAZING UNITS / GLASS J. DOOR, FRAMES & HARDWARE
- K. SCHEDULED FLOOR, WALL, BASE AND MISC FINISHES L. TOILET ACCESSORIES
- M. MANUFACTURED OR CUSTOM SPECIALTIES L. OPERATING & MAINTENANCE DATA
- M. WARRANTIES & BONDS
- N. MECHANICAL AND PLUMBING EQUIPMENT, FIXTURES, DIFFUSERS AND CONTROLS
- AS CALLED FOR BY THE MECHANICAL AND PLUMBING DRAWINGS O. ELECTRICAL EQUIPMENT AND FIXTURES CALLED FOR BY THE ELECTRICAL
- DRAWINGS P. FIRE SUPPRESSION AND FIRE ALARM SHOP DRAWINGS AS REQUIRED BY THE LOCAL AUTHORITY HAVING JURISDICTION

# NOTE TO BIDDERS

- THE FOLLOWING NOTES ARE TO BE CONGRUENT TO, OR IN ADDITION TO THE BID REQUIREMENTS SET BY THE CONSTRUCTION MANAGER. ADHERENCE TO THESE NOTES IS MANDATORY.
- 2. BID FORMAT: PRICING SHALL BE PROVIDED IN STANDARD CSI FORMAT WITH A BREAKDOWN BY TRADES INCLUDING QUANTITIES AND UNIT PRICES WHERE APPLICABLE. OWNER AND ARCHITECT SHALL REVIEW PROPOSED SUBSTITUTIONS FOLLOWING RECEIPT OF BIDS AND SHALL ACCEPT OR REJECT AT OWNER'S SOLE
- THE AWARDED CONTRACTOR SHALL, AT THE CONSTRUCTION MANAGER'S REQUEST, PROVIDE FULL BACK-UP FOR BIDS FROM SUBCONTRACTORS, INCLUDING ACTUAL BID DOCUMENTS PROVIDED TO CONTRACTOR.
- 4. SITE VISIT REQUIRED: PRIOR TO SUBMITTING BID, THE GENERAL CONTRACTOR AND HIS APPROPRIATE SUBCONTRACTORS SHALL THOROUGHLY EXAMINE THE SITE AND THE CONSTRUCTION DOCUMENTS TO ENSURE HIS KNOWLEDGE OF ALL RELEVANT FIELD CONDITIONS AND REQUIREMENTS AFFECTING THE WORK. ANY ITEMS WHICH MAY CONFLICT WITH THE PROPOSED WORK SHALL BE BROUGHT TO THE ARCHITECTS ATTENTION PRIOR TO THE SUBMISSION OF THE BID. THE CONTRACTOR SHALL BE FAMILIAR WITH ALL BUILDING RULES AND REGULATIONS. NO CLAIM FOR EXTRA COMPENSATION WILL BE ALLOWED FOR GENERAL CONTRACTOR'S OR SUBCONTRACTORS FAILURE TO COMPLY WITH THIS REQUIREMENT.
- SUBSTITUTIONS AND QUALIFICATIONS: ALL PRICING SHALL BE BASED ON THE CONTRACT DOCUMENTS WITHOUT SUBSTITUTIONS OR ALTERATION. HOWEVER, THE GENERAL CONTRACTOR MAY OFFER PRODUCT OR CONSTRUCTION METHOD SUBSTITUTIONS WHERE EVER SUBSTANTIAL SAVINGS MAY BE AVAILABLE TO THE OWNER BY SUBMITTING WITH BID. IT IS THE RESPONSIBILITY OF THE GENERAL CONTRACTOR TO CALL OUT AND CLEARLY IDENTIFY ALL PROPOSED SUBSTITUTIONS AS AN ADD OR DEDUCT ALTERNATE TO THE BASE BID AND ATTACH TO THE BID FOR REVIEW BY THE ARCHITECT AND OWNER.
- 6. ALL PROPOSED SUBSTITUTIONS SHALL BE REVIEWED BY THE ARCHITECT AND OWNER WHO WILL HAVE THE FINAL AUTHORITY TO ACCEPT OR REJECT SUBSTITUTIONS AS "EQUAL" TO THE SPECIFIED ITEM OR ASSEMBLY. IF THE GENERAL CONTRACTOR DOES NOT IDENTIFY AND RECEIVE ARCHITECT/ OWNER APPROVAL FOR SUBSTITUTIONS, THEN THE ARCHITECT RETAINS THE RIGHT TO DEMAND THAT THE PRODUCT OR CONSTRUCTION METHOD ORIGINALLY SPECIFIED BE INSTALLED WITHOUT ADDITIONAL COST TO THE TENANT.
- SUBCONTRACTOR LISTING: AFTER AWARD OF THE PROJECT, THE GENERAL CONTRACTOR SHALL SUBMIT A COMPLETE LIST OF ALL PROPOSED SUBCONTRACTORS TO THE ARCHITECT AND OWNER. ALL SUBCONTRACTORS SHALL AT THE DISCRETION OF THE ARCHITECT OR OWNER, SUBMIT QUALIFICATIONS FOR THE TYPE OF WORK SPECIFIED.
- 8. CONSTRUCTION SCHEDULE: THE GENERAL CONTRACTOR SHALL PROVIDE A PROPOSED CONSTRUCTION SCHEDULE SHOWING THE PHASING OF THE WORK AND THE TIME REQUIRED FOR EACH ELEMENT OF EACH PHASE WITH THE BID. THE GENERAL CONTRACTOR SHALL ALSO PROVIDE A SCHEDULE FOR REQUIRED SHOP DRAWINGS AND SUBMITTALS WITH THE BID.

# PROJECT CLOSE OUT NOTES

# **DOCUMENTATION**

- 1. PRIOR TO FINAL PAYMENT, THE CONTRACTOR SHALL ASSEMBLE AN OPERATIONS AND MAINTENANCE ("O&M") MANUAL. THIS MANUAL SHALL INCLUDE THE FOLLOWING ITEMS IN ADDITION TO THE LANDLORD/OWNER RULES AND REGULATIONS:
- A. AN ORIGINAL OF ALL NEW EQUIPMENT AND MATERIALS SPECIFICATIONS AND OPERATIONS SHEETS AND INSTRUCTIONS.
  - B. MSDATA SHEETS WHERE APPLICABLE OF ALL MATERIALS, ETC. C. ALL WARRANTIES AND OPERATIONAL INFORMATION & INSTRUCTIONS FOR
  - ALL NEW EQUIPMENT, APPLIANCES, ETC. D.A COPY OF ALL APPROVED/RECORD SHOP DRAWINGS AS SUBMITTED AND/OR APPROVED DURING THE PROJECT,
  - E. A COPY OF ALL APPROVED FINISHES AND THEIR SPECIFICATIONS. F. AIR BALANCE REPORT AS/IF PRESCRIBED BY THE MECHANICAL PLANS. G.COPIES OF ALL PANEL SCHEDULES AS THEY EXIST AFTER THE COMPLETION
  - OF ALL WIRING. H.SMALL FORMAT AS-BUILT COPIES OF THE PLANS. I. FURNITURE VENDOR INSTALLATION PLANS AS/IF APPLICABLE.

LANDLORD OR THE LANDLORD'S CONSTRUCTION MANAGER.

- TWO BOUND COPIES SHALL BE PROVIDED, IN A NEATLY INDEXED AND LABELED 3-RING BINDER(S) AND PROVIDED TO THE OCCUPANT OF THE SPACE AND THE ENGINEERING AND MAINTENANCE
- STAFF OF THE BUILDING. 3. ONE ELECTRONIC COPY OF THIS BINDER SHALL BE PROVIDED ON A THUMB DRIVE TO THE
- 4. IF DOCUMENTS ARE EITHER LABELED AS CLASSIFIED OR LABELED AS 'SBU', THE CONTRACTOR SHALL ONLY PROVIDE HARDCOPY MATERIALS AS DEFINED ABOVE.
- 5. GC SHOULD ALSO PROVIDE A FULL SIZE COPY OF THEIR FIELD / AS-BUILT/ RED-LINE DRAWINGS TO THE BUILDING ENGINEER

## 6. GC SHALL PROVIDE A MARKED UP PLAN IDENTIFYING THE LOCATION OF ALL ACCESS PANELS FOR VALVES, AND OTHER MECHANICAL DEVICES.

# GENERAL FINISH NOTES

- STARTING OF FINISH WORK SHALL INDICATE APPLICATOR'S ACCEPTANCE OF SUBSTRATE.
- 2. ENSURE ALL SURFACES (NEW & EXISTING) TO RECEIVE FINISHES ARE CLEAN, TRUE, AND FREE OF IRREGULARITIES.
- 3. DO NOT PROCEED WITH WORK UNTIL UNSATISFACTORY CONDITIONS HAVE BEEN CORRECTED.
- 4. DAMAGED OR INCORRECT MATERIALS SHALL BE RETURNED TO THE MANUFACTURER FOR IMMEDIATE REPLACEMENT.
- 5. EXTEND FINISH INTO CLOSETS AND ALCOVES OF AREAS INDICATED, UNLESS ANOTHER FLOOR FINISH IS INDICATED FOR SUCH SPACE. PROVIDE TRIMLESS. FLUSH ACCESS HATCH IN GYPSUM BOARD CEILING AS REQUIRED FOR
- MECHANICAL AND ELECTRICAL ACCESS. CONFIRM SIZE, STYLE AND LOCATION WITH ENGINEER AND ARCHITECT. REPAIR ANY DAMAGE IN METAL OR WOOD WINDOW SILLS AFTER REMOVAL OF EXISTING PARTITIONS
- FINISH NEWLY EXPOSED AND REPAIRED SILL TO MATCH EXISTING. AFTER COMPLETION OF THE PROJECT AND JUST PRIOR TO THE FINAL INSPECTION OF THE WORK,
- THOROUGHLY CLEAN FLOORS AND ACCESSORIES. PRIOR TO TENANT'S OCCUPANCY, THE CONTRACTOR SHALL CLEAN ALL NEW AND EXISTING SURFACES OF DUST, DEBRIS, LOOSE CONSTRUCTION MATERIAL AND EQUIPMENT. MAINTENANCE MATERIALS: DELIVER USABLE SCRAPS OF FINISH MATERIALS TO OWNER'S DESIGNATED STORAGE
- 10. ALL FINISHES, COATINGS, ADHESIVES, SEALANTS, ETC... SHALL BE ZERO OR LOW VOC WHEREVER

POSSIBLE.

UNLESS OTHERWISE NOTED, PROVIDE MINIMUM 2-COAT PAINT SYSTEMS OVER APPROPRIATE PRIMER COAT AS SPECIFIED FOR EACH SUBSTRATE: REFER TO FINISH SCHEDULE FOR COLORS AND

SEMI-GLOSS ALKYD

SEMI-GLOSS ALKYD

SEMI-GLOSS ALKYD

- FINISH QUALITIES. PAINT GRADE WOOD: PAINT GRADE DOORS: H. M. FRAMES & DOORS:
- TYPICAL WALLS: EGG SHELL - LATEX WET WALLS: **EPOXY**

SPACE, PROPERLY PACKAGED (PAPER WRAPPED) AND IDENTIFIED.

- ALL PAINT TO BE APPLIED IN ACCORDANCE WITH MANUFACTURER'S INSTRUCTIONS. 3. SAND LIGHTLY BETWEEN COATS TO ACHIEVE REQUIRED FINISHES.
- ALLOW EACH COAT OF FINISH TO DRY BEFORE THE FOLLOWING COAT IS APPLIED UNLESS DIRECTED OTHERWISE BY THE MANUFACTURER.
- 5. REPAINT OR REFINISH PAINTED SURFACES DAMAGED BY SUBSEQUENT WORK.

APPLY (2) COATS OF SELECTED PAINT.

- 6. FILL NICKS, GOUGES, AND OTHER IMPERFECTIONS OF SURFACES WITH LATEX FILLER. SAND SMOOTH AND FLUSH WITH SURFACE.
- WHERE GRILLES AND DIFFUSERS OCCUR IN CEILING OR WALL. CONFIRM WITH THE ARCHITECT PRIOR TO INSTALLATION TO ENSURE COLOR MATCH WITH ADJACENT SURFACE.

REMOVE OR OTHERWISE PROTECT FINISH HARDWARE, ACCESSORIES, PLATES, LIGHTING FIXTURES

COLOR OF PAINT AND STAIN USED IN THE WORK. CLEARLY LABEL CONTENT AND LOCATION WHERE

AND SIMILAR ITEMS BEFORE PAINTING. DO NOT PAINT ANY MOVING PARTS OF OPERATING UNITS,

- CODE-REQUIRED LABELS AND EQUIPMENT IDENTIFICATIONS. PROVIDE BUILDING MANAGEMENT WITH ATTIC STOCK OF AT LEAST ONE FULL GALLON OF EACH
- a. PAINTING EXISTING WALL SURFACES: PRIOR TO PAINTING EXISTING WALLS. CONTRACTOR SHALL SPACKLE SMALL IMPERFECTIONS IN WALL, SAND SMOOTH AND THEN APPLY (2) COATS
- OF SELECTED PAINT. b. PAINTING NEW WALL SURFACES: TAPE, SPACKLE AND SAND SMOOTH, JOINTS IN 5/8" GYP. BOARD.. THEN APPLY (1) COAT OF SHERWIN-WILLIAMS HEALTHSPEC PRIMER AND THEN APPLY (2) COATS OF SELECTED PAINT.
- c. PAINTING NEW GYP. BOARD CEILING SURFACES: TAPE, SPACKLE AND SAND SMOOTH, JOINTS IN 5/8" GYP. BOARD.. THEN APPLY (1) COAT OF PRIMER & (2) COATS OF AND THEN APPLY (2) COATS OF PAINT SELECTED PAINT. d. PAINTING EXISTING GYP. BOARD CEILING SURFACES: PRIOR TO PAINTING EXISTING CEILING,

CONTRACTOR SHALL SPACKLE SMALL IMPERFECTIONS IN CEILING. SAND SMOOTH AND THEN

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WITHOUT WRITTEN AUTHORIZATION.

DATE

**DESIGN INTENT DRAWINGS** 03.28.2025 PERMIT & BID 07.18.2025

DESIGNED/DRAWN BY: REVIEWED/APPROVED BY: PE

PROJECT NO:

SHEET TITLE:

**GENERAL NOTES** 

# GENERAL SPECIFICATIONS

#### DIVISION 00: PROCUREMENT AND CONTRACTING REQUIREMENTS

## SECTION 00 70 00 - CONDITIONS OF THE CONTRACT

A. GENERAL CONDITIONS: THE GENERAL CONDITIONS OF THE CONTRACT FOR CONSTRUCTION, AIA DOCUMENT A201, 2007 EDITION, IS A PART OF THIS CONTRACT, AND SHALL GOVERN WORK. A COPY WILL BE MADE AVAILABLE BY ARCHITECT UPON REQUEST.

#### SECTION 00 73 00 - SUPPLEMENTARY CONDITIONS

- CONDITIONS AND REQUIREMENTS: GENERAL CONDITIONS. SUPPLEMENTARY CONDITIONS AND DIVISION 01 - GENERAL REQUIREMENTS CONTAIN INFORMATION NECESSARY FOR COMPLETION OF EVERY PART OF PROJECT.
- DIVISION 01: WHERE PROVISIONS OF GENERAL CONDITIONS RELATE TO PROJECT ADMINISTRATION OR WORK-RELATED REQUIREMENTS OF THE CONTRACT, THOSE PARAGRAPHS ARE EXPANDED IN
- SUBCONTRACTORS: CONTRACTOR AGREES TO BIND SUBCONTRACTORS AND MATERIAL SUPPLIERS TO TERMS OF GENERAL AND SUPPLEMENTARY CONDITIONS, INCLUDING ARBITRATION.
- INSURANCE: AS REQUIRED BY AND APPROVED BY OWNER.
- MISCELLANEOUS DEFINITIONS: APPROVED: REQUIRES WRITTEN ACTION BY ARCHITECT AS DO TERMS SUCH AS "DIRECTED," "SELECTED," "REQUIRED," "ORDERED," "DESIGNATED," "ACCEPTED," "ACCEPTABLE," AND "SATISFACTORY.
- FURNISH: SUPPLY AND DELIVER TO PROJECT, UNLESS OTHERWISE SPECIFIED. 3. INSTALL: MAKE OPERATIONAL AT PROJECT FOR INTENDED USE, INCLUDING UNLOADING,
- INSPECTING AND COMPLETING IN PLACE. 4. PROVIDE: FURNISH AND INSTALL, COMPLETE AND READY FOR INTENDED USE, UNLESS OTHERWISE SPECIFIED.

#### **DIVISION 01: GENERAL REQUIREMENTS**

# SECTION 01 11 00 - SUMMARY OF WORK

- A. SCOPE: PROJECT CONSISTS OF CONSTRUCTION OF THE DSW STORE AS INDICATED IN CONTRACT
- 1. ITEMS NOTED "NIC" (NOT IN CONTRACT) WILL BE FURNISHED AND INSTALLED BY OWNER OR
- UNDER SEPARATE CONTRACT. 2. HAZARDOUS MATERIALS: HAZARDOUS MATERIAL CONTAINMENT, REMOVAL AND DISPOSAL ARE NOT INCLUDED IN CONTRACT; OWNER WILL PROVIDE FOR HANDLING OF HAZARDOUS MATERIALS UNDER SEPARATE CONTRACT PRIOR TO THIS PROJECT. NOTIFY OWNER
- IMMEDIATELY IF HAZARDOUS MATERIALS ARE SUSPECTED. WORK SEQUENCE: COORDINATE CONSTRUCTION SCHEDULE, OPERATIONS AND USE OF PREMISES WITH BUILDING MANAGEMENT.
- CONTRACTOR USE OF PREMISES: LIMITED TO AREAS INDICATED AND AS SPECIFIED; LIMIT ACCESS TO THE PROJECT SITE AS DIRECTED BY OWNER.
- LINES AND LEVELS ENGINEERING: ESTABLISH LINES AND LEVELS BY USE OF RECOGNIZED
- ENGINEERING PRACTICES. LOCATE AND PROTECT CONTROL AND REFERENCE POINTS. REGULATORY REQUIREMENTS: COMPLY WITH ALL APPLICABLE CODE REQUIREMENTS. INFORM
- ARCHITECT IMMEDIATELY OF ANY NON-CODE-COMPLYING CONDITIONS OBSERVED OR NOTED. STANDARDS: COMPLY WITH REFERENCED STANDARDS EXCEPT WHERE MORE RIGID REQUIREMENTS
- ARE REQUIRED BY CODE. UNLESS A SPECIFIC DATE IS REFERENCED, THE ISSUE DATE OF THE STANDARD IS THAT DATE IN EFFECT WHEN THE DOCUMENTS ARE ISSUED. OWNER-FURNISHED, CONTRACTOR-INSTALLED ITEMS (OFCI): OWNER WILL ARRANGE AND PAY FOR

DELIVERY OF THE IDENTIFIED PRODUCTS TO THE PROJECT SITE FOR INSTALLATION BY THE

CONTRACTOR 1. CONTRACTOR SHALL INSPECT, RECEIVE, UNLOAD, STORE, INSTALL AND FINISH AS INDICATED OR REQUIRED.

# SECTION 01 30 00 - ADMINISTRATIVE REQUIREMENTS

- PROCEDURES: CONTRACTOR SHALL REVIEW AND APPROVE SUBMITTALS PRIOR TO SUBMITTING TO OWNER'S PROJECT MANAGER. CONTRACTOR SHALL INFORM OWNER'S PROJECT MANAGER IN WRITING, AT TIME OF SUBMISSION, OF ANY PROPOSED DEVIATION FROM CONTRACT DOCUMENTS. 1. CONTRACTOR'S SUBMITTAL REPRESENTS THAT FIELD MEASUREMENTS, FIELD CONSTRUCTION
- CRITERIA, MATERIALS, CATALOG NUMBERS AND SIMILAR DATA HAVE BEEN DETERMINED AND VERIFIED BY CONTRACTOR. SHOP DRAWINGS: SUBMIT TWO PRINTS. SUBMIT SHOP DRAWINGS FOR CUSTOM PRODUCTS AND
- PRODUCTS NOT FULLY IDENTIFIED BY PRODUCT DATA.
- PRODUCT DATA: SUBMIT NUMBER REQUIRED BY CONTRACTOR PLUS TWO FOR OWNER'S PROJECT MANAGER. INDICATE ITEM TO BE USED WHERE DATA FOR MORE THAN ONE PRODUCT OR OPTION IS INCLUDED. SUBMIT PRODUCT DATA FOR EACH STOCK MANUFACTURED ITEM.
- MANUFACTURER'S CERTIFICATES: SUBMIT TWO COPIES. COORDINATION: COORDINATE USE OF PREMISES AND ACCESS TO SITE UNDER DIRECTION OF
- OWNER. COORDINATE WORK TO ASSURE EFFICIENT AND ORDERLY SEQUENCE OF INSTALLATION OF CONSTRUCTION ELEMENTS. 1. MAKE PROVISIONS FOR OWNER-INSTALLED ITEMS AND FOR WORK UNDER SEPARATE
- VERIFY CHARACTERISTICS OF INTERRELATED OPERATING EQUIPMENT ARE COMPATIBLE. COORDINATE WORK HAVING INTERDEPENDENT RESPONSIBILITIES FOR INSTALLING, CONNECTION TO, AND PLACING SUCH EQUIPMENT IN SERVICE.
- 3. COORDINATE SPACE REQUIREMENTS AND INSTALLATION OF MECHANICAL AND ELECTRICAL WORK, CONCEAL PIPES, DUCTS, AND WIRING INSTALLED IN FINISHED AREAS. COORDINATE LOCATIONS OF FIXTURES AND OUTLETS WITH FINISHES.

# SECTION 01 40 00 - QUALITY REQUIREMENTS

- A. GENERAL QUALITY CONTROL: MAINTAIN QUALITY CONTROL OVER SUPPLIERS, MANUFACTURERS, PRODUCTS, SERVICES, SITE CONDITIONS, AND WORKMANSHIP, TO PRODUCE WORK OF SPECIFIED
- MANUFACTURER'S FIELD SERVICES: WHEN SPECIFIED IN OTHER SPECIFICATION SECTIONS, MANUFACTURER OR SUPPLIER SHALL HAVE QUALIFIED PERSONNEL TO PROVIDE ON-SITE OBSERVATIONS AND RECOMMENDATIONS.
- 1. REPRESENTATIVE SHALL: OBSERVE FIELD CONDITIONS, INCLUDING CONDITIONS OF SURFACES. OBSERVE QUALITY OF
- WORKMANSHIP AND METHODS OF INSTALLATION. PROVIDE RECOMMENDATIONS FOR INSTALLATION AND WORKMANSHIP.
- START, TEST, AND ADJUST EQUIPMENT AS REQUIRED.
- SUBMIT WRITTEN REPORT OF OBSERVATIONS TO OWNER'S PROJECT MANAGER. MOCK-UPS: CONSTRUCT FIELD SAMPLES AND MOCK-UPS ON SITE AS REQUIRED.
- TESTING LABORATORY SERVICES: TESTING SHALL BE BY AN APPROVED TESTING LABORATORY, AS REQUIRED BY SPECIFICATIONS AND APPLICABLE CODES. 1. REQUIRED TESTING AND RETESTING WILL BE PAID FOR BY CONTRACTOR.
- 2. FURNISH MATERIALS AND SAMPLES FOR TESTS AND ASSIST TESTING LABORATORY AS REQUIRED.

# SECTION 01 50 00 - TEMPORARY FACILITIES AND CONTROLS

- GENERAL: PROVIDE TEMPORARY CONSTRUCTION FACILITIES AND TEMPORARY CONTROLS AS REQUIRED TO COMPLETE PROJECT IN ACCORDANCE WITH CONTRACT DOCUMENTS. CONFORM TO REQUIREMENTS OF APPLICABLE AUTHORITIES.
- CONTACT GOVERNING AUTHORITIES TO ESTABLISH EXTENT OF REQUIRED TEMPORARY FACILITIES AND CONTROLS. TEMPORARY POWER: PROVIDE POWER SERVICE AND LIGHTING REQUIRED FOR OPERATIONS.
- LOCATE BRANCH WIRING AND DISTRIBUTION BOXES TO ALLOW SERVICE AND LIGHTING BY MEANS OF CONSTRUCTION-TYPE POWER CORDS. TEMPORARY WATER AND SANITARY SERVICES: PROVIDE AND MAINTAIN REQUIRED DRINKING WATER
- AND SANITARY FACILITIES WITH ENCLOSURES. NOISE, DUST, AND POLLUTION CONTROL: PROVIDE MATERIALS AND EQUIPMENT NECESSARY TO
- COMPLY WITH LOCAL REQUIREMENTS FOR NOISE, DUST, AND POLLUTION CONTROL.
- BARRIERS: PROVIDE AS REQUIRED TO PROTECT ADJACENT PROPERTIES FROM DAMAGE FROM OPERATIONS AND AS REQUIRED BY GOVERNING AUTHORITIES. 1. PROVIDE BARRICADES AS REQUIRED BY CITY OR LANDLORD IN ACCORDANCE WITH ALL CODES,
- CRITERIA. AND DETAILS. 2. SECURITY: SECURE THE SITE AND MATERIALS DURING CONSTRUCTION. CLEANING: CONTROL ACCUMULATION OF WASTE MATERIALS AND RUBBISH. AS CONTAINERS BECOME
- FULL, DISPOSE AT OFF-SITE LOCATIONS ACCEPTABLE TO APPLICABLE AUTHORITIES. SIGNS: SUBJECT TO APPROVAL OF OWNER'S PROJECT MANAGER.

H. STORAGE: LIMIT ON-SITE STORAGE TO AREAS WHERE DIRECTED AND APPROVED IN WRITING BY OWNER. PROVIDE ADDITIONAL WEATHER-TIGHT, SECURED, OFF-SITE STORAGE IF REQUIRED. REMOVAL AND CLEANING: REMOVE CONSTRUCTION FACILITIES, CLEAN AND REPAIR DAMAGE

SECTION 01 60 00 - PRODUCT REQUIREMENTS

CAUSED BY OPERATIONS OR USE OF TEMPORARY FACILITIES.

- CONTRACT AMOUNT: BASED ON MATERIALS AND PRODUCTS LISTED IN CONTRACT DOCUMENTS. MATERIALS AND PRODUCTS BY OTHER MANUFACTURERS NOT LISTED SHALL NOT BE USED WITHOUT WRITTEN APPROVAL
- PRODUCTS: COMPONENTS SUPPLIED IN QUANTITY SHALL BE INTERCHANGEABLE. PROVIDE NEW MATERIALS UNLESS OTHERWISE INDICATED OR SPECIFIED. INSTALLATION: INSTALL ITEMS PLUMB, LEVEL, AND IN CORRECT RELATION TO ADJACENT PRODUCTS.
- SECURE IN PLACE WITH POSITIVE ANCHORAGE DEVICES DESIGNED AND SIZED TO WITHSTAND STRESSES, VIBRATION, AND RACKING. 1. COMPLY WITH MANUFACTURER'S RECOMMENDATIONS AND INSTALLATION INSTRUCTIONS
- UNLESS MORE STRINGENT REQUIREMENTS ARE SPECIFIED OR REQUIRED BY GOVERNING AUTHORITIES.
- D. TRANSPORTATION: TRANSPORT PRODUCTS TO AVOID PRODUCT DAMAGE. DELIVER IN UNDAMAGED CONDITION IN MANUFACTURER'S UNOPENED CONTAINERS OR PACKAGING. HANDLING: HANDLE PRODUCTS BY METHODS TO PREVENT SOILING AND DAMAGE. PROMPTLY INSPECT TO ASSURE PRODUCTS ARE CORRECT, COMPLETE, AND UNDAMAGED, AND THAT
- QUANTITIES ARE CORRECT. STORAGE: STORE MATERIALS IN ACCORDANCE WITH MANUFACTURER'S INSTRUCTIONS, WITH SEALS
- AND LABELS INTACT AND LEGIBLE. PROTECTION: PROVIDE COVERINGS TO PROTECT PRODUCTS FROM DAMAGE FROM TRAFFIC AND CONSTRUCTION OPERATIONS. REMOVE WHEN NO LONGER NEEDED.
- SPECIFIED PRODUCTS: IF THESE SPECIFICATIONS INCLUDE MULTIPLE PRODUCTS OR MANUFACTURERS FOR AN ITEM, SELECT THE PRODUCT OF ANY NAMED MANUFACTURER THAT MEETS THE SPECIFICATION REQUIREMENTS.

### SECTION 01 62 00 - SUBSTITUTIONS AND PRODUCT OPTION

- SUBSTITUTIONS AND PRODUCT OPTIONS: PROVIDE PRODUCTS INDICATED, SPECIFIED OR APPROVED. REQUESTS FOR SUBSTITUTIONS OF OTHER PRODUCTS WILL BE CONSIDERED IF SUBMITTED IN
- 1. CONTRACTOR OPTIONS: PROVIDE SPECIFIED PRODUCTS AND MANUFACTURERS. SUBMIT REQUEST FOR SUBSTITUTION FOR PRODUCTS AND MANUFACTURERS NOT SPECIFICALLY
- 2. SUBSTITUTIONS: INVESTIGATE PROPOSED SUBSTITUTIONS AND DETERMINE IF EQUIVALENT TO SPECIFIED PRODUCTS. SUBMITTALS SHALL INCLUDE COST OR TIME BENEFITS FOR THE REQUESTED SUBSTITUTIONS. FAILURE TO INDICATE COST OR TIME BENEFIT IS JUSTIFICATION FOR REJECTION.
- CONTRACTOR'S REPRESENTATION: SUBSTITUTION REQUESTS ARE A REPRESENTATION THAT CONTRACTOR HAS INVESTIGATED PROPOSED PRODUCTS, HAS DETERMINED IT MEETS OR EXCEEDS SPECIFIED PRODUCTS, AND WAIVES CLAIMS FOR ADDITIONAL COSTS THAT SUBSEQUENTLY BECOME APPARENT.
- 4. APPROVALS: OWNER'S PROJECT MANAGER WILL JUDGE THE ACCEPTABILITY. THE OWNER'S PROJECT MANAGER RESERVES THE RIGHT TO REJECT PROPOSED SUBSTITUTION BASED ON INSUFFICIENT INFORMATION. USE ONLY SUBSTITUTIONS APPROVED IN WRITING.

# SECTION 01 70 00 - EXECUTION AND CLOSEOUT REQUIREMENTS

- INSTALLER QUALIFICATIONS: INSTALLERS SHALL HAVE MINIMUM FIVE YEARS SUCCESSFUL EXPERIENCE INSTALLING ITEMS SIMILAR TO THOSE REQUIRED FOR PROJECT. INDIVIDUALS IN TRAINING UNDER DIRECT SUPERVISION OF EXPERIENCED INSTALLERS MAY BE EMPLOYED. EXAMINATION: COMMENCEMENT OF PRODUCT INSTALLATION SIGNIFIES THAT THE INSTALLER HAS
- EXAMINED SUBSTRATES, AREAS, AND CONDITIONS FOR COMPLIANCE WITH MANUFACTURER REQUIREMENTS FOR TOLERANCES AND OTHER CONDITIONS AFFECTING PERFORMANCE. MANUFACTURER'S INSTRUCTIONS: WHEN WORK IS SPECIFIED TO COMPLY WITH MANUFACTURERS'
- RECOMMENDATIONS OR INSTRUCTIONS, DISTRIBUTE COPIES TO OWNER'S PROJECT MANAGER. INSTALLATION: COMPLY WITH MANUFACTURER'S WRITTEN RECOMMENDATIONS AND INSTALLATION INSTRUCTIONS UNLESS MORE RESTRICTIVE REQUIREMENTS ARE SPECIFIED.
- PROTECTION: COVER PRODUCTS SUBJECT TO DETERIORATION WITH IMPERVIOUS SHEET, PROVIDE VENTILATION TO AVOID CONDENSATION AND WATER ENTRAPMENT.
- CUTTING AND PATCHING: CUT AND FIT COMPONENTS AS REQUIRED. PATCH DISTURBED AREAS TO MATCH ADJACENT MATERIALS AND FINISHES. 1. REFINISHING: REFINISH ENTIRE SURFACES AS NECESSARY TO PROVIDE EVEN FINISH TO MATCH ADJACENT FINISHES. REFINISH CONTINUOUS SURFACES TO NEAREST INTERSECTION. FOR AN
- ASSEMBLY, REFINISH THE ENTIRE UNIT. G. FINAL CLEANING: CLEAN EXPOSED INTERIOR AND EXTERIOR SURFACES. REMOVE TEMPORARY LABELS, STAINS, AND FOREIGN SUBSTANCES. POLISH TRANSPARENT AND GLOSSY SURFACES.
- VACUUM CARPETED AND SOFT SURFACES, CLEAN DUCTS, CLEAN THE SITE. H. SUBSTANTIAL COMPLETION: PROVIDE DOCUMENTATION STATING WORK IS SUBSTANTIALLY COMPLETE. WHERE OWNER REQUIRES USE OF SPACE PRIOR TO FINAL COMPLETION. PROVIDE LIST
- OF ITEMS TO BE COMPLETED. 1. OWNER'S PROJECT MANAGER WILL REVIEW LIST OF ANY ITEMS TO BE COMPLETED AND
- SUPPLEMENT LIST WITH ITEMS CONSIDERED INCOMPLETE OR UNACCEPTABLE. FINAL COMPLETION: PROVIDE WRITTEN CERTIFICATION INDICATING WORK IS IN COMPLIANCE WITH CONTRACT DOCUMENTS; THAT SYSTEMS WERE TESTED AND ARE OPERATIONAL; AND THAT WORK IS
- READY FOR FINAL INSPECTION. PROJECT RECORD DOCUMENTS: MAINTAIN COMPLETE AND UP-TO-DATE RECORD DOCUMENTS. KEEP SEPARATE FROM FIELD DOCUMENTS. SUBMIT PROJECT RECORD DOCUMENTS, MATERIAL AND FINISH DATA, OPERATION AND INSTRUCTION MANUALS, WARRANTIES AND BONDS AT COMPLETION.
- 1. SUBMIT BOUND IN 8-1/2" X 11" THREE RING BINDERS WITH DURABLE PLASTIC COVERS. WARRANTIES: PROVIDE WARRANTIES AS SPECIFIED, SIGNED BY CONTRACTOR AND MANUFACTURER. WARRANTY FORM SHALL BE APPROVED BY OWNER.
- 1. WARRANTIES SHALL BE IN ADDITION TO AND, REGARDLESS OF WARRANTY WORDING, NOT A LIMITATION OF OTHER RIGHTS THE OWNER MAY HAVE AGAINST CONTRACTOR UNDER CONTRACT DOCUMENTS AND AS PRESCRIBED BY LAW.
- 2. PROVIDE A LIST OF SUBCONTRACTORS CONTACTS AND PHONE NUMBERS IN A FRAME MOUNTED IN THE STOCK ROOM.
- 3. PROVIDE A FRAME WITH A COPY OF THE CERTIFICATE OF OCCUPANCY MOUNTED ON THE WALL OF THE STOCK ROOM.
- L. SUBMIT, UPON COMPLETION OF THE PROJECT, THE FOLLOWING PAPERWORK: GENERAL CONTRACTOR'S FINAL UNCONDITIONAL WAIVER OF LIEN.
- M. LIEN WAIVERS AND AFFIDAVIT SHALL BE ORIGINAL DOCUMENTS AND BE NOTARIZED.
- GENERAL CONTRACTOR'S AFFIDAVIT.
- N. LIEN WAIVERS AND AFFIDAVIT SHALL BE ORIGINAL DOCUMENTS AND BE NOTARIZED. 3. FINAL UNCONDITIONAL WAIVERS OF LIEN FROM EACH SUBCONTRACTOR
- LIEN WAIVERS AND AFFIDAVIT SHALL BE ORIGINAL DOCUMENTS AND BE NOTARIZED. 4. COMPLETE LIST OF SUBCONTRACTORS, INCLUDING ADDRESSES AND TELEPHONE NUMBERS. CERTIFICATE OF OCCUPANCY.
- ONE-YEAR WARRANTY.
- APPROVED CERTIFIED AIR-BALANCE REPORT. 8. OPERATION AND MAINTENANCE MANUALS.
- 9. ANY CERTIFICATIONS OBTAINED (E.G. ELEVATORS).

# **DIVISION 02: EXISTING CONDITIONS**

# SECTION 02 41 00 - SELECTIVE DEMOLITION

- SELECTIVE DEMOLITION: REMOVE FROM SITE EXISTING MATERIALS, CONSTRUCTION AND UTILITIES AS NEEDED TO COMPLETE PROJECT. REMOVE EXISTING ELEMENTS INDICATED AND ENCOUNTERED DURING CONSTRUCTION, AS REQUIRED TO COMPLETE WORK. 1. REMOVE ONLY THOSE ELEMENTS NECESSARY FOR COMPLETION OF PROJECT. REPAIR OR
- REPLACE ELEMENTS UNNECESSARILY REMOVED OR DAMAGED DURING CONSTRUCTION.
- CAREFULLY REMOVE AND STORE ITEMS INDICATED FOR REUSE IN PROJECT AND COORDINATE WITH OTHER TRADES FOR MODIFICATIONS AND REINSTALLATION.
- PROTECTION: PREVENT MOVEMENT AND SETTLEMENT OF ADJACENT STRUCTURE. PROVIDE BRACING, SHORING, AND UNDERPINNING AS REQUIRED. MAINTAIN THE SAFETY AND SUPPORT OF STRUCTURES. ASSUME LIABILITY FOR SUCH MOVEMENT AND SETTLEMENT. 4. UTILITIES: CONTACT APPLICABLE UTILITY COMPANIES PRIOR TO DISCONNECTING UTILITIES.
- DISCONTINUE WORK IF UNEXPECTED UTILITY LINES ARE ENCOUNTERED. DETERMINE LINE SOURCE AND USE PRIOR TO REMOVAL. CAP AND IDENTIFY EXISTING UTILITY LINES REMOVED. 5. REMOVE ABANDONED MATERIALS AND UTILITIES AT SOURCE.
- **DIVISION 03: CONCRETE**

### SECTION 03 05 00 - CONCRETE FLOOR SEALER

- GENERAL: PROVIDE A CLEAR CONCRETE FLOOR SEALER WHERE SCHEDULED.
- SUBMITTALS: FURNISH MANUFACTURER'S PRODUCT LITERATURE AND INSTALLATION INSTRUCTIONS. WARRANTY: SEALED CONCRETE FLOORS TO BE FREE OF DUSTING FROM ABRASION FOR A PERIOD
- OF 10-YEARS FROM SUBSTANTIAL COMPLETION.
- APPROVED MANUFACTURERS: MANUFACTURER, PRODUCT AND COLOR AS SCHEDULED ON THE MATERIALS SCHEDULE.
- ENSURE SURFACES ARE CLEAN AND FREE OF ALL CONTAMINANTS AND ANY FILM FORMING COMPOUNDS OR SEALERS. ENSURE CONCRETE HAS BEEN CURED A MINIMUM OF THREE (3) DAYS. TEST CONCRETE SURFACE FOR PH LEVELS AND VERIFY THAT PH LEVELS ARE ACCEPTABLE TO SEALER MANUFACTURER.
- APPLY TWO COATS OF CONCRETE FLOOR SEALER TO INTERIOR CONCRETE FLOORS WHERE SCHEDULED, IN ACCORDANCE WITH MANUFACTURER'S INSTRUCTIONS.

# SECTION 033000 - CAST-IN-PLACE CONCRETE

- A. CAST IN PLACE CONCRETE SLAB ON GRADE AS SCHEDULED IN THE STRUCTURAL DRAWINGS. B. ALL CONCRETE AND REINFORCING STEEL SHALL MEET LOCAL SEISMIC CRITERIA FOR ANCHORAGE,
- ALASKA, AS SPECIFIED BY THE STRUCTURAL ENGINEER. RELATED REQUIREMENTS: SECTION 079005 - JOINT SEALERS.
- QUALITY ASSURANCE. PERFORM WORK OF THIS SECTION IN ACCORDANCE WITH ACI 301 AND ACI 318. REINFORCEMENT
- . REINFORCING STEEL: ASTM A 615/A 615M GRADE 60 (420). 2. STEEL WELDED WIRE REINFORCEMENT: ASTM A 185/A 185M, PLAIN TYPE. FORM: FLAT SHEETS.
- TIE WIRE: ANNEALED, MINIMUM 16 GAGE. 4. CHAIRS, BOLSTERS, BAR SUPPORTS, SPACERS: SIZED AND SHAPED FOR ADEQUATE SUPPORT
- OF REINFORCEMENT DURING CONCRETE PLACEMENT. CONCRETE MATERIALS CEMENT: ASTM C 150, TYPE I - NORMAL PORTLAND TYPE.
- 2. FINE AND COARSE AGGREGATES: ASTM C 33. 3. CHEMICAL ADMIXTURES: DO NOT USE CHEMICALS THAT WILL RESULT IN SOLUBLE CHLORIDE IONS IN EXCESS OF 0.1 PERCENT BY WEIGHT OF CEMENT.
- ACCESSORY MATERIALS 1. UNDERSLAB VAPOR RETARDER: MULTI-LAYER, FABRIC-, CORD-, GRID-, OR ALUMINUM-REINFORCED POLYETHYLENE OR EQUIVALENT, COMPLYING WITH ASTM E 1745. CLASS A: STATED BY MANUFACTURER AS SUITABLE FOR INSTALLATION IN CONTACT WITH SOIL
- OR GRANULAR FILL UNDER CONCRETE SLABS. SINGLE PLY POLYETHYLENE IS PROHIBITED. ACCESSORY PRODUCTS: VAPOR RETARDER MANUFACTURER'S RECOMMENDED TAPE, ADHESIVE, MASTIC, PREFABRICATED BOOTS, ETC., FOR SEALING SEAMS AND PENETRATIONS IN
- VAPOR RETARDER. 3. MOISTURE-RETAINING COVER: ASTM C 171; REGULAR CURING PAPER, WHITE CURING PAPER, CLEAR POLYETHYLENE, WHITE POLYETHYLENE, OR WHITE BURLAP-POLYETHYLENE SHEET.
- CONCRETE MIX DESIGN PROPORTIONING NORMAL WEIGHT CONCRETE: COMPLY WITH ACI 211.1 RECOMMENDATIONS. 2. ADMIXTURES: ADD ACCEPTABLE ADMIXTURES AS RECOMMENDED IN ACI 211.1 AND AT RATES
- RECOMMENDED BY MANUFACTURER. 3. NORMAL WEIGHT CONCRETE: COMPRESSIVE STRENGTH, WHEN TESTED IN ACCORDANCE WITH ASTM C 39/C 39M AT 28 DAYS: 3,000 PSI.
- H. VAPOR BARRIERS & REINFORCING STEEL 1. INTERIOR SLABS ON GRADE: INSTALL VAPOR RETARDER UNDER INTERIOR SLABS ON GRADE. LAP JOINTS MINIMUM 6 INCHES. SEAL JOINTS, SEAMS AND PENETRATIONS WATERTIGHT WITH MANUFACTURER'S RECOMMENDED PRODUCTS AND FOLLOW MANUFACTURER'S WRITTEN
- INSTRUCTIONS. REPAIR DAMAGED VAPOR RETARDER BEFORE COVERING. INSTALLING REINFORCEMENT: COMPLY WITH REQUIREMENTS OF ACI 301. CLEAN REINFORCEMENT OF LOOSE RUST AND MILL SCALE, AND ACCURATELY POSITION, SUPPORT, AND SECURE IN PLACE TO ACHIEVE NOT LESS THAN MINIMUM CONCRETE COVERAGE REQUIRED FOR PROTECTION
- 3. INSTALL WELDED WIRE REINFORCEMENT IN MAXIMUM POSSIBLE LENGTHS. AND OFFSET END LAPS IN BOTH DIRECTIONS. SPLICE LAPS WITH TIE WIRE.
- PLACING CONCRETE PLACE CONCRETE IN ACCORDANCE WITH ACI 304R.
- PLACE CONCRETE FOR FLOOR SLABS IN ACCORDANCE WITH ACI 302.1R. REPAIR UNDERSLAB VAPOR RETARDER DAMAGED DURING PLACEMENT OF CONCRETE REINFORCING. REPAIR WITH VAPOR RETARDER MATERIAL; LAP OVER DAMAGED AREAS
- MINIMUM 6 INCHES AND SEAL WATERTIGHT. 4. INSTALL JOINT DEVICES IN ACCORDANCE WITH MANUFACTURER'S INSTRUCTIONS.
- 1. CONCRETE SLABS: FINISH TO REQUIREMENTS OF ACI 302.1R, AND AS FOLLOWS: SURFACES TO RECEIVE THIN FLOOR COVERINGS: "STEEL TROWEL" AS DESCRIBED IN ACI 301.1R; THIN FLOOR COVERINGS INCLUDE CARPETING, RESILIENT FLOORING, SEAMLESS FLOORING, THIN SET QUARRY TILE, AND THIN SET CERAMIC TILE.
- OTHER SURFACES TO BE LEFT EXPOSED: "STEEL TROWEL" AS DESCRIBED IN ACI 302.1R, MINIMIZING BURNISH MARKS AND OTHER APPEARANCE DEFECTS.
- 2. IN AREAS WITH FLOOR DRAINS, MAINTAIN FLOOR ELEVATION AT WALLS; PITCH SURFACES UNIFORMLY TO DRAINS AT 1:100 NOMINAL. CURING AND PROTECTION
- CONCRETE FROM PREMATURE DRYING, EXCESSIVELY HOT OR COLD TEMPERATURES, AND MECHANICAL INJURY 2. MAINTAIN CONCRETE WITH MINIMAL MOISTURE LOSS AT RELATIVELY CONSTANT TEMPERATURE

1. COMPLY WITH REQUIREMENTS OF ACI 308R. IMMEDIATELY AFTER PLACEMENT, PROTECT

3. SURFACES NOT IN CONTACT WITH FORMS: INITIAL CURING: START AS SOON AS FREE WATER HAS DISAPPEARED AND BEFORE SURFACE IS DRY.

KEEP CONTINUOUSLY MOIST FOR NOT LESS THAN THREE DAYS BY WATER PONDING,

FOR PERIOD NECESSARY FOR HYDRATION OF CEMENT AND HARDENING OF CONCRETE.

# WATER-SATURATED SAND. WATER-FOG SPRAY. OR SATURATED BURLAP.

FINAL CURING: BEGIN AFTER INITIAL CURING BUT BEFORE SURFACE IS DRY.

# SECTION 03 54 00 - CEMENTITIOUS UNDERLAYMENT

A. GENERAL: PROVIDE POURED CEMENTITIOUS UNDERLAYMENT SYSTEM, INCLUDING ACCESSORIES AS

MOISTURE-RETAINING COVER: SEAL IN PLACE WITH WATERPROOF TAPE OR ADHESIVE.

- REQUIRED FOR COMPLETE INSTALLATION (NOT INTENDED AS A FINISHED TRAFFIC SURFACE). B. SUBMITTALS: FURNISH MANUFACTURER'S LITERATURE.
- INSTALLER: FIRM WITH MINIMUM 5 YEARS SUCCESSFUL EXPERIENCE, REGULARLY ENGAGED IN INSTALLATION OF SPECIFIED MATERIALS, PROPERLY EQUIPPED AND ACCEPTABLE TO MANUFACTURER.
- MANUFACTURER: ARDEX: K-15; W.R.BONSAL CO.: SELF-LEVELING UNDERLAYMENT. SYSTEM: POURABLE CEMENTITIOUS, HIGH-STRENGTH, FAST-SETTING, NON-SHRINK, SELF-LEVELING UNDERLAYMENT; MINIMUM 4000 PSI COMPRESSIVE STRENGTH AT 28 DAYS, ASTM C349. TOLERANCE NOT MORE THAN 1/8" OVER TEN FEET
  - INSTALLATION: COMPLY WITH MANUFACTURER'S RECOMMENDATIONS AND INSTALLATION INSTRUCTIONS.



4601 FAIRFAX DRIVE SUITE 1000 ARLINGTON, VIRGINIA 22203 (T): 703-527-2280



5628 FOXCROFT WAY COLUMBIA, MD 21045 (T): 202-674-4481

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**DESIGN INTENT DRAWINGS** 03.28.2025 PERMIT & BID 07.18.2025

DESIGNED/DRAWN BY: REVIEWED/APPROVED BY: PE

PROJECT NO:

SHEET TITLE:

ITEM	EXISTING	PROPOSED
FIRE HYDRANT		
AIR CONDITIONING UNIT	AC	ÄC
UTILITY POLE	0	ච
FIRE DEPARTMENT		
CONNECTION	\$	<u> </u>
STORM STRUCTURE IDENTIFIER	<b>#</b> >	<b>(#</b> )
STORM MANHOLE	$\bigcirc$	•
STORM SEWER LAYOUT		
SANITARY STRUCTURE		
IDENTIFIER	(X)	(X)
SANITARY MANHOLE	S	<u> </u>
SANITARY SEWER LAYOUT		S
SIDEWALK	WALK	WALK
SIGN	0	<del>-</del>
SIGN (DOUBLE POST)	00	- 0 0
GAS VALVE	GV	GV
GAS LINE	G G	G
GAS METER	GM	GM
IRRIGATION VALVE	$\otimes^{V}$	<b>e</b> v
BOLLARD	•	•
CLEANOUT	°C0	ço
WELL	(W)	<b>W</b>
WATERLINE	W W	w
WATER VALVE	W	×
WATER METER	$\bigcirc_{WM}$	•
TRANSFORMER	TR	TR
ELECTRIC MANHOLE	(E)	Ð
ELECTRIC METER	EM O	EM
ELEC BOX/STRUCTURE	EB	EB
ELECTRIC LINE	—— E— — E—	——Е—
FELECOMMUNICATION LINE	TT	т
CABLE LINE	C	c
CABLE/ELECTRIC/ FELECOMMUNICATION LINE	—— C—— T—— E ———	— c— т— E —
TELECOMMUNICATION MANHOLE		Ф
TELECOMMUNICATION STRUCTURE	C	C
OVERHEAD STREET LIGHT	·	•
LIGHT POLE	<b>\$</b>	ф
LANDSCAPE LIGHT	<b></b>	€
FENCES	XX	xx
GRADING SPOT	+124.5	+ 24 <sup>50</sup>
GRADING CONTOUR	<u> </u>	<u> </u>
BUILDING ENTRANCE		
PAVING		0 0
GUARDRAIL		
CURB AND GUTTER		
PROPOSED SPILL CURB		
PROPOSED TRANSITION/ NOSE DOWN CURB	+++++	* * * * *
LIMITS OF DISTURBANCE		
LIMITS OF WORK		

# TEXT LEGEND:

= DEGREES INTX = INTERSECTION IRF = IRON ROD FOUND = MINUTES (OR FEET) L = LUMENS' = SECONDS (OR INCHES) LAT = LATERAL% = PERCENTLED = LIGHT EMITTING DIODE # = NUMBERLL = LANDSCAPE LIGHT $\mathbf{@} = \mathsf{AT}$ LOC = LOCATIONlbs = POUNDS LP = LIGHT POLE A = ARCMAX = MAXIMUMAC = ACREME = MATCH EXISTINGADA = AMERICANS W/ DISABILITIES ACT MH = MANHOLEAPPROX = APPROXIMATEMIN = MINIMUMBC = BOTTOM OF CURBMON = MONUMENTBF = BASEMENT FLOORMPH = MILES PER HOURBFE = BASE FLOOD ELEVATION MW = MONITORING WELL BLDG = BUILDINGN = NORTHBM = BENCHMARKOHW = OVERHEAD WIRE BSMT = BASEMENTPED = PEDESTRIANBOL = BOLLARDPN = PANELBW = BOTTOM OF WALLPG = PAGECATV = CABLE UTILITYPP = POWER POLE CL = CLASSPROP = PROPOSED C/L = CENTERLINEPVC = POLYVINYL CHLORIDE CLR = CLEARANCER = RADIUSCLF = CHAIN LINK FENCE RCP = REINFORCED CONCRETE PIPE CMP = CORRUGATED METAL PIPE RELOC = RELOCATEDCI = CURB INLETRET = RETAININGCO = CLEAN OUTRESID = RESIDENTIAL CONC = CONCRETEREQ = REQUIREDC&G = CURB & GUTTERROW = RIGHT-OF-WAYCVR = COVERS = SOUTHDB = DEED BOOKSAN = SANITARYDHF = DRILL HOLE FOUND SEW = SEWERDIP = DUCTILE IRON PIPE SF = SQUARE FEETDOM = DOMESTICSQ FT = SQUARE FEETDU = DWELLING UNIT STM = STORME = EASTSTR = STRUCTURE EBOX = ELECTRICAL BOXSW = SIDEWALKESMT = EASEMENTTBR = TO BE REMOVEDEP = EDGE OF PAVEMENTTBS = TO BE SAVEDEVE = EMERGENCY VEHICLE EASEMENT TM = TAX MAPEX = EXISTINGTMH = TELEPHONE MANHOLE FDC = FIRE DEPT. CONNECTION

TC = TOP OF CURB

TW = TOP OF WALL

UP = UTILITY POLE

W/L = WATER LINE

WV = WATER VALVE

WW = WINDOW WELL

XING = CROSSING

WM = WATER METER

W/S = WATER SERVICE

TYP = TYPICAL

W = WEST

TRAF SIG = TRAFFIC SIGNAL

VPD = VEHICLES PER DAY


UGE = UNDERGROUND ELECTRIC

VCS = VIRGINIA COORDINATE SYSTEM

WSE = WATER SURFACE ELEVATION

# MINOR AMENDMENT SIT81-0041 LOT 2

# PRINCE STREET SCHOOL (1001 PRINCE STREET) CITY OF ALEXANDRIA, VIRGINIA

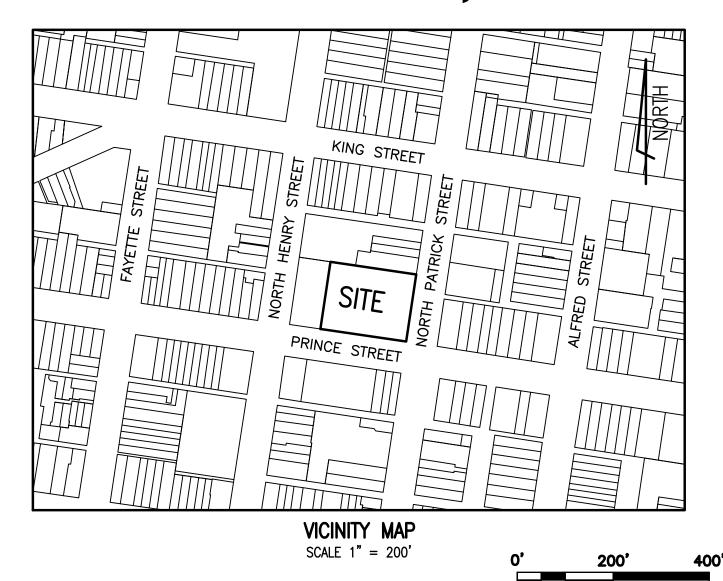

INDEX TO	PLAN:	1
SITE PLANWATER PLAN P	ROFILE	

# PROJECT NARRATIVE:

THIS MINOR AMENDMENT TO THE SITE PLAN SIT81-0041 IS TO INSTALL A FIRE LINE AND CONSTRUCTION OF A RAMP TO ACCESS THE EAST SIDE OF THE BUILDING. NO CHANGES TO THE FOOTPRINT OF THE EXISTING BUILDING ARE PROPOSED WITH THIS PLAN. THIS SITE IS LOCATED AT THE SOUTHEAST CORNER OF PRINCE STREET AND NORTH PATRICK STREET AND IS DEVELOPED WITH A 23-STORY BRICK BUILDING. THE SITE IS CURRENTLY LOCATED IN ZONE CD. THERE ARE NO RESOURCE PROTECTION AREAS (RPA) ON THE SITE. THIS PROPERTY IS LOCATED IN ZONE X (UNSHADED) OF THE FEMA FLOOD INSURANCE RATE MAP #25013C0403E.

# ARCHAEOLOGY NOTES:

CALL ALEXANDRIA ARCHAEOLOGY IMMEDIATELY (703-746-4399) IF ANY BURIED STRUCTURAL REMAINS (WALL FOUNDATIONS, WELLS, PRIVIES, CISTERNS, ETC.) OR CONCENTRATIONS OF ARTIFACTS ARE DISCOVERED DURING DEVELOPMENT. WORK MUST CEASE IN THE AREA OF THE DISCOVERY UNTIL A CITY ARCHAEOLOGIST COMES TO THE SITE AND RECORDS THE FINDS.

THE APPLICANT SHALL NOT ALLOW ANY METAL DETECTION AND/OR ARTIFACT COLLECTION TO BE CONDUCTED ON THE PROPERTY, UNLESS AUTHORIZED BY ALEXANDRIA ARCHAEOLOGY. FAILURE TO COMPLY SHALL RESULT IN PROJECT DELAYS.

ALL REQUIRED ARCHAEOLOGICAL PRESERVATION MEASURES SHALL BE COMPLETED IN COMPLIANCE WITH SECTION 11-411 OF THE ZONING ORDINANCE.

# **ENVIRONMENTAL SITE ASSESSMENT:**

SATURDAYS FROM 10am TO 4pm.

THE CITY OF ALEXANDRIA DEPARTMENT OF TRANSPORTATION AND ENVIRONMENTAL SERVICES, DIVISION OF ENVIRONMENTAL QUALITY MUST BE NOTIFIED IF UNUSUAL OR UNANTICIPATED CONTAMINATION OR UNDERGROUND STORAGE TANKS, DRUMS AND CONTAINERS ARE ENCOUNTERED AT THE SITE. IF THERE IS ANY DOUBT TO PUBLIC SAFETY OR A RELEASE TO THE ENVIRONMENT, THE ALEXANDRIA FIRE DEPARTMENT MUST BE CONTACTED IMMEDIATELY BY CALLING 911. THE TANK OR CONTAINERS REMOVAL, ITS CONTENTS, ANY SOIL CONTAMINATION AND RELEASES TO THE ENVIRONMENT WILL BE HANDLED IN ACCORDANCE WITH FEDERAL, STATE AND CITY REGULATIONS.

ALL WELLS INCLUDING MONITORING WELLS MUST BE CLOSED IN ACCORDANCE WITH WELL REGULATIONS. COORDINATE WITH THE ALEXANDRIA HEALTH DEPARTMENT AT 703-746-4996.

ALL CONSTRUCTION ACTIVITIES MUST COMPLY WITH THE ALEXANDRIA NOISE CONTROL CODE TITLE 11, CHAPTER 5, WHICH PERMITS CONSTRUCTION ACTIVITIES TO OCCUR BETWEEN THE FOLLOWING HOURS: MONDAY THROUGH FRIDAY FROM 7am TO 6pm AND SATURDAYS FROM 9am TO 6pm. NO CONSTRUCTION ACTIVITIES ARE PERMITTED ON SUNDAYS. PILE DRIVING IS FURTHER RESTRICTED TO THE FOLLOWING HOURS: MONDAY THROUGH FRIDAY FROM 9am TO 6pm AND

# **GENERAL NOTES:**

2. ZONE:

VIRGINIA TECH FOUNDATION INC CAPITOL COMPANIES ATTN BRYAN FELTS 3914

CENTERVILLE ROAD #300 CHANTILLY, VA 20151

JONATHAN RODGERS

JRODGERS@FOCUS-ARCH.COM

- 4. TOPOGRAPHIC SURVEY WAS FIELD RUN BY THIS FIRM. VERTICAL DATUM = NAVD '88 PER FIELD GPS DATA REFERENCED TO THE RTK NETWORK LEICA. SMARTNET.
- 5. A TITLE REPORT WAS NOT FURNISHED, THUS ALL EASEMENTS MAY NOT BE SHOWN.
- 6. PLAT SUBJECT TO RESTRICTIONS OF RECORD.
- 7. TOTAL SITE AREA = 25,643 S.F. OR 0.5887 AC.
- 8. TOTAL DISTURBED AREA = 780 SF OR 0.0179 AC.
- 9. ALL CONSTRUCTION SHALL CONFORM TO THE CURRENT EDITION OF THE UNIFORM STATEWIDE BUILDING CODE
- 10. THIS LOT SHALL REUSE THE EXISTING SEWER AND WATER SERVICE. IF NEEDED, UTILITY UPSIZES WILL REQUIRE
- 11. THIS LOT IS IN ZONE X (UNSHADED) OF THE FEMA FLOOD INSURANCE RATE MAP #25013C0403E.
- 12. THERE ARE NO KNOWN GRAVE SITES OR OBJECTS MARKING A PLACE OF BURIAL ON THIS SITE.
- 13. THIS SITE CONTAINS NO KNOWN CONTAMINATED SOILS, TOXIC OR HAZARDOUS MATERIALS, UNDERGROUND STORAGE TANKS OR AREAS WITH THE POTENTIAL TO GENERATE COMBUSTIBLE GASES AND IS NOT KNOWN TO WITHIN 1,000 FEET OF A FORMER SANITARY LANDFILL. DUMP OR DISPOSAL AREA.
- 14. STORMWATER MANAGEMENT AND RUNOFF FROM THIS PROPOSED LOT WILL BE PROVIDED TO THE SATISFACTION OF THE DIRECTOR OF TRANSPORTATION AND ENVIRONMENTAL SERVICES. THERE ARE NO CHANGES IN DRAINAGE PATTERNS PROPOSED WITH THIS PLAT.
- 15. THERE ARE NO RESOURCE PROTECTION AREAS (RPA) LOCATED ON THIS PROPERTY.
- 16. ALL PROPOSED UTILITIES TO BE PLACED UNDERGROUND.
- 17. A DEMOLITION PERMIT SHALL BE OBTAINED PRIOR TO ANY DEMOLITION ACTIVITIES.
- 18. APPLICANT SHALL BE RESPONSIBLE FOR REPAIRS TO THE ADJACENT CURB, GUTTER AND RIGHT-OF-WAY IF DAMAGED DURING CONSTRUCTION ACTIVITY AS DETERMINED BY THE DIRECTOR OF TRANSPORTATION AND ENVIRONMENTAL SERVICES (T&ES).
- 19. A SEPARATE SOIL REPORT & GROUNDWATER DRAINAGE PLAN WILL BE SUBMITTED TO CODE ADMINISTRATION IF
- 20. THE APPLICANT WILL COMPLY WITH THE CITY OF ALEXANDRIA'S NOISE CONTROL CODE, TITLE 11, CHAPTER 5 WHICH SETS THE MAXIMUM PERMISSIBLE NOISE LEVEL AS MEASURED AT THE PROPERTY LINE. SEE ENVIRONMENTAL SITE ASSESSMENT ON THIS SHEET FOR HOURS.
- 21. IF DISTURBANCE EXCEEDS 2,500 SF, THE APPLICANT MUST COMPLY WITH ARTICLE XIII OF THE CITY'S ZONING ORDINANCE, WHICH INCLUDES REQUIREMENTS FOR STORMWATER POLLUTANT LOAD REDUCTIONS, TREATMENT OF THE WATER QUALITY VOLUME DEFAULT, AND STORMWATER QUALITY MANAGEMENT.
- 22. PERMITS FROM THE EPA, US ARMY CORPS OF ENGINEERS, & VIRGINIA MARINE RESOURCES ARE NOT REQUIRED FOR THIS PROJECT. A VPDES PERMIT IS NOT REQUIRED FOR THIS PROJECT.
- 23. ADDRESS SHALL BE CLEARLY MARKED AT THE ENTRANCES TO THIS SITE FOR EMERGENCY RESPONSE PURPOSES.
- 24. THE CRIME PREVENTION UNIT OF THE ALEXANDRIA POLICE DEPARTMENT CAN BE CONTACTED AT 703-746-1920.
- 25. SOLID WASTE SERVICES TO BE PROVIDED BY THE CITY AND REFUSE/RECYCLING MUST BE PLACED AT CURB FOR PICK-UP.
- 26. ALL STREET CUT AND PATCH WORK LOCATED IN PUBLIC RIGHT-OF-WAYS, REQUIRED FOR ANY UTILITY INSTALLATION SHALL BE PERFORMED IN STRICT ACCORDANCE WITH THE CITY OF ALEXANDRIA STANDARDS AND
- 27. THERE ARE NO KNOWN CONTAMINATED AREAS. CONTAMINATED SOILS OR ENVIRONMENTAL ISSUES ASSOCIATED
- 28. THIS SITE DOES NOT CONTAIN AREAS PREVIOUSLY MAPPED AS MARINE CLAYS.
- 29. THIS PROJECT IS LOCATED IN THE CAMERON RUN WATERSHED.
- 30. ANY WORK WITHIN THE RIGHT-OF-WAY REQUIRES A SEPARATE PERMIT FROM T&ES.
- 31. BEFORE A BUILDING PERMIT CAN BE ISSUED ON ANY PROPOSED ALTERATIONS, A CERTIFICATION IS REQUIRED FROM THE OWNER OR HIS/HER AGENT STATING THAT THE BUILDING HAS BEEN INSPECTED BY A LICENSED ASBESTOS INSPECTOR FOR THE PRESENCE OF ASBESTOS.

# RIGHT-OF-WAY NOTES:

- A. ANY WORK IN THE PUBLIC RIGHT OF WAY SHALL REQUIRE A SEPARATE PERMIT FROM THE DIRECTOR, TRANSPORTATION AND ENVIRONMENTAL SERVICES. THE CONTRACTOR CAN CONTACT THE DEPARTMENT OF TRANSPORTATION AND ENVIRONMENTAL SERVICES AT (703) 746-4035 FOR ANY QUESTIONS OR ADDITIONAL
- B. SIDEWALK CLOSURES,IF REQUIRED, ARE SUBJECT TO SEPARATE APPROVAL FROM TRANSPORTATION AND ENVIRONMENTAL SERVICES (T&ES) AT THE TIME OF PERMIT APPLICATION. SIDEWALK CLOSURES WILL NOT BE PERMITTED FOR THE DURATION OF THE PROJECT.

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EXISTING UTILITIES SHOWN ON THIS PLAN TAKEN FROM AVAILABLE RECORDS AND/OR FROM FIELD OBSERVATIONS. FOR EXACT LOCATIONS OF EXISTING UNDERGROUND UTILITIES, NOTIFY "MISS UTILITY" AT 1-800-552-7001, 72 HOURS BEFORE THE START OF ANY EXCAVATION OR CONSTRUCTION.

LOCATION AND DEPTH OF ALL EXISTING UNDERGROUND UTILITIES TO BE VERIFIED BY CONTRACTOR PRIOR TO CONSTRUCTION. INTERFERENCE OR DISRUPTION OF SAME WILL NOT BE THE RESPONSIBILITY OF THIS OFFICE. ALL CONSTRUCTION SHALL CONFORM TO THE CURRENT STANDARDS AND SPECIFICATIONS OF THE CITY OF ) 2025 R.C. FIELDS & ASSOCIATES, INC.



0 )HO( PLAN LOT 2 TREE OK 1024, PRINCE S RN

CITY

AM

MINO

REVISION

DESIGN: VMM CHECKED: VMM SCALE: 1" = 200'DATE: JUN. 06,2025

COVER SHEET

FF = FINISH FLOOR

FH = FIRE HYDRANT

GI = GRATE INLET

G/L = GAS LINE

GM = GAS METER

GV = GAS VALVE

G/S = GAS SERVICE

HC = HEADER CURB

HDCP = HANDICAP

HP = HIGH POINT

INV = INVERT


HDPE = HIGH DENSITY POLYETHYLENE


HPS = HIGH PRESSURE SODIUM

IPF = IRON PIPE FOUND

INSTR = INSTRUMENT

FT = FEET

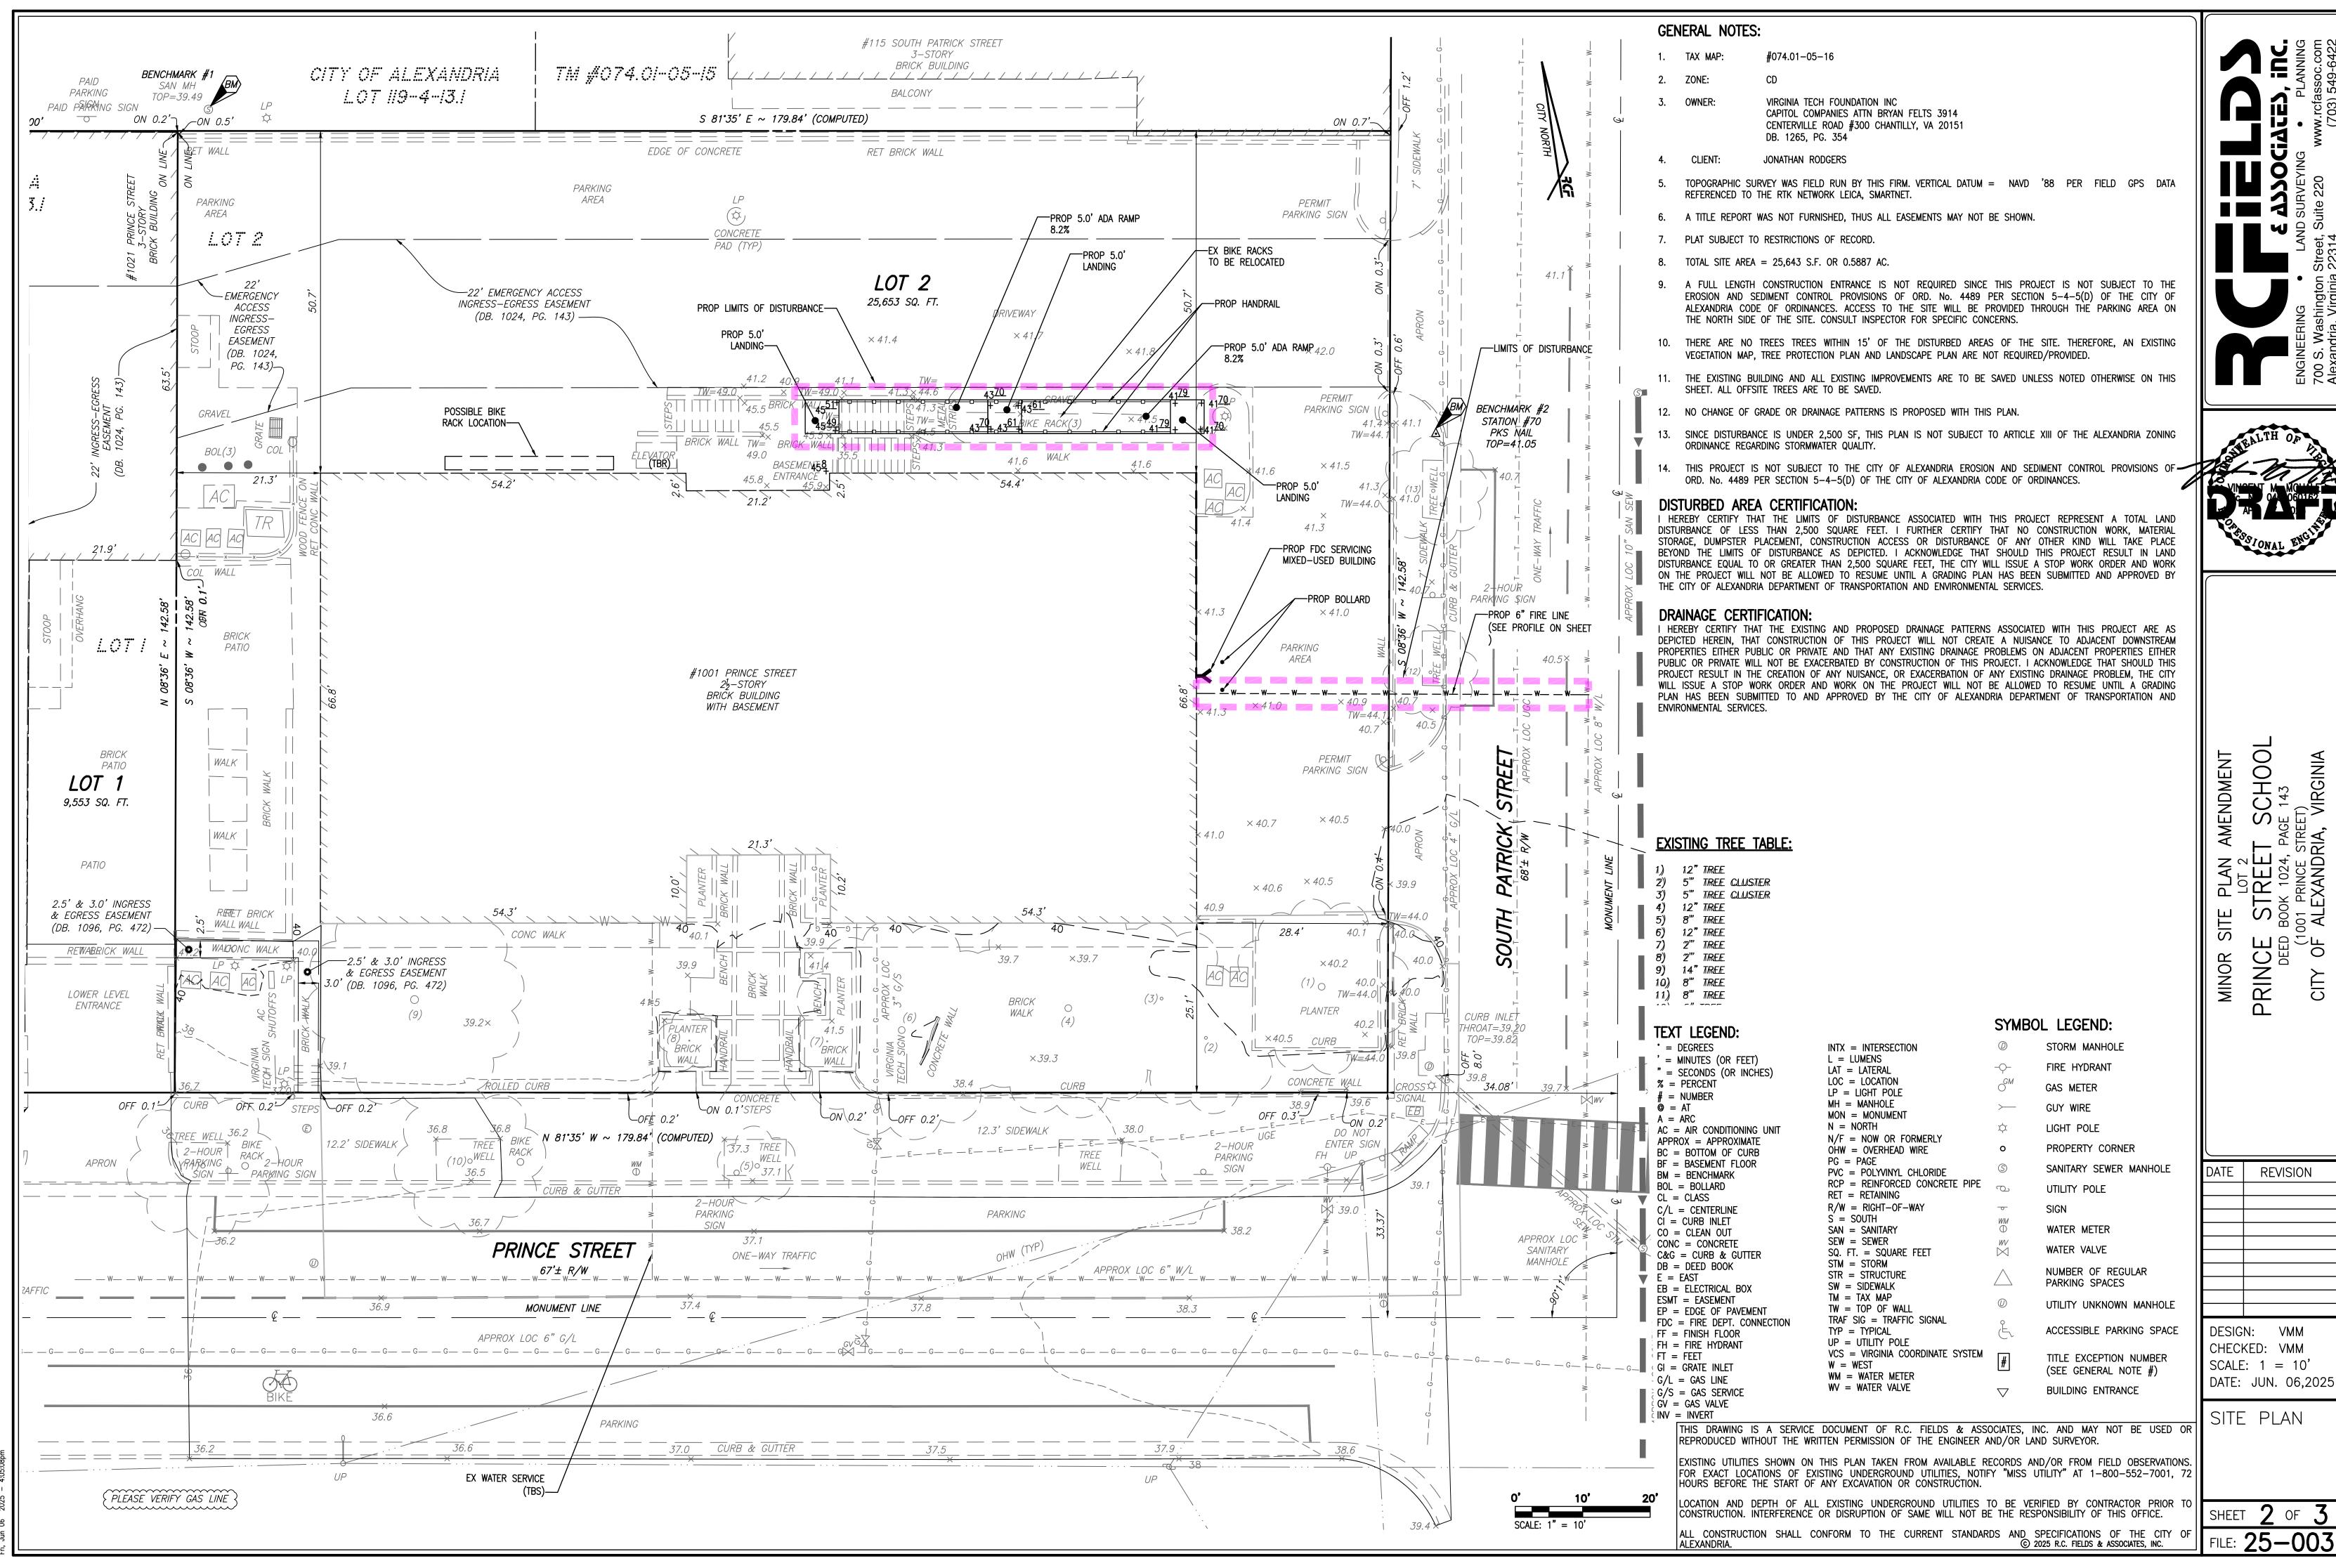

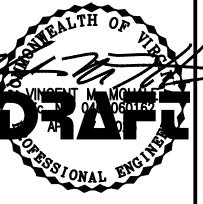

VPDES PERMIT NOTE:

THIS PROJECT PROPOSES CONSTRUCTION ACTIVITIES THAT ARE LESS THAN 1 ACRE, THEREFORE A VPDES PERMIT IS NOT REQUIRED.

# E&S MEASURES NOTE:

ADDITIONAL EROSION & SEDIMENT CONTROLS SHALL BE INSTALLED IF DIRECTED BY THE T&ES INSPECTOR.

# WATER QUANTITY/OUTFALL COMPLIANCE NARRATIVE

# (CITY CODE SECTION 13-109F COMPLIANCE):

THIS PARCEL IS LOCATED IN THE COMBINED SEWER SYSTEM WATERSHED. THE ENTIRE PARCEL CONSISTS OF IMPERVIOUS AREAS OF AN EXISTING 7—STORY BUILDING WITH UNDERGROUND GARAGE AND ASSOCIATED IMPROVEMENTS. ALL THE EXISTING IMPROVEMENTS ARE TO REMAIN. THE ONLY GROUND DISTURBING ACTIVITY PROPOSED WITH THIS PLAN IS FOR THE FIRE LINE INSTALLATION AND CONSTRUCTION OF A RAMP ON THE EAST SIDE OF THE BUILDING. THIS WORK WILL GENERATE A LAND DISTURBANCE OF APPROXIMATELY 0.0179 ACRES (SITE AREA). THE RUNOFF GENERATED FROM THIS SITE SHEET FLOWS TO THE CURB AND GUTTER ALONG PRINCE STREET AND SOUTH PATRICK STREET ENTERING THE CITY OF ALEXANDRIA COMBINED SEWER SYSTEM.

# STORM WATER QUALITY NARRATIVE

(CITY CODE SECTION 13-109E COMPLIANCE):

SINCE DISTURBANCE IS UNDER 2,500 SF, THIS PLAN IS EXEMPT FROM ARTICLE XIII OF THE ALEXANDRIA ZONING ORDINANCE PER SECTION 13-123(B)(1).

1. VIRGINIA - AMERICAN WATER COMPANY WILL INSTALL AND MAINTAIN ALL WATERMAINS, SERVICE CONNECTIONS AND METER

# WATER SERVICE INSTALLATION NOTES:

- SETTINGS. AN INDIVIDUAL APPLICATION FOR EACH SERVICE IS REQUIRED TO VERIFY LINE SIZE, METER SIZE AND ANY BACKFLOW REQUIREMENTS.
- 2. PERMITS FOR THE INSTALLATION OF WATER FACILITIES ON—SITE MUST BE OBTAINED BY THE DEVELOPER/CONTRACTOR FROM THE ALEXANDRIA DEPARTMENT OF TRANSPORTATION AND ENVIRONMENTAL SERVICES.
- 3. ALL WATER FACILITY CONSTRUCTION, INCLUDING BACKFLOW PREVENTION DEVICES, SHALL CONFORM TO VIRGINIA AMERICAN WATER COMPANY STANDARDS AND SPECIFICATIONS, ALEXANDRIA CITY STANDARDS AND THE STATE BOARD OF HEALTH WATERWORKS REGULATIONS.
- 4. LOCATION AND DEPTH OF THE EXISTING WATERMAIN IS TO BE FIELD VERIFIED BY THE CONTRACTOR PRIOR TO CONSTRUCTION.
- 5. WHERE A MINIMUM TEN (10) FOOT HORIZONTAL AND 18-INCH VERTICAL SEPARATION CANNOT BE MAINTAINED BETWEEN THE OUTSIDE OF THE WATERMAIN AND THE OUTSIDE OF THE SANITARY SEWER FACILITIES, THE FOLLOWING SHALL APPLY:

   A) SEWER SHALL BE CONSTRUCTED OF AWWA APPROVED WATER PIPE, PRESSURE TESTED IN PLACE WITHOUT LEAKAGE, PRIOR TO BACKFILLING.
   B) SEWER MANHOLES SHALL BE OF WATERTIGHT CONSTRUCTION AND TESTED IN PLACE.
- 6. ANY NEW FIRE SERVICES THAT ARE INSTALLED MUST BE SEPARATE CONNECTIONS TO THE WATER MAIN FROM THE DOMESTIC SERVICE.
- 7. ANY FIRE HYDRANT LATERAL OR SERVICE 1.5" OR LARGER REQUIRES A GATE VALVE AT MAIN TAP.

# LIMITS OF DISTURBANCE NOTE:

THE LIMITS OF DISTURBANCE AS SHOWN ON THIS PLAN ARE THE ULTIMATE LIMITS FOR THE PROJECT. THE CONTRACTOR MUST APPLY SEPARATELY TO THE DEPARTMENT OF TRANSPORTATION AND ENVIRONMENTAL SERVICES (T&ES) FOR ANY WORK, INCLUDING THE PLACEMENT OF CONSTRUCTION FENCING, WITHIN THE PUBLIC RIGHT OF WAY. THE CITY WILL NOT ALLOW INCLUSION OF ANY PORTION OF THE PUBLIC RIGHT OF WAY, INCLUDING SIDEWALKS, INTO THE PROJECT AREA FOR THE PROJECT DURATION. WORK AND ASSOCIATED CLOSURES IN THE PUBLIC RIGHT OF WAY WILL BE PERMITTED SEPARATELY ON AN AS NEEDED BASIS BY T&ES.

# TEST HOLE NOTES:

IT IS THE RESPONSIBILITY OF THE OWNER AND/OR CONTRACTOR TO PROVIDE THE DESIGN ENGINEER AND SURVEYOR WITH TEST HOLE INFORMATION PRIOR TO CONSTRUCTION. THE LOCATION AND DEPTH OF EXISTING UTILITIES, ESPECIALLY AT CRITICAL TIE—INS AND CROSSINGS, MUST BE PROVIDED TO ENSURE CONSTRUCTIBILITY. IT IS THE RESPONSIBILITY OF THE CONTRACTOR TO LOCATE UTILITIES HORIZONTALLY AND VERTICALLY DURING TEST PIT OPERATIONS AND PROVIDE THE INFORMATION TO THE DESIGN ENGINEER.

STAKE OUT AND CUT SHEETS OF THE PROPOSED DESIGN WILL NOT BE PERFORMED BY R.C. FIELDS AND ASSOCIATES, INC UNTIL TEST HOLES ARE PERFORMED AND DETAILED UTILITY INFORMATION IS PROVIDED.

DENOTES PROPOSED TEST HOLE LOCATION.

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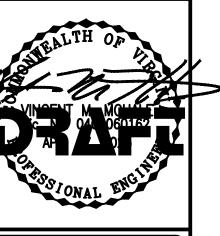
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LOCATION AND DEPTH OF ALL EXISTING UNDERGROUND UTILITIES TO BE VERIFIED BY CONTRACTOR PRIOR TO CONSTRUCTION. INTERFERENCE OR DISRUPTION OF SAME WILL NOT BE THE RESPONSIBILITY OF THIS OFFICE.

ALL CONSTRUCTION SHALL CONFORM TO THE CURRENT STANDARDS AND SPECIFICATIONS OF THE CITY OF ALEXANDRIA.

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NGINEERING • LAND SURVEYING • PLANNING OF Street Suite 220 www.rcfassoc.co



MINOR SITE PLAN AMENDMENT
LOT 2
LOT 2
PRINCE STREET SCHOOL
DEED BOOK 1024, PAGE 143
(1001 PRINCE STREET)
CITY OF ALEXANDRIA, VIRGINIA

REVISION

. INEVISION

DESIGN: VMM
CHECKED: VMM
SCALE: 1 = 10'

WATER PLAN AND PROFILE

DATE: JUN. 06,2025

SHEET 3 OF 3

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