

598 SOUTH ALFRED STREET


THE APPLICANT PROPOSES DEMOLISHING THE EXISTING TOWNHOUSES TO BUILD A MULTI-FAMILY DEVELOPMENT WITH 145 AFFORDABLE HOUSING UNITS WITH ONE LEVEL OF BELOW GRADE PARKING.

THIS SITE IS BORDERED TO THE NORTH BY A CONCRETE WALKWAY; TO THE SOUTH BY A BUILDING AND ITS ASSOCIATED PARKING LOT; TO THE EAST BY SOUTH COLUMBUS STREET; AND TO THE WEST BY SOUTH ALFRED STREET.

SITE ACCESS: THE PRIMARY ACCESS TO THE SITE WILL BE FROM SOUTH ALFRED STREET.

1. REZONING FROM RB TO RMF
2. DEVELOPMENT SPECIAL USE PERMIT WITH PRELIMINARY SITE PLAN.
3. SPECIAL USE PERMIT TO INCREASE ALLOWABLE FAR UP TO 3.0 IN THE RMF ZONE FOR THE PROVISION OF ON-SITE AFFORDABLE HOUSING IN ACCORDANCE WITH SECTION 3-1406(B)

engineering • surveying • land planning
4035 Ridge Top Rd., Suite 601, Fairfax, VA 22030
phone 703.273.6820 fax 703.273.7636

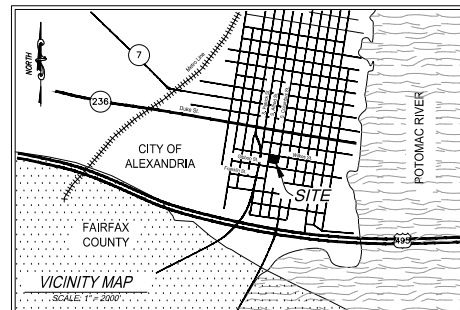

	New	Upgraded
Crosswalks (number)	0	0
Standard	0	0
High Visibility	0	0
Curb Ramps	0	0
Sidewalks (LF)	158'	790'
Bicycle Parking (number of spaces)		
Public/Visitor	8	N/A
Private/Garage	44	N/A
Bicycle Paths (LF)	0	N/A
Pedestrian Signals	0	0

SHEET INDEX	
Sheet Number	Sheet Title
C100	COVER
C101	NOTES AND TABULATIONS
C200	EXISTING CONDITION PLAN
C201	TREE PRESERVATION PLAN
C202	TREE PRESERVATION TABULATION
C203	TREE PRESERVATION NOTES AND DETAILS
C210	CONTEXTUAL SITE PLAN
C300	PRELIMINARY SITE PLAN
C400	PRELIMINARY GRADING
C401	AVERAGE FINISHED GRADE
C402	PRELIMINARY DIMENSION PLAN
C403	FIRE SAFETY PLAN
C500	OPEN SPACE PLAN
C700	PRELIMINARY BMP MAP
C701	PRELIMINARY BMP COMPUTATIONS
C702	BMP DETAILS
C703	BMP DE TAILS
C720	PRELIMINARY SWIM AND OUTFALL ANALYSIS
C721	PRELIMINARY SANITARY OUTFALL ANALYSIS
C900	TURNING MOVEMENTS
C901	TURNING MOVEMENTS
C902	TURNING MOVEMENTS
C903	TURNING MOVEMENTS
C904	TURNING MOVEMENTS
C905	TURNING MOVEMENTS
C906	TURNING MOVEMENTS
C907	TURNING MOVEMENTS
C908	TURNING MOVEMENTS
C910	PRELIMINARY SIGHT DISTANCE
C920	PHOTOMIC TRIP PLAN
L100	LANDSCAPE PLAN
L101	LANDSCAPE PLAN, COURTYARD
L200	LANDSCAPE SCHEDULE AND CALCULATIONS
L300	LANDSCAPE SPECIFICATIONS AND DETAILS
A-100	CODE ANALYSIS
A-200	GRADE LEVEL P1 PLAN
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A-301	BUILDING ELEVATIONS
A-302	ELEVATIONS MATERIALS
A-401	BUILDING SECTIONS
A-401	AREAL VIEW
A-502	SUNSHADE STUDY
A-602	PERSPECTIVE

<p>JOHN L. HELMS Lic. No. 52485 10/03/2025 PROFESSIONAL ENGINEER</p>	<u>DATE</u>	<u>REVISION</u>
	07/11/25	PRELIMINARY O&UP SUBMISSION
	09/16/25	COMPLETENESS SUBMISSION
	10/03/25	VERIFICATION RESUBMISSION

**ATTORNEY
WIRE GILL**
700 N. FAIRFAX STREET, SUITE 600
ALEXANDRIA, VA 22314
(703) 835-1922

<p>APPROVED</p> <p>SPECIAL USE PERMIT NO. <u>XXXX-XXXX</u></p> <p>DEPARTMENT OF PLANNING & ZONING</p>		
DIRECTOR _____	DATE _____	
DEPARTMENT OF TRANSPORTATION & ENVIRONMENTAL SERVICES		
SITE PLAN NO. _____		
DIRECTOR _____	DATE _____	
CHAIRMAN, PLANNING COMMISSION _____ DATE _____		
DATE RECORDED _____		
INSTRUMENT NO. _____	DEED BOOK NO. _____	PAGE NO. _____

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C

B

A

4

CITY OF ALEXANDRIA, VIRGINIA

[illegible]

Q

07-03-2025

Quinn Nolan
ISA Certified Arborist, NE-7474A
4035 Ridge Top Road, Suite 601
Fairfax, VA 22030
703.234.1551
quinn.nolan@imegcorp.com

<h1>APPROVED</h1> <p>SPECIAL USE PERMIT NO. <u>XXXX-XXXX</u></p> <p>DEPARTMENT OF PLANNING & ZONING</p>		
DIRECTOR _____	DATE _____	
DEPARTMENT OF TRANSPORTATION & ENVIRONMENTAL SERVICES		
SITE PLAN NO. _____		
DIRECTOR _____	DATE _____	
CHAIRMAN, PLANNING COMMISSION _____ DATE _____		
DATE RECORDED _____		
INSTRUMENT NO. _____	DEED BOOK NO. _____	PAGE NO. _____

OBJECT No.: 24001431.00
DRAWING No.: 113952
DATE: 10/03/2025
SCALE: NOT TO SCALE
SIGN: QCN
DRAWN: QCN
CHECKED: EG/JM


TREE PRESERVATION TABULATIONS

FET No. _____

C202



<h1 style="margin: 0;">APPROVED</h1> <p style="margin: 5px 0;">SPECIAL USE PERMIT NO. <u>XXXX-XXXXXX</u></p> <p style="margin: 5px 0;">DEPARTMENT OF PLANNING & ZONING</p>		
DIRECTOR _____	DATE _____	
DEPARTMENT OF TRANSPORTATION & ENVIRONMENTAL SERVICES SITE PLAN NO. _____		
DIRECTOR _____	DATE _____	
CHAIRMAN, PLANNING COMMISSION _____		
DATE RECORDED _____		
INSTALLMENT NO. _____	FEED BOOK NO. _____	
PAGE NO. _____		

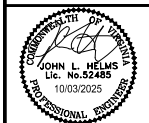

OLDE TOWNE WEST AFFORDABLE HOUSING DEVELOPMENT
PRELIMINARY DEVELOPMENT SPECIAL USE PERMIT

CITY OF ALEXANDRIA, VIRGINIA

DATE	DESCRIPTION
10/03/2025	PRELIMINARY SUBMISSION
10/03/2025	COMPLETION SUBMISSION
10/03/2025	VERIFICATION SUBMISSION

PROJECT NO.: 24001431.00
DRAWING NO.: 113952
DATE: 10/03/2025
SCALE: 1" = 40'
DESIGN: EG
DRAWN: JS
CHECKED: EG

SHEET TITLE:

PRELIMINARY BMP MAP

SHEET No. **C700**

APPROVED
SPECIAL USE PERMIT NO. XXXX-XXXX
DEPARTMENT OF TRANSPORTATION & ENVIRONMENTAL SERVICES
DEPARTMENT OF PLANNING & ZONING

DIRECTOR _____ DATE _____

SITE PLAN NO. _____

DIRECTOR _____ DATE _____

DATE RECORDED _____

INSTRUMENT NO. _____ DEED BOOK NO. _____ PAGE NO. _____

EXISTING CONDITION SITE NARRATIVE

THIS SITE IS 1.18 ACRES AND IS AN RESIDENTIAL AREA. THE SITE IS BORDERED TO THE NORTH BY AN EXISTING PARK TO THE SOUTH BY A RESIDENTIAL AREA, TO THE EAST BY SOUTH COLUMBUS STREET, AND TO THE WEST BY SOUTH ALFRED STREET.

REVIEW OF EXISTING TOPOGRAPHY INDICATES THAT THE PROPERTY DRAINS FROM THE SOUTH TO NORTH. MOST OF THE SITE DRAINS TO AN EXISTING STORM SYSTEM THAT RUNS NORTH DOWN TO THE STORM AT THE INTERSECTION OF WILKES STREET AND COLUMBUS STREET.

THERE ARE NO RESOURCE PROTECTION AREAS ON THIS PROPERTY.

PROPOSED CONDITION SITE NARRATIVE

THIS PROJECT PROPOSES TO DEMOLISH THE EXISTING TOWNHOUSES TO BUILD A MULTIFAMILY DEVELOPMENT WITH 140 AFFORDABLE HOUSING UNITS WITH ONE LEVEL OF BELOW GRADE PARKING.

WATER QUALITY TREATMENT (WQV) NARRATIVE

TO COMPLY WITH THE CHESAPEAKE BAY ACT (CBA) AND ARTICLE XII OF THE ZONING ORDINANCE, THE PROJECT WILL PROVIDE WATER QUALITY TREATMENT THROUGH THE USE OF RAIN GARDENS.

THE RAIN GARDENS WILL TREAT APPROXIMATELY 0.88 ACRES OF IMPERVIOUS RUNOFF FROM THE BUILDING

SITE AREA
PER CITY CODE SECTION 13-103-4, THE TOTAL SITE THE ENTIRE PARCEL SINCE GREATER THAN 50% OF THE TAX PARCEL IS BEING DISTURBED. THIS TOTAL SITE AREA IS 1.18 ACRES AND THIS VAULE WILL BE USED FOR THE WQV CALCULATIONS. FOR THE BMP/SWM CALCULATIONS, THE LIMITS OF DISTURBANCE AREA OF 1.43 AC IS BEING USED.

WQV TREATMENT
THE WQV TO BE TREATED AS PER THE CITY OF ALEXANDRIA SUPPLEMENT TO THE NORTHERN VIRGINIA BMP HANDBOOK IS 1816 CU FT/ ACRE OF IMPERVIOUS SURFACE.
THEREFORE WQV REQUIRED = $1.18 \times 1,816 = 2,143$ CU FT. SEE WQV CALCULATIONS ON THIS SHEET.

MEMO TO INDUSTRY 01-18 REQUIREMENT:

THIS CITY REQUIREMENT IF FOR THE TREATMENT OF 60% OF THE STATES REQUIREMENT BY NON-PROPRIETARY BMP FACILITIES. THIS REQUIRES A TOTAL OF 0.37 LBS OF PHOSPHORUS BE REMOVED PER YEAR. THIS REQUIREMENT IS MET WITH RAIN GARDENS. THESE BMP PRACTICES REMOVE 0.44 LBS OF PHOSPHORUS A YEAR.

BMP MAINTENANCE AGREEMENT NOTE:

THE APPLICANT SHALL EXECUTE A MAINTENANCE SERVICE CONTRACT WITH A PRIVATE CONTRACTOR FOR A MINIMUM OF THREE YEARS. A COPY OF THE CONTRACT SHALL BE PLACED IN THE BMP OPERATION AND MAINTENANCE MANUAL. PRIOR TO ISSUANCE OF THE CERTIFICATE OF OCCUPANCY, A COPY OF THE CONTRACT SHALL BE SUBMITTED TO THE CITY. THE APPLICANT SHALL PREPARE AN OWNER'S OPERATION AND MAINTENANCE MANUAL FOR ALL THE BEST MANAGEMENT PRACTICES (BMPs) USED ON SITE. THE MANUAL SHALL INCLUDE AT A MINIMUM: AN EXPLANATION OF THE FUNCTIONS AND OPERATIONS OF THE BMPs; DRAWINGS AND DIAGRAMS OF THE BMPs; AND ANY SUPPORTING UTILITIES, CATALOG CUTS ON MAINTENANCE REQUIREMENTS, MANUFACTURER CONTACT NAMES AND PHONE NUMBERS. A COPY OF THE EXECUTED MAINTENANCE SERVICE CONTRACT AND A COPY OF THE MAINTENANCE AGREEMENT WITH THE CITY, PRIOR TO ISSUANCE OF THE CERTIFICATE OF OCCUPANCY, A COPY OF THE OPERATION AND MAINTENANCE MANUAL SHALL BE SUBMITTED TO THE CITY ON A DIGITAL MEDIA.

DESIGN PROFESSIONAL INSPECTION NOTE

THE STORMWATER BEST MANAGEMENT PRACTICES (BMPs) REQUIRED FOR THIS PROJECT SHALL BE CONSTRUCTED AND INSTALLED UNDER THE DIRECT SUPERVISION OF THE DESIGN PROFESSIONAL OR HIS DESIGNATED REPRESENTATIVE. PRIOR TO ISSUANCE OF THE CERTIFICATE OF OCCUPANCY, THE DESIGN PROFESSIONAL SHALL SUBMIT A WRITTEN CERTIFICATION TO THE DIRECTOR OF TIES THAT THE BMPs ARE:
A. CONSTRUCTED AND INSTALLED AS DESIGNED AND IN ACCORDANCE WITH THE APPROVED FINAL SITE PLAN.
B. CLEAN AND FREE OF DEBRIS, SOIL AND LITTER BY EITHER HAVING BEEN INSTALLED OR BROUGHT INTO SERVICE AFTER SITE WAS STABILIZED.

STORM WATER MANAGEMENT / BEST MANAGEMENT PRACTICES NARRATIVE:

TO COMPLY WITH THE STORM WATER REQUIREMENTS IN ACCORDANCE WITH ARTICLE XIII OF THE ZONING ORDINANCE, THIS PROJECT WILL PROVIDE ON-SITE TREATMENT OF SITE RUNOFF THROUGH THE USE OF MULTIPLE CITY-APPROVED BMP FACILITIES OR STRUCTURES TO MEET BOTH POLLUTANT LOAD REDUCTION AND THE WATER QUALITY VOLUME DEFAULT. IF WE CANNOT EFFECTIVELY TREAT A SMALL PORTION OF THE ON-SITE PROPOSED IMPERVIOUS COVER, WE WILL SUBMIT A REQUEST IN WRITING TO PROVIDE AN IN-PLACE PAYMENT FOR THAT PORTION OF IMPERVIOUS AREA.

WQV CALCULATIONS

REQUIRED = $(1,816 \text{ CU FT/ACRE}) \times (1.18 \text{ ACRES}) = 2,143 \text{ CU FT}$

PROVIDED (ON-SITE) = $(1,816 \text{ CU FT/ACRE}) \times (0.88 \text{ ACRES}) = 1,598 \text{ CU FT}$

TOTAL WQV REMAINING = $2,143 \text{ CU FT} - 1,598 \text{ CU FT} = 545 \text{ CU FT}$

IMPERVIOUS AREA COVERAGE

TOTAL IMPERVIOUS AREA = 1.18 ACRES

TOTAL IMPERVIOUS TREATED (ON-SITE) = 0.88 ACRES

TOTAL IMPERVIOUS AREA UNTREATED = $1.18 \text{ AC} - 0.88 \text{ AC} = 0.30 \text{ AC}$

NOTE:

- A CONTRIBUTION TO THE WQV IS BEING REQUESTED FOR THE UNTREATED IMPERVIOUS AREA (0.30 AC OR 13,068 SF) OF THE SITE.
- 75% OF THE IMPERVIOUS AREA PROPOSED WITH THIS PROJECT IS CAPTURED AND TREATED.
- A CONTRIBUTION TO THE WQV WILL BE MADE FOR THE UNTREATED IMPERVIOUS AREA.

DEQ Virginia Runoff Reduction Method Re-Development Compliance Spreadsheet - Version 4.1

Project Name: ABCD OUP - 588 S Alford
Date: 7/10/2025
Linear Development Project? No

Site Information
Post-Development Project (Treatment Volume and Loads)

Enter Total Disturbed Area (acres) = 1.29
Maximum reduction required: 20%
The other net increase in impervious cover (added in Post-Development TP Load Reduction for Site (lb/yr)) = 0.88

Pre-Development Land Cover (acres)

	A Soils	B Soils	C Soils	D Soils	Totals
Forest (acres)	0.00	0.00	0.00	0.00	0.00
Mixed Open (acres)	0.00	0.00	0.00	0.00	0.00
Managed Turf (acres)	0.00	0.00	0.00	0.00	0.00
Impervious Cover (acres)	0.00	0.00	0.00	0.00	0.00
Impervious Load (lb/yr)	0.00	0.00	0.00	0.00	0.00

Post-Development Land Cover (acres)

	A Soils	B Soils	C Soils	D Soils	Totals
Forest (acres)	0.00	0.00	0.00	0.00	0.00
Mixed Open (acres)	0.00	0.00	0.00	0.00	0.00
Managed Turf (acres)	0.00	0.00	0.00	0.00	0.00
Impervious Cover (acres)	0.00	0.00	0.00	0.00	0.00
Impervious Load (lb/yr)	0.00	0.00	0.00	0.00	0.00

Post-Development Requirement for Site Area
TP Load Reduction Required (lb/yr) = 0.87

Nitrogen Loads (Informational Purposes Only)
Pre-Development TN Load (lb/yr) = 0.00
Post-Development TN Load = 0.00

Drainage Area A

Drainage Area A Land Cover (acres)	A Soils	B Soils	C Soils	D Soils	Totals	Land Cover Rr	Composite Loading P
Forest (acres)	0.00	0.00	0.00	0.00	0.00	0.00	0.00
Mixed Open (acres)	0.00	0.00	0.00	0.00	0.00	0.00	0.00
Managed Turf (acres)	0.00	0.00	0.00	0.00	0.00	0.00	0.00
Impervious Cover (acres)	0.00	0.00	0.00	0.00	0.00	0.00	0.00
Total	0.00	0.00	0.00	0.00	0.00	0.00	0.00

Stormwater Best Management Practices (RR = Runoff Reduction)

Practice	Runoff Reduction Credit (%)	Mixed Open Credit Area (acres)	Managed Turf Credit Area (acres)	Impervious Cover Credit Area (acres)	Volume from Upstream Practice (ft³)	Runoff Reduction (ft³)	Remaining Runoff Volume (ft³)	Total BMP Treatment Volume (ft³)	Phosphorus Removal Efficiency (%)	Phosphorus Load from Upstream Practices (lb)	Untreated Phosphorus Load to Practice (lb)	Phosphorus Removed by Practice (lb)	Remaining Phosphorus Load (lb)	Downstream Practice to be Employed
6. Bioretention (RR)	40	0.00	0.00	0.00	0	415	652	1,087	25	0.00	0.28	0.16	0.13	Downstream Practice to be Employed

Drainage Area B

Drainage Area B Land Cover (acres)	A Soils	B Soils	C Soils	D Soils	Totals	Land Cover Rr	Composite Loading P
Forest (acres)	0.00	0.00	0.00	0.00	0.00	0.00	0.00
Mixed Open (acres)	0.00	0.00	0.00	0.00	0.00	0.00	0.00
Managed Turf (acres)	0.00	0.00	0.00	0.00	0.00	0.00	0.00
Impervious Cover (acres)	0.00	0.00	0.00	0.00	0.00	0.00	0.00
Total	0.00	0.00	0.00	0.00	0.00	0.00	0.00

Stormwater Best Management Practices (RR = Runoff Reduction)

Practice	Runoff Reduction Credit (%)	Mixed Open Credit Area (acres)	Managed Turf Credit Area (acres)	Impervious Cover Credit Area (acres)	Volume from Upstream Practice (ft³)	Runoff Reduction (ft³)	Remaining Runoff Volume (ft³)	Total BMP Treatment Volume (ft³)	Phosphorus Removal Efficiency (%)	Phosphorus Load from Upstream Practices (lb)	Untreated Phosphorus Load to Practice (lb)	Phosphorus Removed by Practice (lb)	Remaining Phosphorus Load (lb)	Downstream Practice to be Employed
6. Bioretention (RR)	40	0.00	0.00	0.00	0	797	1,196	1,993	25	0.00	0.51	0.28	0.23	Downstream Practice to be Employed

Site Results (Water Quality Compliance) VRRM 4.1, 2024

Area Checks	D.A. A	D.A. B	D.A. C	D.A. D	D.A. E	AREA CHECK
FOREST (ac)	0.00	0.00	0.00	0.00	0.00	OK
MIXED OPEN (ac)	0.00	0.00	0.00	0.00	0.00	OK
MIXED OPEN AREA TREATED (ac)	0.00	0.00	0.00	0.00	0.00	OK
MANAGED TURF AREA (ac)	0.00	0.00	0.00	0.00	0.00	OK
MANAGED TURF AREA TREATED (ac)	0.00	0.00	0.00	0.00	0.00	OK
IMPERVIOUS COVER (ac)	0.00	0.00	0.00	0.00	0.00	OK
IMPERVIOUS COVER TREATED (ac)	0.00	0.00	0.00	0.00	0.00	OK
AREA CHECK	OK	OK	OK	OK	OK	OK

Site Treatment Volume (ft³)

Runoff Reduction Volume and TP by Drainage Area	D.A. A	D.A. B	D.A. C	D.A. D	D.A. E	TOTAL
RUNOFF REDUCTION VOLUME ACHIEVED (ft³)	415	797	0	0	0	1,212
TP LOAD AVAILABLE FOR REMOVAL (lb/yr)	0.00	0.00	0.00	0.00	0.00	0.00
TP LOAD REDUCTION ACHIEVED (lb/yr)	0.00	0.00	0.00	0.00	0.00	0.00
TP LOAD REMAINING (lb/yr)	0.00	0.00	0.00	0.00	0.00	0.00
NITROGEN LOAD REDUCTION ACHIEVED (lb/yr)	0.00	0.00	0.00	0.00	0.00	0.00

Total Phosphorus

FINAL POST-DEVELOPMENT TP LOAD (lb/yr)	0.00
TP LOAD REDUCTION REQUIRED (lb/yr)	0.00
TP LOAD REDUCTION ACHIEVED (lb/yr)	0.00
TP LOAD REMAINING (lb/yr)	0.00
REMAINING TP LOAD REDUCTION REQUIRED (lb/yr)	0.00
Total Nitrogen (For Information Purposes)	0.00
POST-DEVELOPMENT LOAD (lb/yr)	0.00
NITROGEN LOAD REDUCTION ACHIEVED (lb/yr)	0.00
REMAINING POST-DEVELOPMENT NITROGEN LOAD (lb/yr)	0.00

Project Description

Development or Redevelopment	Impervious	Pervious	Total
Drainage Area	1.18 AC	0.11 AC	1.29 AC
Site Area	0.88 AC	0.05 AC	0.93 AC
On-Site Treated	0.00 AC	0.00 AC	0.00 AC
Off-Site Treated	0.00 AC	0.00 AC	0.00 AC
Total Treated	0.00 AC	0.00 AC	0.00 AC
Any On-Site Disconnected by a Vegetated Buffer (25 ft)	0.00 AC	0.00 AC	0.00 AC
Total On-Site Treated or Disconnected	0.00 AC	0.00 AC	0.00 AC

Water Treatment on site

BMP Type	Area treated by BMP (acres)	Impervious area treated by BMP (acres)	BMP efficiency (%)
WQV BIORETENTION A	0.33 AC	0.31 AC	25
WQV BIORETENTION B	0.60 AC	0.57 AC	25

Miscellaneous

Total WQV treated: yes
Detection on site: yes
Project is within which watershed? COMBINED SEWER SYSTEM
Project discharges to which body of water? POTOMAC RIVER

BMP TREATMENT FACILITIES NOTE:

REFERENCE BMP TREATMENT FACILITIES AND THEIR ASSOCIATED TREATED AREAS ARE PRELIMINARY AND MAY BE ADJUSTED WITH THE FINAL SITE PLAN. FINAL BMP TREATMENT FACILITIES WILL MEET CITY AND STATE REQUIREMENTS.

APPROVED
SPECIAL USE PERMIT NO. XXXX-XXXX
DEPARTMENT OF TRANSPORTATION & ENVIRONMENTAL SERVICES
SITE PLAN NO. ____
DIRECTOR _____ DATE _____
DEPARTMENT OF PLANNING & ZONING
SUBMITTAL PLANNING COMMISSION _____ DATE _____
DATE RECORDED _____
INSTRUMENT NO. _____ DEED BOOK NO. _____ PAGE NO. _____



OLDE TOWNE WEST AFFORDABLE HOUSING DEVELOPMENT
PRELIMINARY DEVELOPMENT SPECIAL USE PERMIT
CITY OF ALEXANDRIA, VIRGINIA

DATE	DESCRIPTION
07/10/25	PRELIMINARY BMP SUBMISSION
08/05/25	COMPLETION SUBMISSION
09/05/25	VERIFICATION SUBMISSION

PROJECT NO.: 2801431.00
DRAWING NO.: 113952
DATE: 10/03/2025
SCALE: NONE
DESIGN: EG
DRAWN: JS
CHECKED: EG

SHEET TITLE:
PRELIMINARY BMP COMPUTATIONS

SHEET No.: C701

BIORETENTION A

VA DEQ STORMWATER DESIGN SPECIFICATION NO. 9

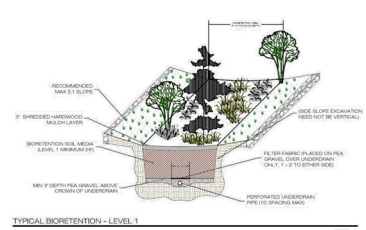


Figure 9.4a: Typical Detail of Bioretention Basin Level 1 Design


VA DEQ STORMWATER DESIGN SPECIFICATION NO. 9

Material	Specification	Notes
Filter Media Composition	Filter Media to contain: <ul style="list-style-type: none"> 65%-80% sand 8%-12% soil fines 3%-5% organic matter in the form of leaf compost 	The volume of filter media based on 110% of the plan volume, to account for settling or compaction.
Filter Media Testing	P-Index range = 15-30, OR Between 7 and 21 mg/kg of P in the soil media.	The media must be procured from approved filter media vendors.
Mulch Layer	Use aged, shredded hardwood bark mulch.	Use a 2 to 3 inch layer on the surface of the filter bed.
Alternative Surface Cover	Use river stone or pea gravel, cor and jute matting, or turf cover.	Use a 2 to 3 inch layer of to suppress weed growth.
Top Soil For Turf Cover	Loamy sand or sandy loam texture, with less than 5% clay content, pH corrected to between 6 and 7, and an organic matter content of at least 2%.	3 inch surface depth.
Geotextile/Liner	Use a non-woven geotextile fabric with a flow rate of > 110 gal/min/ft ² (e.g., Geotex 351 or equivalent).	Apply only to the sides and above the underdrain. For hotspots and certain karst sites only, use an appropriate liner on bottom.
Choking Layer	Lay a 2 to 4 inch layer of sand over a 2 inch layer of choker stone (typically #8 or #10 washed gravel), which is laid over the underdrain stone.	12 inches for the underdrain; 12 to 18 inches for the stone storage layer, if needed.
Stone Jacket for Underdrain and/or Storage Layer	Use 6 inch rigid schedule 40 PVC pipe for equivalent corrugated HDPE for micro-bioretenion, with 3/8-inch perforations at 6 inches on center, position each underdrain on a 1% or 2% slope located not more than 20 feet from the next pipe.	12 inches for the underdrain; 12 to 18 inches for the stone storage layer, if needed.
Underdrains, Cleanouts, and Observation Wells	Plant one tree per 250 square feet (15 feet on-center, minimum 1 inch caliper). Shrubs a minimum of 30 inches high planted a minimum of 10 feet on-center. Plant ground cover plugs at 12 to 18 inches on-center. Plant container-grown plants at 18 to 24 inches on-center, depending on the initial plant size and how large it will grow.	In general, plant spacing must be sufficient to ensure the plant material achieves 80% cover in the proposed planting areas within a 5-year period. If seed mixes are used, they should be from a qualified supplier, should be appropriate for stormwater basin applications, and should consist of native species (unless the seeding is to establish maintained turf).
Plant Materials		

Version 1.0, March 1, 2011

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RISER DETAIL STRUCTURE

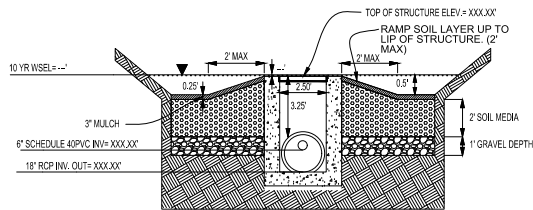

* SEE STANDARD DROP INLET VDOT DETAIL FOR FURTHER SPECIFICATIONS

VA DCR STORMWATER DESIGN SPECIFICATION NO. 9

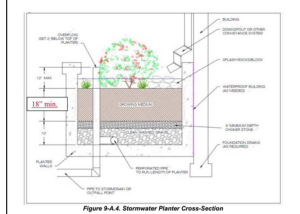


Figure 9.4.4: Stormwater Planter Cross-Section

MICRO-BIORETENTION A - CALCULATIONS

STORAGE DEPTH
SOIL MEDIA V = 0.25
GRAVEL V = 0.40
SURFACE STORAGE V = 1.0
(2 X 0.25) + (1 X 0.4) + (1 X 0.5) = 1.4 FT

MEGA DEPTH = 2 FT
GRAVEL DEPTH = 1 FT
PONDING DEPTH = 0.5 FT

SURFACE AREA = TV / STORAGE DEPTH
TV = 1.067 CF
STORAGE DEPTH = 1.4 FT.

SURFACE AREA REQUIRED = 1.067 / 1.4 = 776 SF


SURFACE AREA PROVIDED MICRO-BIORETENTION A = 832 SF

832 SF > 776 SF SURFACE AREA REQUIREMENT SATISFIED

TABLE 9.2 MICRO-BIORETENTION


LEVEL 1 DESIGN (RR 40 TP-25) CRITERIA	BIORETENTION A
SIZING: FILTER SURFACE AREA (SQ. FT.) = 5% OF THE CONTRIBUTING DRAINAGE AREA (CDA) FROM DOWNSPUTS	1,067 SF (SEE SHEET #C701)
MAXIMUM CONTRIBUTION AREA = 0.5 AC	0.33 AC
MAXIMUM PONDING DEPTH = 6 INCHES	6 INCHES
FILTER MEDIA DEPTH MINIMUM = 18 INCHES; MAXIMUM = 36 INCHES	24 INCHES
SUB-SOIL TESTING: NOT NEEDED IF AN UNDERDRAIN IS USED.	NOT NEEDED
UNDERDRAIN = CORRUGATED HDPE OR EQUIVALENT	YES
PRE-TREATMENT: EXTERNAL LEAF SCREENS, GRASS FILTER STRIP, ENERGY DISSIPATER, ETC.	LEAF SCREEN
VEGETATION: TURF, HERBACEOUS, OR SHRUBS (MIN = 1 OVR OF THOSE 3 CHOICES)	SHRUBS
GEOGRAPHIC COORDINATES (NAD83)	(6,977,893.91, 11,896,116.32)

NOTE: BIORETENTION TO BE PRIVATELY MAINTAINED.

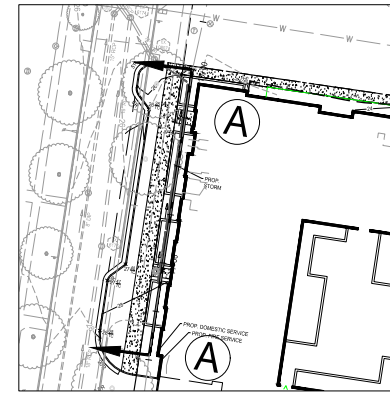

PLAN VIEW
SCALE: 1"=30'

BIORETENTION A-A' CROSS SECTION
SCALE: 1"=50'(H); 1"=5'(V)

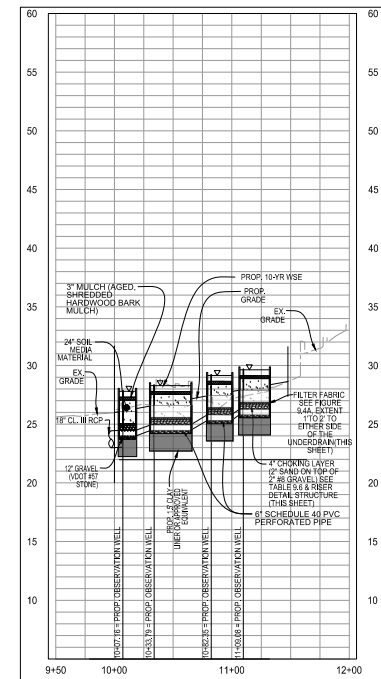

APPROVED
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DEPARTMENT OF TRANSPORTATION & ENVIRONMENTAL SERVICES
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INSTRUMENT NO. _____ DEED BOOK NO. _____ PAGE NO. _____

DIRECTOR _____ DATE _____
DEPARTMENT OF TRANSPORTATION & ENVIRONMENTAL SERVICES
SHEET TITLE: _____
BMP DETAILS
SHEET No. _____
C702



OLDE TOWNE WEST AFFORDABLE HOUSING DEVELOPMENT
PRELIMINARY DEVELOPMENT SPECIAL USE PERMIT
CITY OF ALEXANDRIA, VIRGINIA

MARK	DATE	DESCRIPTION
07/17/25		PRELIMINARY SUBMITTAL
08/19/25		COMPLETION SUBMITTAL
10/02/25		VERIFICATION SUBMITTAL

PROJECT NO.: 2801431.00
DRAWING NO.: 113952
DATE: 10/03/2025
SCALE: NONE
DESIGN: EG
DRAWN: JS
CHECKED: EG

SHEET TITLE: _____
BMP DETAILS
SHEET No. _____
C702

BIORETENTION B

VA DEG STORMWATER DESIGN SPECIFICATION NO. 9

BIORETENTION

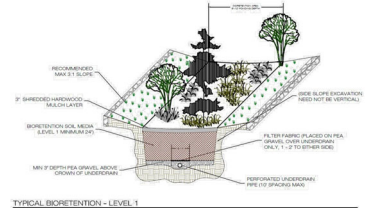


Figure 9.4a: Typical Detail of Bioretention Basin Level 1 Design

VA DEG STORMWATER DESIGN SPECIFICATION NO. 9

BIORETENTION


Table 9.6. Bioretention Material Specifications

Material	Specification	Notes
Filter Media Composition	Filter Media to contain: <ul style="list-style-type: none"> 65%-80% sand 8%-12% soil fines 3%-5% organic matter in the form of leaf compost 	The volume of filter media based on 110% of the plan volume, to account for settling or compaction.
Filter Media Testing	P-Index range = 15-30, OR Between 7 and 21 mg/kg of P in the soil media.	The media must be procured from approved filter media vendors.
Mulch Layer	Use aged, shredded hardwood bark mulch.	Lay a 2 to 3 inch layer on the surface of the filter bed.
Alternative Surface Cover	Use river stone or pea gravel, cor and jute matting, or turf cover.	Lay a 2 to 3 inch layer of to suppress weed growth.
Top Soil For Turf Cover	Loamy sand or sandy loam texture, with less than 5% clay content, pH corrected to between 6 and 7, and an organic matter content of at least 2%.	3 inch surface depth.
Geotextile/Liner	Use a non-woven geotextile fabric with a flow rate of > 110 gal/min/ft ² (e.g., Geotex 351 or equivalent).	Apply only to the sides and above the underdrain. For hotspots and certain karst sites only, use an appropriate liner on bottom.
Choking Layer	Lay a 2 to 4 inch layer of sand over a 2 inch layer of choker stone (typically #8 or #88 washed gravel), which is laid over the underdrain stone.	12 inches for the underdrain; 12 to 18 inches for the stone storage layer, if needed.
Stone Jacket for Underdrain and/or Storage Layer	Use 6 inch rigid schedule 40 PVC pipe for equivalent corrugated HDPE for micro-bioretentation, with 3/8 inch perforations at 6 inches on center; position each underdrain on a 1% or 2% slope located not more than 20 feet from the plant pipe.	12 inches for the underdrain; 12 to 18 inches for the stone storage layer, if needed.
Underdrains, Cleanouts and Observation Wells	Plant one tree per 250 square feet (10 feet on-center, minimum 1 inch caliper). Shrubs a minimum of 30 inches high planted a minimum of 10 feet on-center. Plant ground cover plugs at 12 to 18 inches on-center. Plant container-grown plants at 18 to 24 inches on-center, depending on the initial plant size and how large it will grow.	Establish plant materials as specified in the landscaping plan and the recommended plant list. In general, plant spacing must be sufficient to ensure the plant material achieves 80% cover in the proposed planting areas within a 5-year period. If seed mixes are used, they should be from a qualified supplier, should be appropriate for stormwater basin applications, and should consist of native species (unless the seeding is to establish maintained turf).
Plant Materials		

Version 1.0, March 1, 2011

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RISER DETAIL STRUCTURE

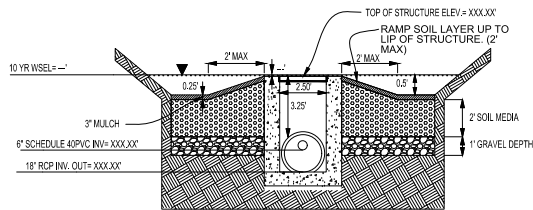

* SEE STANDARD DROP INLET VDOT DETAIL FOR FURTHER SPECIFICATIONS

VA DCR STORMWATER DESIGN SPECIFICATION NO. 9

BIORETENTION

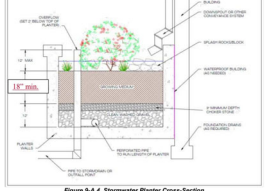


Figure 9.4.4: Stormwater Planter Cross-Section

MICRO-BIORETENTION B - CALCULATIONS

STORAGE DEPTH
SOIL MEDIA V₁ = 0.25
GRAVEL V₂ = 0.40
SURFACE STORAGE V₃ = 1.0
(4 X 0.25) + (1 X 0.4) + (1 X 0.5) = 1.9 FT

MEAN DEPTH = 4 FT
GRAVEL DEPTH = 1 FT
PONDING DEPTH = 0.5 FT

SURFACE AREA = TV / STORAGE DEPTH
TV = 1,993 CF
STORAGE DEPTH = 1.9 FT.

SURFACE AREA REQUIRED = 1,993 / 1.9 = 1048 SF


SURFACE AREA PROVIDED MICRO-BIORETENTION A = 1,056 SF

1,056 SF > 1,048 SF SURFACE AREA REQUIREMENT SATISFIED

TABLE 9.2 MICRO-BIORETENTION


LEVEL 1 DESIGN (RR 40 TP-25) CRITERIA	BIORETENTION B
SIZING: FILTER SURFACE AREA (SQ. FT.) = 5% OF THE CONTRIBUTING DRAINAGE AREA (CDA) FROM DOWNSPOTS	1,993 SF (SEE SHEET #C701)
MAXIMUM CONTRIBUTION AREA = 0.5 AC	0.60 AC
MAXIMUM PONDING DEPTH = 6 INCHES	6 INCHES
FILTER MEDIA DEPTH MINIMUM = 18 INCHES; MAXIMUM = 36 INCHES	24 INCHES
SUB-SOIL TESTING: NOT NEEDED IF AN UNDERDRAIN IS USED.	NOT NEEDED
UNDERDRAIN = CORRUGATED HDPE OR EQUIVALENT	YES
PRE-TREATMENT: EXTERNAL LEAF SCREENS, GRASS FILTER STRIP, ENERGY DISSIPATER, ETC.	LEAF SCREEN
VEGETATION: TURF, HERBACEOUS, OR SHRUBS (MIN = 1 OUR OF THOSE 3 CHOICES)	SHRUBS
GEOGRAPHIC COORDINATES (NAD83)	(6,977,860.41, 11,896,351.22)

NOTE: BIORETENTION TO BE PRIVATELY MAINTAINED.

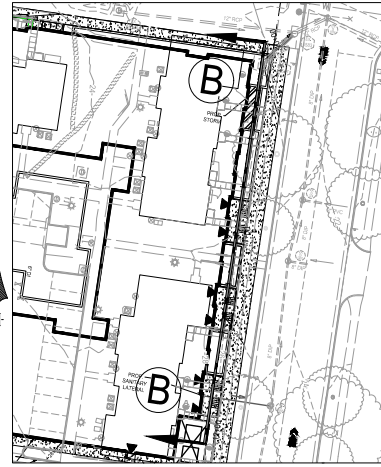

PLAN VIEW
SCALE: 1"=30'

BIORETENTION B-B' CROSS SECTION SCALE: 1"=50'(H); 1"=5'(V)

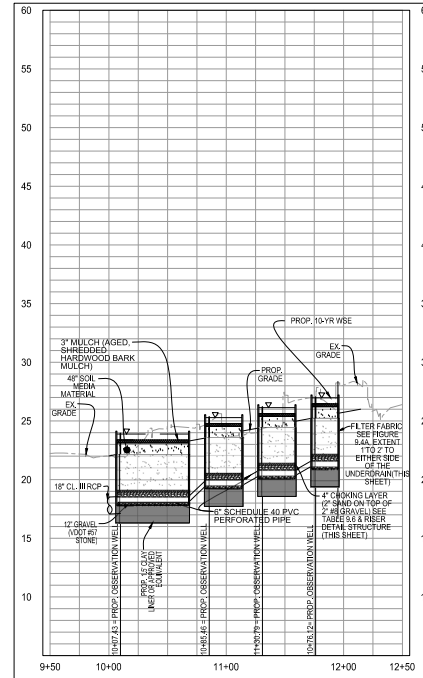

APPROVED SPECIAL USE PERMIT NO. XXXX-XXXXX

DIRECTOR _____ DATE _____
DEPARTMENT OF TRANSPORTATION & ENVIRONMENTAL SERVICES
SITE PLAN NO. _____
DIRECTOR _____ DATE _____

SUBMITTAL PLANNING COMMISSION _____ DATE _____
DATE RECORDED _____
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CITY OF ALEXANDRIA, VIRGINIA

DATE	DESCRIPTION
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08/19/25	COMPLETENESS SUBMISSION
10/03/25	VERIFICATION SUBMISSION


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DRAWING NO.: 113952
DATE: 10/03/2025
SCALE: NONE
DESIGN: EG
DRAWN: JS
CHECKED: EG

SHEET TITLE:

BMP DETAILS

SHEET No.

C703

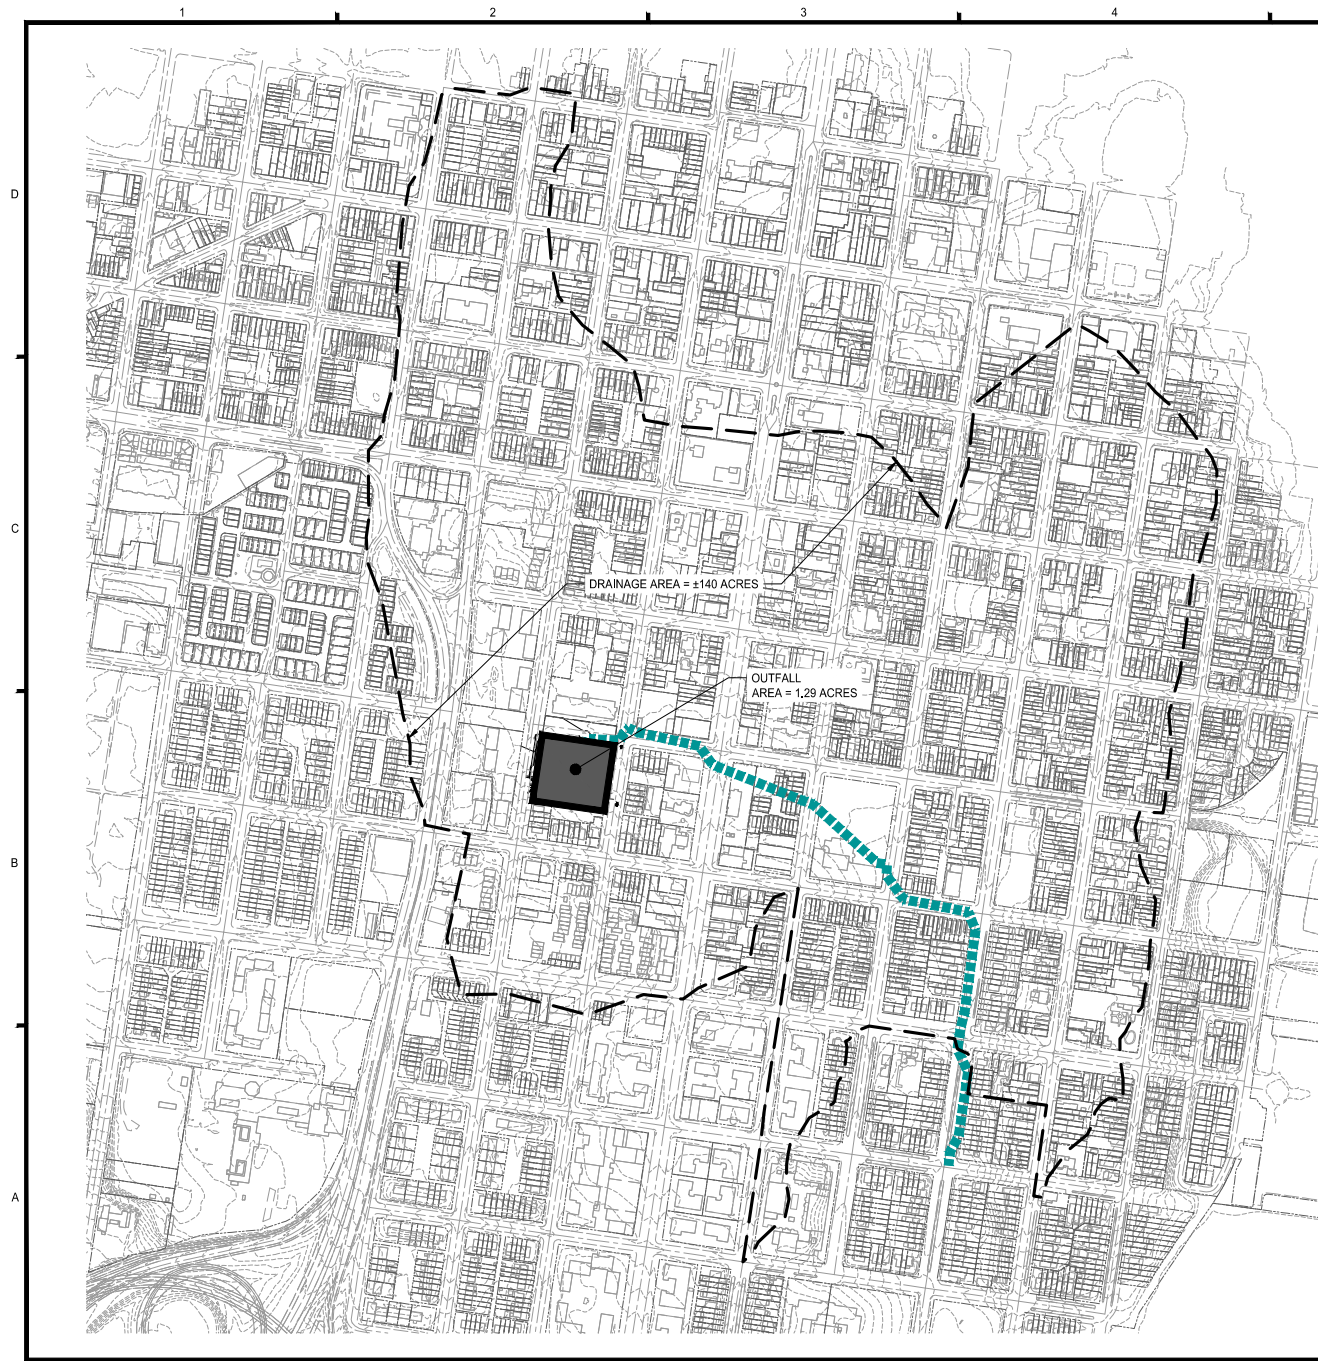

CONCEPTUAL STORM WATER MANAGEMENT NARRATIVE

TO MEET THE CITY STORMWATER MANAGEMENT REQUIREMENTS FOR CHANNEL PROTECTION AND FLOOD PROTECTION, THE CHANNEL PROTECTION IS MET BY BEING PIPED THE ENTIRE DURATION OF THE EXTENT OF THE REVIEW (13-1054-F-144). BY USING THIS EQUATION IT WAS DETERMINED NO DETENTION IS REQUIRED FOR THE 1-YEAR 24-HOUR STORM. THE FLOOD PROTECTION IS MET BY THE POST-DEVELOPMENT 10-YEAR 24-HOUR STORM EVENT BEING LOWER THAN THE PRE-DEVELOPMENT. THE 10-YEAR 24-HOUR STORM EVENT IS REDUCED FOR ALL THREE OUTFALLS. THEREFORE NO DETENTION IS REQUIRED.

STORMWATER QUANTITY (CHANNEL PROTECTION / FLOOD PROTECTION)

THE SITE WAS ANALYZED FOR BOTH CHANNEL PROTECTION AND FLOOD PROTECTION.

CHANNEL PROTECTION - EQUATION 13-109-F-144 IN THE CITY CODE WAS USED TO DETERMINE THAT THE POST-DEVELOPMENT 2-YEAR 24-HOUR STORM DOES NOT CAUSE ANY EROSION TO THE SYSTEM SINCE IT IS PIPE FOR THE DURATION OF THE EXTENT OF REVIEW.

FLOOD PROTECTION - THE POST-DEVELOPMENT PEAK FLOW RATE FOR THE 10-YEAR 24-HOUR STORM EVENT IS REQUIRED TO BE LESS THAN THE PRE-DEVELOPMENT PEAK FLOW RATE OF THE SAME STORM EVENT. THE PRE-DEVELOPMENT FLOW RATE AT THIS OUTFALL WAS 16.81 CFS AND THE POST DEVELOPMENT FLOW RATE IS 14.87 CFS. SINCE THE POST-DEVELOPMENT RATE IS LESS THAN THE PRE-DEVELOPMENT, NO DETENTION IS REQUIRED.

NOTE: THIS NARRATIVE AND COMPUTATIONS ARE CONCEPTUAL AND ARE SUBJECT TO CHANGE, AS THE PLAN PROGRESSES FURTHER INTO THE CITY'S DEVELOPMENT REVIEW PROCESS, ADDITIONAL COMPUTATIONS AND NARRATIVES WILL BE PROVIDED PER CITY STANDARDS.

PRE AND POST CN

PRE:

FOR 1-YR, 2-YR, AND 10-YR:
TOTAL = 1.29 AC, (MT = 0.46, IMP = 0.83), AVE. CN = 92

POST:

FOR 1-YR, 2-YR, AND 10-YR:
DA=8 FOR BIORETENTION = 0.35 AC (MT = 0.32, IMP = 0.31) (CN = 94)
DA=8 FOR BIORETENTION = 0.60 AC, (MT = 0.32, IMP = 0.57) (CN = 94)
UNCONTROLLED = 0.35 AC, (MT = 0.36, IMP = 0.30) (CN = 94)
TOTAL = 1.29 AC, AVE. CN = 94

PRE-DEVELOPMENT

A = 1.29 ACRES
CN = 92

$T_c = 5$ MINUTES
 $I_2 = 6.2$ INCHES/HOUR
 $I_{10} = 9.0$ INCHES/HOUR
 $Q_2 = 11.32$ CFS
 $Q_{10} = 16.81$ CFS

POST-DEVELOPMENT

A = 1.29 ACRES
CN = 94

$T_c = 5$ MINUTES
 $I_2 = 6.2$ INCHES/HOUR
 $I_{10} = 9.0$ INCHES/HOUR
 $Q_2 = 10.51$ CFS
 $Q_{10} = 15.55$ CFS

NET DECREASE IN RUNOFF

$Q_2 = 11.32$ CFS - 10.11 CFS = 1.21 CFS (DECREASE)
 $Q_{10} = 16.81$ CFS - 14.87 CFS = 2.14 CFS (DECREASE)

Hydrograph Return Period Recap

Hyd. No.	Hydrograph type (origin)	Inflow (cfs)	Peak Outflow (cfs)								Hydrograph Description
			1-yr	2-yr	3-yr	5-yr	10-yr	25-yr	50-yr	100-yr	
1	SCB Runoff	---	2,689	---	---	3,977	---	---	---	---	BIO A AREA
2	SCB Runoff	---	4,889	---	---	7,231	---	---	---	---	BIO B AREA
3	SCB Runoff	---	2,933	---	---	4,338	---	---	---	---	C AREA
4	Reservoir	1	2,621	---	---	3,935	---	---	---	---	BIO A
5	Reservoir	2	4,675	---	---	6,994	---	---	---	---	BIO B
6	SCB Runoff	---	11.32	---	---	16.81	---	---	---	---	PRE
7	Combine	3, 4, 5,	10.11	---	---	14.87	---	---	---	---	POST

LEGEND

- DRAINAGE DIVIDE
- OUTFALL PIPE
- SITE

0 100 200 300 400
GRAPHIC SCALE
1" = 200'

APPROVED

SPECIAL USE PERMIT NO. XXXXX-XXXXX

DEPARTMENT OF TRANSPORTATION & ENVIRONMENTAL SERVICES

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DIRECTOR DATE

DIRECTOR DATE

CIVILIAN PLANNING COMMISSION DATE

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CITY OF ALEXANDRIA, VIRGINIA


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10/03/2025	COMPLETENESS SUBMISSION
10/03/2025	VERIFICATION SUBMISSION

PROJECT NO.: 28001431.00
DRAWING NO.: 113952
DATE: 10/03/2025
SCALE: 1" = 200'
DESIGN: EG
DRAWN: JS
CHECKED: EG

SHEET TITLE:
PRELIMINARY SWM
AND OUTFALL
ANALYSIS

SHEET NO.

C720

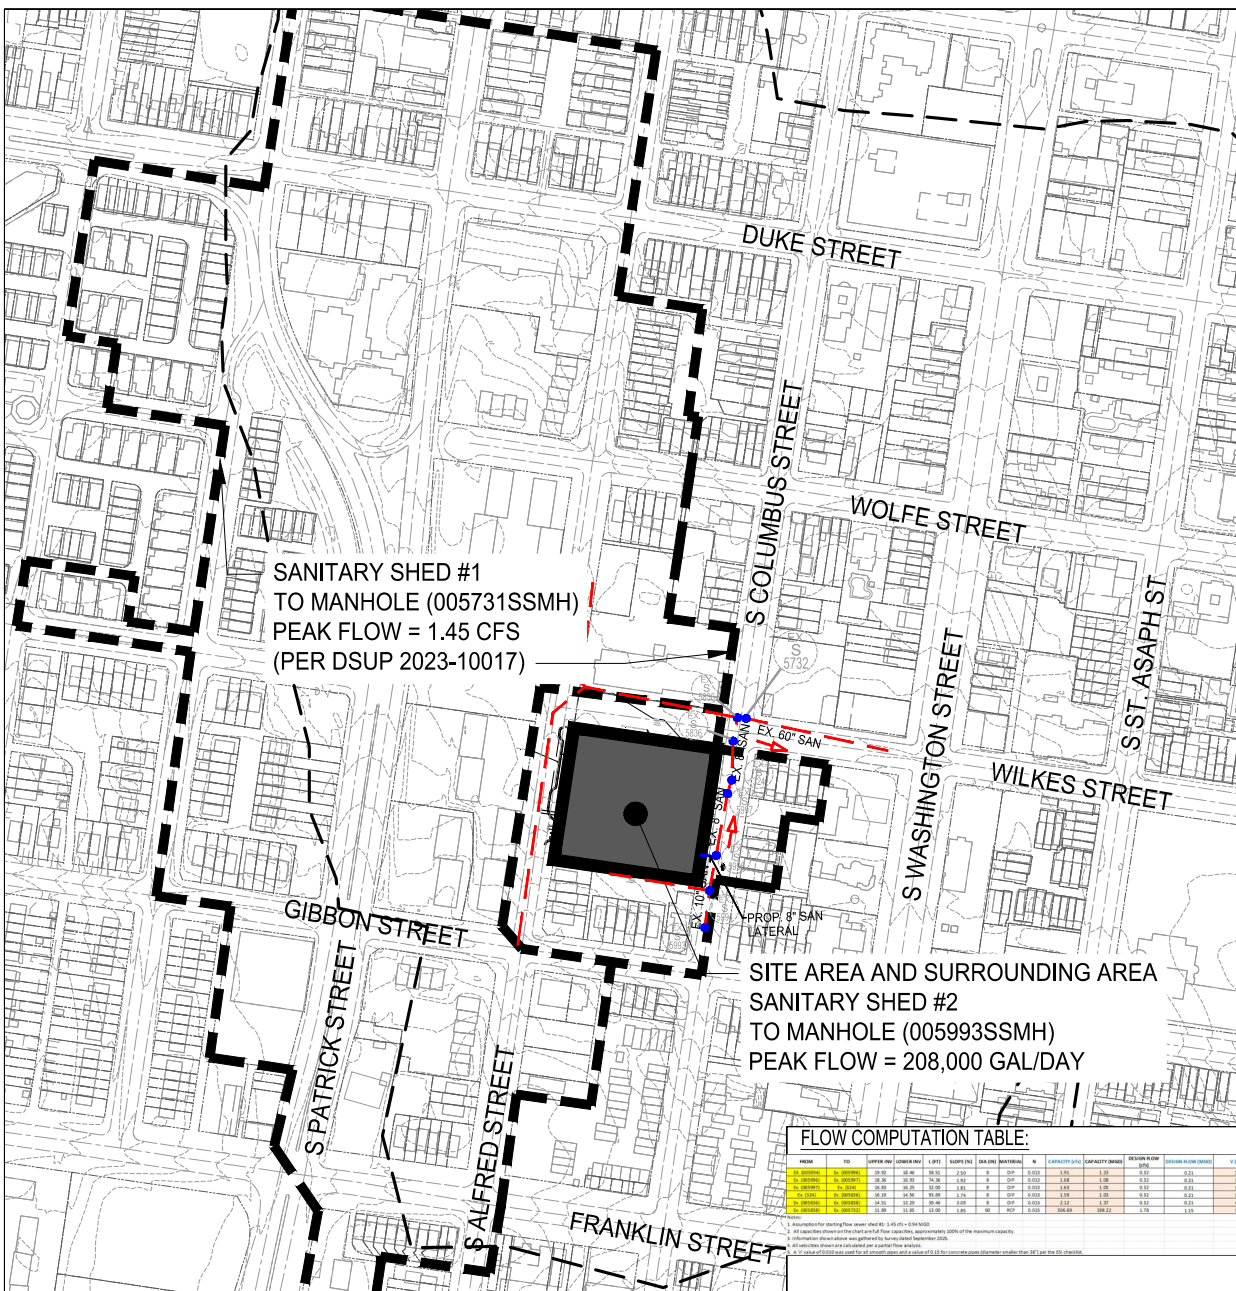

SANITARY SEWER OUTFALL CALCULATIONS:
THE EXISTING USE IS A RESIDENTIAL APARTMENT (MULTIFAMILY WITH A TOTAL OF 35 UNITS). THIS PROJECT PROPOSES THE CONSTRUCTION OF 145 CONDOS (AFFORDABLE HOUSING UNITS). THE AVERAGE DAY AND PEAK HOUR WASTEWATER DISCHARGE FLOW CALCULATION WERE COMPLETED USING THE METHOD PROVIDED BY THE CITY OF ALEXANDRIA IN MEMORANDUM OF INDUSTRY NO. 06-14. THE AVERAGE DAILY FLOW IS DESCRIBED BELOW.

EXISTING - APARTMENT/MULTIFAMILY - 300 GPD X 35 UNITS = 10,500 GPD OR 0.02 CFS
PROPOSED - MULTIFAMILY (CONDOMINIUM APARTMENT) - 500 GPD X 145 UNITS = 43,500 GPD OR 0.07 CFS
TO ACCOUNT FOR THE DAILY PEAK PERIOD, THE ABOVE FLOW IS MULTIPLIED BY A FACTOR OF 4:

EXISTING: 10,500 GPD X 4 = 42,000 GPD
PROPOSED: 43,500 GPD X 4 = 174,000 GPD
TOTAL PEAK FLOW = 174,000 GPD OR 0.27 CFS

SANITARY SEWER OUTFALL NOTE:
THIS PROJECT IS ANTICIPATED TO GENERATE AN INCREASE IN EXCESS OF 10,000 GPD IN SANITARY WASTE OUTFLOW. A FLOW OF APPROXIMATELY 43,500 GPD IS EXPECTED FOR THIS DEVELOPMENT RESULTING IN A PEAK FLOW OF 174,000 GPD. THEREFORE, THE PROJECT IS SUBJECT TO A SANITARY SEWER OUTFALL ANALYSIS SHOWING ADEQUACY OF SANITARY SEWER OUTFALL IN ACCORDANCE WITH MEMO TO INDUSTRY 06-14. THE GENERAL AREA IS NOT KNOWN TO HAVE SANITARY SEWER CAPACITY PROBLEMS.

THIS PROJECT PROPOSES A 10" PIP SANITARY LATERAL FOR ALL UNITS. THE PROPOSED LATERAL WILL CONNECT INTO AN EXISTING 10" SANITARY SEWER MAIN WITHIN COLUMBUS STREET (RIGHT-OF-WAY) THROUGH A PROPOSED CITY STANDARD MANHOLE. THE SANITARY FLOW IS THEN CONVEYED NORTH UNTIL IT ENTERS AN EXISTING 8" SANITARY SEWER AT STRUCTURE 005593SSMH. PER MEMORANDUM TO INDUSTRY NO. 06-14, THE UNITS OF ANALYSIS FOR THE SANITARY SEWER ADEQUATE OUTFALL IS AT A POINT WHERE THE DOWNSIDE SEWER HAS A MINIMUM DIAMETER GREATER THAN 24". THEREFORE, THE SANITARY SEWER ANALYSIS CONCLUDES AT STRUCTURE 005832SSMH.

COMBINED SEWER NOTE:
THE SITE DISCHARGES TO THE COMBINED SEWER SYSTEM. PER MEMO TO INDUSTRY 23-02, THE APPLICANT WILL PROVIDE A CONTRIBUTION FOR STORMWATER AND SANITARY RUNOFF GENERATED ONSITE IN LIEU OF SEPARATION AS THERE IS NO OPPORTUNITY FOR SEPARATION WITHIN THE VICINITY OF THE SITE.

a. THE SANITARY FLOW FROM THE SITE WILL BE DISCHARGED TO THE COMBINED SEWER SYSTEM. THE PROJECT IS TO MEET CDM MANAGEMENT POLICY REQUIREMENTS BY MAKING A SANITARY CONTRIBUTION.
b. THE NON-WASTEWATER REQUIREMENT FROM THE SITE WILL BE DISCARDED TO THE COMBINED SEWER SYSTEM. THE PROJECT IS TO MEET CDM MANAGEMENT POLICY REQUIREMENTS BY REDUCING THE 10-YEAR 24-HOUR DESIGN STORM BY 10 PERCENT.

SANITARY CONSTRUCTION NOTES:

a. CONTRACTOR SHALL ENSURE ALL DISCHARGES ARE IN ACCORDANCE WITH CITY OF ALEXANDRIA CODE TITLE 5, CHAPTER 6, ARTICLE 5.
b. DOWNSTREAMING AND OTHER CONSTRUCTION RELATED DISCHARGE LIMITS TO THE SEWER SYSTEM ARE REGULATED BY ALEXANDRIA PRETREATMENT. CONTRACTOR IS REQUIRED TO CONTACT ALEXANDRIA'S PRETREATMENT COORDINATOR AT 703-721-3500 X2020.

"SANITARY SEWER DATA NOTE"
INVESTIGATE MATERIAL AND SITE INFORMATION OBTAINED FROM AS-BUILT DATA FROM THE ALEXANDRIA GSE SEWER VIEWER AND IN ACCORDANCE WITH THE SURVEY INFORMATION PROVIDED BY OTHERS FOR THE HERITAGE AT OLD DOWN DEVELOPMENT PLAN (DSUP2023-10032) AND IS RELEI UPON AS ACCURATE BY THE ENGINEER.

LEGEND:
● = MANHOLE

EXISTING/PROPOSED	USE	CROSS BUILDING AREA	NOF UNITS	UNIT FLOW (GPD)	SCHOOL FLOW (GPD)	TOTAL FLOW (MGD)	TOTAL FLOW (MGD) (4 INCH)
EXISTING	SINGLE FAMILY TOWNHOMES	35	300	0.008	0.000	0.008	0.008
PROPOSED	MULTIFAMILY APARTMENTS	145	500	0.042	0.000	0.042	0.042
PROPOSED	SCHOOL			0.000	0.000	0.000	0.000
PROPOSED	OPENSIDE			0.000	0.000	0.000	0.000
TOTAL				0.050	0.000	0.050	0.050

FLOW COMPUTATION TABLE:

NO.	USE	CROSS BUILDING AREA	NOF UNITS	UNIT FLOW (GPD)	SCHOOL FLOW (GPD)	TOTAL FLOW (MGD)	TOTAL FLOW (MGD) (4 INCH)
1	SINGLE FAMILY TOWNHOMES	35	300	0.008	0.000	0.008	0.008
2	MULTIFAMILY APARTMENTS	145	500	0.042	0.000	0.042	0.042
3	SCHOOL			0.000	0.000	0.000	0.000
4	OPENSIDE			0.000	0.000	0.000	0.000
5	TOTAL			0.050	0.000	0.050	0.050

APPROVED
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DEPARTMENT OF TRANSPORTATION & ENVIRONMENTAL SERVICES
SITE PLAN NO. 10000-XXXXXX
DEPARTMENT OF PLANNING & ZONING

DIRECTOR _____ DATE _____
DIRECTOR _____ DATE _____

SUBMITTAL PLANNING COMMISSION _____ DATE _____
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OLDE TOWNE WEST AFFORDABLE HOUSING DEVELOPMENT
PRELIMINARY DEVELOPMENT SPECIAL USE PERMIT

CITY OF ALEXANDRIA, VIRGINIA

DATE	DESCRIPTION
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10/13/2025	COMPLETION SUBMISSION
10/13/2025	VERIFICATION SUBMISSION


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DRAWING NO.: 113952
DATE: 10/03/2025
SCALE: 1" = 100'
DESIGN: EG
DRAWN: JS
CHECKED: EG

SHEET TITLE:
PRELIMINARY SANITARY OUTFALL ANALYSIS

SHEET NO.:
C721

SU-30 INBOUND

SU-30 OUTBOUND

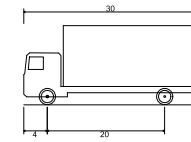

SU-30 - Single Unit Truck
 Overall Length 30.000ft
 Overall Width 8.000ft
 Overall Body Height 13.500ft
 Min Body Ground Clearance 1.36ft
 Track Width 8.000ft
 Lock-to-lock time 5.00s
 Max Steering Angle (Virtual) 31.80°

SOUTH ALFRED STREET
 VARIABLE WIDTH PUBLIC
 RIGHT-OF-WAY


SOUTH ALFRED STREET
 VARIABLE WIDTH PUBLIC
 RIGHT-OF-WAY

#526 S ALFRED STREET
 PID #080.01-05-02
BURSTEIN KIMBERL
 YORK
 ZONED: RB

#526 S ALFRED STREET
 PID #080.01-05-02
BURSTEIN KIMBERL
 YORK
 ZONED: RB

EX. BUILDING

EX. BUILDING

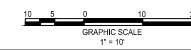

APPROVED	
SPECIAL USE PERMIT NO. XXXXX-XXXXX	
DEPARTMENT OF PLANNING & ZONING	
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DEPARTMENT OF TRANSPORTATION & ENVIRONMENTAL SERVICES	
SITE PLAN NO. _____	
DIRECTOR _____	DATE _____
JURISDICTION PLANNING COMMISSION _____	
DATE RECORDED _____	DATE _____
INSTRUMENT NO. _____	DEED BOOK NO. _____ PAGE NO. _____



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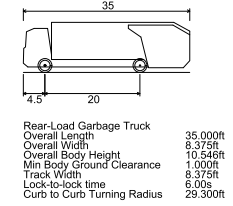
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10/03/2025	COMPLETENESS SUBMISSION
10/03/2025	VERIFICATION SUBMISSION

PROJECT No.: 2801431.00
 DRAWING No.: 113952
 DATE: 10/03/2025
 SCALE: 1" = 10'
 DESIGN: EG
 DRAWN: JS
 CHECKED: EG
 SHEET TITLE:
TURNING MOVEMENTS

SHEET No.
C900

GARBAGE TRUCK INBOUND

GARBAGE TRUCK OUTBOUND



SOUTH ALFRED STREET
 VARIABLE WIDTH PUBLIC
 RIGHT-OF-WAY


SOUTH ALFRED STREET
 VARIABLE WIDTH PUBLIC
 RIGHT-OF-WAY

#526 S ALFRED STREET
 PID #080.01-05-02
BURSTEIN KIMBERL
 YORK
 ZONED: RB

#526 S ALFRED STREET
 PID #080.01-05-02
BURSTEIN KIMBERL
 YORK
 ZONED: RB

EX. BUILDING

EX. BUILDING

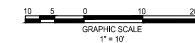

APPROVED SPECIAL USE PERMIT NO. 10000-100000 DEPARTMENT OF PLANNING & ZONING	
DIRECTOR _____	DATE _____
DEPARTMENT OF TRANSPORTATION & ENVIRONMENTAL SERVICES	
SITE PLAN NO. _____	
DIRECTOR _____	DATE _____
JURISDICTION PLANNING COMMISSION _____	
DATE RECORDED _____	DATE _____
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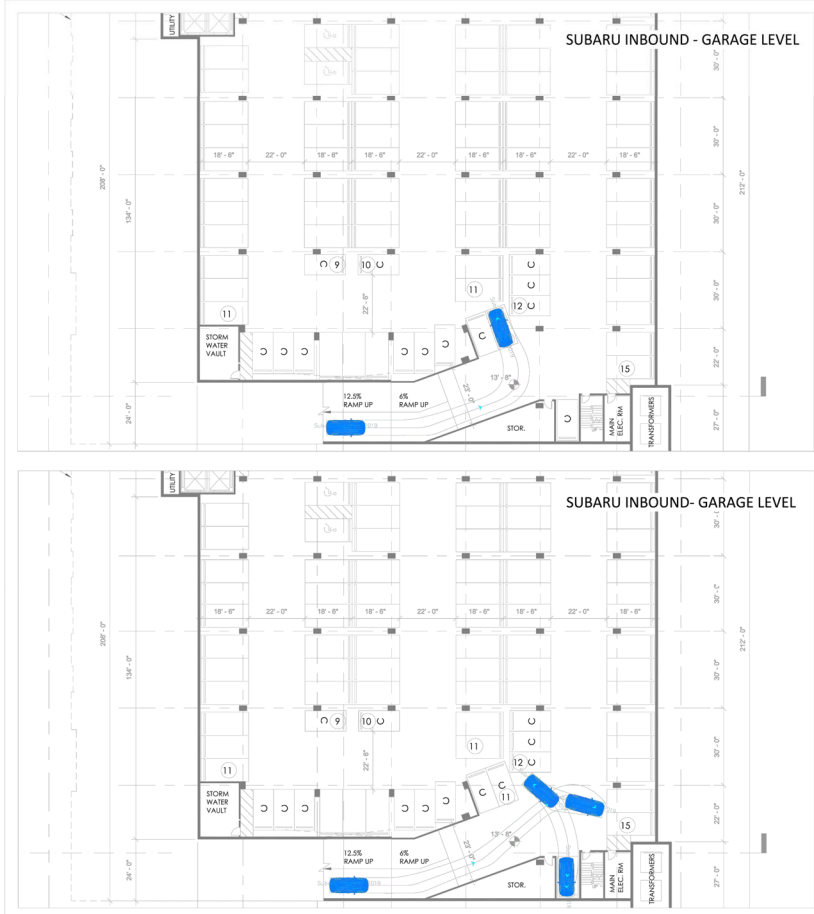
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 PRELIMINARY DEVELOPMENT SPECIAL USE PERMIT
 CITY OF ALEXANDRIA, VIRGINIA

MARK	DATE	DESCRIPTION
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08/16/25		COMPLETENESS SUBMISSION
10/02/25		VERIFICATION SUBMISSION

PROJECT NO.: 20011431-00
 DRAWING NO.: 113952
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 CHECKED: EG

SHEET TITLE:
TURNING MOVEMENTS

SHEET NO.:
C901



GOROVE SLADE
Transportation Planners and Engineers

598 S Alfred Street: Vehicle Garage Maneuvers
The Community Builders
September 11, 2025
Sheet 1 of 7

City of Alexandria, VA



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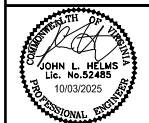
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DEPARTMENT OF PLANNING & ZONING	
DIRECTOR _____	DATE _____
DEPARTMENT OF TRANSPORTATION & ENVIRONMENTAL SERVICES	
SITE PLAN NO. _____	
DIRECTOR _____	DATE _____
CIVILIAN PLANNING COMMISSION _____	
DATE RECORDED _____	
INSTRUMENT NO. _____	DEED BOOK NO. _____
PAGE NO. _____	


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09/10/05		COMPLETENESS SUBMISSION
10/03/05		VERIFICATION SUBMISSION

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SHEET TITLE:
TURNING MOVEMENTS

SHEET No.
C902

OLDE TOWNE WEST AFFORDABLE HOUSING DEVELOPMENT
PRELIMINARY DEVELOPMENT SPECIAL USE PERMIT
CITY OF ALEXANDRIA, VIRGINIA



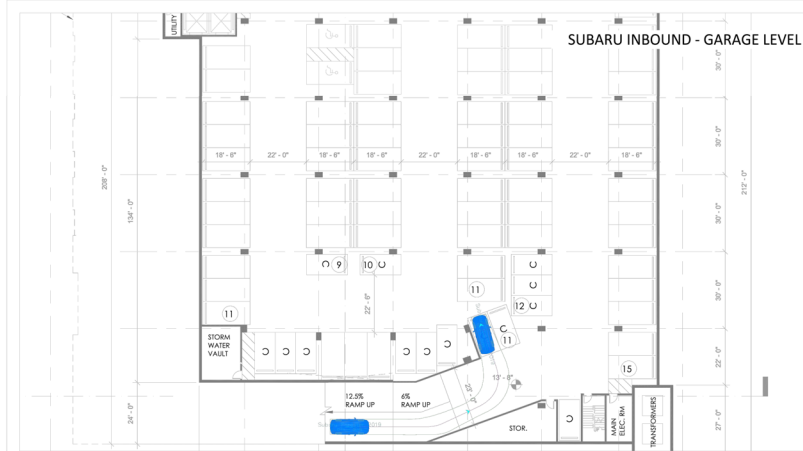



CITY OF ALEXANDRIA, VIRGINIA

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PROJECT No.: 24001431.00
DRAWING No.: 113952
DATE: 10/03/2025
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DESIGN: EG
DRAWN: JS
CHECKED: EG

TURNING MOVEMENTS

SHEET No. C904



598 S Alfred Street: Vehicle Garage Maneuvers

The Community Builders
September 11, 2025
Sheet 3 of 7


City of Alexandria, VA



SCALE: 1" = 40'

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DEPARTMENT OF PLANNING & ZONING		
DIRECTOR _____		DATE _____
DEPARTMENT OF TRANSPORTATION & ENVIRONMENTAL SERVICE		
SITE PLAN NO. _____		
DIRECTOR _____		DATE _____
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GOROVE SLADE
Transportation Planners and Engineers

598 S Alfred Street: Vehicle Garage Maneuvers
The Community Builders
September 11, 2025
Sheet 4 of 7
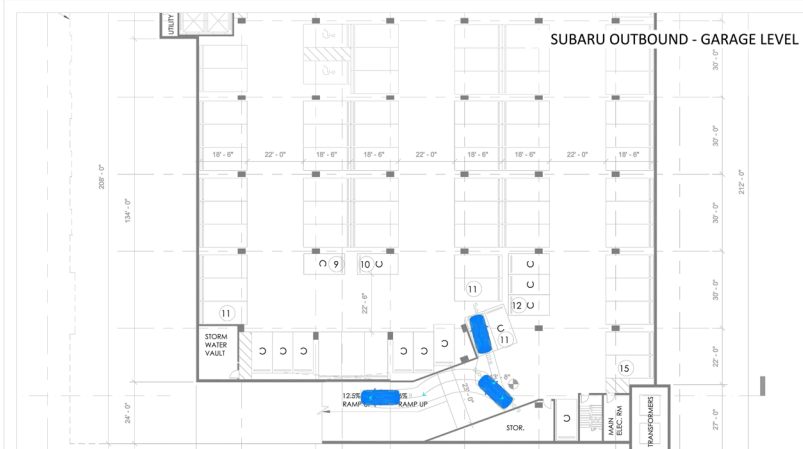
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City of Alexandria, VA



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DEPARTMENT OF PLANNING & ZONING

DIRECTOR _____ DATE _____
DEPARTMENT OF TRANSPORTATION & ENVIRONMENTAL SERVICES
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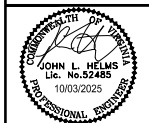
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10/03/05		VERIFICATION RESUBMISSION




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SHEET TITLE:
TURNING MOVEMENTS

SHEET No.
C905

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598 S Alfred Street: P-Vehicle Garage Maneuvers
The Community Builders
September 11, 2025
Sheet 5 of 7

City of Alexandria, VA

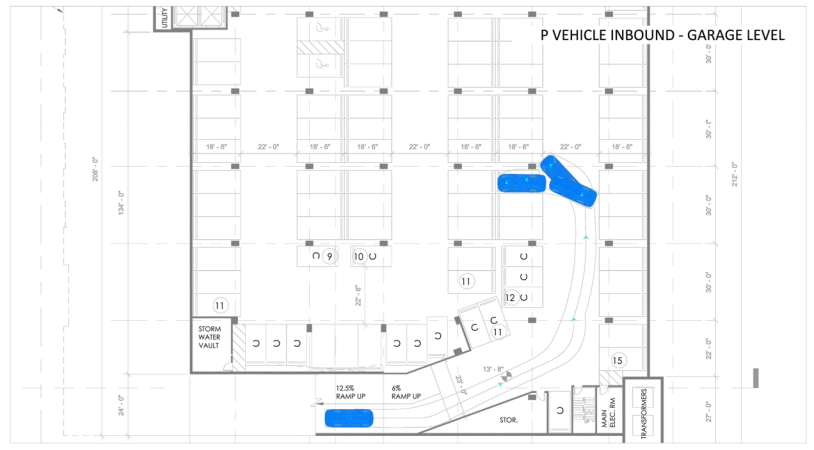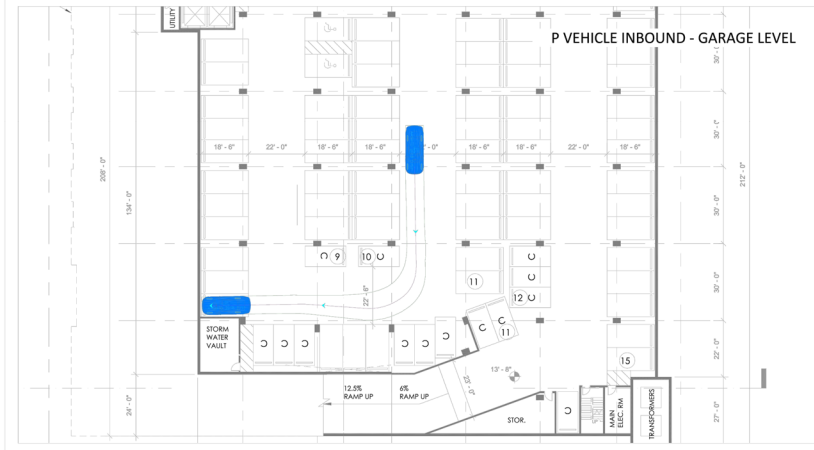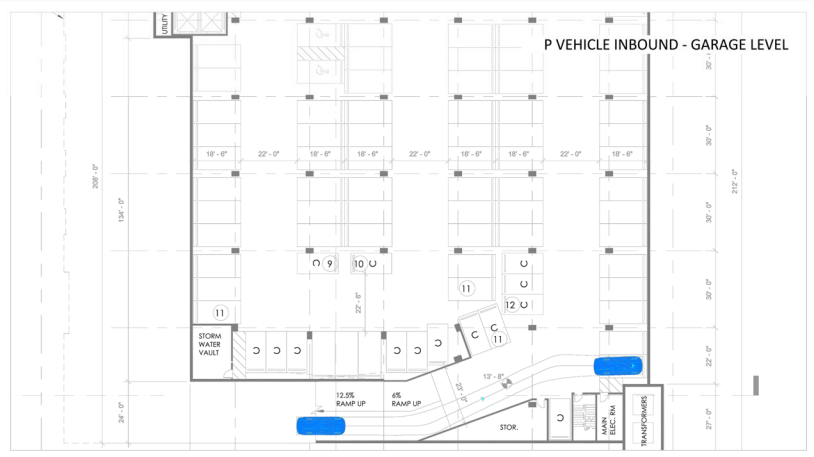

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DIRECTOR _____ DATE _____
DEPARTMENT OF TRANSPORTATION & ENVIRONMENTAL SERVICES
SITE PLAN NO. _____
DIRECTOR _____ DATE _____

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DATE RECORDED _____
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09/10/25		COMPLETENESS SUBMISSION
10/03/25		VERIFICATION SUBMISSION

PROJECT NO.: 24001431-00
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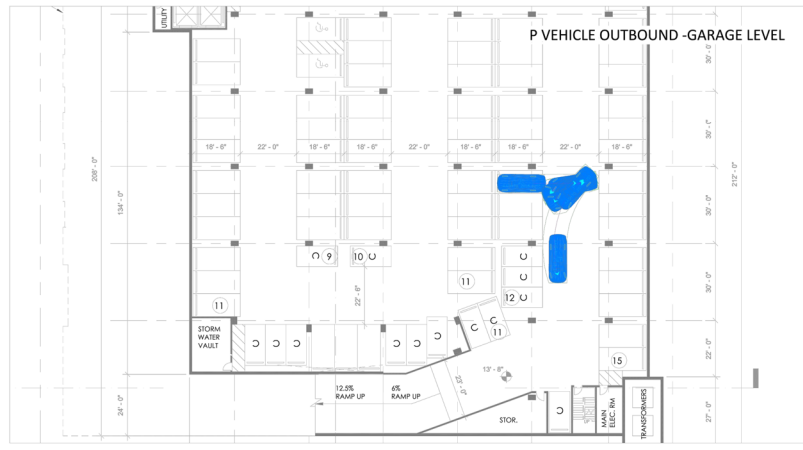
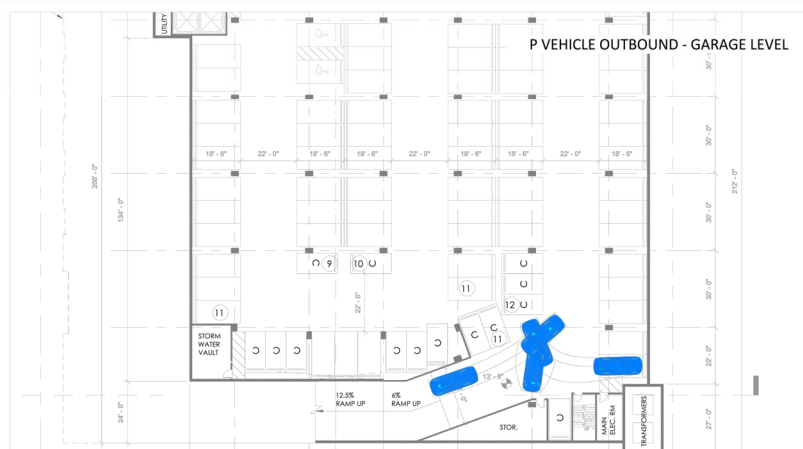
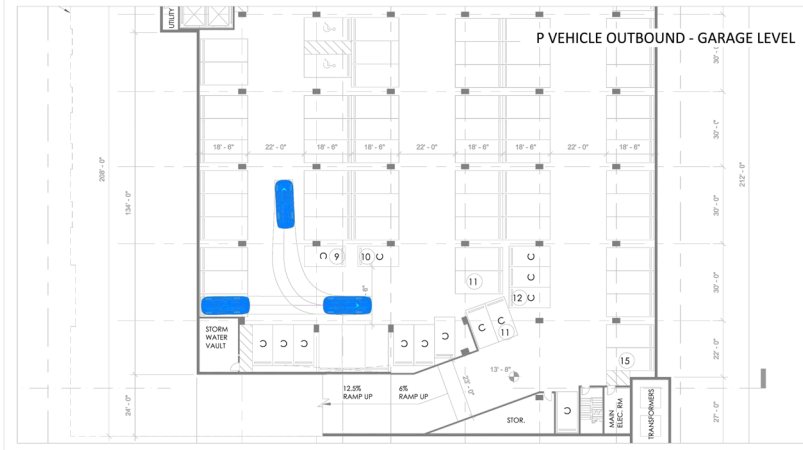
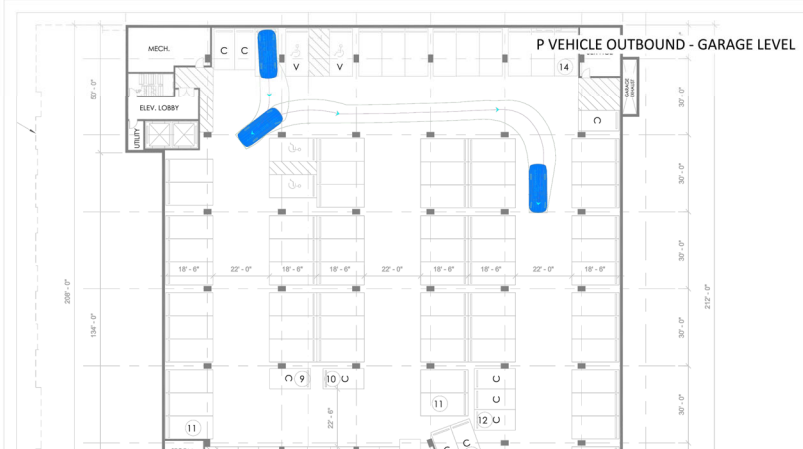
SHEET NO. **C906**

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JOHN L. HELMS
Lic. No. 52485
10/03/2025
PROFESSIONAL ENGINEER

CITY OF ALEXANDRIA, VIRGINIA



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Transportation Planners and Engineers

598 S Alfred Street: P-Vehicle Garage Maneuvers
The Community Builders
September 11, 2025
Sheet 6 of 7

City of Alexandria, VA



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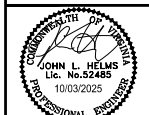
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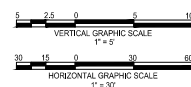
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09/02/25		COMPLETENESS SUBMISSION
10/03/25		VERIFICATION SUBMISSION

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TURNING MOVEMENTS


SHEET No.
C907

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CITY OF ALEXANDRIA, VIRGINIA

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PROJECT No.: 24001431.00
DRAWING No.: 113952
DATE: 10/03/2025
SCALE: NONE
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SHEET TITLE:

PRELIMINARY SIGHT
DISTANCE

SHEET No.

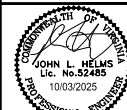C910

NOTE:
PER APPROVED LANDSCAPE GUIDELINES CHAPTER
CANOPY COVERAGE STANDARDS 8. STREET TREES
OR OTHER PLANTINGS IN PUBLIC R.O.W. DO NOT
APPLY TOWARD CROWN COVERAGE ALLOWANCES.

BIODIVERSITY TABLES							
TREES (URBAN AND STANDARD)							
TOTAL NUMBER OF TREES PROPOSED: 12							
GENUS	QTY.	PERCENT OF TOTAL PROPOSED	MAXIMUM PERCENT ALLOWED	SPECIES	QTY.	PERCENT OF TOTAL PROPOSED	MAXIMUM PERCENT ALLOWED
Ametlanchier	1	8.3%	33%	laevis 'Spring Flurry'	1	8.3%	10%
Nyssa	2	16.7%	33%	virginica	2	16.7%	10%
Liquidambar	1	8.3%	33%	styraciflua	1	8.3%	10%
Prunus	2	16.7%	33%	serotina	2	16.7%	10%
Quercus	4	33.3%	33%	coccinea	2	16.7%	10%
				palustris	2	16.7%	10%
Tilia	2	16.7%	33%	americana 'Redmond'	2	16.7%	10%

SHRUBS							
TOTAL NUMBER OF SHRUBS PROPOSED: 244							
GENUS	QTY.	PERCENT OF TOTAL PROPOSED	MAXIMUM PERCENT ALLOWED	SPECIES	QTY*	PERCENT OF TOTAL PROPOSED	MAXIMUM PERCENT ALLOWED
Abelia	12	4.9%	33%	x grandiflora 'Radiance'	12	4.9%	10%
Aronia	12	4.9%	33%	melanocarpa	12	4.9%	10%
Chamaecyparis	4	1.6%	33%	obtusa 'Concordia'	4	1.6%	10%
Cornus	18	7.4%	33%	sericea 'Kelley'	18	7.4%	10%
Eonymus	20	8.2%	33%	americanus	20	8.2%	10%
Hydrangea	11	4.5%	33%	quercifolia 'Rady Slippers'	11	4.5%	10%
Ilex	27	11.1%	33%	glabra 'Gem Box'	18	7.4%	10%
				vomitoria 'Schillings'	11	4.5%	10%
Illicium	13	5.3%	33%	floridanum	13	5.3%	10%
Itea	23	9.4%	33%	virginica 'Little Henry'	23	9.4%	10%
Juniperus	21	8.6%	33%	communis	21	8.6%	10%
Leucothoe	17	7.0%	33%	aaxillaris	17	7.0%	10%
Rhododendron	12	4.9%	33%	atlanticum	12	4.9%	10%
Rhus	20	8.2%	33%	aromatica 'Gro-Low'	20	8.2%	10%
Rosa	19	7.8%	33%	palustris	19	7.8%	10%
Taxus	15	6.1%	33%	canadensis	15	6.1%	10%

GENERAL NOTES:

1. ALL MATERIALS SPECIFICATIONS SHALL BE IN ACCORDANCE WITH THE INDUSTRY STANDARD FOR GRADING PLANT MATERIAL - THE AMERICAN STANDARD FOR NURSERY STOCK (ANSI Z60.1)
2. MAINTENANCE OF ALL TREES AND LANDSCAPE MATERIALS SHALL CONFORM TO ACCEPTED INDUSTRY STANDARDS SET FORTH BY THE LANDSCAPE CONTRACTORS ASSOCIATION, AMERICAN SOCIETY OF LANDSCAPE ARCHITECTS, THE INTERNATIONAL SOCIETY OF ARBORICULTURE AND THE AMERICAN NATIONAL STANDARDS INSTITUTE.
3. PLANT SIZES ARE MINIMUMS AS REQUIRED BY THE CITY OF ALEXANDRIA LANDSCAPE GUIDELINES.
4. TOTAL DISTURBED AREA IS 62,258 SF OR 1.43 AC.

<h1>APPROVED</h1> <p>SPECIAL USE PERMIT NO. XXXXX-XXXXX</p> <p>DEPARTMENT OF PLANNING & ZONING</p>		
DIRECTOR _____		DATE _____
DEPARTMENT OF TRANSPORTATION & ENVIRONMENTAL SERVICES		
SITE PLAN NO. _____		
DIRECTOR _____		DATE _____
CHAIRMAN, PLANNING COMMISSION _____ DATE _____		
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**OLD TOWNE WEST AFFORDABLE
HOUSING DEVELOPMENT
PRELIMINARY DEVELOPMENT SPECIAL USE PERMIT**

MARK	DATE	DESCRIPTION
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	07/11/25	PRELIMINARY OSUP SUBMISSION
	08/16/25	COMPLETENESS SUBMISSION


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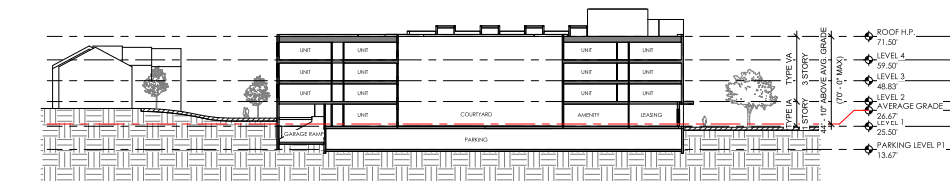
LANDSCAPE
SCHEDULE AND
CALCULATIONS

SHEET No.

L200



1 BUILDING CODE DIAGRAM
SCALE: 1" = 30'-0"

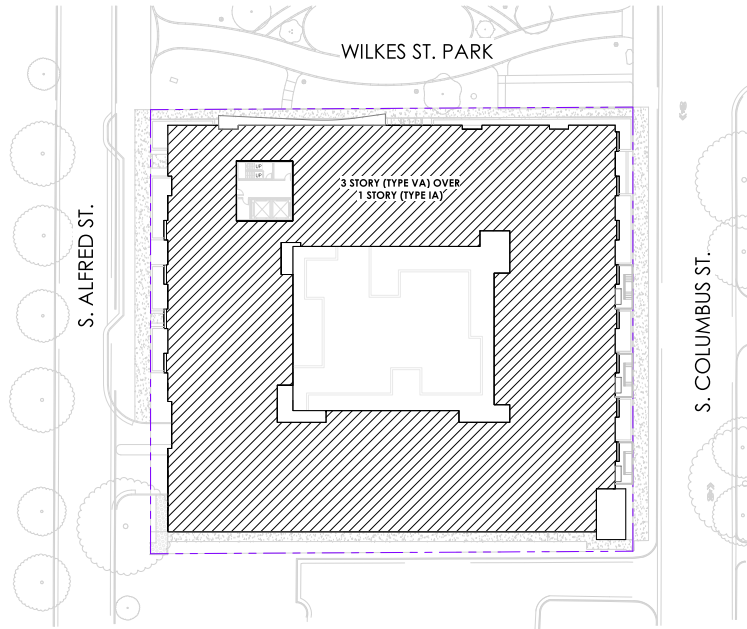

2 BUILDING CODE SECTION
SCALE: 1" = 30'-0"

APPLICABLE CODES (City of Alexandria)
2021 VIRGINIA UNIFORM STATEWIDE BUILDING CODE (2021 International Code Council Family of Codes w/incorporated USBC amendments)

Floor	Area (SF)	Use Group	Type(s) of Construction	Allowable No. of Stories	Allowable Height (FT)	Allowable Area Per Floor (SF)*	Fire Protection
LEVEL 4	37,813	R2	VA	4	70	36,000 / 50,720	NFPA 13
LEVEL 3	38,111	R2	VA	4	70	36,000 / 50,720	NFPA 13
LEVEL 2	36,982	R2	VA	4	70	36,000 / 50,720	NFPA 13
LEVEL 1	37,942	R2/S2/A3	IA		UL	UL	NFPA 13
GARAGE LEVEL	36,617	S2	IA		UL	UL	NFPA 13

***506.2.1 Single-occupancy buildings.**
The total allowable area of a single-occupancy building more than three stories above grade plane shall be determined in accordance with Equation 5-2:
$$A_s = [A_f + (NS \times J)] \times S_s$$

where:
A_s = Allowable area (square feet).
A_f = Tabular allowable area factor (NS, S13R, S13D or SM value, as applicable) in accordance with Table 506.2.
NS = Tabular allowable area factor in accordance with Table 506.2 for a nonsprinklered building (regardless of whether the building is sprinklered).
J = Area factor increase due to frontage (percent) as calculated in accordance with Section 506.3.
S_s = 3 where the actual number of stories above grade plane exceeds three, or
S_s = 4 where the building is equipped throughout with an automatic sprinkler system installed in accordance with Section 903.3.1.2.
The actual area of any individual floor shall not exceed the allowable area per Equation 5-1.

506.3 Frontage Increase.
Every building shall adjoin or have access to a public way to receive an area factor increase based on frontage. Area factor increase shall be determined in accordance with Sections 506.3.1 through 506.3.3.

506.3.1 Minimum percentage of perimeter.
To qualify for an area factor increase based on frontage, a building shall have not less than 25 percent of its perimeter on a public way or open space. Such open space shall be either on the same lot or dedicated for public use and shall be accessed from a street or approved fire lane.

506.3.3 Amount of increase.
The area factor increase based on frontage shall be determined in accordance with Table 506.3.3.


TABLE 506.3.3 FRONTAGE INCREASE FACTOR*

PERCENTAGE OF BUILDING PERIMETER	OPEN SPACE (feet)			
	0 to less than 20	20 to less than 25	25 to less than 30	30 or greater
0 to less than 25	0	0	0	0
25 to less than 50	0	0.17	0.21	0.25
50 to less than 75	0	0.33	0.42	0.50
75 to 100	0	0.50	0.62	0.75


Allowable Maximum Area For Building: $A_a = (36,000 + 12,000 \times 0.17) \times 4 = 152,160 \text{ SF}$
Allowable Maximum Area Per Floor: $A_a / 4 = 38,040 \text{ SF}$

*Horizontal Building Separations located above the below grade garage (Type IA construction) and a portion of level 1 (Type IA construction) below the upper three stories of the Type VA construction.

BUILDING USE AND OCCUPANCY
Separated Mixed Uses
R2 Residential
A3 Assembly
S2 Storage (Loading)
Non-Separated Mixed Uses
S2 Storage (Parking Garage Uses)

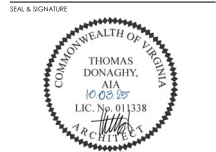

ALFRED STREET BAPTIST CHURCH HOUSING
598 SOUTH ALFRED STREET
ALEXANDRIA, VA 22314
THE COMMUNITY BUILDERS, INC.
ALFRED STREET BAPTIST CHURCH

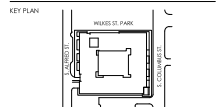

REVISIONS

NO.	DATE	DESCRIPTION

PROJECT NUMBER **24001431.00**
DATE **10/03/2025**

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DRAWING TITLE

CODE ANALYSIS

A-100

DRAWING NUMBER
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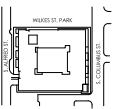
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ALFRED STREET BAPTIST CHURCH HOUSING

598 SOUTH ALFRED STREET
ALEXANDRIA, VA 22314
THE COMMUNITY BUILDERS, INC.
ALFRED STREET BAPTIST CHURCH

KEY PLAN



REVISIONS
NO. DATE DESCRIPTION

ISSUE
DATE DESCRIPTION
07.12.25 SUBMITTAL
09.16.25 COMPLETION SUBMISSION
10.03.25 VERIFICATION SUBMISSION


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DATE 10/03/2025

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DRAWING TITLE

GARAGE LEVEL P1 PLAN


DRAWING NUMBER
10/03/2025 A-MCH/PA **A-200**

PARKING LEGEND

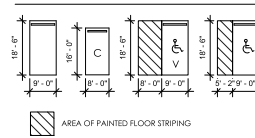

PARKING COUNT

ACCESSIBLE	2
ACCESSIBLE VAN	2
STANDARD	73
COMPACT	17
TOTAL PARKING	94

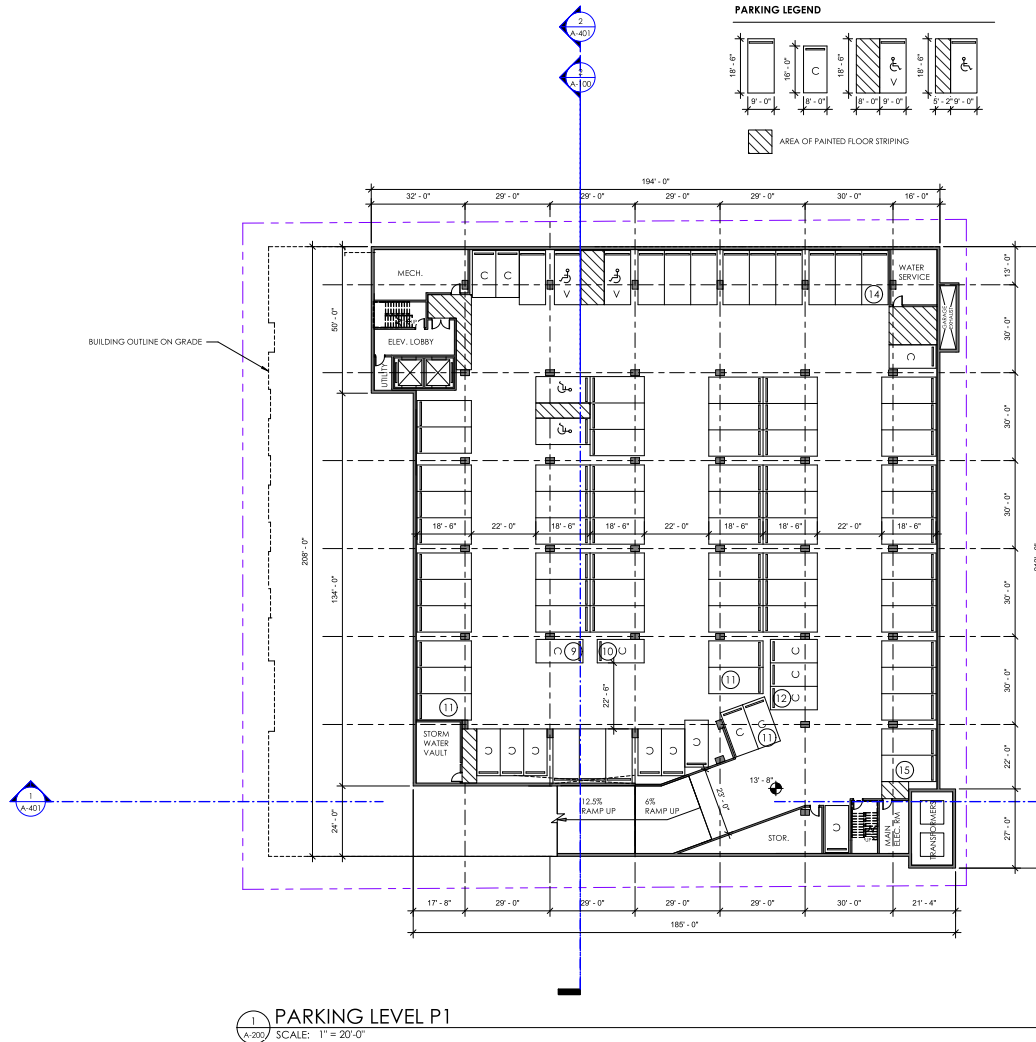

PARKING LEVEL P1
SCALE: 1" = 20'-0"


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ALFRED STREET BAPTIST CHURCH HOUSING

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ALFRED STREET BAPTIST CHURCH

KEY PLAN



REVISIONS
NO. DATE DESCRIPTION
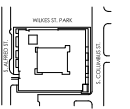
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DATE DESCRIPTION
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10.03.25 VERIFICATION SUBMISSION


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LEVEL 1 PLAN


A-201

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1 LEVEL 1 PLAN
A-201 SCALE: 1" = 20'-0"

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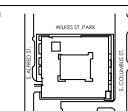
ALFRED STREET BAPTIST CHURCH HOUSING

598 SOUTH ALFRED STREET
ALEXANDRIA, VA 22314

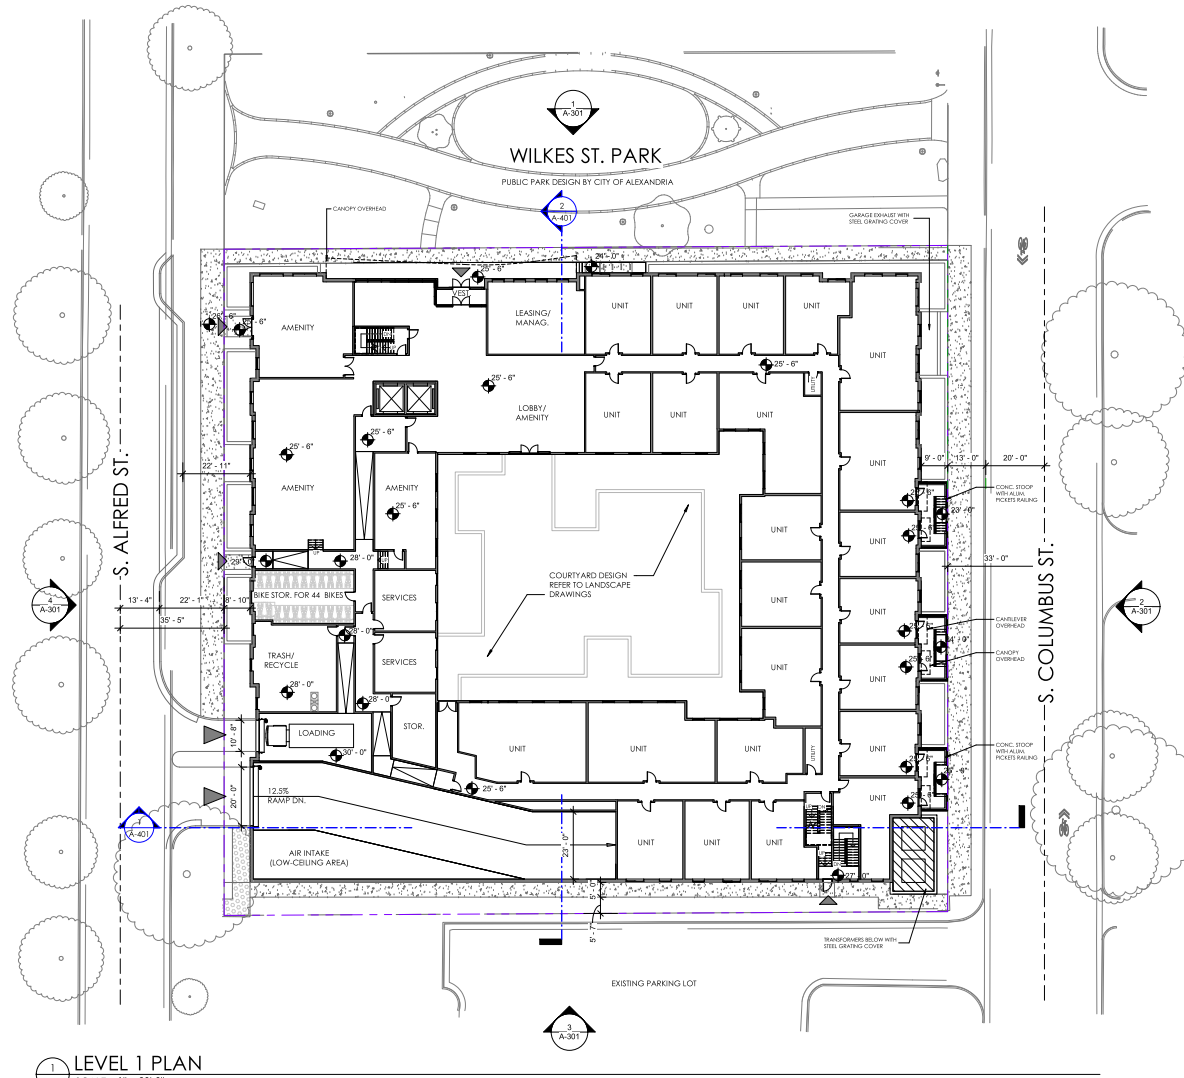THE COMMUNITY BUILDERS, INC.
ALFRED STREET BAPTIST CHURCH
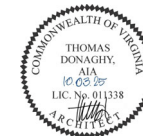
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KEY PLAN



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1	07/12/25	ISSUE
2	09/16/25	ISSUE SUBMISSION
3	10/03/25	COMPLETION SUBMISSION
4	10/03/25	VERIFICATION SUBMISSION

ISSUE

DATE	DESCRIPTION
07/12/25	ISSUE
09/16/25	ISSUE SUBMISSION
10/03/25	COMPLETION SUBMISSION
10/03/25	VERIFICATION SUBMISSION

PROJECT NUMBER

24001431.00

DATE

10/03/2025

SCALE

As Indicated


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LEVEL 2 PLAN

DRAWING NUMBER


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10/03/2025 A-KS/PWA



1 LEVEL 2 PLAN
A-202 SCALE: 1" = 20'-0"

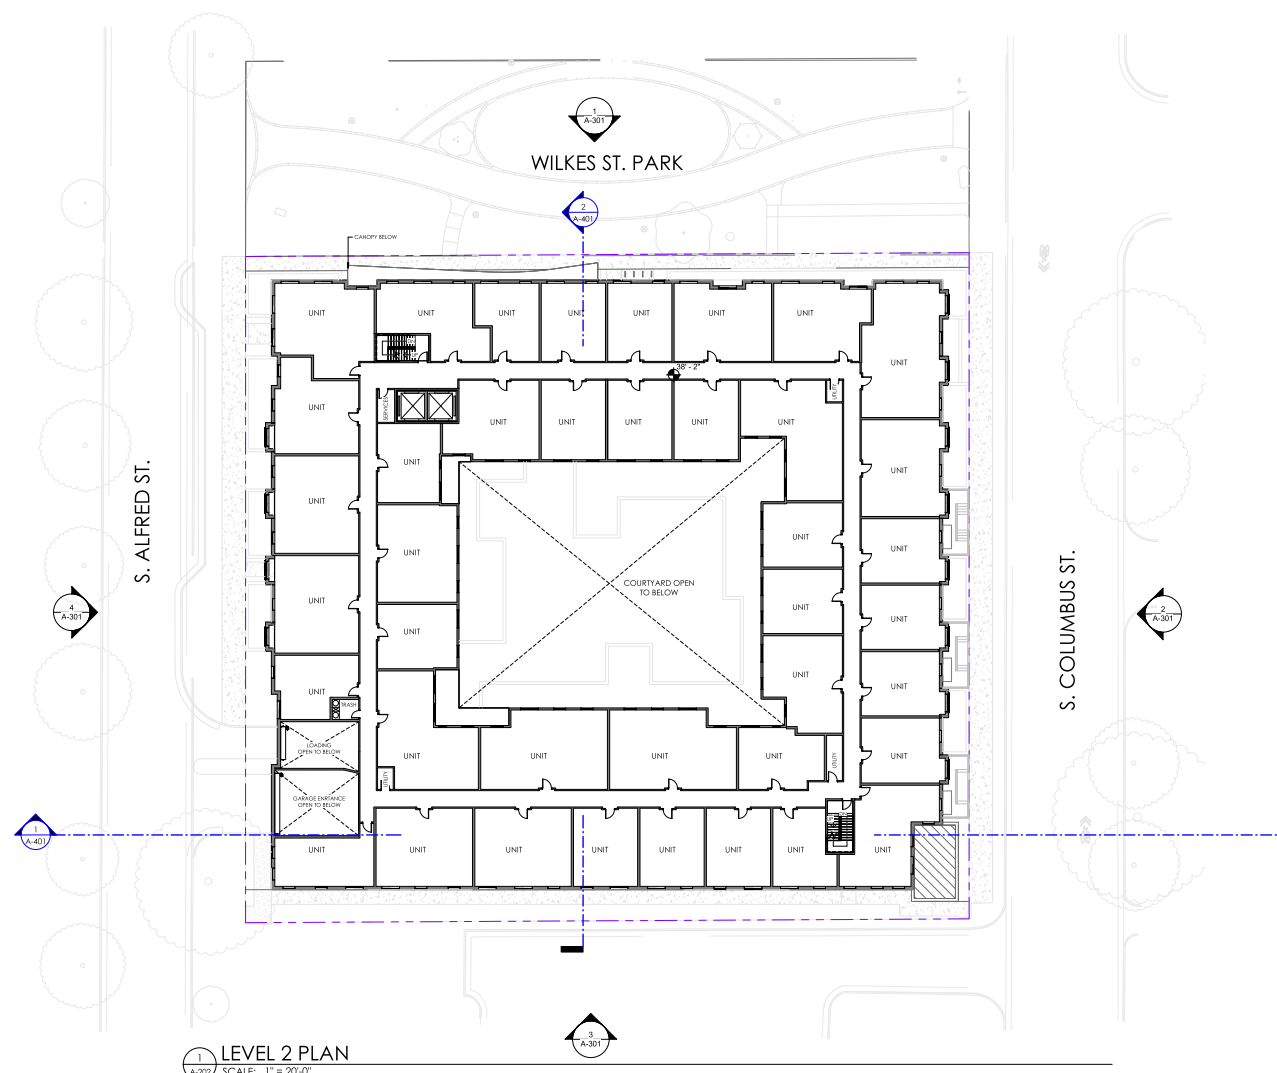SEAL & SIGNATURE

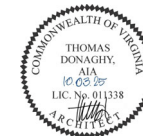


ALFRED STREET BAPTIST CHURCH HOUSING

598 SOUTH ALFRED STREET
ALEXANDRIA, VA 22314
THE COMMUNITY BUILDERS, INC.
ALFRED STREET BAPTIST CHURCH

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KEY PLAN

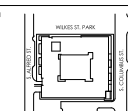

REVISIONS NO.	DATE	DESCRIPTION

ISSUE DATE	DESCRIPTION
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09.16.25	COMPLETENESS SUBMISSION
10.03.25	VERIFICATION SUBMISSION


PROJECT NUMBER 24001431.00
DATE 10/03/2025

SCALE As Indicated
DRAWING TITLE

LEVEL 3 PLAN


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DRAWING NUMBER
10/03/2025 A-203.PIA

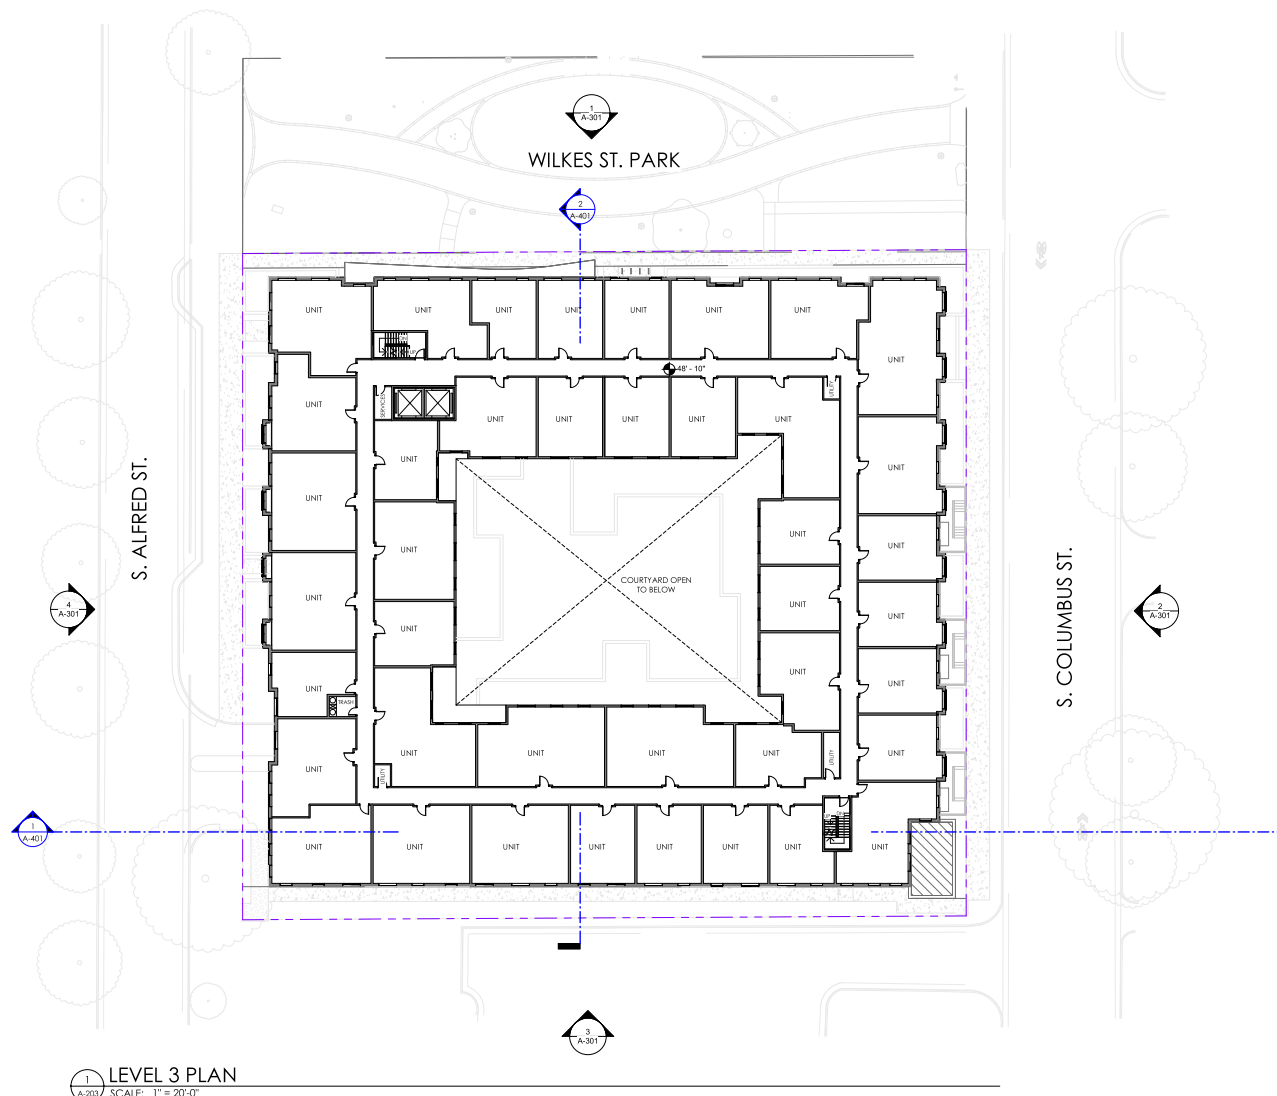

1 LEVEL 3 PLAN
A-203 SCALE: 1" = 20'-0"

SEAL & SIGNATURE

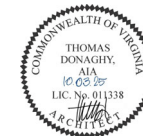


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 CHURCH HOUSING**

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 NO. DATE DESCRIPTION

ISSUE
 DATE DESCRIPTION
 07.11.25 ISSUE SUBMISSION
 09.16.25 COMPLETENESS SUBMISSION
 10.03.25 VERIFICATION SUBMISSION


PROJECT NUMBER 24001431.00
 DATE 10/03/2025

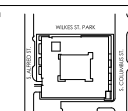SCALE As Indicated
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LEVEL 4 PLAN


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DRAWING NUMBER
 10/03/2025 A-204.PIA



LEVEL 4 PLAN
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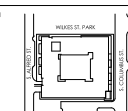
SEAL & SIGNATURE

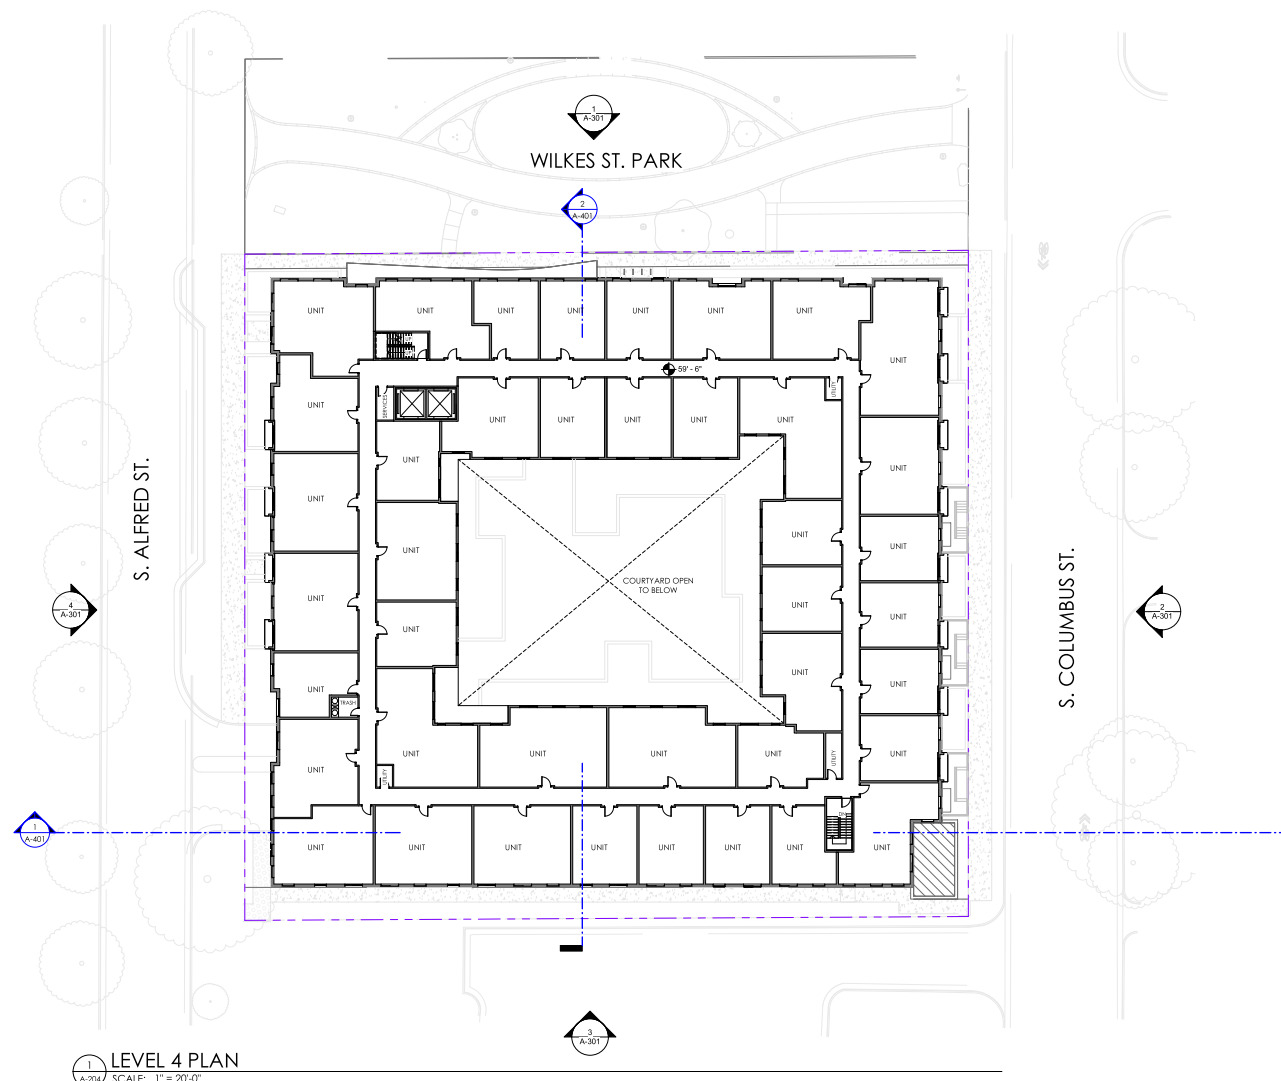

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ALEXANDRIA, VA 22314
THE COMMUNITY BUILDERS, INC.
ALFRED STREET BAPTIST CHURCH

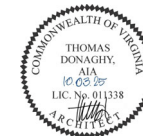KEY PLAN



REVISIONS

NO	DATE	DESCRIPTION
1	07/11/25	ISSUE
2	09/16/25	COMPLETION SUBMISSION
3	10/03/25	VERIFICATION SUBMISSION

ISSUE

DATE	DESCRIPTION
07/11/25	ISSUE
09/16/25	COMPLETION SUBMISSION
10/03/25	VERIFICATION SUBMISSION

PROJECT NUMBER

24001431.00

DATE

10/03/2025

SCALE

As Indicated


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ROOF PLAN

DRAWING NUMBER

A-205

10/03/2025 4:54 PM

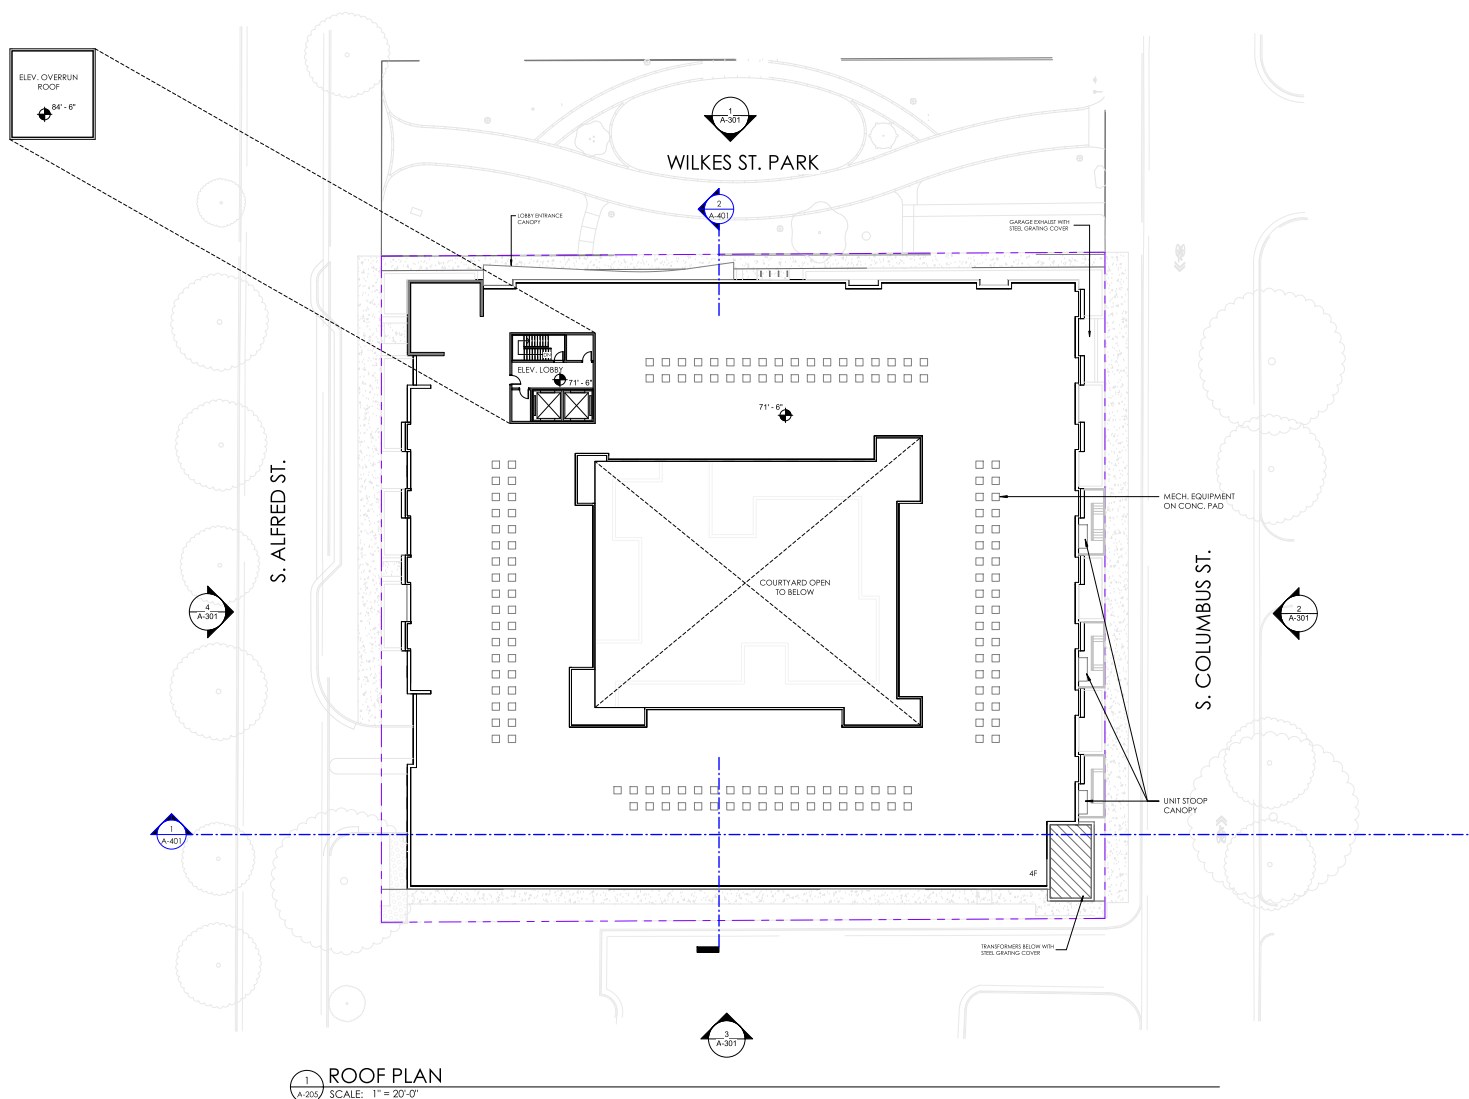

1 ROOF PLAN
A-205 SCALE: 1" = 20'-0"


SEAL & SIGNATURE



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ALFRED STREET BAPTIST CHURCH

KEY PLAN

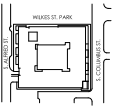

REVISIONS

NO DATE DESCRIPTION

ISSUE

DATE 07/1/25
DESCRIPTION SUBMITTAL
09/16/25 COMPLETION SUBMISSION
10/03/25 VERIFICATION SUBMISSION

PROJECT NUMBER

24001431.00

DATE

10/03/2025

SCALE

As Indicated


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AREA PLAN

DRAWING NUMBER


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10/03/2025 4:54 PM




TOTAL BASEMENT GROSS AREA = 36,617 SF
(not included in Total Gross Area or Net Floor Area)

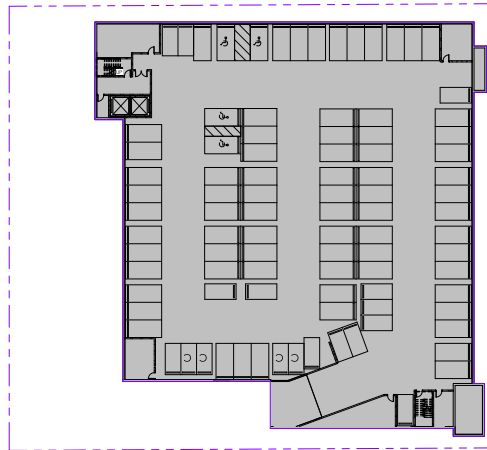5 PARKING LEVEL P1
A-206 SCALE: 1" = 30'-0"

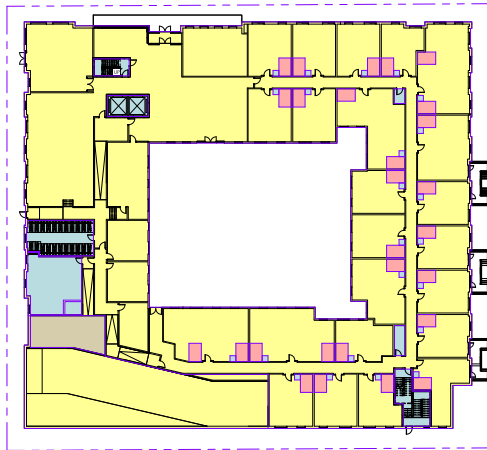


GROUND LEVEL GROSS AREA	
AREA EXCLUSION - Circulation, Shaft & Mechanical	2,497 SF
AREA EXCLUSION - Lavatory	1,094 SF
AREA EXCLUSION - Loading Space	655 SF
NET FLOOR AREA	33,214 SF
TOTAL GROSS AREA	37,742 SF

1 LEVEL 1
A-206 SCALE: 1" = 30'-0"

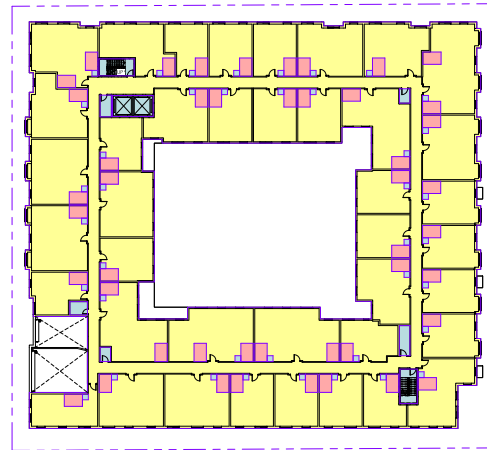


LEVEL 2 GROSS AREA	
AREA EXCLUSION - Circulation, Shaft & Mechanical	1,183 SF
AREA EXCLUSION - Lavatory	2,719 SF
NET FLOOR AREA	33,079 SF
TOTAL GROSS AREA	36,982 SF

2 LEVEL 2
A-206 SCALE: 1" = 30'-0"

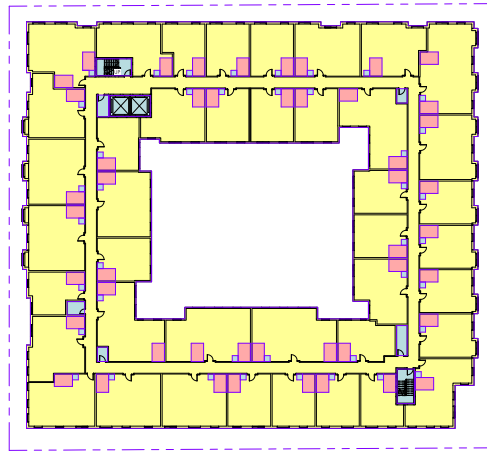

LEVEL 3 GROSS AREA	
AREA EXCLUSION - Circulation, Shaft & Mechanical	1,192 SF
AREA EXCLUSION - Lavatory	2,778 SF
NET FLOOR AREA	34,140 SF
TOTAL GROSS AREA	36,111 SF

3 LEVEL 3
A-206 SCALE: 1" = 30'-0"

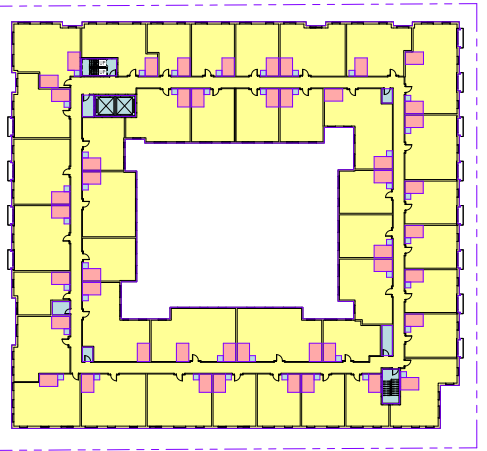

LEVEL 4 GROSS AREA	
AREA EXCLUSION - Circulation, Shaft & Mechanical	1,192 SF
AREA EXCLUSION - Lavatory	2,778 SF
NET FLOOR AREA	33,643 SF
TOTAL GROSS AREA	37,813 SF

4 LEVEL 4
A-206 SCALE: 1" = 30'-0"

BUILDING TOTAL GROSS AREA	
AREA EXCLUSION - Circulation, Shaft & Mechanical	6,045 SF
AREA EXCLUSION - Lavatory	9,872 SF
AREA EXCLUSION - Loading Space	655 SF
NET FLOOR AREA	134,276 SF
TOTAL GROSS AREA	150,867 SF


- BASEMENT, Area exclusions per City of Alexandria Zoning Ordinance 2-145
- CIRCULATION & SHAFTS & MECHANICAL ROOMS, Area exclusions per City of Alexandria Zoning Ordinance 2-145
- LAVATORY, Area exclusions per City of Alexandria Zoning Ordinance 2-145
- LOADING, Area exclusions per City of Alexandria Zoning Ordinance 2-145
- REMAINING NET FLOOR AREA, Area exclusions per City of Alexandria Zoning Ordinance 2-145

NOTE: Basement garage levels not counted towards GFA or Floor Area Ratio

UNIT MIX


LEVEL	1 - BR	2 - BR	3 - BR	4 - BR	UNIT/LEVEL
1ST	17	2	3	1	23
2ND	21	13	5	1	40
3RD	20	15	5	1	41
4TH	20	15	5	1	41
TOTAL	78	45	18	4	145

NOTE: THE UNIT COUNT AND MIX IS SUBJECT TO CHANGES BASED ON FUTURE PROGRAM REVISIONS

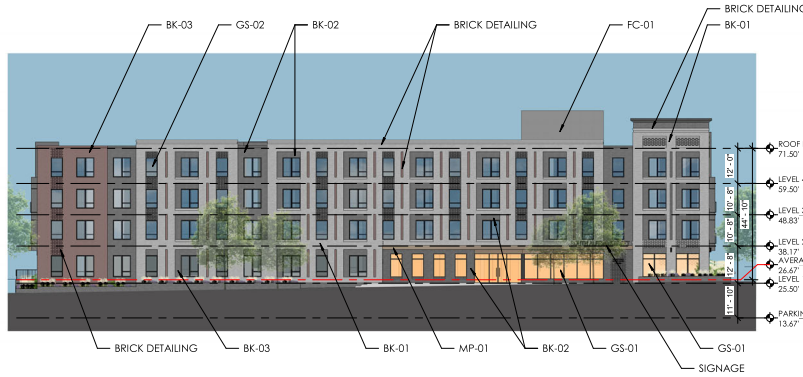


1 OVERALL ELEVATION 01 - NORTH ELEVATION
SCALE: 1" = 20'-0"

FIBER CEMENT RATIO: 0%

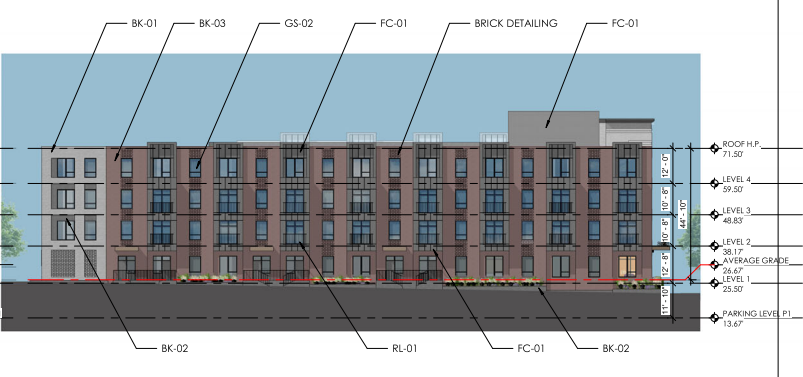


2 OVERALL ELEVATION 2 - EAST ELEVATION
SCALE: 1" = 20'-0"

FIBER CEMENT RATIO: 20%

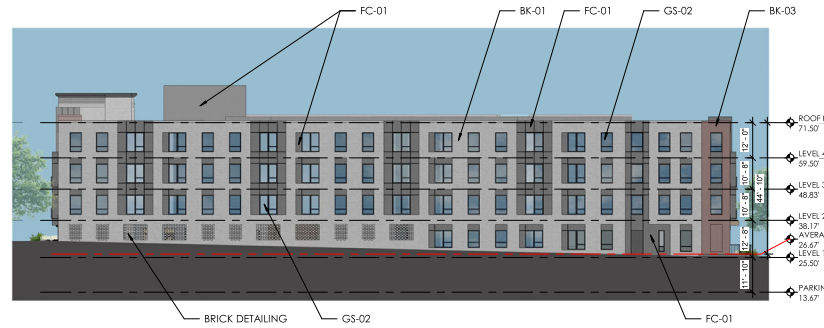

3 OVERALL ELEVATION 3 - SOUTH ELEVATION
SCALE: 1" = 20'-0"

FIBER CEMENT RATIO: 20%

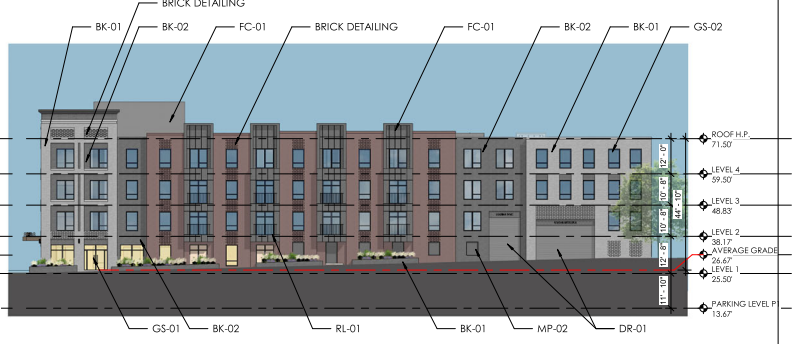


4 OVERALL ELEVATION 3 - WEST ELEVATION
SCALE: 1" = 20'-0"

FIBER CEMENT RATIO: 12%

EXTERIOR ELEVATION KEYNOTE LEGEND	
BK-01	BRICK VENEER - TYPE 1
BK-02	BRICK VENEER - TYPE 2
BK-03	BRICK VENEER - TYPE 3
MP-01	METAL CANOPY
MP-02	METAL LOUVER SYSTEM
RL-01	ALUM. PICKETS RAILING
FC-01	FIBER CEMENT PANEL - TYPE 1
GS-01	ALUM. AND GLASS STOREFRONT
GS-02	UNIT WINDOWS
DR-01	OVERHEAD ROLLING DOOR
SIGNAGE	PROPOSED SIGNAGE LOCATION

ALFRED STREET BAPTIST CHURCH HOUSING
598 SOUTH ALFRED STREET
ALEXANDRIA, VA 22314
THE COMMUNITY BUILDERS, INC.
ALFRED STREET BAPTIST CHURCH

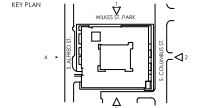

REVISIONS	NO	DATE	DESCRIPTION
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ISSUE	DATE	DESCRIPTION
01	07.12.25	DSUP SUBMISSION
02	09.16.25	COMPLETION SUBMISSION
03	10.03.25	VERIFICATION SUBMISSION

PROJECT NUMBER 24001431.00
DATE 10/03/2025

SCALE As Indicated
DRAWING TITLE

BUILDING ELEVATIONS


A-301

DRAWING NUMBER

10/03/2025 4:04PM

ALFRED STREET BAPTIST CHURCH HOUSING

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ALEXANDRIA, VA 22314
THE COMMUNITY BUILDERS, INC.
ALFRED STREET BAPTIST CHURCH

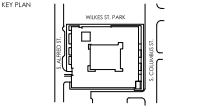

REVISIONS	NO	DATE	DESCRIPTION
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ISSUE	DATE	DESCRIPTION
01	07/12/25	DISP SUBMISSION
02	09/16/25	COMPLETION SUBMISSION
03	10/03/25	VERIFICATION SUBMISSION

PROJECT NUMBER 24001431.00
DATE 10/03/2025


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DRAWING TITLE

ELEVATIONS MATERIALS


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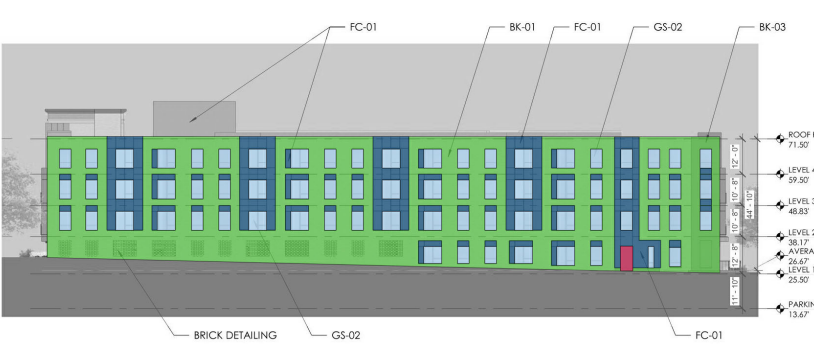
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SCALE: 1" = 20'-0"

FIBER CEMENT RATIO: 0%

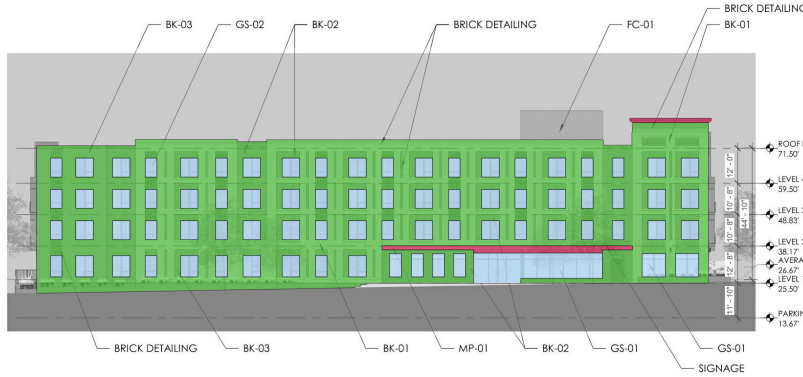


2 OVERALL ELEVATION 2 - EAST ELEVATION
SCALE: 1" = 20'-0"

FIBER CEMENT RATIO: 20%

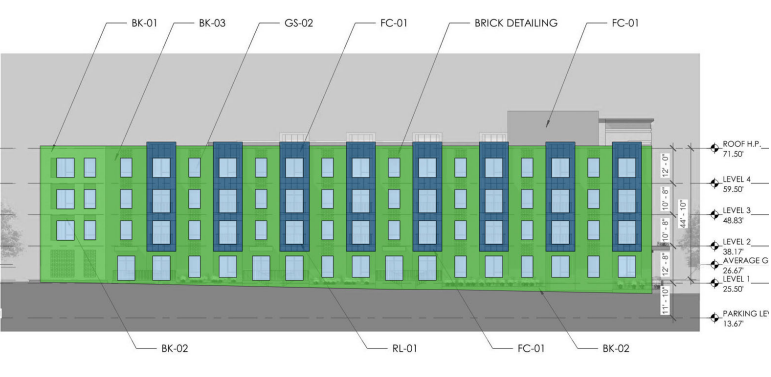

3 OVERALL ELEVATION 3 - SOUTH ELEVATION
SCALE: 1" = 20'-0"

FIBER CEMENT RATIO: 20%

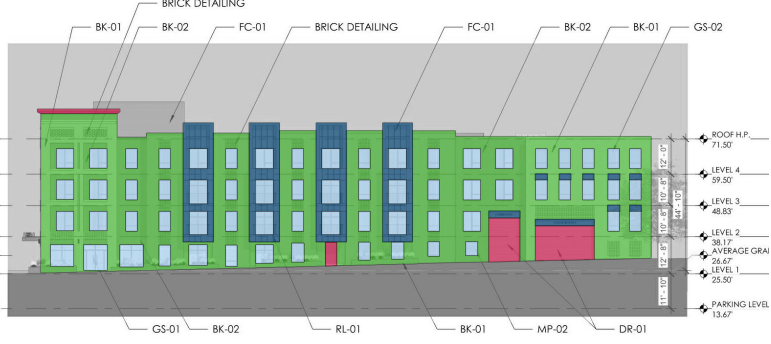

4 OVERALL ELEVATION 3 - WEST ELEVATION
SCALE: 1" = 20'-0"

FIBER CEMENT RATIO: 12%

EXTERIOR ELEVATION KEYNOTE LEGEND	
BK-01	BRICK VENEER - TYPE 1
BK-02	BRICK VENEER - TYPE 2
BK-03	BRICK VENEER - TYPE 3
MP-01	METAL CANOPY
MP-02	METAL COVER SYSTEM
RL-01	ALUM. PICKET RAILING
FC-01	FIBER CEMENT PANEL - TYPE 1
GS-01	ALUM. AND GLASS STOREFRONT
GS-02	UNIT WINDOWS
DR-01	OVERHEAD ROLLING DOOR
SIGNAGE	PROPOSED SIGNAGE LOCATION

MATERIALS

- METAL PANEL
- BRICK / MASONRY
- CEMENTITIOUS PANEL
- FENESTRATION


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ALFRED STREET BAPTIST CHURCH HOUSING

598 SOUTH ALFRED STREET
ALEXANDRIA, VA 22314
THE COMMUNITY BUILDERS, INC.
ALFRED STREET BAPTIST CHURCH

KEY PLAN



REVISIONS
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ISSUE
DATE DESCRIPTION
07/11/25 DISU SUBMISSION
09/16/25 COMPLETENESS SUBMISSION
10/03/25 VERIFICATION RESUBMISSION

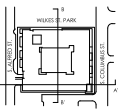
PROJECT NUMBER 24001431.00
DATE 10/03/2025

SCALE As Indicated
DRAWING TITLE

BUILDING SECTIONS

A-401

DRAWING NUMBER
10/03/2025 4:54 PM

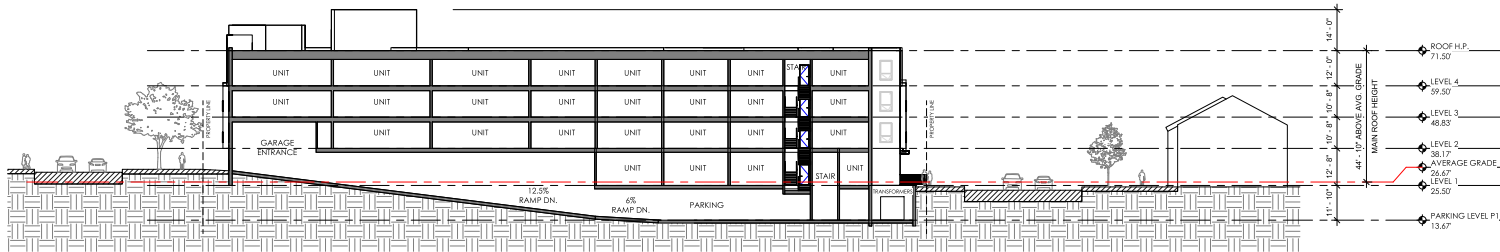

1 BUILDING SECTION A - A'
A-401 SCALE: 1" = 20'-0"



2 BUILDING SECTION B - B'
A-401 SCALE: 1" = 20'-0"



1 NE AERIAL - WILKES ST. & S. COLUMBUS ST.



2 NW AERIAL - WILKES ST. & S. ALFRED ST.

KGD


1101 13th Street NW
Suite 200
Washington, DC 20005
CONSULTANT

SEAL & SIGNATURE



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CHURCH HOUSING**
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	10.03.25	VERIFICATION SUBMISSION

PROJECT NUMBER 24001431.00
DATE 10/03/2025

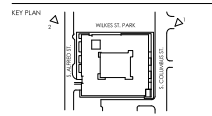SCALE As Indicated
DRAWING TITLE

AERIAL VIEW

DRAWING NUMBER **A-501**
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SEAL & SIGNATURE




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598 SOUTH ALFRED STREET
ALEXANDRIA, VA 22314
THE COMMUNITY BUILDERS, INC.
ALFRED STREET BAPTIST CHURCH

DESIGNATED CONSULTANT (DMC) HEREBY certifies that the drawings, specifications and other documents herein were prepared by or under the direct supervision and control of the undersigned, who is a duly Licensed Professional Architect in the Commonwealth of Virginia, and who is duly qualified to perform the services herein.

KEY PLAN

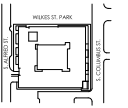

REVISIONS
NO. DATE DESCRIPTION

ISSUE
DATE DESCRIPTION
07/11/25 ISSUE SUBMISSION
09/16/25 COMPLETION SUBMISSION
10/03/25 VERIFICATION RESUBMISSION

PROJECT NUMBER 24001431.00
DATE 10/03/2025

SCALE As Indicated
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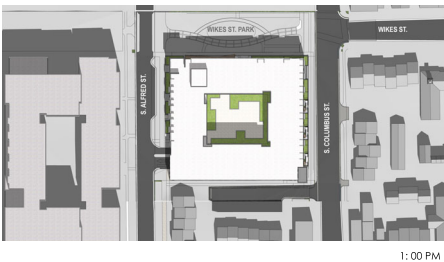
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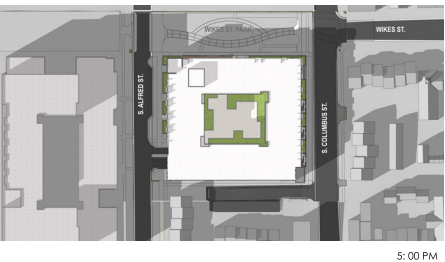
SPRING
MARCH 22ND



10: 00 AM



1: 00 PM




5: 00 PM

SUMMER
JUNE 22ND



10: 00 AM

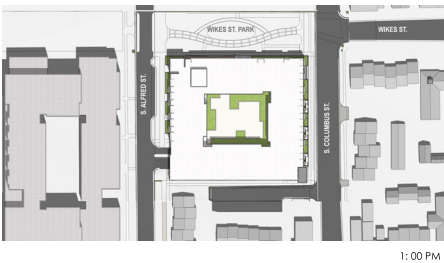

1: 00 PM



5: 00 PM

FALL
SEPTEMBER 22ND



10: 00 AM



1: 00 PM



5: 00 PM

WINTER
DECEMBER 22ND



10: 00 AM



1: 00 PM



5: 00 PM



1 NW CORNER - WILKES ST. & S. ALFRED ST.



2 NE CORNER PERSPECTIVE - S. ALFRED ST.



3 NE CORNER PERSPECTIVE - WILKES ST. & S. COLUMBUS ST.



4 SE CORNER PERSPECTIVE - S. COLUMBUS ST.


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1101 13th Street NW
Suite 200
Washington, DC 20005
CONSULTANT

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**ALFRED STREET BAPTIST
CHURCH HOUSING**
598 SOUTH ALFRED STREET
ALEXANDRIA, VA 22314
THE COMMUNITY BUILDERS, INC.
ALFRED STREET BAPTIST CHURCH



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09.16.25	09.16.25	COMPLETENESS SUBMISSION
10.03.25	10.03.25	VERIFICATION SUBMISSION

PROJECT NUMBER 24001431.00
DATE 10/03/2025

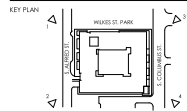SCALE As Indicated
DRAWING TITLE

PERSPECTIVE

DRAWING NUMBER **A-601**
10/03/2025 4:45:00 PM

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