ISSUE: Permit to Demolish/Capsulate (partial) and Certificate of Appropriateness

for alterations and addition

APPLICANT: Erica Rossi and John Medici

LOCATION: Old and Historic Alexandria District

820 South Lee Street

ZONE: RM/Residential Townhouse Zone

STAFF RECOMMENDATION

Staff recommends approval of the Permit to Demolish/Capsulate (partial) and Certificate of Appropriateness for alterations and addition, with the following conditions:

- The shutters be made of wood;
- The shutter dogs be installed in mortar joints;

Window/door glazing is clear, reflective, without tint, complying with the *Alexandria New and Replacement Window Performance Specifications in the Historic Districts*

BAR minutes from the February 7, 2024 hearing:

5&6 BAR#2023-00538 OHAD

Request for alterations and addition at 820 S Lee Street Applicant: Marks Woods Construction Services

BAR#2023-00539 OHAD

Request for partial demolition/encapsulation at 820 S Lee Street Applicant: Marks Woods Construction Services

BOARD ACTION: On a motion by Mr. Scott, and seconded by Ms. Miller, the Board of Architectural Review voted to approve BAR#2023-00538 and BAR#2023-00539 with staff recommendations. The motion carried on a vote of 6-0.

REASON

The Board found the proposed addition and alterations to be compatible with the community.

SPEAKERS

Erica Rossi, homeowner, gave a summary of the project, introduced her husband John Medici, and noted that they had lived in this house since 2010. They were available to answer questions.

Lucy Adams, project architect, discussed the proposed stain and roof colors.

DISCUSSION

Docket Items #11 & 12 BAR #2025-00291 & 2025-00293 Old and Historic Alexandria District September 3, 2025

Mr. Scott asked if all of the brick would be stained and was advised that it would be.

Ms. Zandian asked about the size and location of the proposed rooftop mechanical equipment shown on page 18 of the application materials. Ms. Adams advised that it would be located on the shed roof portion.

Mr. Scott asked if the proposal added a full third story to the house. Ms. Adams replied in the affirmative and also explained that at least two courses of brick would be added above the upper floor windows on the primary/west elevation, as currently the roof sits directly on the tops of those windows.

Mr. Lyons supported the project with staff recommendations.

Mr. Adams agreed with Mr. Lyons.

Ms. Zandian agreed with Mr. Lyons and Mr. Adams.


Ms. Miller also supported staff recommendations. She also suggested that the rear/east door have a contemporary configuration, as it is the only remaining traditional component on that elevation.

Mr. Scott said that this was a nice design and that he approved it as submitted.

Mr. Spencer fully supported the application.

GENERAL NOTES TO THE APPLICANT

- 1. APPEAL OF DECISION: In accordance with the Zoning Ordinance, if the Board of Architectural Review denies or approves an application in whole or in part, the applicant or opponent may appeal the Board's decision to City Council on or before 14 days after the decision of the Board.
- 2. COMPLIANCE WITH BAR POLICIES: All materials must comply with the BAR's adopted policies unless otherwise specifically approved.
- 3. BUILDING PERMITS: Most projects approved by the Board of Architectural Review require the issuance of one or more construction permits by Department of Code Administration (<u>including signs</u>). The applicant is responsible for obtaining all necessary construction permits after receiving Board of Architectural Review approval. Contact Code Administration, Permit Center, 4850 Mark Center Drive, Suite 2015, 703-746-4200 for further information.
- 4. ISSUANCE OF CERTIFICATES OF APPROPRIATENESS AND PERMITS TO DEMOLISH: Applicants must obtain a copy of the Certificate of Appropriateness or Permit to Demolish PRIOR to applying for a building permit. Contact BAR Staff, Room 2100, City Hall, 703-746-3833, or preservation@alexandriava.gov for further information.
- 5. EXPIRATION OF APPROVALS NOTE: In accordance with Sections 10-106(B), 10-206(B) and 10-307 of the Zoning Ordinance, any Board of Architectural Review approval will expire 12 months from the date of issuance if the work is not commenced and diligently and substantially pursued by the end of that 12-month period.
- 6. HISTORIC PROPERTY TAX CREDITS: Applicants performing extensive, certified rehabilitations of historic properties may separately be eligible for state and/or federal tax credits. Consult with the <u>Virginia Department of Historic Resources (VDHR)</u> prior to initiating any work to determine whether the proposed project may qualify for such credits.

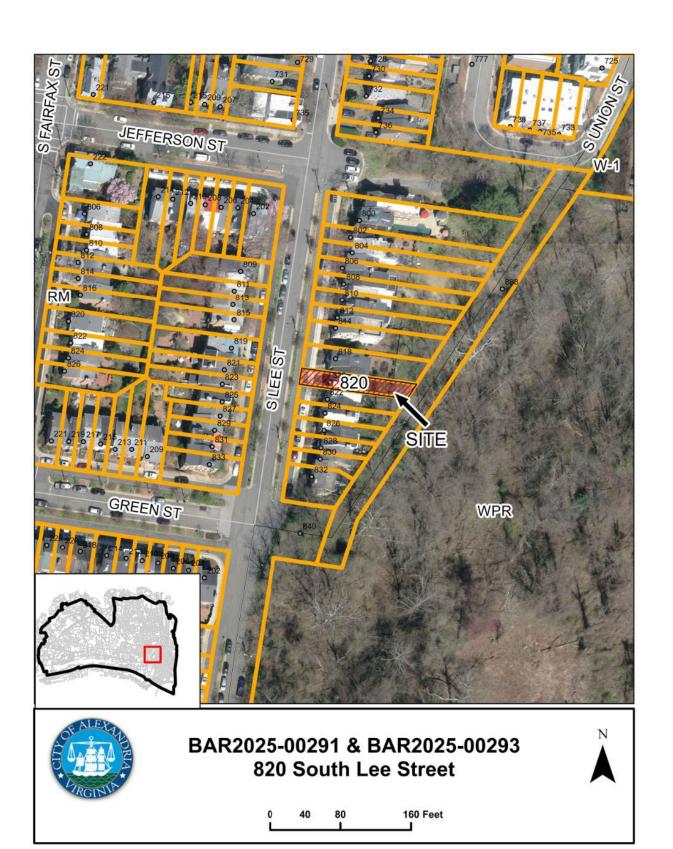

Docket Items #11 & 12 BAR #2025-00291 & 2025-00293 Old and Historic Alexandria District September 3, 2025

Note: Staff coupled the applications for a Permit to Demolish (BAR #2025-00293) and Certificate of Appropriateness (BAR #2025-00291) for clarity and brevity. The Permit to Demolish requires a roll call vote.

UPDATE

The case is returning to the Board because more than 12 months have passed since the original approval and construction has not yet begun. The original approval has therefore expired. The applicant has added some window and door replacements to this application which were not included in the original.

I. APPLICANT'S PROPOSAL

The applicant requests a Permit to Demolish/Capsulate (partial) and Certificate of Appropriateness to remove the existing roof and add a third story, add an open deck at the first floor, as well as alterations, at 820 South Lee Street.

Addition The applicant proposes to add a third story which will have two gable dormer windows on the front/west elevation and a shed dormer with doors and a Juliet balcony on the rear/east elevation. The new roof on the west elevation will be standing seam metal and the shed dormer will be clad in cementitious siding with an asphalt shingle roof on the east elevation. The roof of the shed dormer will also have solar panels. On the rear/east elevation, an open deck with a metal railing, above the existing covered patio, will also be constructed as part of this project. This will entail removing the existing window and wall space in order to add wood-clad bifold doors in this location.

Alterations The front/west shutters on the windows and entry door will be replaced, as will the front/west railing and fencing. The chimney will be altered and extended, and new trim will be added to the existing window on the first level of the primary/west elevation. Wood-clad bifold doors accessing the open deck will be added to the first level of the rear/east elevation. All brick will be stained. A door and windows at the rear/east elevation will be replaced, as will the basement door on the primary/west elevation.

Site context

The property is at the southern end of the City and backs to Jones Point Park. Although Jones Point Park is public, the portion of the park behind the subject property is wooded and not pedestrian friendly. Few people walk in this area. The changes to the rear/east elevation will therefore be minimally visible from a public right of way.

II. HISTORY

The interior unit townhouse at 820 South Lee Street was constructed as part of the Yates Garden subdivision ca. **1953.** The Board approved the construction of these rowhouses on March 12, 1953 and permit #s 5873 and 5874 were issued to Yates View Development Co. on June 11, 1953 for the construction of 16 buildings in the Yates Garden on South Lee Street. 820 South Lee is a three-bay, two-and-a-half story brick townhouse with a partial raised basement in a row

of eight townhouses with alternately projecting and set back facades. The main level has a single eight-over-eight window on the south half of the primary/west elevation and a small octagonal window over the main entry at the north half of this elevation. The third level has three six-over-six windows with shutters.

Previous BAR Approvals

- BAR2023-00538 & BAR2023-00539, February 7, 2024: Board approval to add a third story and a rear first-floor open deck.
- BAR2012-00321 Administrative approval for window replacement.

III. ANALYSIS

Permit to Demolish/Capsulate

In considering a Permit to Demolish/Capsulate, the Board must consider the following criteria set forth in the Zoning Ordinance, §10-105(B), which relate only to the subject property and not to neighboring properties. The Board has purview of the proposed demolition/capsulation regardless of visibility.

Standard	Description of Standard	Standard Met?
(1)	Is the building or structure of such architectural or historical interest that its moving, removing, capsulating or razing would be to the detriment of the public interest?	No
(2)	Is the building or structure of such interest that it could be made into a historic shrine?	No
(3)	Is the building or structure of such old and unusual or uncommon design, texture and material that it could not be reproduced or be reproduced only with great difficulty?	No
(4)	Would retention of the building or structure help preserve the memorial character of the George Washington Memorial Parkway?	N/A
(5)	Would retention of the building or structure help preserve and protect an historic place or area of historic interest in the city?	No
(6)	Would retention of the building or structure promote the general welfare by maintaining and increasing real estate values, generating business, creating new positions, attracting tourists, students, writers, historians, artists and artisans, attracting new residents, encouraging study and interest in American history, stimulating interest and study in architecture and design,	No

Docket Items #11 & 12 BAR #2025-00291 & 2025-00293 Old and Historic Alexandria District September 3, 2025

	educating citizens in American culture and heritage, and making the city a more attractive and desirable place in which to live?	

The analysis of the standards indicated above relate only to the specific portions of the building proposed for demolition/capsulation, not the overall building. In the opinion of staff, none of the criteria for demolition and capsulation are met and the Permit to Demolish/Capsulate should be granted. The area which will be demolished on this 1950s townhouse is not historic and the proposed demolition does not compromise its integrity. The materials to be demolished are not of unusual or uncommon design and could be reproduced easily.

Certificate of Appropriateness

Staff supports the proposed addition and alterations to this property. The Board approved adding a third story and a first-floor open deck and other minor alterations at the February 7, 2024 hearing. The proposed alterations in this application are appropriate for this mid-20th century Colonial Revival townhouse. Since the 1950s construction of these townhouses, there have been a number of significant third floor additions in this block, including:

- 826 South Lee Street: BAR2022-00230 & BAR2022-00235
- 812 South Lee Street: BAR2010-0050
- 833 South Lee Street: BAR2007-0002
- 809 South Lee Street: BAR2006-0002
- 821 South Lee Street: BAR2001-0080

The *Design Guidelines* encourage "respectful additions" which "make use of the design vocabulary of the existing...structure" and supports additions that "are compatible with both the architectural character of the existing house and the immediate neighborhood." Staff finds that the proposed Colonial Revival addition fully complies with these guidelines. Figure 1 depicts the west elevation of the proposed addition to 820 South Lee in the context of its blockface. The subject property will be no taller than 818 South Lee immediately to the north and will harmonize with 822 and 824 to the south. Much like other houses on the block, the proposed third story will have gable dormer windows. The new entry door to the basement will be wood clad with a single glazed window panel.

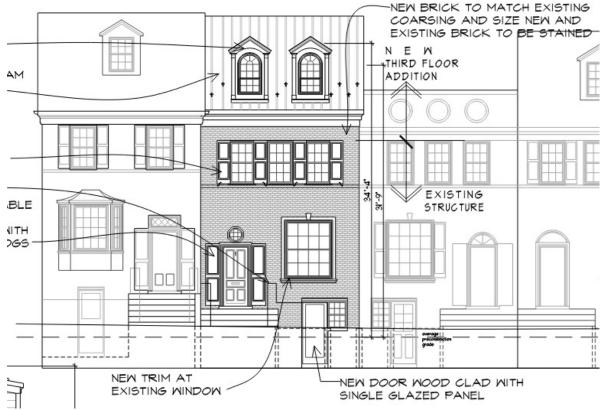


Figure 1: Proposed primary/west elevation

The standing seam metal roof will improve the appearance of the primary elevation, as will the new operable paneled shutters with shutter dogs. Staff also finds that staining the exterior brick would be appropriate for this 1950s building. It will not harm the brick and could improve the house's appearance, as the brick is currently an unusual color with some areas of discoloration. The new Pella Architect Series windows are appropriate and could be administratively approved. However, the application does not contain specifications for the glazing of these windows; those will need to be supplied prior to the issuance of the building permit.

The *Design Guidelines* state that open decks "are primarily a late-20th century occurrence... and are suburban in character." The Board has previously approved the construction of open decks in sections of the districts with a distinctly suburban feel or where there is minimal visibility of the deck from a public way. The subject property meets both these criteria. These 1950s townhouses are in a part of Alexandria with a distinct suburban feel. As noted above, it will be minimally visible and the wall area and window to be removed in order to construct the deck are not of unusual or uncommon design and could be reproduced easily.

With the conditions that the shutters be made of wood, the shutter dogs be installed in mortar joints, and the replacement window/door glazing is clear, reflective, without tint, complying with the *Alexandria New and Replacement Window Performance Specifications in the Historic Districts*, staff recommends approval of the project.

STAFF

Susan Hellman, Historic Preservation Planner, Planning & Zoning Tony LaColla, AICP, Land Use Services Division Chief, Planning & Zoning

IV. CITY DEPARTMENT COMMENTS

Legend: C- code requirement R- recommendation S- suggestion F- finding

Zoning

C-1 Proposed third story addition and replacement of rear covered structure with an open deck will comply with zoning.

Code Administration

C-1 A building permit is required.

Transportation and Environmental Services

- R-1 The building permit must be approved and issued prior to the issuance of any permit for demolition, if a separate demolition permit is required. (T&ES)
- R-2 Applicant shall be responsible for repairs to the adjacent city right-of-way if damaged during construction activity. (T&ES)
- R-3 No permanent structure may be constructed over any existing private and/or public utility easements. It is the responsibility of the applicant to identify any and all existing easements on the plan. (T&ES)
- F-1 After review of the information provided, an approved grading plan is not required at this time. Please note that if any changes are made to the plan it is suggested that T&ES be included in the review. (T&ES)
- F-2 If the alley adjacent to the parcel is to be used at any point of the construction process, the following will be required:
 - <u>For a Public Alley -</u> The applicant shall contact T&ES, Construction Permitting & Inspections at (703) 746-4035 to discuss any permits and accommodation requirements that will be required.
 - <u>For a Private Alley</u> The applicant must provide proof, in the form of an affidavit at a minimum, from owner of the alley granting permission of use. (T&ES)
- C-1 The applicant shall comply with the City of Alexandria's Solid Waste Control, Title 5, Chapter 1, which sets forth the requirements for the recycling of materials (Sec. 5-1-99). (T&ES)
- C-2 The applicant shall comply with the City of Alexandria's Noise Control Code, Title 11, Chapter 5, which sets the maximum permissible noise level as measured at the property line. (T&ES)

Docket Items #11 & 12 BAR #2025-00291 & 2025-00293 Old and Historic Alexandria District September 3, 2025

- C-3 Roof, surface and sub-surface drains be connected to the public storm sewer system, if available, by continuous underground pipe. Where storm sewer is not available applicant must provide a design to mitigate impact of stormwater drainage onto adjacent properties and to the satisfaction of the Director of Transportation & Environmental Services. (Sec.5-6-224) (T&ES)
- C-4 All secondary utilities serving this site shall be placed underground. (Sec. 5-3-3) (T&ES)
- C-5 Any work within the right-of-way requires a separate permit from T&ES. (Sec. 5-2) (T&ES)
- C-6 All improvements to the city right-of-way such as curbing, sidewalk, driveway aprons, etc. must be city standard design. (Sec. 5-2-1) (T&ES)

Alexandria Archaeology

F-1 No Archaeology comments.

V. ATTACHMENTS

- Application Materials
- Completed application
- Plans
- Material specifications
- Scaled survey plat if applicable
- Photographs
- Public comment
- Any other supporting documentation

BAR Case # BAR2025-00291 & BAR2025-00293

ADDRESS OF PROJECT:820 South Lee St
DISTRICT: MOId & Historic Alexandria ☐ Parker – Gray ☐ 100 Year Old Building
TAX MAP AND PARCEL: 081 03 02 10- LOT 507 ZONING:
APPLICATION FOR: (Please check all that apply)
☑ CERTIFICATE OF APPROPRIATENESS
PERMIT TO MOVE, REMOVE, ENCAPSULATE OR DEMOLISH (Required if more than 25 square feet of a structure is to be demolished/impacted)
WAIVER OF VISION CLEARANCE REQUIREMENT and/or YARD REQUIREMENTS IN A VISION CLEARANCE AREA (Section 7-802, Alexandria 1992 Zoning Ordinance)
WAIVER OF ROOFTOP HVAC SCREENING REQUIREMENT (Section 6-403(B)(3), Alexandria 1992 Zoning Ordinance)
Applicant: Property Owner Susiness (Please provide business name & contact person)
Name: Marks-woods Construction services
Address
City: Zip: Zip:
Phone: E-mail:
Authorized Agent (if applicable): Attorney Architect Z Contractor
Name: Grea Marks Phone:
E-mail:
Legal Property Owner:
Name: Erica Rossi + John Medici
Address:
City: Zip: Zip:
Phone:E-mail:
Yes No Is there an historic preservation easement on this property? Yes No If yes, has the easement holder agreed to the proposed alterations? Is there a homeowner's association for this property? Yes No If yes, has the homeowner's association approved the proposed alterations?

If you answered yes to any of the above, please attach a copy of the letter approving the project.

BAR Case # BAR2025-00291 & BAR2025-00293

NATURE OF PROPOSED WORK: Please check all that apply

considered feasible.

	NEW CONSTRUCTION EXTERIOR ALTERATION: Please check all that apply. awning fence, gate or garden wall HVAC equipment shutters windows siding shed pergola/trellis painting unpainted masonry other ADDITION DEMOLITION/ENCAPSULATION SIGNAGE
DE: be a	SCRIPTION OF PROPOSED WORK: Please describe the proposed work in detail (Additional pages may ttached).
F	Removing existing roof and adding third story. Adding open deck at first floor Replacing front fencing Replacement of windows and door at rear and replacement of basement door at front
SU	BMITTAL REQUIREMENTS:
req	ns listed below comprise the minimum supporting materials for BAR applications. Staff may uest additional information during application review. Please refer to the relevant section of the sign Guidelines for further information on appropriate treatments.
ma	olicants must use the checklist below to ensure the application is complete. Include all information and terial that are necessary to thoroughly describe the project. Incomplete applications will delay the extended of the application for review. Pre-application meetings are required for all proposed additions. applicants are encouraged to meet with staff prior to submission of a completed application.
Ele	ctronic copies of submission materials should be submitted whenever possible.
De	molition/Encapsulation: All applicants requesting 25 square feet or more of demolition/encapsulation st complete this section. Check N/A if an item in this section does not apply to your project.
	N/A Survey plat showing the extent of the proposed demolition/encapsulation. Existing elevation drawings clearly showing all elements proposed for demolition/encapsulation. Clear and labeled photographs of all elevations of the building if the entire structure is proposed to be demolished. Description of the reason for demolition/encapsulation. Description of the alternatives to demolition/encapsulation and why such alternatives are not

BAR Case	BAR2025-00291 &
= 111 Ouse 7	BAR2025-00293

Additions & New Construction: Drawings must be to scale and should not exceed 11" x 17" unless approved by staff. All plans must be folded and collated into 3 complete 8 1/2" x 11" sets. Additional copies may be requested by staff for large-scale development projects or projects fronting Washington Street. Check-N/A if an item in this section does not apply to your project.

	N/A	
V	N/A	structures on the lot, location of proposed structure or addition, dimensions of existing structure(s), proposed addition or new construction, and all exterior, ground and roof mounts of the structure of the st
V		equipment. FAR & Open Space calculation form. Clear and labeled photographs of the site, surrounding properties and existing structures, if applicable.
∨		Existing elevations must be scaled and include dimensions. Proposed elevations must be scaled and include dimensions. Include the relationship to adjacent structures in plan and elevations.
		Materials and colors to be used must be specified and delineated on the drawings. Actual samples may be provided or required
\checkmark		doors, lighting, fencing, HVAC equipment and walls
		For development site plan projects, a model showing mass relationships to adjacent properties and structures.
		& Awnings: One sign per building under one square foot does not require BAR approval unless ed. All other signs including window signs require BAR approval. Check N/A if an item in this section does to your project.
		Linear feet of building: Front:Secondary front (if corner lot): Square feet of existing signs to remain: Photograph of building showing existing conditions. Dimensioned drawings of proposed sign identifying materials, color, lettering style and text. Location of sign (show exact location on building including the height above sidewalk). Means of attachment (drawing or manufacturer's cut sheet of bracket if applicable). Description of lighting (if applicable). Include manufacturer's cut sheet for any new lighting fixtures and information detailing how it will be attached to the building's facade.
Alt	erati	ions: Check N/A if an item in this section does not apply to your project.
V	N/A	Clear and labeled photographs of the site, especially the area being impacted by the alterations,
V		all sides of the building and any pertinent details. Manufacturer's specifications for materials to include, but not limited to: roofing, siding, windows, doors, lighting, fencing, HVAC equipment and walls.
		Drawings accurately representing the changes to the proposed structure, including materials and overall dimensions. Drawings must be to scale
\exists		An official survey plat showing the proposed locations of HVAC units, fences, and sheds. Historic elevations or photographs should accompany any request to return a structure to an earlier appearance.

ALL APPLICATIONS: Please read and check that you have read and understand the following items:

- I have submitted a filing fee with this application. (Checks should be made payable to the City of Alexandria. Please contact staff for assistance in determining the appropriate fee.)
- I understand the notice requirements and will return a copy of the three respective notice forms to BAR staff at least five days prior to the hearing. If I am unsure to whom I should send notice I will contact Planning and Zoning staff for assistance in identifying adjacent parcels.
- I, the applicant, or an authorized representative will be present at the public hearing.
- I understand that any revisions to this initial application submission (including applications deferred for restudy) must be accompanied by the BAR Supplemental form and 3 sets of revised materials.

The undersigned hereby attests that all of the information herein provided including the site plan, building elevations, prospective drawings of the project, and written descriptive information are true, correct and accurate. The undersigned further understands that, should such information be found incorrect, any action taken by the Board based on such information may be invalidated. The undersigned also hereby grants the City of Alexandria permission to post placard notice as required by Article XI, Division A, Section 11-301(B) of the 1992 Alexandria City Zoning Ordinance, on the property which is the subject of this application. The undersigned also hereby authorizes the City staff and members of the BAR to inspect this site as necessary in the course of research and evaluating the application. The applicant, if other than the property owner, also attests that he/she has obtained permission from the property owner to make this application.

APPLICANT OR AUTHORIZED AGENT:

Signature:

Printed Name: <u>Greg</u>

Date: $\frac{7/21}{2025}$

OWNERSHIP AND DISCLOSURE STATEMENT Use additional sheets if necessary

1. Applicant. State the name, a	ddress and percent of owner	rship of any person or entity owning		
an interest in the applicant, un	less the entity is a corp	oration or partnership, in which		
case identify each owner of n	nore than three percent. Th	he term ownership interest shall		
include any legal or equitable	interest held at the time of	the application in the real property		
which is the subject of the application.				

Name	Address	Percent of Ownership
1. Gregory Marks		100%
2.	•	
3.		

2. Property. State the name, address and percent of ownership of any person or entity owning an interest in the property located at 820 S Lee (address), unless the entity is a corporation or partnership, in which case identify each owner of more than three percent. The term ownership interest shall include any legal or equitable interest held at the time of the application in the real property which is the subject of the application.

Name	Address	Percent of Ownership
1. Erica + John Russi - Medici	A	100%
2.		
3.		

3. Business or Financial Relationships. Each person or entity listed above (1 and 2), with an ownership interest in the applicant or in the subject property is required to disclose **any** business or financial relationship, as defined by Section 11-350 of the Zoning Ordinance, existing at the time of this application, or within the12-month period prior to the submission of this application with any member of the Alexandria City Council, Planning Commission, Board of Zoning Appeals or either Boards of Architectural Review.

Name of person or entity	Relationship as defined by Section 11-350 of the Zoning Ordinance	Member of the Approving Body (i.e. City Council, Planning Commission, etc.)
1.	_	
2.		
3.		

NOTE: Business or financial relationships of the type described in Sec. 11-350 that arise after the filing of this application and before each public hearing must be disclosed prior to the public hearings.

As the applicant or the applicant's authorized agent, I hereby attest to the best of my ability that the information provided above is true and correct.

8/6/25 Gregory T. Marks
Printed Name


Department of Planning & Zoning Floor Area Ratio and Open Space Calculations

B

A. Property Information					
A1.				Zon	
Street Address	v			2011	е
Total Lot Area	^	Floor Area Ratio Allowed by Zone	=	Max	imum Allowable Floor Area
Existing Gross Floor Area Existing Gross Area		Allowable Exclusions**			
Basement		Basement**		B1.	Sq. Ft.
First Floor		Stairways**			Existing Gross Floor Area*
Second Floor		Mechanical**		B2.	Allowable Floor Exclusions**
Third Floor		Attic less than 7'**			
Attic		Porches**		В3.	Sq. Ft. Existing Floor Area Minus Exclusions
Porches		Balcony/Deck**			(subtract B2 from B1)
Balcony/Deck		Lavatory***		Con	mments for Existing Gross Floor Area
Lavatory***		Other**			
Other covered		Other**			
	B2.	Total Exclusions			
Proposed Gross Floor Area Proposed Gross Area Basement First Floor Second Floor Third Floor Attic Porches Balcony/Deck Lavatory***		Allowable Exclusions** Basement** Stairways** Mechanical** Attic less than 7'** Porches** Balcony/Deck** Lavatory*** Other**		C1. C2.	Sq. Ft. Proposed Gross Floor Area* Sq. Ft. Allowable Floor Exclusions** Sq. Ft. Proposed Floor Area Minus Exclusions (subtract C2 from C1)
Other		Other**			Notes
<u>Total Gross</u>	C2.	Total Exclusions			*Gross floor area is the sum of <u>all areas</u> under roof of a lot, measured from the face of exterior walls, including basements,
D. Total Floor Area D1. Sq. Ft. Total Floor Area (add B3 and C3) D2. Sq. Ft. Total Floor Area Allowed by Zone (A2)		E1. Sq. F Existing Open Space Sq. F Required Open Space	Ft. Ft.		garages, sheds, gazebos, guest buildings and other accessory buildings. *** Refer to the Zoning Ordinance (Section 2-145(B)) and consult with Zoning Staff for information regarding allowable exclusions. Sections may also be required for some exclusions. ***Lavatories may be excluded up to a maximum of 50 square feet, per lavatory. The maximum total of excludable area for lavatories shall be no greater than 10% of gross floor area.
	Street Address Total Lot Area Existing Gross Floor Area Existing Gross Area Basement First Floor Second Floor Third Floor Attic Porches Balcony/Deck Lavatory*** Other COVETED Datio Total Gross Proposed Gross Floor Area Proposed Gross Area Basement First Floor Second Floor Third Floor Attic Porches Balcony/Deck Lavatory*** Other Total Gross Total Floor Area Sq. Ft. Total Floor Area (add B3 and C3) Sq. Ft. Total Floor Area Allowed	Street Address Total Lot Area Existing Gross Floor Area Existing Gross Area Basement First Floor Second Floor Third Floor Attic Porches Balcony/Deck Lavatory*** Other*Covered Datio Total Gross Basement First Floor Second Floor Third Floor Attic Proposed Gross Floor Area Proposed Gross Area Basement First Floor Second Floor Third Floor Attic Porches Balcony/Deck Lavatory*** Other Total Gross C2. Total Floor Area Sq. Ft. Total Floor Area Allowed	Total Lot Area Existing Gross Floor Area Existing Gross Area Basement First Floor Second Floor Attic Porches Balcony/Deck Lavatory*** Other** Other** Droposed Gross Area Basement First Floor Second Floor Attic Porches Balcony/Deck Lavatory*** Other** Other** Datal Gross B2. Total Exclusions* Balcony/Deck* Balcony/Deck Lavatory*** Other** Other** Droposed Gross Floor Area Proposed Gross Area Basement First Floor Second Floor Attic Porches Balcony/Deck Lavatory*** Other** Second Floor Attic Porches Balcony/Deck Lavatory*** Other* Other Other* Other* Other Other* Other Other Other* Other Ot	Total Lot Area Existing Gross Floor Area Existing Gross Floor Area Existing Gross Area Basement Basement First Floor Stairways** Porches Balcony/Deck Lavatory*** Other** Second Floor Attic Basement First Floor Balcony/Deck** Balcony/Deck** Lavatory*** Other** Other** Proposed Gross Floor Area Proposed Gross Floor Area Proposed Gross Area Basement Basement First Floor Stairways** Allowable Exclusions Proposed Gross Floor Area Proposed Gross Floor Area Proposed Gross Area Basement Basement* First Floor Stairways** Mechanical** Attic less than 7*** Attic less than 7*** Other* Total Floor Area Sq. Ft. Existing Open Space E. Open Space E. Required Open Space E. Proposed Open Space E. Proposed Open Space	Street Address Total Lot Area Existing Gross Floor Area Existing Gross Area Basement Basement First Floor Stainways** Second Floor Attic Porches Balcony/Deck* Lavatory*** Other** Other** Other Gross Area Basement Basement Basement Basement Basement C1. Stairways** C2. Allowable Exclusions** Ba. Ba. Allowable Exclusions** Ba. Core Attic less than 7*** Core Core Attic Porches Balcony/Deck** Canding area Allowable Exclusions C2. Total Floor Attic Porches** Basement C1. C3. Attic less than 7*** C4. C4. C5. C6. C6. C6. C7. C6. C7. C7. C7

The undersigned hereby certifications are true and correct

Signature: _____ Date: _____

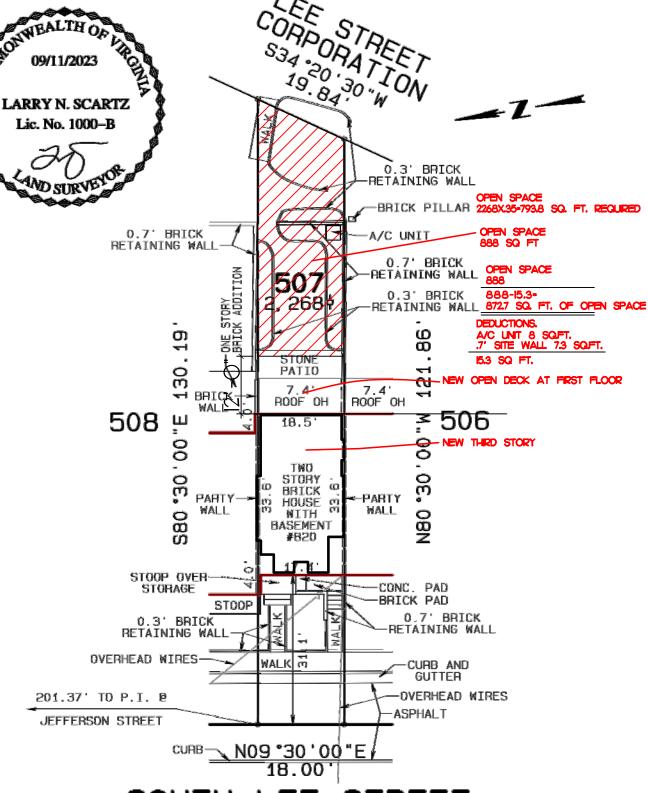

SOUTH LEE STREET

PHYSICAL IMPROVEMENTS SURVEY

LOT 507, BLOCK 7

YATES GARDENS

CITY OF ALEXANDRIA, VIRGINIA

SCALE: 1"=20' DATE: SEPTEMBER 11, 2023

NO TITLE REPORT FURNISHED.

PLAT SUBJECT TO RESTRICTIONS & EASEMENTS OF RECORD OR OTHERWISE.

FENCE LOCATIONS, IF SHOWN, ARE APPROXIMATE ONLY AND DO NOT CERTIFY AS TO OWNERSHIP.


CASE NAME: ROSSI / MEDICI

SCARTZ SURVEYS

LARRY N. SCARTZ LO CERTIFIED LAND SURVEYOR WOODBRIDGE, VIRGINIA LARRY

LOCAL (703) 494-4181 FAX (703) 494-3330 LARRY.SCARTZ@SCARTZ.COM



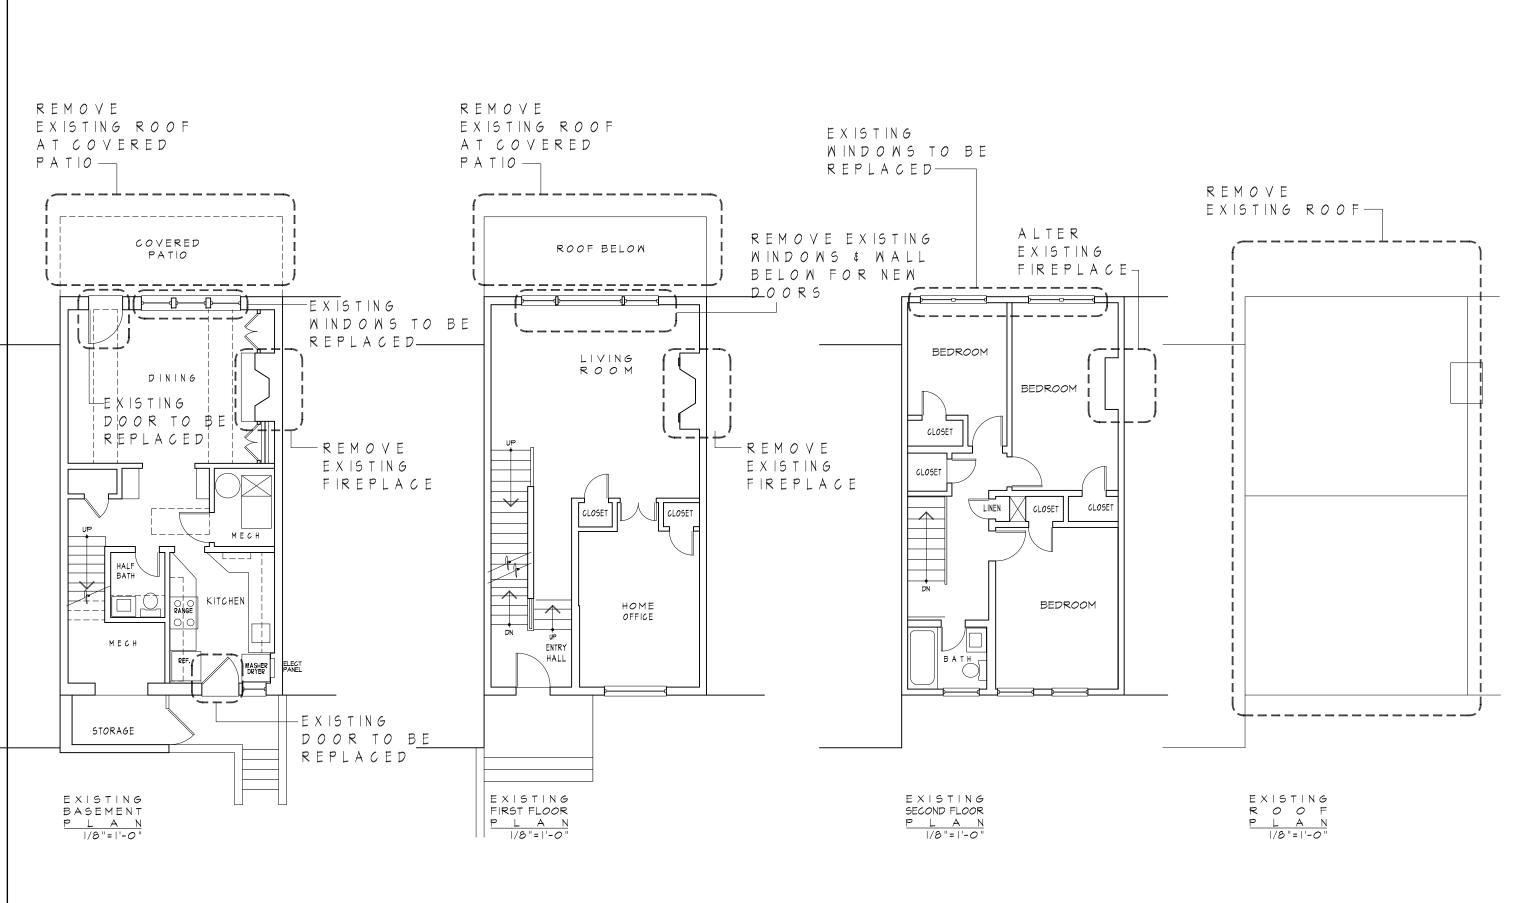

9303 IRVING STREET MANASSASVA 2 0 1 1 0 · 5 1 1 0

E MAIL- hay@posteurdesigns.com
TELEPHONE - 703 472 4172
FACSIMILE - 703 393 8706

M MARKS-WOODS

CONSTRUCTION SERVICES

EDICI RESIDENCE SLEE STREET NDRIA VIRGINIA

COPTRIGHT 2023 LUCLE F ADMS ARCHTECT FIRED PARAMS COPTRIGHT PROTECTION ACT. ANY INAMINORIZED JOE COPTING OR MOVEMENT ALONG OF THE ORGANIAL IS PROMISTED TO THE ORGANIAL INCOME.

I M 2 0 X A A

 ${f S}_{f B}^{f S}$


0

O9/O7/23 11/O3/23 11/O8/23 12/O5/23 O6/12/25 B A R 12/27/23

07/21/25

EXISTING PLANS

SHEET NUMBER

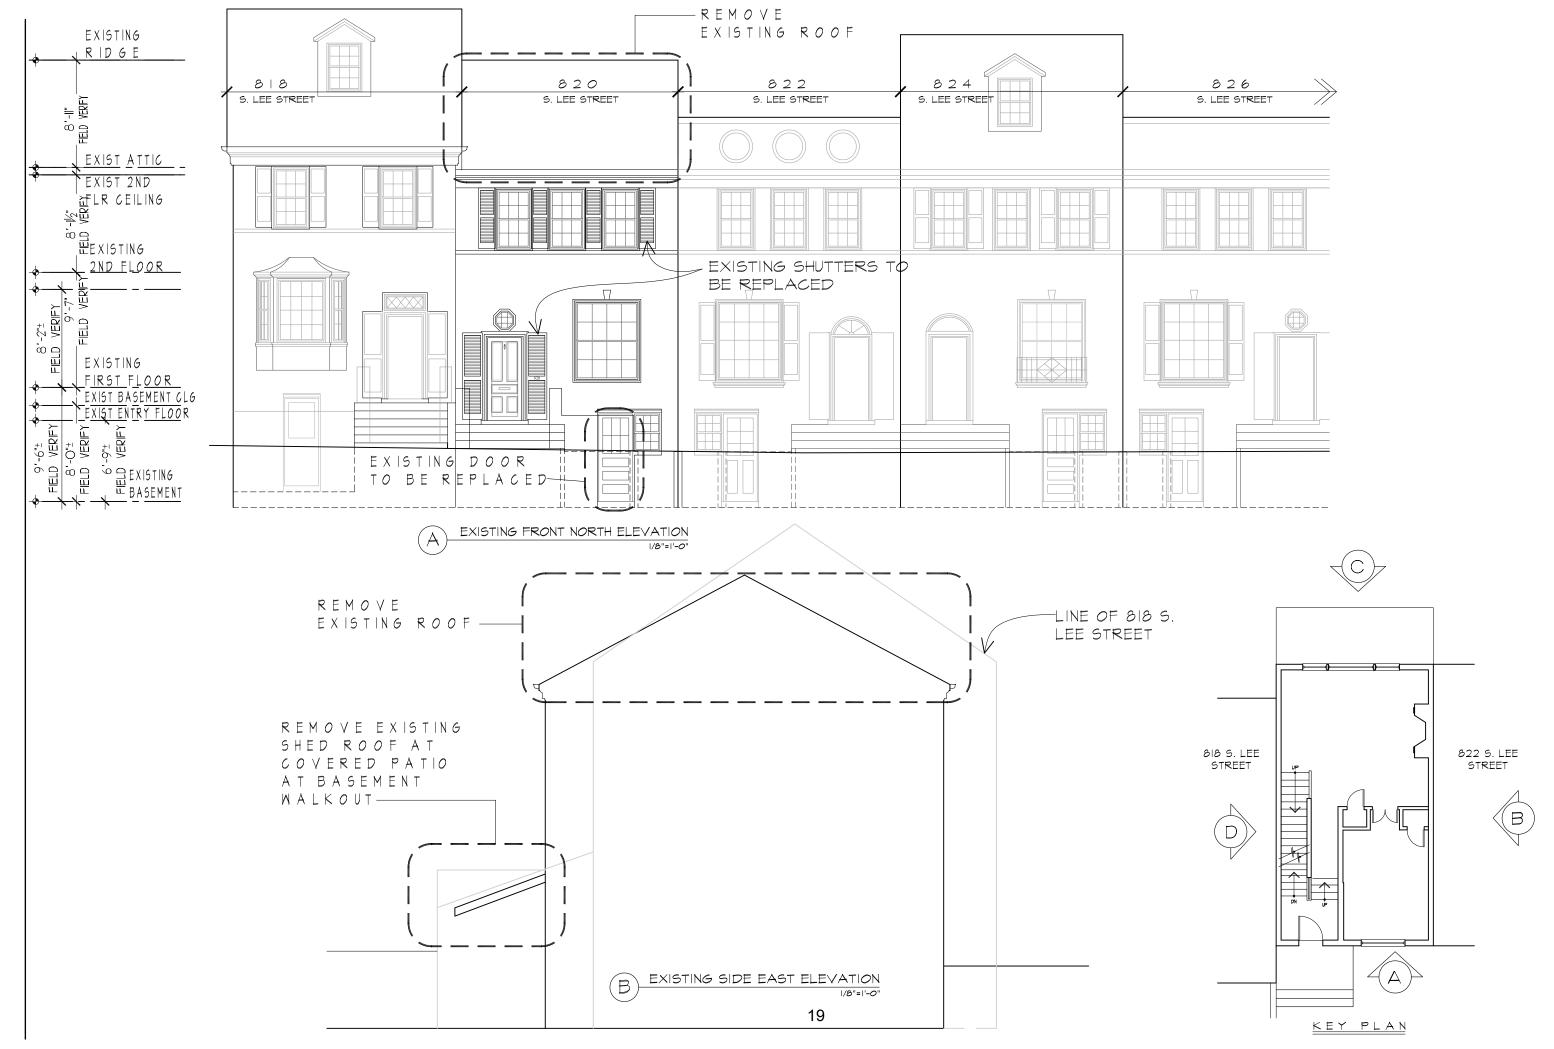

9303 IRVING STRE M A N A S S A S V 2 0 1 1 0 · 5 1 1

M MARKS-WOODS

CONSTRICTION SERVICES 드

Ŋ Z RESIDE STREET STREET VIRGINIA Œ EDICI SLEB NDRIA

0 \mathbb{R} ISSUE DATE

 \mathbf{S}


z W_O ∀ $rac{1}{2} \times$ $^{\circ}$ $^{\circ}$ $^{\circ}$

D E S I G N O9/O7/23 11/O3/23 11/O8/23 12/O5/23 O6/12/25 B A R

12/27/23 07/21/25

SHEET TITLE EXISTING ELEVATIONS

SHEET NUMBER

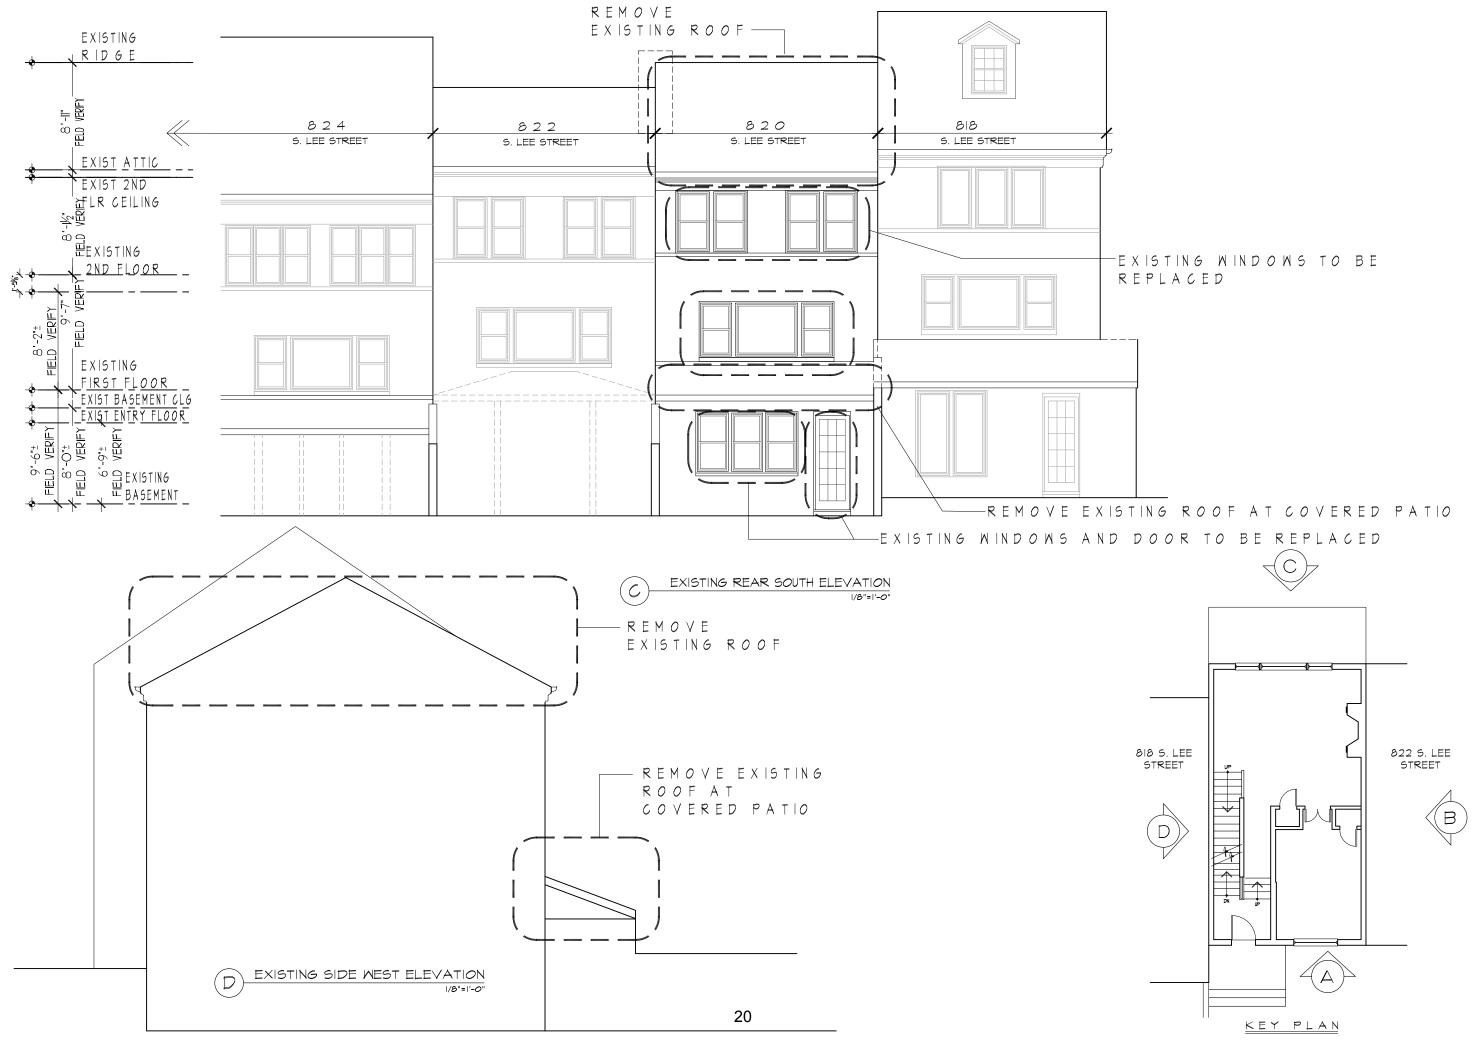

M MARKS-WOODS

CONSTRICTION SERVICES

Œ Ŋ N A ᄪᆫ OEZ RESII STREE VIRGII


囝 $\begin{array}{c} C \ I \\ L \ E \\ I \ A \end{array}$. O S O **W** 0 A $rac{1}{2}$ $^{\circ}$ $^{\circ}$ $^{\circ}$ $^{\circ}$ 0 \mathbb{R}

ISSUE DATE D E S I G N O9/O7/23 11/O3/23 11/O8/23 12/O5/23 O6/12/25

BAR 12/27/23 07/21/25

SHEET TITLE EXISTING ELEVATIONS

SHEET NUMBER

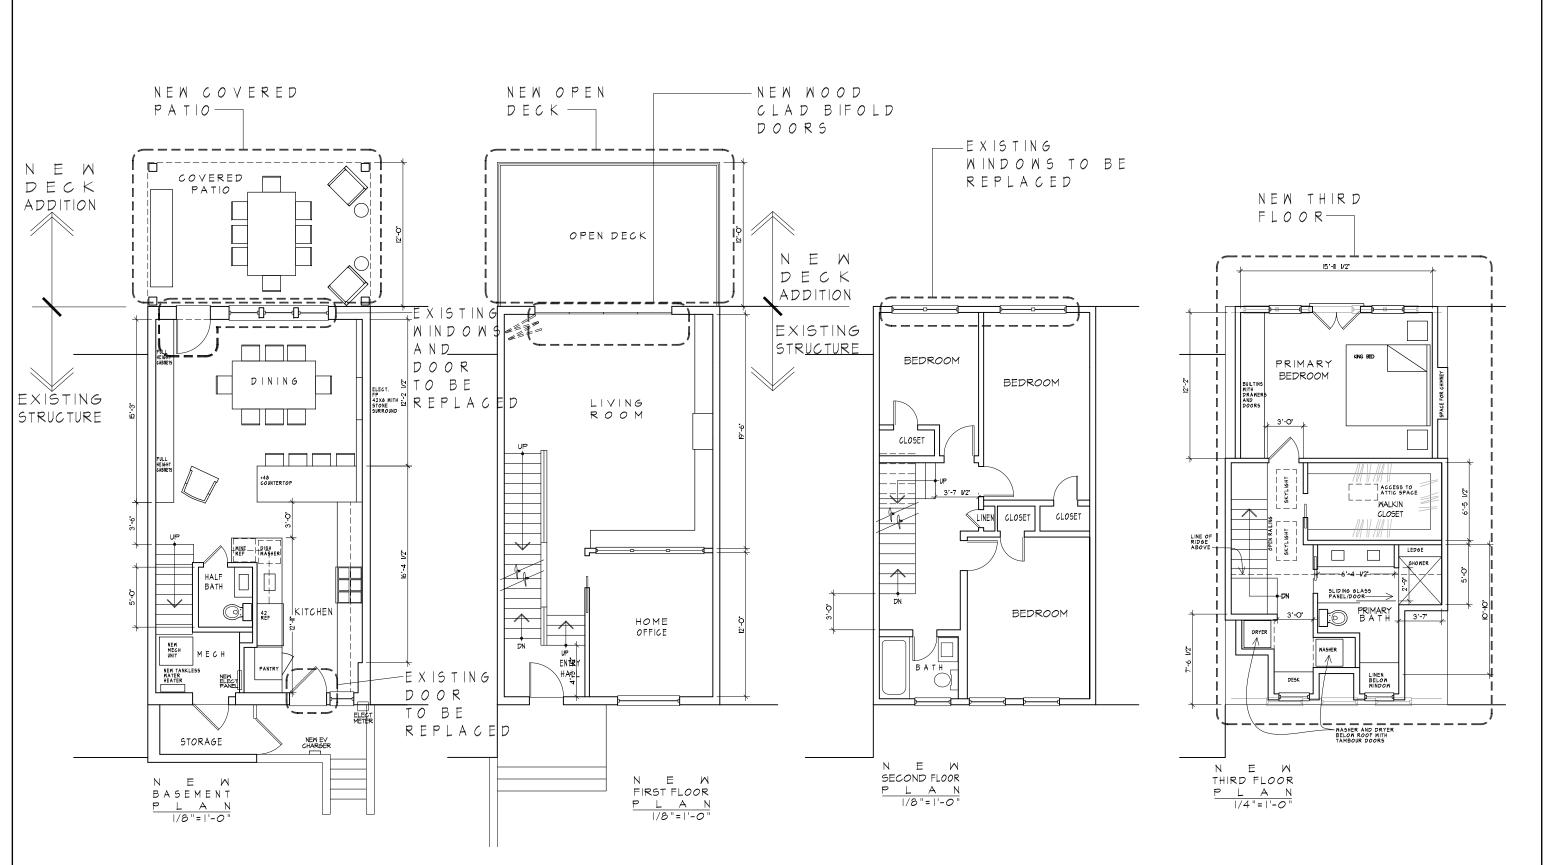

M MARKS-WOODS

CONSTRICTION SERVICES 드

Ŋ N A D E RESII STREE VIRGII 囝 H A O N O ᅜᆖᅩ

 \mathbf{R} ISSUE DATE DESIGN 09/07/23 11/03/23 11/08/23 12/05/23 06/12/25

Zo∀

- $^{\sim}$ \times $^{\circ}$ 8 $^{\circ}$ 8 $^{\circ}$ 1 $^{\circ}$ 1 $^{\circ}$ 1 $^{\circ}$ 1 $^{\circ}$ 2 $^{\circ}$ 3 $^{\circ}$


 $^{\circ}$ 0


BAR 12/27/23

07/21/25

SHEET TITLE N E W PLANS

SHEET NUMBER A-4

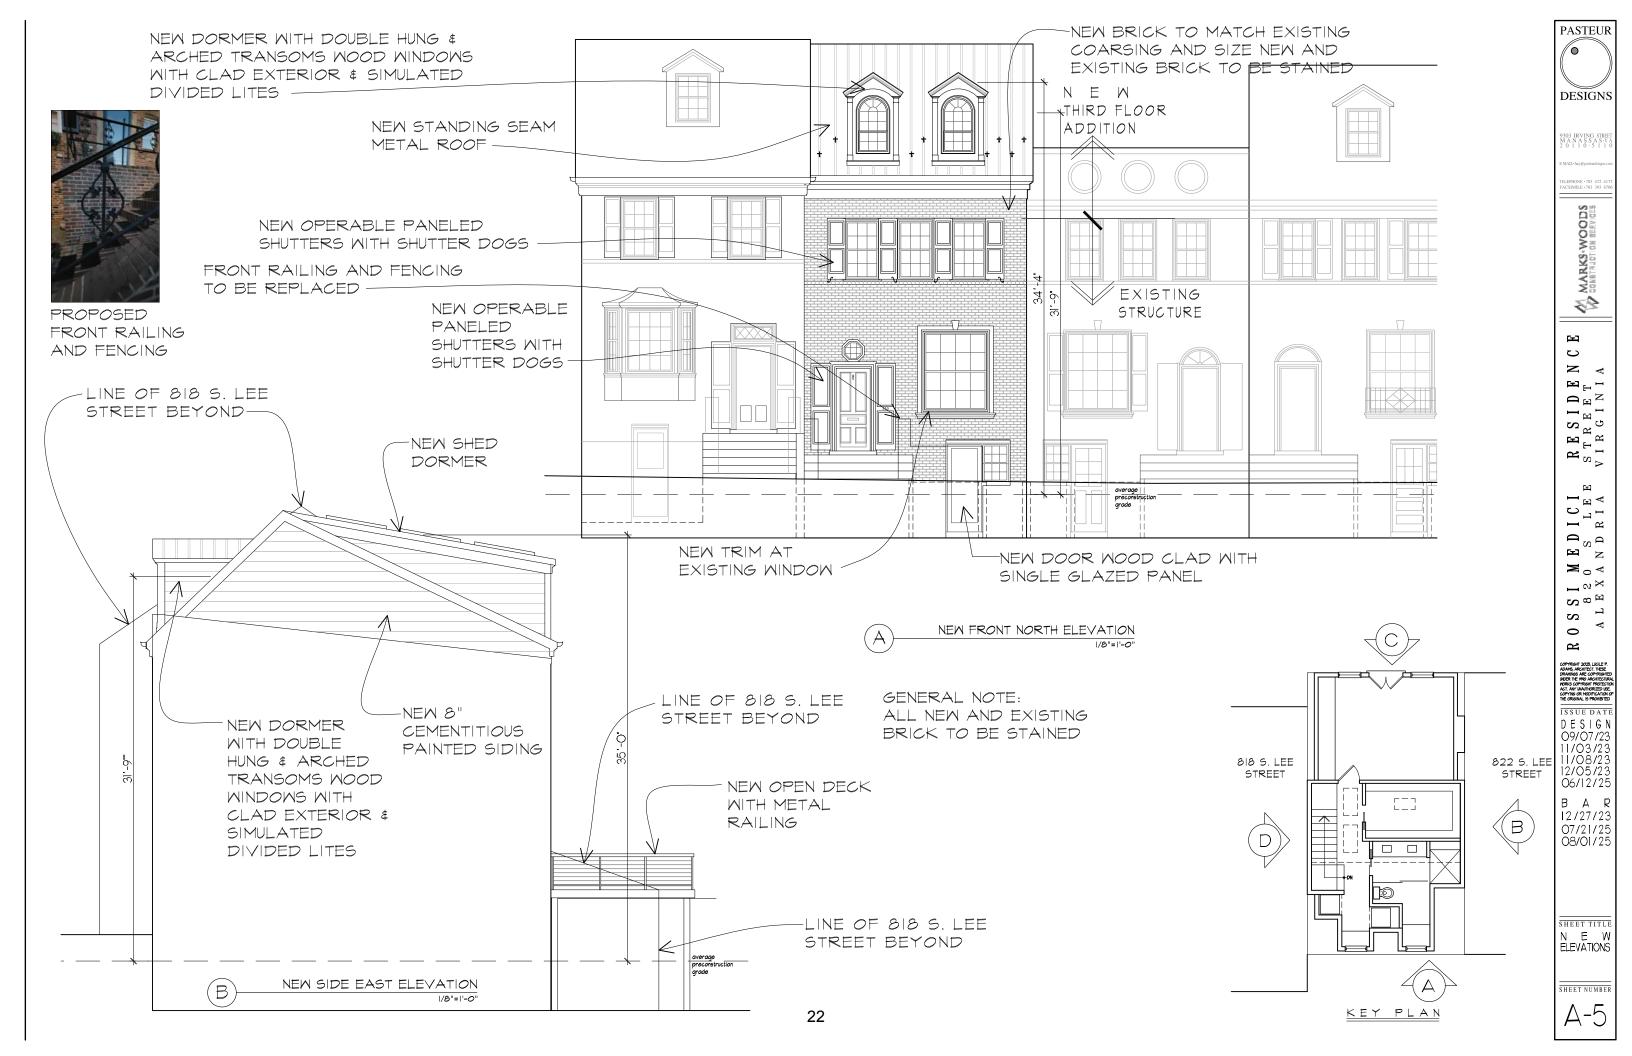

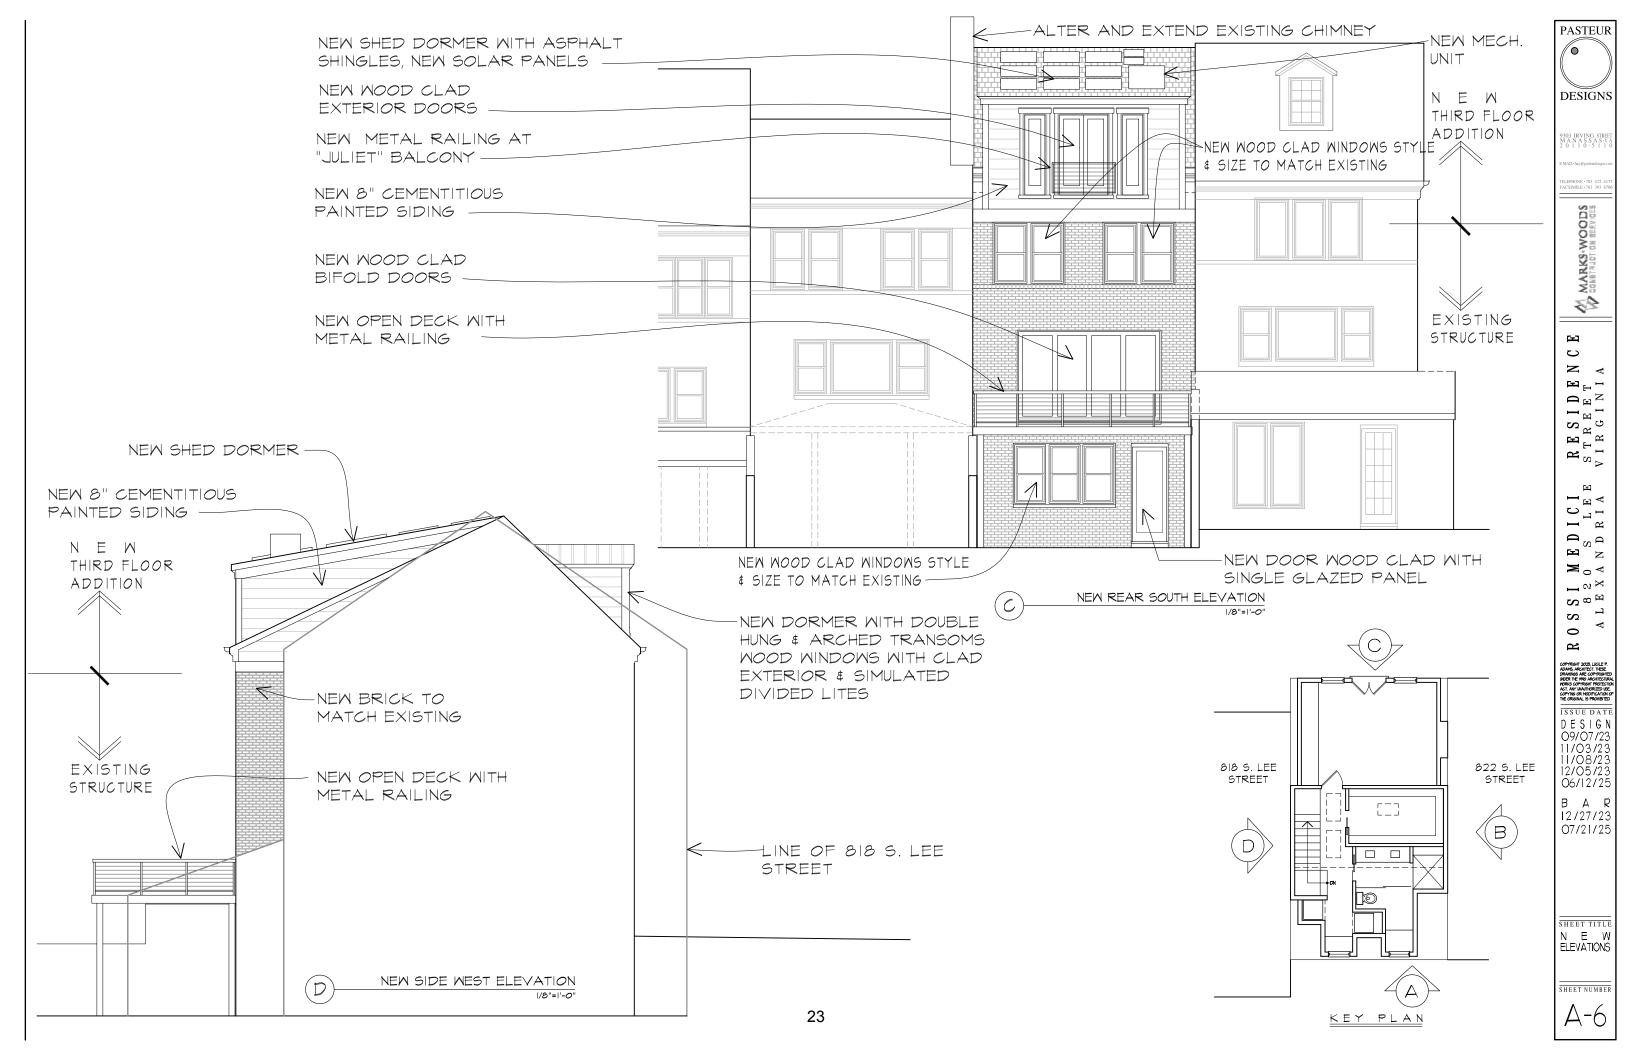




WEST ELEVATION FRONT 820 SOUTH LEE STREET



820 SOUTH LEE STREET

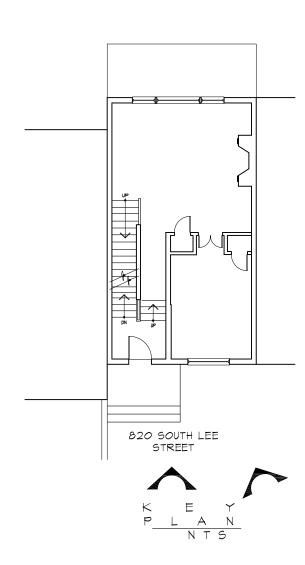

9303 IRVING STREI M A N A S S A S · V 2 0 1 1 0 · 5 1 1

MARKS-WOODS

CONSTRUCTION SERVICES

ഥ Ç RESIDEN (STREET VIRGINIA 囝 MEDICI OSLEE GANDRIA

 \mathbf{S} 0 R ISSUE DATE

- \approx $\mathbf{c}_{\mathbf{g}}$

D E S I G N O9/O7/23 II/O3/23 II/O8/23 I2/O5/23 O6/I2/25 B A R 12/27/23 07/21/25

SHEET TITLE PHOTOS

SHEET NUMBER A-7




REAR EAST ELEVATION 820 SOUTH LEE STREET



REAR EAST ELEVATION 818 SOUTH LEE STREET





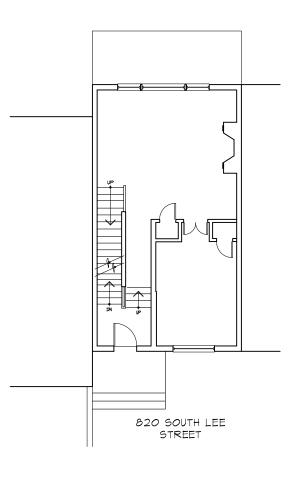



9303 IRVING STRE M A N A S S A S V 2 0 1 1 0 · 5 1 1

MARKS-WOODS
W CONSTRUCTION SERVICES 田

၁

RESIDEN (STREET 压 EDICI SLEI NDRIA

W 0 ♥ $rac{1}{2}$ $^{\infty}$ $^{\omega}$ $^{\Xi}$ \mathbf{S}

0 \mathbf{R} ISSUE DATE


D E S I G N O9/O7/23 11/O3/23 11/O8/23 12/O5/23 O6/12/25 B A R 12/27/23 07/21/25

SHEET TITLE PHOTOS


SHEET NUMBER 8-4



Architect Series® Reserve™

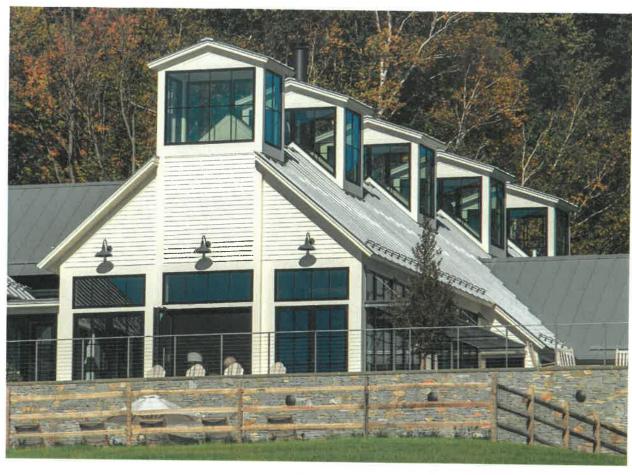

Photograph(s) © Scott Barrow Photography

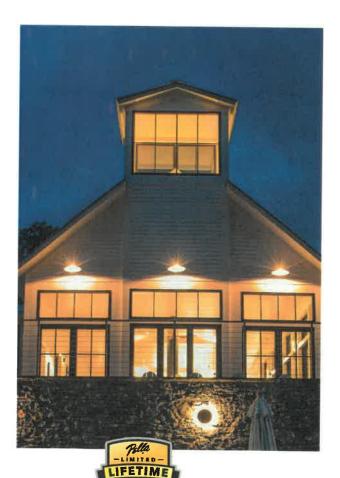

Authentically Detailed.

Meticulously designed to replicate the historical millwork process, Pella® Architect Series® Reserve™ offers unparalleled authenticity. Each piece is original, featuring excellent craftsmanship to reflect your project's unique personality and customized to fit your vision.

- A wide range of glazing options as well as HurricaneShield[®] impact-resistant.
- Divided light options available in Integral Light Technology^e grilles, grilles-between-the-glass or wood removable grilles in standard and custom patterns.
- Wide range of historically authentic features and attributes including butt joinery and through stiles
- Two exterior sash profiles are available: Ogee and Putty Glaze.
- Virtually unlimited exterior color options, EnduraClad® protective finish in 27 standard colors plus nearly unlimited custom colors and Anodized finishes.



Available with factory-installed integrated security sensors.

Wood Windows and Patio Doors

Grilles

For a full list of grille size and pattern availability contact your local Pella sales representative.


Integral Light Technology® Grilles

- Extruded aluminum or wood grilles are adhered to the exterior face
- Wood grilles are adhered to the interior face
- Between-the-glass foam spacers, which are aligned with the interior and exterior grilles, replicate the appearance of true divided lights
- Typical grilles are 7/8" wide putty glazed or ogee profile, other standard and custom widths are available
- Custom grille patterns are available



Grille Profile


Grille Profile

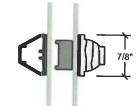

7/8", 1-1/4", and 2" widths

Roomside Removable Grilles

- Roomside wood grilles are securely attached to the interior, but can be removed for glass cleaning
- Typical grilles are 3/4" wide, other standard and custom widths and profiles are available

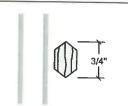

3/4", 1-1/4", and 2" widths

Grilles-Between-the-Glass

- Permanent aluminum grilles are factory-installed inside the airspace of insulating glass
- White, Tan2, Brown, Putty2, Black, Morning Sky Gray, Ivory, Sand Dune, Harvest, Cordovan or Brickstone interior.
- Grilles are 3/4" wide
- Interior colors complements today's most popular interior finishes; choose a color to coordinate with the window or door frame, or select a contrasting grille color for a one-of-a-kind look



Interior GBG Colors



Available Patterns

Traditional	9-Lite Prairie	Top Row	Cross	Custom Equally Divided	-
	%# ##	by.	98		Pattern availability may vary depending on size of unit. Custom configurations are also available, for details contact your local Pella sales representative.

1) Appearance of exterior grille color may vary depending on the Low-E insulating glass selection.

(2) Tan or Putty Interior GBG colors are available in single-tone (Tan/Tan or Putty/Putty).



Grilles 7/8" Integral Light Technology


Grilles 1-1/4" Integral Light Technology

Grilles 2" Integral Light Technology

SIMULATED-DIVIDED-LIGHT GRILLES

- Grilles are permanently bonded to the inside and outside of the glass
- No spacer between the grilles

BEST USE: When you want the traditional look of divided-light windowpanes.

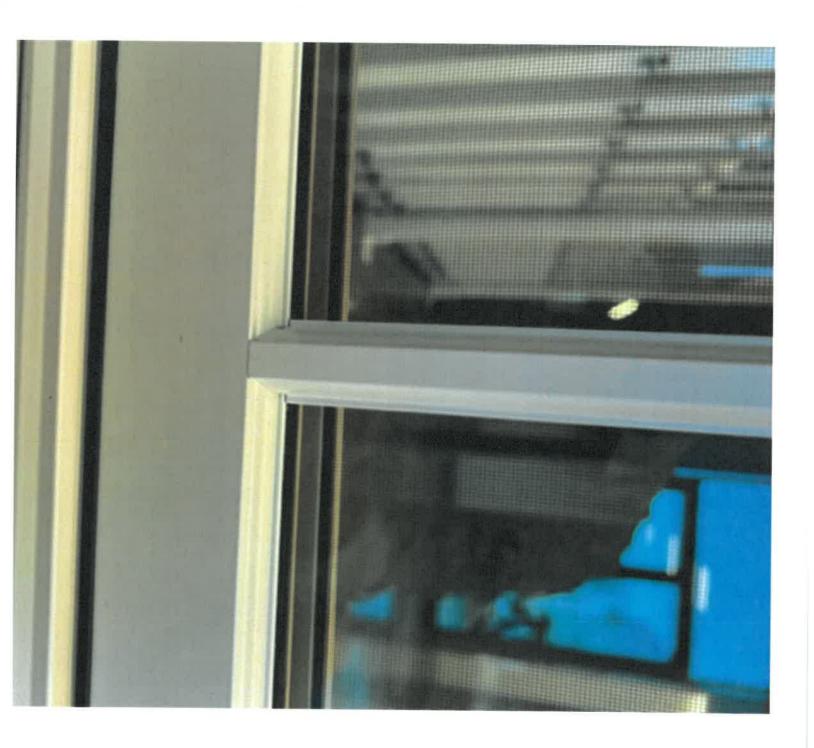


Total of




Side View

Interior

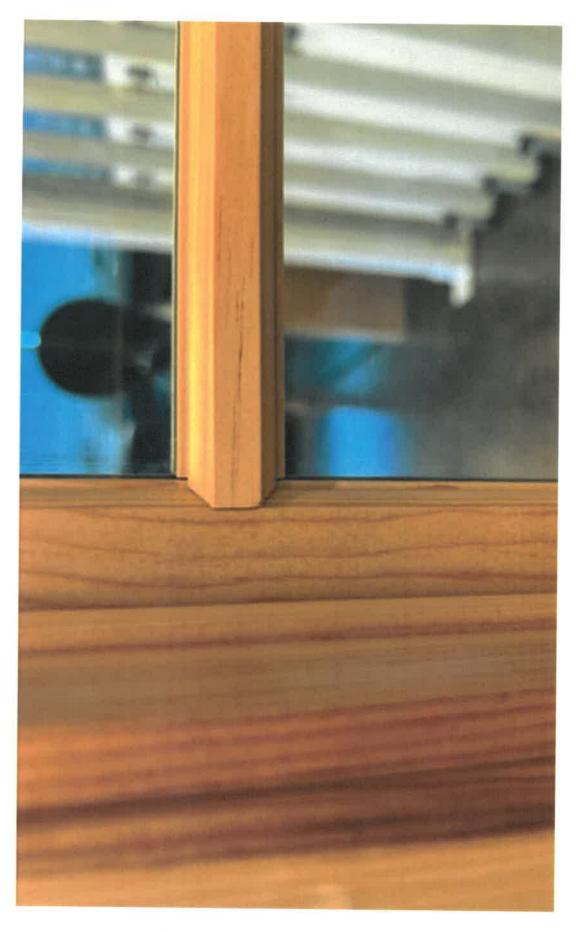

Finishes

EnduraClad® Protective Finish Standard Colors + Virtually Unlimited Custom Colors and Wood Options

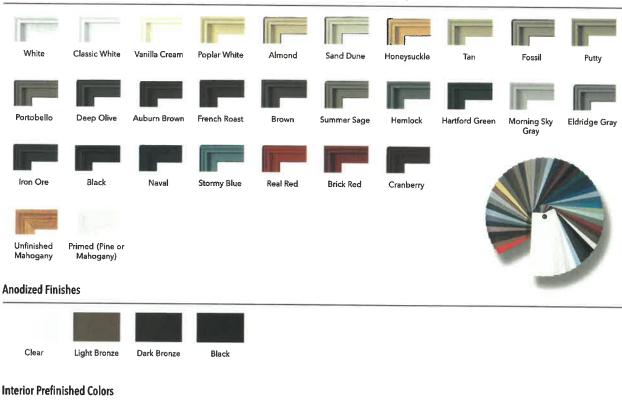



Screens



Vivid View® Screen

Provides the sharpest view and available as an upgrade on Pella wood windows and patio doors. Allows in 29% more light and is 21% more open to airflow compared to conventional screen. PVDF 21/17 mesh, 78% light transmissive.

InView™ Screen

Standard screen on Pella wood windows and patio doors, as well as Rolscreen* retractable screens on wood casement windows and Integrated Rolscreen* on Architect Series* Reserve™ single- and double-hung

More transparent than conventional fiberglass, allows 14% more light and is 8% more open to airflow than conventional screen.

Vinyl coated 18/18 mesh fiberglass, Complies with performance requirements of SMA 1201.

Conventional Screen

Standard on Rolscreen* retractable screens on patio doors.

Black vinyl coated 18/14 mesh fiberglass, Complies with ASTM D 3656 and SMA 1201.

Improved airflow is based on calculated screen cloth openness. Screen cloth transmittance was measured using an integrated sphere spectrophotometer.

Because of printing and display limitations, actual colors may vary from those shown.

Hardware

Consult your local Pella Sales Representative for a full list of available hardware options.

Rustic Collection





Hinged Patio Door Bifold Door,



Sliding Patio Door, Multi-slide Door,

Finishes







Distressed Bronze

Classic Collection



Casement/Awning Window



Double-Hung

Window

Double-Hung Window



Hinged Patio Door Bifold Door,



Sliding Patio Door Multi-slide Door₂

Finishes



Antique Brass





Bright Brass



Satin Nickel



Oil-Rubbed Bronze

Matte Black

Essential Collection



Casement/Awning Window



Double-Hung Window



Hinged Patio Door Bifold Door,



Sliding Patio Door

Finishes



White



Champagne





Satin Nickel Oil-Rubbed

Bronze

Finishes



Multi-slide Door



Bright Brass

Bright Brass

White



Brown

Satin Nickel






Oil-Rubbed

Bronze

Polished


Custom Capabilities

Consult your local Pella Sales Representative for available options.

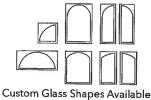





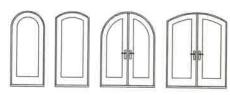

Custom Door Shapes Available





PRODUCTS

CONTACT US



Order Sample

- · See Full Base Colour Chart
- ► See Full Design Colour Chart

1020 SiLazur

Semi-Transparent Mineral Stain

1020 SiLazur is a highly durable, semi-transparent mineral stain for interior and exterior use. It is designed to appear completely natural on the surface and can be diluted to any degree with 1050 PrimaSil in order to increase transparency and allow variation to show in the finish.

PRODUCT INFO:

- · Semi-transparent silicate dispersion stain for interior or exterior use
- For use on absorbent mineral based surfaces such as brick, stone, concrete, block, mortar
 joints and other masonry substrates
- Can be diluted to any degree with 1050 PrimaSil to increase transparency and allow variation to show in the finish promoting a natural appearance
- · Available in over 150 standard colors custom color matching available
- Dry to touch in approx. 2 hours, wait a minimum of 12 hours before re-coating although 24 hours is ideal
- Covers approx. 200 240 sq ft per gallon (varies on surface absorbency)
- · Fully breathable, anti-microbial, mildew resistant
- . 100% Non-Hazardous, allow to dry out and dispose of with regular garbage
- · Non-Flammable, 0 VOC
- . Non-Film forming, bonds by chemical reaction on the inside of the substrate
- · Will never blister or peel
- · Apply with brush, roller or sprayer (back roll if spraying)
- · Apply an even coat and allow to absorb into surface soak up excess
- · Wash tools with water
- · Minimum application temperature is 5 C or 40 F and above
- 10 year product replacement warranty 30-40 year lifespan









PERMAINT®

Order Sample

- See Full Base Color Chart
- See Full Design Color Chart

1010 QuartzGuard

Opaque Mineral Stain

1010 QuartzGuard is a highly durable, opaque mineral paint for interior and exterior use. 1010 QuartzGuard is designed to produce a completely uniform finish and hide background variation. It is highly effective at blending out previous repairs/discolorations/stains and producing a clean, uniform result. It can be diluted up to a maximum of 20% with 1050 PrimaSil in order to increase fluidity if desired.


PRODUCT INFO:

- Opaque silicate dispersion stain for interior or exterior use
- For use on absorbent mineral based surfaces such as brick, stone, concrete, block, mortar joints and other masonry substrates
- Excellent hiding capabilities produces a completely uniform finish
- Can be diluted up to 20% with 1050 PrimaSil to lower viscosity
- · Available in over 150 standard colors custom color matching available
- Dry to touch in approx. 2 hours, wait a minimum of 12 hours before re-coating although 24 hours is ideal
- Covers approx. 300 sq ft per gallon (varies on surface absorbency)
- Fully breathable, anti-microbial, mildew resistant
- 100% Non-Hazardous, allow to dry out and dispose of with regular garbage
- Non-Flammable, 0 VOC
- · Non-Film forming, bonds by chemical reaction on the inside of the substrate
- Will never blister or peel
- . Apply with brush, roller or sprayer (back roll if spraying) dilute 20% with 1050 PrimaSil if
- Apply an even coat and allow to absorb into surface soak up excess
- Wash tools with water
- Minimum application temperature is 5 C or 40 F and above
- 10 year product replacement warranty 30-40 year lifespan





BASE COLORS

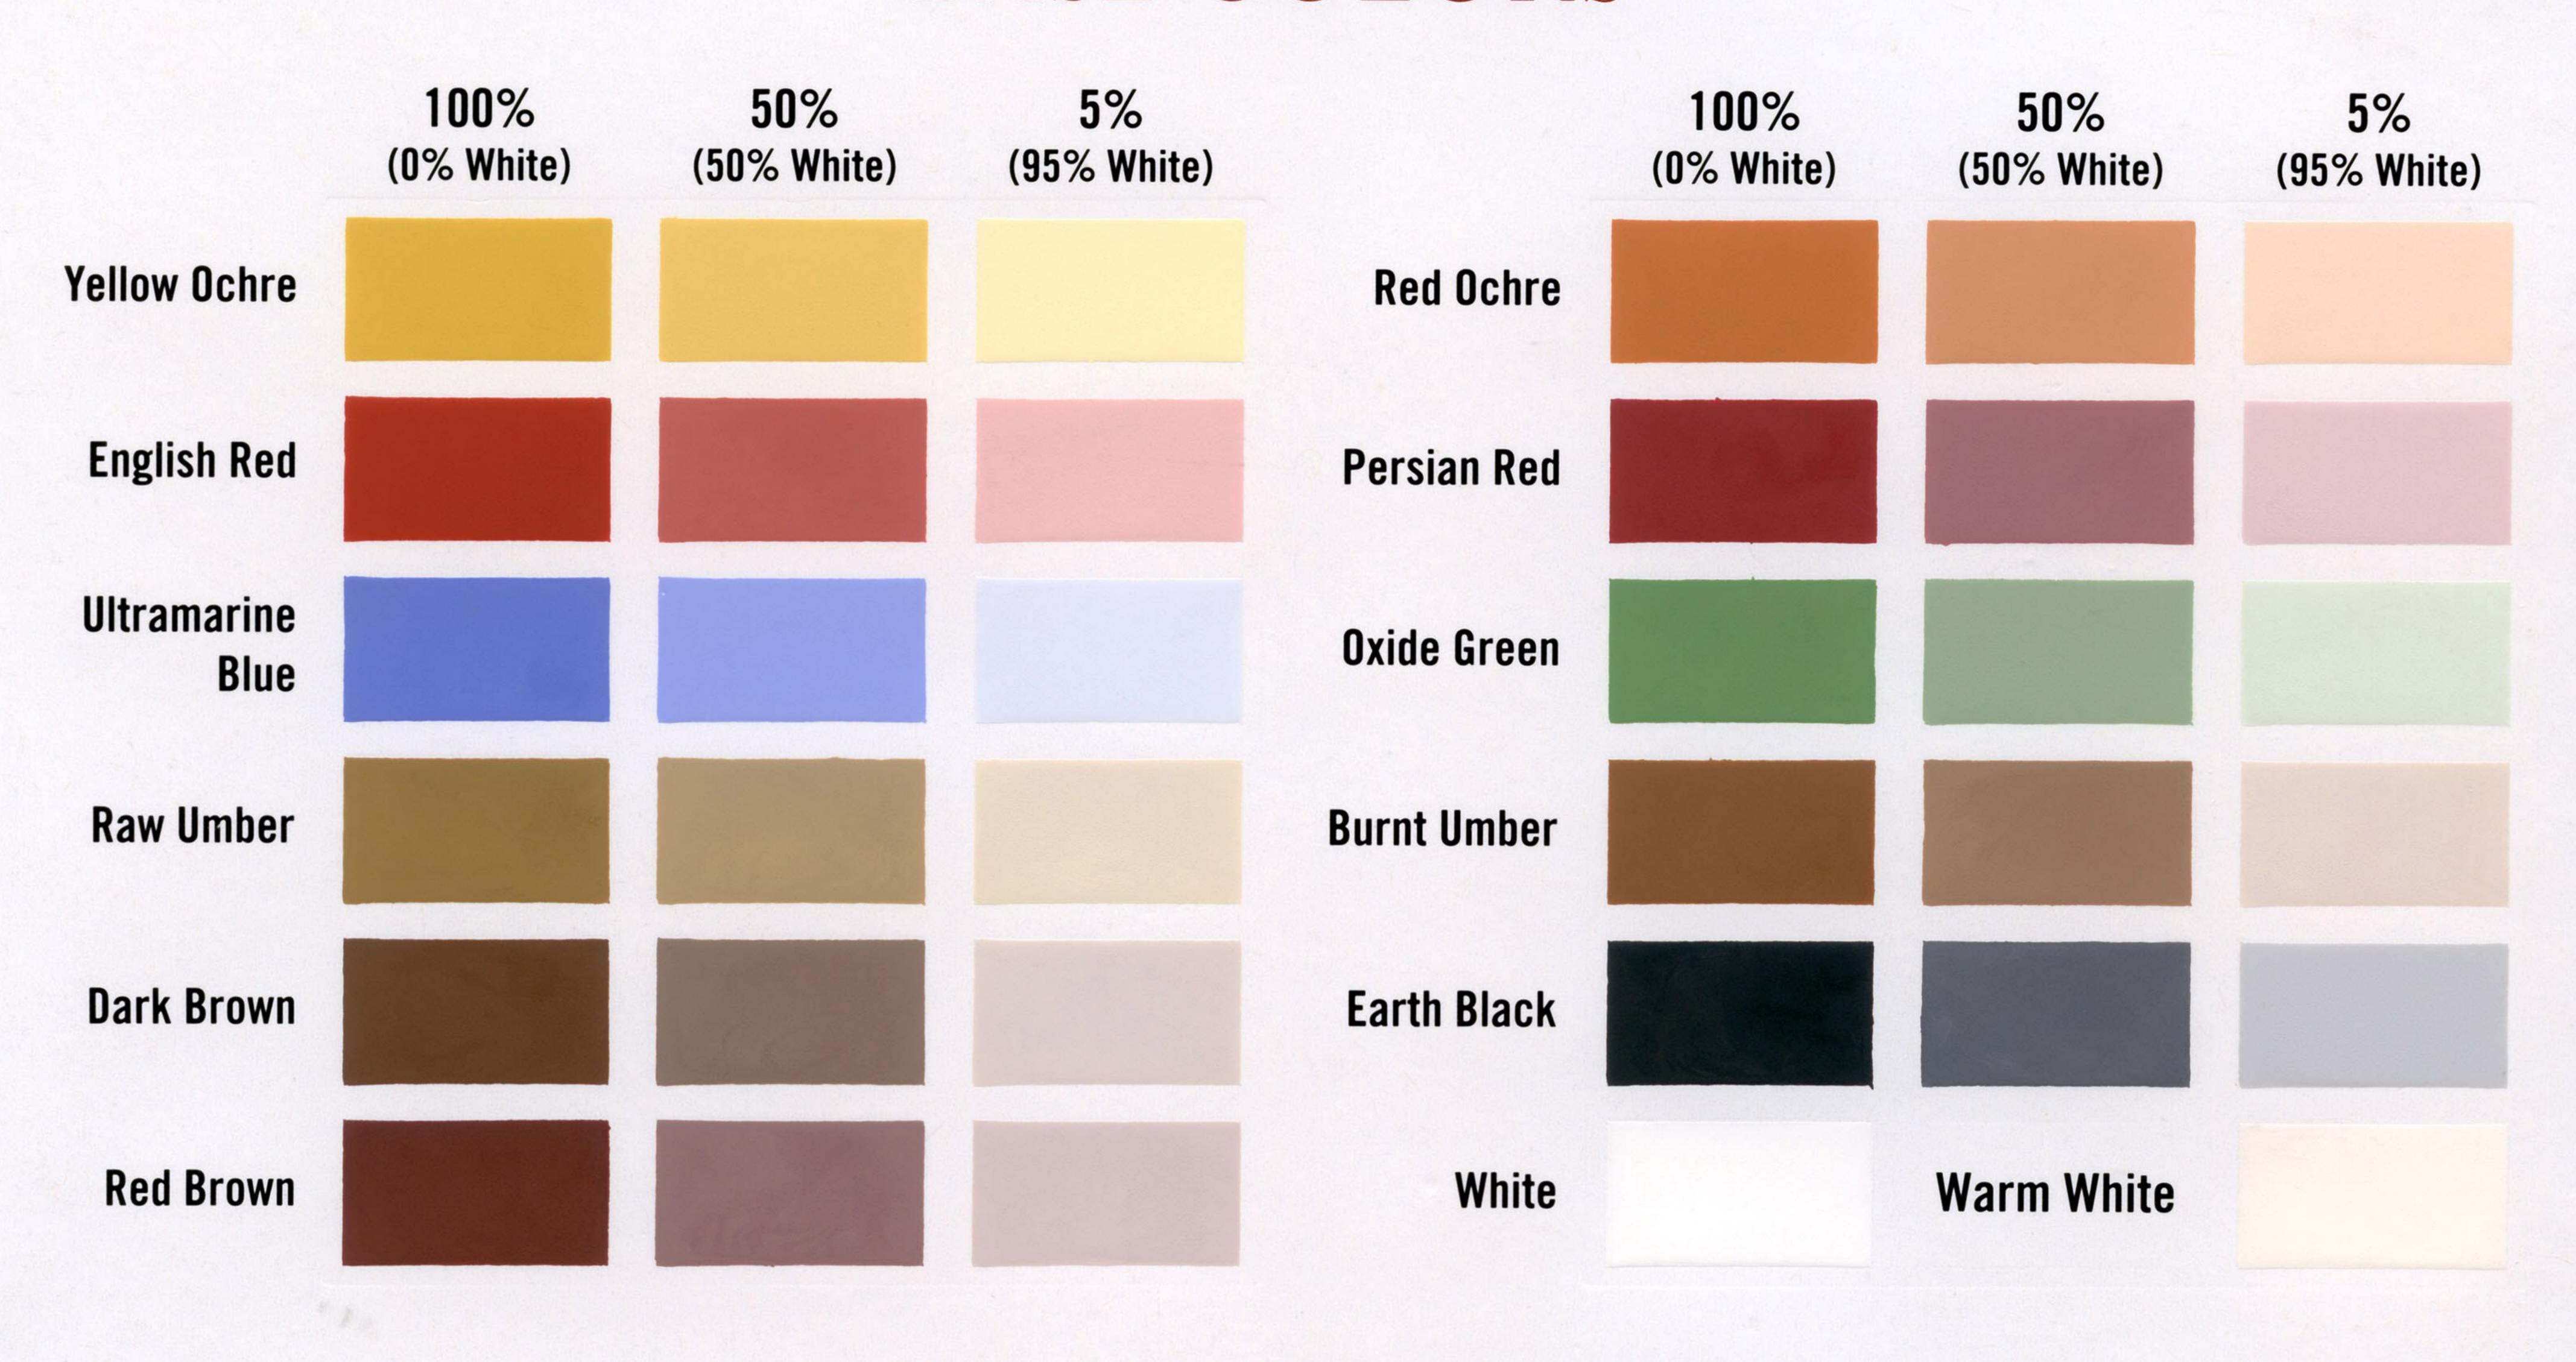

DESIGNER COLORS

BRICK STAIN

PT 5000	PT 5005	PT 5010	PT 5015	PT 5020	PT 5025	PT 5030	PT 5035
Coin Grey	Mysterious Sea	Twilight Blue	Lucky Clover	Sunrise	Autumn Gold	Red Grapefruit	Robin Red
PT 5001	PT 5006	PT 5011	PT 5016	PT 5021	PT 5026	PT 5031	PT 5036
Crystal Moon	Maya Blue	Benjamin Blue	Pacific Green	May Flowers	Flame	Rose	Remington
PT 5002	PT 5007	PT 5012	PT 5017	PT 5022	PT 5027	PT 5032	PT 5037
Enchantment	Slate Grey	Sea Breeze	Wilderness	Canary Yellow	Harvest Red	Marigold Red	Rust Red
PT 5003	PT 5008	PT 5013	PT 5018	PT 5023	PT 5028	PT 5033	PT 5038
Lilac Purple	Midnight Sky	Tea Leaf	Earth Green	Peach Yellow	Poppy	Cardinal Red	Crimson
PT 5004	PT 5009	PT 5014	PT 5019	PT 5024	PT 5029	PT 5034	PT 5039
Blue Jay	Deep Blue	Mint Green	Black Bark	Creamsicle	Ancient Artifact	Firebrick	Rhode Island Red

Custom color matching available on request to any manufacturer's samples.

*Due to limitations in color reproduction and print process, color swatches may vary from the actual product.





Phone: 540-437-2324 Fax: 540-437-9399 www.marcometals.com








VINYL SHUTTERS COMPOSITE WOOD SHUTTERS ALUMINUM HARDWARE VENTS CUPOLAS HOME

Home / Wood Shutters / PlacerCraft Wood Shutters / PlacerCraf...

Photo is a stock image and will not represent the options you choose.

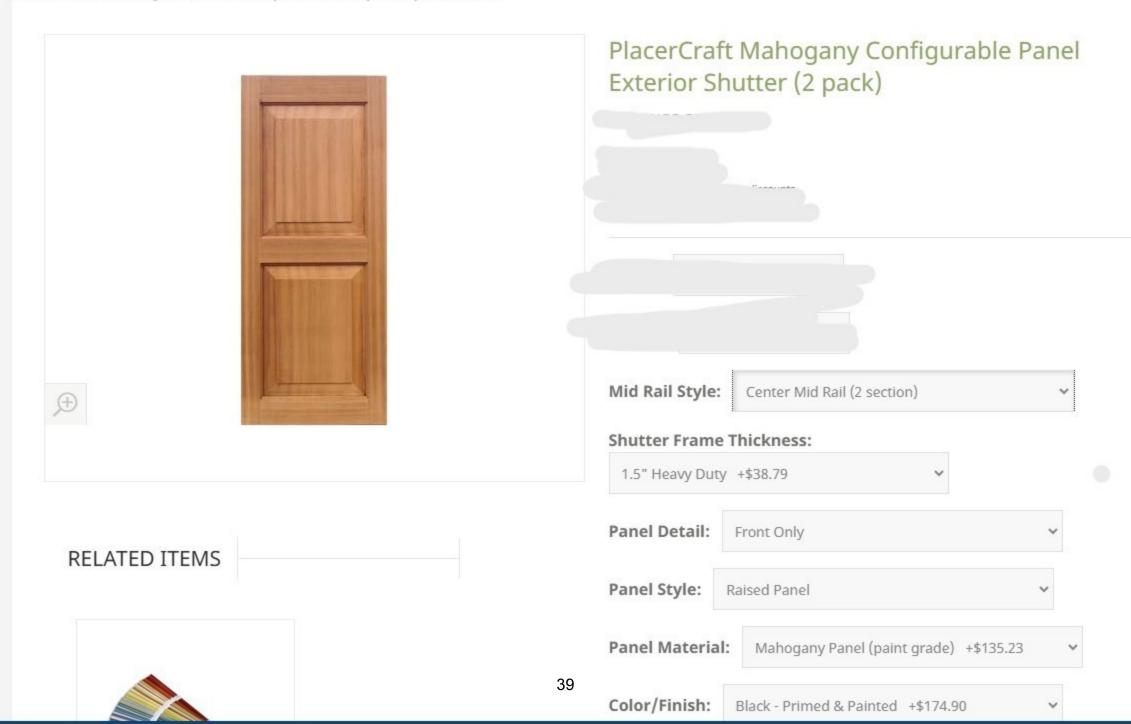

Before adding the paint color, your PlacerCraft wood shutters will be primed with acrylic primer/sealer. The Rockbridge Composite Shutters are primed with oil-based primer. The finish coats are in a satin sheen. The top coat paint colors for feature water-borne acrylic.

<Back To Previous Page

Chack to Frevious ray

