

## **APPLICATION**

G. ATTOMATION OF		Amendment I		
PROPERTY LOCATIO	N: 598 S. Alf	red Street		
APPLICANT			<del></del>	
Name:	Alfred Stree	t Baptist Churc	h and The Comm	nunity Builders, Inc.
Address:				
PROPERTY OWNER:		,		
Name:	Olde Town	West Propertie	es	
Address:				
Interest in property	- /	OCantract Dura	hanar	
	<b>⊘</b> Owner	OContract Purc	naser	
	Developer	OLessee	Oother_	
	s some form of	compensation, do		ch as an attorney, a realtor, or other ousiness in which they are employed
	Yes: If yes,	provide proof of o	urrent City business	license.
	ONo: If no, s	aid agent shall ob	tain a business licen	se prior to filing application.
	301B of the Zon	ing Ordinance, he	reby grants permissi	ation is complete and accurate, and, on to the City of Alexandria, Virginia,
Mary Catherine Gib		LLP_	Mary &	thered Ill
Mailing/Street Address		<del></del>	Telephone #	 Fax#

DO NOT WRITE IN	THIS SPACE - OFFICE USE ONLY
Application Received:  Legal advertisement:	Fee Paid: \$
ACTION - PLANNING COMMISSION	ACTION - CITY COUNCIL:

Zip Code

City and State

MPA#	
REZ#	 

### **SUBJECT PROPERTY**

Provide the following information for each property for which an amendment is being requested. (Attach separate sheets if needed.)

Address Tax Map - Block - Lot	Land Use Existing - Proposed	Master Plan Designation Existing - Proposed	Zoning Designation Existing - Proposed	Frontage (ft.)  Land Area (acres)
1 074.03-05-05	Res M Res M	Res. Res.	RB RMF	1.29 acres
2				
3				
4				

## **PROPERTY OWNERSHIP**

[] Individual Owner

Identify	each person or individual with ownership interest. If corporation or partnership	ership owner, identify each person with
more th	nan 3% interest in such corporation or partnership.	
1.	Name: Olde Town West Properties, LLC	Extent of Interest: 100%
	Address:	
2.	Name:	Extent of Interest:
	Address:	
3.	Name:	Extent of Interest:
	Address:	
4.	Name:	Extent of Interest:
	Address:	

[/] Corporation or Partnership Owner

MPA#	 	 
REZ#	 	 

#### JUSTIFICATION FOR AMENDMENT

(attach separate sheets if needed)

- Explain how and why any proposed amendment(s) to the Master Plan are desirable, beneficial to surrounding properties, in character with the applicable Small Area Plan and consistent with City policies:
  NA
- 2. Explain how and why the proposed amendment to the Zoning Map(s) is consistent with the proposed amendment to the Master Plan, or, if no amendment to the Master Plan is being requested, how the proposed zoning map amendment is consistent with the existing Master Plan:

The zoning amendment is desirable to achieve the South Patrick Street Housing Affordability Strategy as well as the City's Housing Master Plan Goals by increasing affordable home opportunities for residents with low and moderate incomes. Particularly, the project furthers the City's goal of creating "economic diversity among city residents resulting in strong, resilineighborhoods" as well as "ultimately allowing for Alexandria residents to remain in the City and Alexandria workers to live the jurisdiction where they work." The surrounding neighborhood is residential, in different levels, single family and multifamily. There is also the Alfred Street Baptist Church across the street and one block east of the site.

- Explain how the property proposed for reclassification will be served adequately by essential public facilities and services such as highways, streets, parking spaces, police and fire, drainage structures, refuse disposal, water and sewers, and schools.
  - The property will be adequately served by essential public facilities and services. Significant public facilities and services are in close proximity to the site including an elementary school to the east across Washington Street, as well as access to S. Patrick Street one block away, a main arterial road in the City with direct access to I495 within a few blocks.
- 4. If this application is for conditional zoning approval pursuant to Section 11-804 of the Zoning Ordinance, identify all proffered conditions that are to be considered part of this application (see Zoning Ordinance Section 11-804 for restrictions on conditional zoning):

NA

## **APPLICATION**



# DEVELOPMENT SPECIAL USE PERMIT with SITE PLAN

DSUP #DSUP #2025-10022 Project Name: Old Town West Affordable Housing Redevelopment

PROPERTY LO	CATION:	598 S. Alfred Stre	eet	
TAX MAP REF	ERENCE:	074.03-05-05		ZONE: RB, Rezoning Proposed to RMF
APPLICANT:				
Name:	Alfred Stre	eet Baptist Church	and The Commu	nity Builders, Inc.
Address:				
PROPERTY O	WNER:			
Name:	Olde Tow	n West Properties	6	- Marie - Mari
Address:				
summary of new 145 unit	PROPOSA affordabl	AL Request to redee housing building	evelop 34 current a under the propos	affordable housing units into a ed RMF zone.
MODIFICATIO				
SUP's REQUE	STED SUF	o to increase FAR fr	rom .75 to 2.16 for th	ne provision of providing at least
1/3 of the inc	rease in ι	units affordable to	those making 40%	of the AMI (on average).
THE UN with the provisions	IDERSIGNE s of Section 11	<b>D</b> hereby applies for Deve 1-400 of the Zoning Ordina	elopment Site Plan with Sp ance of the City of Alexand	ecial Use Permit approval in accordance Iria, Virginia.
Alexandria to post	placard notic	D, having obtained permine te on the property for whic ce of the City of Alexandria	th this application is reques	rner, hereby grants permission to the City of sted, pursuant to Article XI, Section 11-301
THE UN drawings, etc., req	IDERSIGNE quired of the a	D also attests that all of topplicant are true, correct a	the information herein prov and accurate to the best of	vided and specifically including all surveys, inis/her knowledge and belief.
		, Wire Gill, LLP	Signature /	thrul GUJ
Print Name of Appli	icant or Agent		Signature //	•
Mailing/Street Addr	ess		Telephone #	Fax#
City and State		Zip Code	Email address	
			Date	
		DO NOT WRITE IN T	THIS SPACE - OFFICE U	SE ONLY
				Completeness:
Fee Paid and Dat	te:		Received Plans for	Preliminary:
		SION:		
ACTION - CITY C	COUNCIL:			

## ALL APPLICANTS MUST COMPLETE THIS FORM.

Supplemental forms are required for child care facilities, restaurants, automobile oriented uses and freestanding signs requiring special use permit approval.

1.	The applicant	t is: (check one)		
	The Owner	O Contract Purchaser	OLessee or	Other: Co Developers of
	the subject prop	perty.		

State the name, address and percent of ownership of any person or entity owning an interest in the applicant, unless the entity is a corporation or partnership in which case identify each owner of more than three percent.

Alfred Street Baptist Church and The Community Builders, Inc., are both non-stock corporations with no owners (501C(3)).

If property owner or applicant is being represented by an authorized agent, such as an attorney, realtor, or other person for which there is some form of compensation, does this agent or the business in which the agent is employed have a business license to operate in the City of Alexandria, Virginia?

- **Yes.** Provide proof of current City business license. No. The agent shall obtain a business license prior to filing application, if required by the City
  - Code.

## OWNERSHIP AND DISCLOSURE STATEMENT

Use additional sheets if necessary

1. Applicant. State the name, address and percent of ownership of any person or entity owning an interest in the applicant, unless the entity is a corporation or partnership, in which case identify each owner of more than three percent. The term ownership interest shall include any legal or equitable interest held at the time of the application in the real property which is the subject of the application.

Name	Address	Percent of Ownership
<sup>1.</sup> Alfred Street Baptist Churc		100%
The Community Builders, I		100%
3.		

2. Property. State the name, address and percent of ownership of any person or entity owning an interest in the property located at 598 S. Alfred Street (address), unless the entity is a corporation or partnership, in which case identify each owner of more than three percent. The term ownership interest shall include any legal or equitable interest held at the time of the application in the real property which is the subject of the application.

100%

3. BusinessorFinancialRelationships. Each person or entity listed above (1 and 2), with an ownership interest in the applicant or in the subject property is required to disclose any business or financial relationship, as defined by Section 11-350 of the Zoning Ordinance, existing at the time of this application, or within the12-month period prior to the submission of this application with any member of the Alexandria City Council, Planning Commission, Board of Zoning Appeals or either Boards of Architectural Review.

Name of person or entity	Relationship as defined by Section 11-350 of the Zoning Ordinance	Member of the Approving Body (i.e. City Council, Planning Commission, etc.)
1. Alfred Street Baptist Church	None	None
<sup>2.</sup> The Community Builders, Ir	None	None
3. Olde Town West Properties	None	None

NOTE: Business or financial relationships of the type described in Sec. 11-350 that arise after the filing of this application and before each public hearing must be disclosed prior to the public hearings.

As the applicant or the applicant's authorized agent, I hereby attest to the best of my				
ability that the	information provided above	e is true and correct.		
alintar		Mary Lattetuer SIN		
11111111	Mary Catherine Gibbs	11/10 My arabet Unc		
Date	Printed Name	J// Signature		

6

**2. Narrative description.** The applicant shall describe below the nature of the request **in detail** so that the Planning Commission and City Council can understand the nature of the operation and the use, including such items as the nature of the activity, the number and type of patrons, the number of employees, the hours, how parking is to be provided for employees and patrons, and whether the use will generate any noise. If not appropriate to the request, delete pages 6-9. (Attach additional sheets if necessary.)

The Alfred Street Baptist Church (ASBC) and their co-developer, The Community Builders, Inc., (TCB) are seeking to expand the number of affordable housing units in the Olde Town West neighborhood where the ASBC is located. ASBC purchased the 77 unit Olde Town West properties in 2009. Old Town West Properties, LLC and the ASBC own 77 units in the Old Town West project developed as part of the DIP Urban Renewal project in the 1970's. The Old Town West project encompasses three separate parcels:

- 1) 901 Wolfe Street (22 units),
- 2) 598 S. Alfred St. (34 units (including 2 units for office use) and
- 3) 601 S. Alfred Street (19 units).

TCB, as ASBC's development partner, plans to redevelop the 34 units that are located at 598 S. Alfred St. into a 145 unit multi-family building for residents making 30-60% of the Average Median Income (AMI). Subsequent phases of the redevelopment will be forthcoming for the units at 601 S. Alfred Street and those plans will be processed for that redevelopment at a later date.

As part of the proposal, TCB is seeking a rezoning to the RMF (Residential Multi-Family) zone, in keeping with the South Patrick Street Housing Affordability Strategy, and is seeking a Development Special Use Permit (DSUP) to increase the density from .75 FAR to 2.16 FAR and will provide all units as committed affordable units at varying levels of affordability. The Applicant is proposing to provide 111 units affordable up to 60% of AMI and 34 units affordable up to 30% of AMI. The units available at 30% AMI have an estimated average net square footage of 900 square feet, for a total of 45,000 square feet, well over the 1/3 of the increase in density that is required by the RMF zone to be affordable on average to those households at 40% of AMI.

Development	SUP #	DSUP	#2025-1	0022

3.		ons, clients, pupil (i.e., day, hour, or sh		h users do you expect	?
	Typical for a resid	lential developmen	t of this size.		
4.	Specify time period	oyees, staff and (i.e. day, hour, or sh employees, 8:30 a.r	ift).		
5.	Describe the prop	osed hours and day	s of operation of	the proposed use:	
	Day Sun Sat.	Hours 24 hours	Day 	Hours	
6.	Describe any po	otential noise em	anating from th	e proposed use:	
		e noise levels anticip m a residential deve		anical equipment and patro ize.	ns.
	The enclosed co	e noise from patrons urtyard will keep so her noise from peo	me of the noise of	enerated by the residents oing into the buidling will	s within be
7.	<b>Describe any po control them:</b> NA.	otential odors em	anating from th	e proposed use and pl	ans to

D.	Provide information regarding trasmand litter generated by the above
	A. What type of trash and garbage will be generated by the use?  Typical type from a residential project of this size.
	B. How much trash and garbage will be generated by the use?  Typical amount from a residential project of this size.
	C. How often will trash be collected?  At least once week and more as needed.
	D. How will you prevent littering on the property, streets and nearby properties?  The project will have an on-site property management company that will work to ensure the site is property maintained.
9.	Will any hazardous materials, as defined by the state or federal government be handled, stored, or generated on the property?
	Yes. V No.
	If yes, provide the name, monthly quantity, and specific disposal method below:
10.	Will any organic compounds (for example: paint, ink, lacquer thinner, or cleaning or degreasing solvent) be handled, stored, or generated on the property?
	Yes. No.
	If yes, provide the name, monthly quantity, and specific disposal method below:  Paint or cleaning solvents to ensure proper upkeep of the project and during turnovers in the units.

Development	SUP	#	DSUP #2025-10022

11.	What methods are	proposed to	o ensure	the	safety	of	residents,	employees
	and patrons?							

The building will be access controlled by keyfob or other technology.

### **ALCOHOL SALES**

12.	Will the proposed use	include	the sale of	beer,	wine	or mixed	drinks?
E MIN 19	Till the proposed ass						

Yes. V No.

If yes, describe alcohol sales below, including if the ABC license will include on-premises and/ or off-premises sales. Existing uses must describe their existing alcohol sales and/or service and identify any proposed changes in that aspect of the operation.

## **PARKING AND ACCESS REQUIREMENTS**

## 13. Provide information regarding the availability of off-street parking:

A. How many parking spaces are required for the proposed use pursuant to section
 8-200 (A) of the zoning ordinance?
 8 spaces

B. How many parking spaces of each type are provided for the proposed use:

73 Standard spaces
17 Compact spaces
4 Handicapped accessible spaces
Other

**Development SUP #** DSUP #2025-10022

C.	Where is required parking located? (check one) on-site off-site
	If the required parking will be located off-site, where will it be located?

Pursuant to section 8-200 (C) of the zoning ordinance, commercial and industrial uses may provide off-site parking within 500 feet of the proposed use, provided that the off-site parking is located on land zoned for commercial or industrial uses. All other uses must provide parking on-site, except that off-street parking may be provided within 300 feet of the use with a special use permit.

D. If a reduction in the required parking is requested, pursuant to section 8-100 (A) (4) or (5) of the zoning ordinance, complete the **Parking Reduction Supplemental**Application.

## 14. Provide information regarding loading and unloading facilities for the use:

- A. How many loading spaces are required for the use, per section 8-200 (B) of the zoning ordinance? 0
- B. How many loading spaces are available for the use? 1
- C. Where are off-street loading facilities located? Off of S. Alfred St.
- D. During what hours of the day do you expect loading/unloading operations to occur? Typical hours for residential move ins and move outs.
- E. How frequently are loading/unloading operations expected to occur, per day or per week, as appropriate?

The number of residential move ins and move outs will change over time so this is difficult to estimate.

15. Is street access to the subject property adequate or are any street improvements, such as a new turning lane, necessary to minimize impacts on traffic flow?

Street access is adequate.

# PRELIMINARY DEVELOPMENT SPECIAL USE PERMIT OLDE TOWNE WEST AFFORDABLE HOUSING DEVELOPMENT ALEXANDRIA, VIRGINIA

#### 598 SOUTH ALFRED STREET

#### NARRATIVE DESCRIPTION OF DEVELOPMENT


THE APPLICANT PROPOSES DEMOLISHING THE EXISTING TOWNHOUSES TO BUILD A MULTIFFAMILY DEVELOPMENT WITH 145 AFFORDABLE HOUSING UNITS WITH ONE LEVEL OF BELOW GRADE PARKING.

SITE ACCESS: THE PRIMARY ACCESS TO THE SITE WILL BE FROM SOUTH ALFRED STREET

#### SPECIAL USE PERMITS/ZONING MODIFICATIONS/WAIVERS

- REZONING FROM RS TO RMF
  DEVELOPMENT SPECIAL USE PERMIT WITH PRELIMINARY SITE PLAN.
  SPECIAL USE PERMIT TO INCREASE ALLOWABLE FAR UP TO 3.0 IN THE RMF ZONE FOR THE PROVISION OF ON-SITE
  AFFORDABLE HOUSING IN ACCORDANCE WITH SECTION 3-140(8)



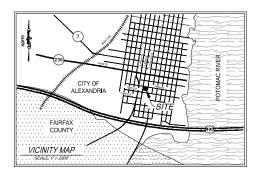

Sheet Number	
C100	COVER
C101	NOTES AND TABULATIONS
C200	EXISTING CONDITION PLAN
C201	TREE PRESERVATION PLAN
C202	TREE PRESERVATION TABULATION
C203	TREE PRESERVATION NOTES AND DETAIL:
C210	CONTEXTUAL SITE PLAN
C300	PRELIMINARY SITE PLAN
C400	PRELIMINARY GRADING
C401	AVERAGE FINISHED GRADE
C402	PRELIMINARY DIMESION PLAN
C403	FIRE SAFETY PLAN
C500	OPEN SPACE PLAN
C700	PRELIMINARY BMP MAP
C701	PRELIMINARY BMP COMPUTATIONS
C702	BMP DETAILS
C703	BMP DETAILS
C720	PRELIMINARY SWM AND OUTFALL ANALYS
C721	PRELIMINARY SANITARY OUTFALL ANALYS
C900 C901	TURNING MOVEMENTS TURNING MOVEMENTS
C901	TURNING MOVEMENTS
C902	TURNING MOVEMENTS
C903	TURNING MOVEMENTS
C905	TURNING MOVEMENTS
C906	TURNING MOVEMENTS
C907	TURNING MOVEMENTS
C908	TURNING MOVEMENTS
C910	PRELIMINARY SIGHT DISTANCE
C920	PHOTOMETRIC PLAN
L100	LANDSCAPE PLAN
L101	LANDSCAPE PLAN- COURTYARD
1200	I ANDSCAPE SCHEDULE AND CALCULATION
L300	LANDSCAPE SPECIFICATIONS AND DETAIL
A-100	CODE ANALYSIS
A-200	GARAGE LEVEL P1 PLAN
A-201	LEVEL 1 PLAN
A-202	LEVEL 2 PLAN
A-203	LEVEL 3 PLAN
A-204	LEVEL 4 PLAN
A-205	ROOF PLAN
A-206	AREA PLAN
A-301	BUILDING ELEVATIONS
A-302	ELEVATIONS MATERIALS
A-401	BUILDING SECTIONS
A-501	AERIAL VIEW
A-502	SUN-SHADE STUDY
A-602	PERSPECTIVE

SHEET INDEX

	DATE	REVISION
*********	07/11/25	PRELIMINARY DSUP SUBMISSION
ALL LIS	09/16/25	COMPLETENESS SUBMISSION
E VA	10/03/25	VERIFICATION RESUBMISSION
\$ JOHN L. HELMS		
Lic. No.52485		
10/03/2025		
CA TOTAL STATE OF		
JONAL BUSINESS		
10000000		

#### COMPLETE STREETS:

	New	Upgradeo
Crosswalks (number)	0	0
Standard	0	0
High Visibility	0	0
Curb Ramps	0	0
Sidewalks (LF)	158'	790'
Sidewalks (LF)	130	/90
Bicycle Parking (numbe		/90
		N/A
Bicycle Parking (numbe	r of spaces)	
Bicycle Parking (numbe Public/Visitor	r of spaces)	N/A

#### OWNER **OLDE TOWN WEST PROPERTIES**

301 S. ALFRED STREET ALEXANDRIA, VA 22314 (267) 895-1722

#### CO-DEVELOPER THE COMMUNITY BUILDERS, INC.

1003 K STREET, NW WASHINGTON, DC 20001 (202) 552-2500

#### CO-DEVELOPER ALFRED STREET BAPTIST CHURCH

301 S. ALFRED STREET ALEXANDRIA, VA 22314 (703) 683-2222

CIVIL ENGINEER IMEG

4035 RIDGE TOP ROAD FAIRFAX, VIRGINIA 22030 (703) 273-6820

#### **ARCHITECT** KGD

1101 15TH STREET NW. SUITE 200 WASHINGTON, DC. 20005 (202) 338-3800

#### TRAFFIC ENGINEER **GOROVE SLADE** 225 REINEKERS LANE. SUITE 750

ALEXANDRIA, VA 22314 (202) 296-8627

#### **ATTORNEY** WIRE GILL

700 N. FAIRFAX STREET. SUITE 600 ALEXANDRIA, VA 22314 (703) 835-1922



C100

113952

GENERAL NOTES 1. THE BOUNDARY INFORMATION FOR THE SUBJECT SITES IS BASED ON A CURRENT FIELD SURVEY PREPARED BY THIS FIRM BETWEEN THE DATES OF DECEMBER 26TH, 2018 AND JANUARY 10TH, 2019. EXISTING SITE INFORMATION FOR THE SUBJECT SITES IS BASED ON A CURRENT FIELD SURVEY PREPARED BY THIS FIRM BETWEEN THE DATES OF DECEMBER 28TH, 2018 AND JANUARY 10TH, 2019. THE SUBJECT SITE IS LOCATED ON CITY OF ALEXANDRIA ASSESSMENT MAP 074.03-05-07 ZONING TABULATIONS THE PROPERTY SHOWN HEREON ARE LOCATED ON FLOOD INSURANCE RATE MAPS (FIRM) COMMUNITY PANEL NUMBER 515519 DOM E, REVISED JUNE 16, 2011. ZONE X, AREAS DETERMINED TO BE OUTSIDE THE 0.2% ANNUAL CHANCE FLOODPLAIN. 074.03-05-07 (598 S. ALFRED STREET) EXISTING ZONE RMF (RESIDENTIAL, MULTIFAMILY) IN ACCORDANCE WITH THE CITY OF ALEXANDRIA'S MARINE CLAY AREAS MAP DATED NOVEMBER 1976, THERE ARE NO AREAS OF MARINE CLAY LOCATED IN THE VICINITY OF EXISTING SITE AREA: 56.096 S.F. OR 1.29 AC Parking Requirement THESE SITES. IN ACCORDANCE WITH THE RESOURCE PROTECTION AREAS MAP ADOPTED JUNE 12, 2004 BY THE CITY COUCIL OF ALEXANDRIA, THERE ARE NO RESOURCE PROTECTION AREAS PROPOSED SITE AREA: 56.096 S F OR 1.29 AC LOCATED ON THESE PROPERTIES. EXISTING LISE-RESIDENTIAL 8. THIS PROJECT IS LOCATED IN A COMBINED SEWER AREA. MULTIFAMILY TO THE BEST OF OUR KNOWLEDGE THERE ARE NO KNOWN UNDERGROUND STORAGE TANKS CURRENTLY LOCATED AT THESE PROPERTIES. PROPOSED USE PROPOSED NUMBER OF UNITS: 145 UNITS TO THE BEST OF OUR KNOWLEDGE THERE ARE NO AREAS ON-SITE CONTAINING CONTAMINATED SOLLS OR CONTAMINATED GROUNDWATER. N/A 145 / 1,29 = 1112.4 DU/AC. Walkability Index score is between 90-100 (10%) Walkability Index score is between 80-89 (5%) 11. THE ENTIRE SUBJECT PROPERTY CONSIST OF SOIL TYPE 98 URBAN LAND - GRIST MILL. ent project has 20% or more studio units (5%) ENVIRONMENTAL SITE ASSESSMENT

YARDS PROVIDED:

PARKING REQUIRED:

PARKING PROVIDED:

BICYCLE PARKING REQUIRED

BICYCLE PARKING PROVIDED:

EXISTING AVG. DAILY TRIPS:

USE GROUP


A, USE GROUP: B. NIIMBED OF STODIES:

C. TYPE OF CONSTRUCTION: D. FLOOR AREA PER FLOOR:

E FIRE PROTECTION PLAN:

APPROXIMATE AREA OF DISTURBANCE

Four or more bus routes stop within 0.25 mile of development entrance (5%) GROSS FLOOR AREA PROPOSED: NET FLOOR AREA PROPOSED: Residential performance-based ratios based on the Guiding Document for Parking Standards for Multi-Family Residential Developmen Projects dated February 24, 2016.
 The ratio shown above includes a reduction to the 0.75 and 0.50 space per unit rate for affordable housing based on units at 60% and 30% AMI. resort-felve, with websability and transit credits apolied. 0.75 OR UP TO 3.0 WITH DSUP 2.16 MAXIMUM BUILDING HEIGHT: PROPOSED BUILDING HEIGHT Alfred Street Redevelopment
Trip Generation Calculations (9/12/2025) AMI MIX UNITTYPE | UNITCOUNT | MIXRATIO PROPOSED AVERAGE FINISH GRADE 28.6' 598 South Alfred Street 45 18 Trip Generation Analysis - Existing (withMode Split Reductions) LOT REQUIRED: LOT PROVIDED: FRONT (NORTH) = 0 YARDS REQUIRED: SIDE (EAST & WEST) = 8' EAST (SOUTH) = 8'

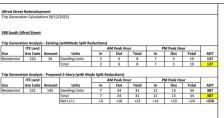

#### PARKING CALCULATION NOTE THE PARKING TABULATIONS SHOWN ON THIS SHEET ARE CONCEPTUAL AND SUBJECT TO CHANGE BASED ON AFFORDABILITY OF THE PROJECT AND ADDITIONAL PARKING REDUCTIONS.

GREEN BUILDING NARRATIVE

GENERAL APPROACH: EARTHCRAFT COLD CERTIFICATION

ARCHAEOLOGY NOTES

THERE ARE NO RPA'S, TIDAL WETLANDS, SHORES, TRIBUTARY STREAMS, FLOODPLAINS, CONNECTED WETLANDS, ISOLATED WETLANDS, HOHILLY EXODISLIPERMEABLE SOILS OR BUFFER AREA SASSOLATED WITH SHORES, STREAMS OR WETLANDS LOCATED ON THIS SITE.

THIS PROJECT WILL COMPLY WITH THE CITY OF ALEXANDRIA 2019 GREEN BUILDING POLICY.

ENERGY. THE SHAPE OF THE BUILDING WILL ALLOW US TO MAXIMIZE DAYLIGHTING AND EFFICIENT WIND FLOW FOR NATURAL COOLING WHEN DESIRED. THIS WILL LOWER THE DEMAND FOR THE MEP SYSTEMS. THE PROJECT WILL ALSO EMPLOY ENERGY EFFICIENT LIGHTING AND APPLIANCES WERE APPLICABLE HELPING TO REDUCE THE ENERGY USE.

WATER THE USE OF BRIDGATON AND OTHER STORMATER MANAGEMENT & STILL IN THE DESIGNMENT AS TREAS ESTER METHOD HIS PLOTE USE ON AN WHITE THE SUBJECT OF REDUCE THE AMOUNT OF BOTABLE WATER REQUIRED, AGOIT DOWNLY. THE EMPLOYMENT OF LOW FLOW FIRTURES WHERE APPL CABLE WILL REDUCE THE AMOUNT OF PORTABLE WHITE REQUIRED, ADDITIONALLY, THE EMPLOYMENT OF LOW FLOW FIXTURES WHERE APPLICABLE WILL REDUCE THE CONSAMPTION OF WATER ON SITE.

HVAC: THE MECHANICAL SYSTEMS WILL MEET ASHRAE STANDARDS AS WELL AS MAINTAIN INDOOR AIR QUALITY STANDARDS. ADDITIONALLY, NATURAL VENTILATION WITHIN EVERY UNIT WILL BE MET VIA SELECTED GLAZING SYSTEMS.

- THE APPLICANT/DEVELOPER SHALL CALL ALEXANDRIA ARCHAEOLOGY IMMEDIATELY
  (702-746-4399) F ANY BURIED STRUCTURAL REMAINS (WALL FOUNDATIONS, WELLS, PRIVIES,
  CISTERNS, ETC.) OR CONCENTRATIONS OF ARTIFACTS ARE OBSCOVERED DURING DEVELOPMENT: WORK MUST CEASE IN THE AREA OF THE DISCOVERY UNTIL A CITY ARCHAEOLOGIST COMES TO THE SITE AND RECORDS THE FINDS.
- THE APPLICANT/DEVELOPER SHALL NOT ALLOW ANY METAL DETECTION TO BE CONDUCTED ON THE PROPERTY, UNLESS AUTHORIZED BY ALEXANDRIA ARCHAEOLOGY.
- THE APPLICANT HAS HIRED A ARCHEOLOGY CONSULTANT AND WILL BE COORDINATING WITH ALEXANDRIA ARCHEOLOGY FOR THE SCOPE OF WORK FOR THE PROJECT.

#### SANITARY SEWER OUTFALL NARRATIVE

THIS PROJECT PROPOSES TO CONNECT TO THE EXISTING 15' SEWER THAT RUNS EAST ALONG THE NORTHERN PORTION OF THE SITE. PER NEMO TO NULSTRY 05-14, AN ADEQUATE ANALYSIS MUSTS DE PERFORMED TO ANALYSE THE SYSTEM UNTIL IT RUNS TO A 24' PIPE. THIS PROJECT IS LOCATED IN A COMBINED SEWER AREA.

#### STORM WATER MANAGEMENT NARRATIVE

TO COMPLY WITH THE STORM WATER REQUIREMENTS IN ACCORDANCE WITH ARTICLE XIII OF THE ZONING ORDINANCE, THIS PROJECT WILL PROVIDE ON-SITE TREATMENT OF SITE RUNOFF THROUGH THE USE OF CITY-APROVED BMP FACILITIES TO MEET BOTH POLLUTANT LOAD REDUCTION AND THE WATER QUALITY VOLUME DEFAULT.

#### BEST MANAGEMENT PRACTICES:

TO COMPLY WITH THE CHESAPEAKE BAY ACT (CBA) AND ARTICLE XIII OF THE ZONING ORDINANCE, THIS PROJECT WILL PROVIDE WATER QUALITY TREATMENT THROUGH THE USE OF BIORETENTIONS. PER THE CITY'S STORMWATER MANAGEMENT REQUIREMENTS [ARTICLE XIII'CHESAPEAKE BAY ENVIRONMENTAL MANAGEMENT' SECTION 13-109.F.1], VOLUME CONTROL IS REQUIRED.

#### ALEXRENEW NOTES:

CONTRACTOR SHALL ENSURE ALL DISCHARGES ARE IN ACCORDANCE WITH CITY OF ALEXANDRIA
ODE TITLES, CHAPTER 6, ARTICLE 8.
 DEWLATERING AND OTHER CONSTRUCTION RELATED DISCHARGE LIMTS TO THE SEWER SYSTEM
ARE REGULATED BY A EXPRENENT PRETEATMENT, CONTRACTOR IS REQUIRED TO CONTACT
ALEXEMENT SPETERATAMENT CONTRACTOR TO 359 MS (282)

ALEXEMENT SPETERATAMENT CONDITION TO THOS 3500 X202)

TO STATE OF THE TO STATE OF THE STATEMENT OF T

#### SOIL DATA:

THE ENTIRE SUBJECT PROPERTIES CONSIST OF SOIL TYPE 98 URBAN LAND -GRIT MILL

#### STORM STRUCTURE DATA

- RIM EL. = 25.68
  STRUCTURE INACCESSIBLE FOR AS-BUILT
  EVALUATION TREE-SAVE CHAIN LINK
  FENCE CONSTRUCTED OVER STORM LID.
- RIM EL. = 25.64 8779 INV IN (15" RCP FROM SE) = 21.64 INV IN (15" RCP FROM SOUTH) = 21.54 INV OUT (15" RCP TO NW) = 21.44
- (583) INV IN (12" DIP FROM SOUTH) = 21.05 INV IN (12" DIP FROM SOUTH) = 20.95 INV OUT (10" DIP TO 0583) = 20.75
- | RIM EL = 22.10 | INV IN (10" DIP FROM SOUTH) = 19.00 | INV OUT (10" DIP TO NORTH) = 18.95 | POTENTIAL BLIND CONNECTION INTO THE PIPE CONNECTING #0584 AND #0583
- (SEE DATA FOR #5836)

#### SANITARY STRUCTURE DATA

- RIM EL, = 28.60
  INV IN (10° DIP FROM SOUTH) = 20.00
  UPSTREAM STRUCTURE IN INTERSECTION OF SOUTH ALFRED AND GIBBONS STREETS.
  INV OUT (15° PVC TO 5724) = 19.95
- RIM EL. = 26.12 INV IN (8" DIP FROM SOUTH) = 20.02 INV IN (8" PVC FROM WEST) = 20.37 INV OUT (8" DIP TO 5996) = 19.92
- RIM EL. = 24.66
  INV IN (8" DIP FROM 5994) = 18.46
  INV OUT (8" DIP TO MORTH) = 18.36
  UNABLE TO CONFIRM THE
  DOWNSTREAM CONNECTION.
- RIM EL. = 22.83 INV IN (8° RCP FROM EAST) = 16.93 INV OUT (8° DIP TO 324) = 16.83
- RIM EL = 22.23 INV IN (8° DIP FROM 5997) = 16.25 INV IN (8° PVC FROM EAST) = 18.13 INV OUT (8° DIP TO 0583) = 16.19
- RIM EL. = 21.31
  SEALED FACING SW
  POTENTIAL CONNECTION FROM #0583
  INV IN (8" DIP FROM 324) = 14.56
  INV OUT (8" DIP TO 5838) = 14.51 INV UUI (6 UII FO 5000) - MAI RIM EL. = 21.49 INV IN (8° DIP FROM 304) = 13.29 INV IN (RCP FROM NORTH) INACCESSIBLE, PIPE SET BACK AT TOP OF STRUCTURE. INV OUT (60° RCP TO 5732) = 11.89
- RIM EL. = 21.45
  INV IN (RCP FROM 5838) = 11.85
  UNABLE TO DETERMINE PIPE SIZE
  BASED ON SEWER CAMERA PHOTOS
  INV IN (8° DIP FROM NORTH) = 12.65
  INV OUT (60° RCP TO EAST) = 11.45

APPROV SPECIAL USE DEPARTMENT OF PLA	PERMIT		x-xxxxx
DIRECTOR	_	DATE	
DEPARTMENT OF TRAI SITE PLAN NO		& ENVIRON	MENTAL SERVICES
DIRECTOR		DATE	
CHARMAN, PLANNING CO	ANSSICH		DATE
CHARMAN, PLANNIC COL	AN SSICH		DATE





ELOPMENT T SPECIAL USE PERMIT AFFORDABLE OLDE TOWNE WEST AF HOUSING DEVELO

PROJECT No.: 24001431.00 DRAWING No.: 113952 SCALE: NONE DESIGN: EG RAWN: JS HECKED: EG SHEET TITLE:

> NOTES AND **TABULATIONS**

SHEET No. C101

NORTH = 8' MIN., 10.5' MAX. SOUTH = 10.5' WEST = 8.8'

EAST = 8.9' MIN., 18.7' MAX.

145 UNITS (SEE PARKING CALCULATIONS) 86 SPACES

86 SPACES 94 SPACES (73 STANDARD, 17 COMPACT, 2 HANDICAP, 2 HANDICAP VAN)


25% x 56,096 = 14,024 SF +/- 15,410 SF (SEE SHEET C500 FOR DETAIL)


BUILDING TO BE FULLY SPRINKLER WITH FIRE PUMP

TOTAL = 47

TOTAL = 52

LONG TERM BICYCLE REQUIRED = 44 SHORT TERM BICYCLE REQUIRED = 3

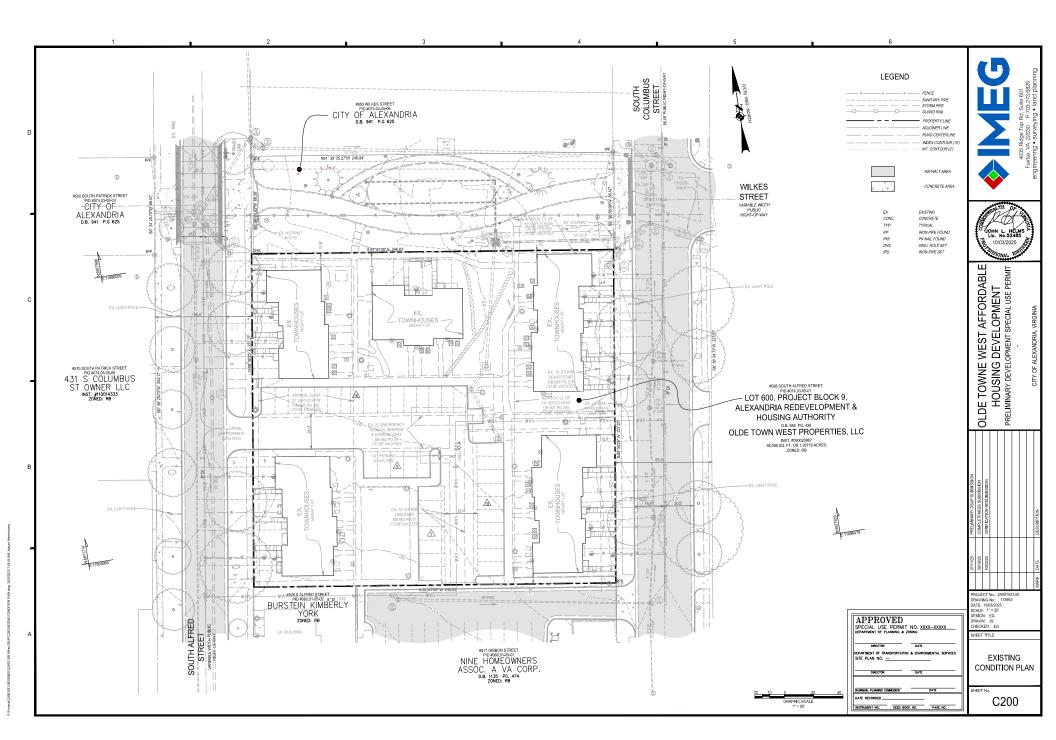

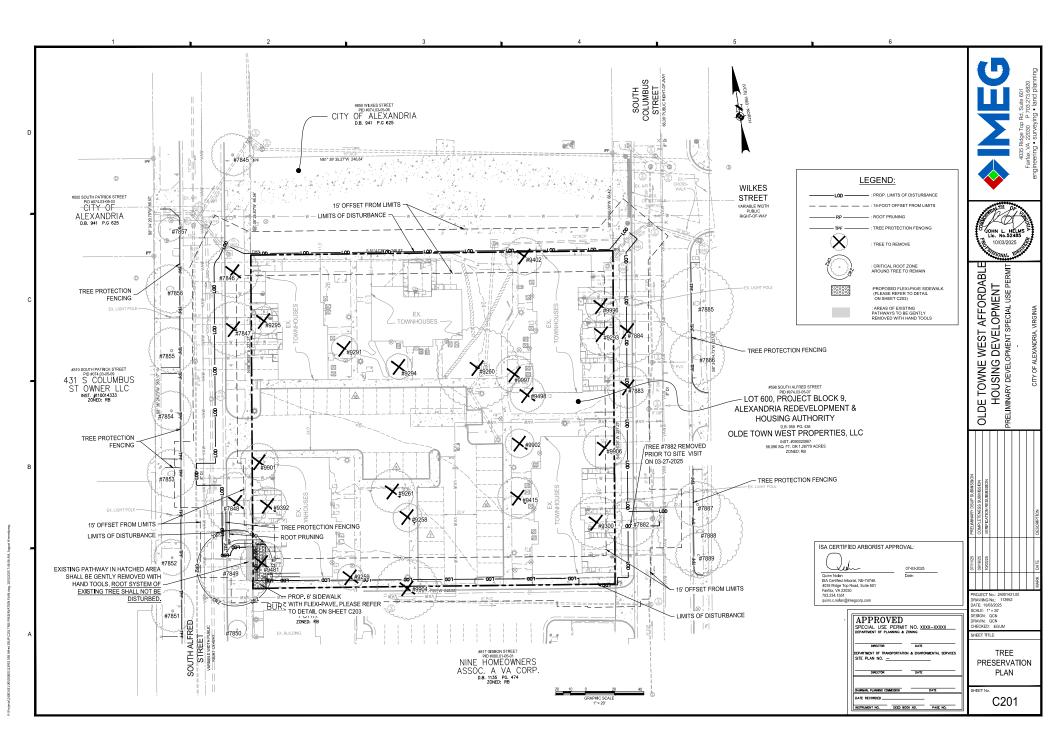

1 2 3 4 5 6

rree #	BOTANICAL NAME	COMMON NAME	TRUNK DIAMETER (INCHES) / CRITICAL ROOT ZONE RADIUS (FEET)	SURVEYED DRIPLINE RADIUS (FEET)	CONDITION RATING	LOCATION	PROCEDURE	COMMENTS
7845	STYPHNOLOBIUM JAPONICUM	SOPHORA	16	18	86	OFFSITE	PRESERVE	NUMEROUS GIRDLING ROOTS, PLASTIC ROPE COMING OUT OF ROC FLARE, OLD PRUNING CUTS HEALING OVER, 3 LARGE DEAD SCAFFOLD BRANCHES, 4 DEAD MEDIUM SIZED BRANCHES THROUGHOUT CROWN.
7846	STYPHNOLOBIUM JAPONICUM	SOPHORA	22	20	69	OFFSITE	REMOVE	2 SMALL GIRDLING ROOTS, BASE OF MAIN LEADERS RUBBING, SM. DEAD BRANCHES THROUGHOUT CROWN.
7847	FRAXINUS PENNSYLVANICA	GREEN ASH	20	15	56	OFFSITE	REMOVE	I LARGE GIRDLING ROOT. BARK SHOWING SLIGHT SIGNS OF BLONDING, INSECT EXIT THE PRESENT OR TRUME. HIGH DENSITY EPICCRING SPROUTS GROWING THROUGHOUT CANOPY CROWN I 23 DEAD EXCEPT FOR EXISTING EPICORMIC GROWTH, OLD PRUN CUT EXPOSING HEART ROT IN TRUME.
7848	FRAXINUS PENNSYLVANICA	GREEN ASH	21	23	69	OFFSITE	REMOVE	LARGE OLD WOUND ON LOWER TRUNK EXPOSING HEART ROT. HIG DENSITY OF EPICORMIC GROWTH THROUGHOUT CROWN, 6 DEAD BRANCHES,
7849	QUERCUS PHELLOS	WILLOW OAK	26	20	72	OFFSITE	PRESERVE	1 SMALL GIRDLING ROOT, INCLUDED BARK IN MAIN LEADER UNION
7850	PISTACIA CHINENSIS	CHINESE PISTACHE	10	8	75	OFFSITE	PRESERVE	
7851	GINKGO BILOBA	GINKGO	15	15	69	OFFSITE	PRESERVE	SMALL SECTION OF PLASTIC COORUGATED PIPE COMING OUT AT ROOT FLARE. 1 LARGE BROKEN SCAFFOLD BRANCH, LAWN MOWE DAMAGE TO SURFACE ROOTS.
7852	GINKGO BILOBA	GINKGO	12	10	69	OFFSITE	PRESERVE	SMALL OLD WOUND ON LOWER TRUNK. OLD WOUND HEALED OVE AT LOWER MID-TRUNK. TIPS OF SMALLER SCAFFOLD BRANCHES BROKEN AND STUBS REMAINING.
7853	GINKGO BILOBA	GINKGO	16	15	75	OFFSITE	PRESERVE	
7854	GINKGO BILOBA	GINKGO	14	15	72	OFFSITE	PRESERVE	4 SCAFFOLD BRANCHES PREVIOUSLY BROKE AND LARGE STUBS REMAINING.
7855	GINKGO BILOBA	GINKGO	17	16	72	OFFSITE	PRESERVE	INCLUDED BARK IN MAIN CROWN LEADER UNION.
7856	GINKGO BILOBA	GINKGO	18	15	75	OFFSITE	PRESERVE	
7857	GINKGO BILOBA	GINKGO	9	8	69	OFFSITE	PRESERVE	3 BROKEN BRANCHES WITH STUBS REMAINING, 1 BROKEN BRANC STILL ATTACHED AND HANGING.
7883	ZELKOVA SERRATA	JAPANESE ZELKOVA	20	18	69	OFFSITE	REMOVE	LAWN MOWER DAMAGE TO SURFACE ROOTS EXPOSING ROT. 4 D BRANCHES IN CROWN INTERIOR.
7884	PLATANUS × ACERIFOLIA	LONDON PLANETREE	16	18	63	OFFSITE	REMOVE	SEVERE LAWN MOWER DAMAGE TO ROOTS. ROOTS AT ROOT FLA BROKEN AND EXPOSING HEART ROT AS A RESULT OF DAMAGE. C WOUND AT ROOT FLARE EXPOSING DECAY. 6 DEAD SCAFFOLD BRANCHES.
7885	QUERCUS PHELLOS	WILLOW OAK	30	26	69	OFFSITE	PRESERVE	LARGE OLD WOUND ON ROOT FLARE EXPOSING HEART WOOD W FUNGAL FRUITING BODIES PRESENT.
7886	ZELKOVA SERRATA	JAPANESE ZELKOVA	19	18	69	OFFSITE	PRESERVE	3 LARGE GIRDLING ROOTS.
7887	TILIA AMERICANA	BASSWOOD	15	12	69	OFFSITE	PRESERVE	LAWN MOWER DAMAGE TO SURFACE ROOTS. 1 LARGE GIRDLING ROOT.
7888	QUERCUS PHELLOS	WILLOW OAK	27	24	69	OFFSITE	PRESERVE	TREE HAS OUT GROWN TREE PIT, ROOTS GROWING AROUND EXISTING MAN HOLE. DAMAGE TO ROOT FLARE ALONG ROAD EXPOSING DECAY.
7889	TILIA AMERICANA	BASSWOOD	15	12	69	OFFSITE	PRESERVE	OLD WOUND ON TRUNK EXPOSING HEART ROT, PRUNING CUTS HEALING OVER, UNEVEN CANOPY STRUCTURE.
9300	CRATAEGUS PHAENOPYRUM	WASHINGTON HAWTHORN	8	18	66	ONSITE	REMOVE	MULTI-STEMMED WITH 4 TRUMS, DBH AVERAGE OF TRUMS, TRI RUBBING CREATING WOUND, CLD WOUNDS ON 2 TRUMS, UNEVE CANOPY STRUCTURE FROM OVER PRUNING FOR CLEARANCE. SM BRANCHES AND SCAFFOLD BRANCHES STUBBED OFF AS A RESU
9906	CRATAEGUS PHAENOPYRUM	WASHINGTON HAWTHORN	8	15	66	ONSITE	REMOVE	MULTI-STEMMED WITH 3 TRUMS, DBH IS ANAVG OF TRUMS, CHRISTIMS LIGHT WEAPPED AROUND TRUM, AND BEGINNING TO GIRDLE TREE. CLD WOUND FROM LEADER BEING REMOVED EXPOSING HEART ROY. ALL THREE TRUMS RUBBING, LINEVEN CAROPY STRUCTURE FROM OVER PRUNING.
9293	CRATAEGUS PHAENOPYRUM	WASHINGTON HAWTHORN	10	15	69	ONSITE	REMOVE	DBH AVGERAGE OF 3 TRUNKS. CAVITY WITH DECAY IN MAIN TRU UNION. TRUNKS APPEAR TO BE SEPERATING, LARGE POCKET OF DECAY IN CENTRAL LEADER APPEARS TO BE SPREADING.
9996	CRATAEGUS PHAENOPYRUM	WASHINGTON HAWTHORN	10	12	69	ONSITE	REMOVE	HEART ROT PRESENT IN UPPER HALF OF TRUNK, OLD PRUNING WOUND HEALING OVER.
9415	CRATAEGUS PHAENOPYRUM	WASHINGTON HAWTHORN	11	14	66	ONSITE	REMOVE	UNEVEN CANOPY STRUCTURE LEANING TOWARDS PARKING LOT TENSION CRACKS IN ROOT FLARE EXPOSING HEART WOOD. HEA ROT WITHIN INTERIOR TRUNKS FROM POOR PRUNING CUTS.
9902	CRATAEGUS PHAENOPYRUM	WASHINGTON HAWTHORN	9	10	69	ONSITE	REMOVE	SMALL OLD WOUNDS ON TRUNK EXPOSING HEART WOOD, 2 LAR DEAD SCAFFOLD BRANCH, 1 DEAD BRANCH.
9498	MAGNOLIA GRANDIFLORA	SOUTHERN MAGNOLIA	13	12	72	ONSITE	REMOVE	UNEVEN CANOPY STRUCTURE.


TREE #	BOTANICAL NAME	COMMON NAME	TRUNK DIAMETER (INCHES) / CRITICAL ROOT ZONE RADIUS (FEET)	SURVEYED DRIPLINE RADIUS (FEET)	CONDITION RATING	LOCATION	PROCEDURE	COMMENTS
9997	CRATAEGUS PHAENOPYRUM	WASHINGTON HAWTHORN	10	13	69	ONSITE	REMOVE	DBH AVGERAGE OF 2 LEADERS. UNEVEN CANOPY STRUCTURE. CROWN ON BULDING SIDE HAS BEEN OVER PRUNED. SMALL OLD WOUNDS FROM PRUNING CUTS EXPOSING HEART WOOD. STUBS LEF FROM POOR PRUNING CUTS THROUGHOUT CANOPY.
9402	MALUS SPP.	CRAB APPLE	11	13	66	ONSITE	REMOVE	UNEVEN CANOPY STRUCTURE. OLD WOUND ON ROOT FLARE FROM MECHANICAL DAMAGE. OLD PRUNING CUTS EXPOSING HEART WOO SMALL OLD CAVITY IN TRUNK.
9260	ACER SACCHARINUM	SILVER MAPLE	36	28	69	ONSITE	REMOVE	LAWN MOWER DAMAGE TO SURFACE ROOTS EXPOSING HEART WOOD. 1 DEAD SCAFFOLD BRANCH, SMALL DEAD BRANCHES THROUGHOUT CROWN.
9294	MALUS SPP.	CRAB APPLE	8	9	69	ONSITE	REMOVE	LARGE CAVITY PRESENT IN LOWER HALF OF TRUNK.
9291	MALUS SPP.	CRAB APPLE	8	9	69	ONSITE	REMOVE	LARGE OLD CAVITY IN THE BASE OF TRUNK AND SMALL CAVITY IN MIDDLE OF TRUNK. TRUNK LEANING TOWARDS BUILDING.
9295	MALUS SPP.	CRAB APPLE	9	10	66	ONSITE	REMOVE	OLD WOUNDS ON TRUNK EXPOSING HEART ROT. POOR PRUNING CU STUBBED OFF BRANCHES, LARGE OLD WOUND ON SCAFFOLD BRANCH EXPOSING HEART ROT.
9901	ACER RUBRUM	RED MAPLE	13	13	72	ONSITE	REMOVE	POOR PRUNING CUTS STUBBING BRANCHES ON BUILDING SIDE.
9392	CRATAEGUS PHAENOPYRUM	WASHINGTON HAWTHORN	19	13	69	ONSITE	REMOVE	UNEVEN CANOPY STRUCTURE. LARGE DEAD STUBS THROUGHOUT CANOPY, SMALL DEAD BRANCHES THROUGHOUT CANOPY.
9481	CRATAEGUS PHAENOPYRUM	WASHINGTON HAWTHORN	10	15	66	ONSITE	REMOVE	DBH AVGERAGE TWO STEMS. OLD WOUND ON TRUNK EXPOSING HEART ROT. STUBS THROUGHOUT CANCEY FROM POOR PRUNING. DEAD BRANCHES THROUGHOUT CANCEY, UNEVEN CANCEY STRUCTURE.
9259	MALUS SPP.	CRAB APPLE	6	9	63	ONSITE	REMOVE	DBH IS AVERAGE OF 2 LEADERS, 1 LEADER IS HOLLOW WITH CAVIT PRESENT AT MID ELBOW. OLD WOUND EXPOSING HEART ROT AT ELBOW OF SECOND LEADER, SMALL CAVITY PRESENT AT MAIN TRUNK UNION. STUB REMAIN FROM SCAFFOLD BRANCH FAILING.
9904	AILANTHUS ALTISSIMA	TREE OF HEAVEN	28	21	63	OFFSITE	REMOVE	EXTENSIVE VINES ON TRUNK AND THROUGHOUT CANOPY, CUTS INTO BARK AND CAMBIUM FROM VINE REMOVAL, SMALL DEAD BRANCHES THROUGHOUT CROWN, OLD WOUND ON UPPER TRUNK EXPOSING DECAY.
9258	UNIDENTIFIED	DEAD TREE	11	10	25	ONSITE	REMOVE	DEAD
9261	TILIA AMERICANA	BASSWOOD	14	15	63	ONSITE	REMOVE	I GIROLING ROOT, LARGE OLD WOUND ON MID TRUNK EXPOSING HEART ROT FROM PREVIOUS BRANCH FAILURE, 3 DEAD BRANCHES SIMOLING ROWN, OLD WOUND AT BASE OF TRUNK EXPOSING DECAY WHICH IS SPREADING UP TRUNFROM ROOT FLARE.




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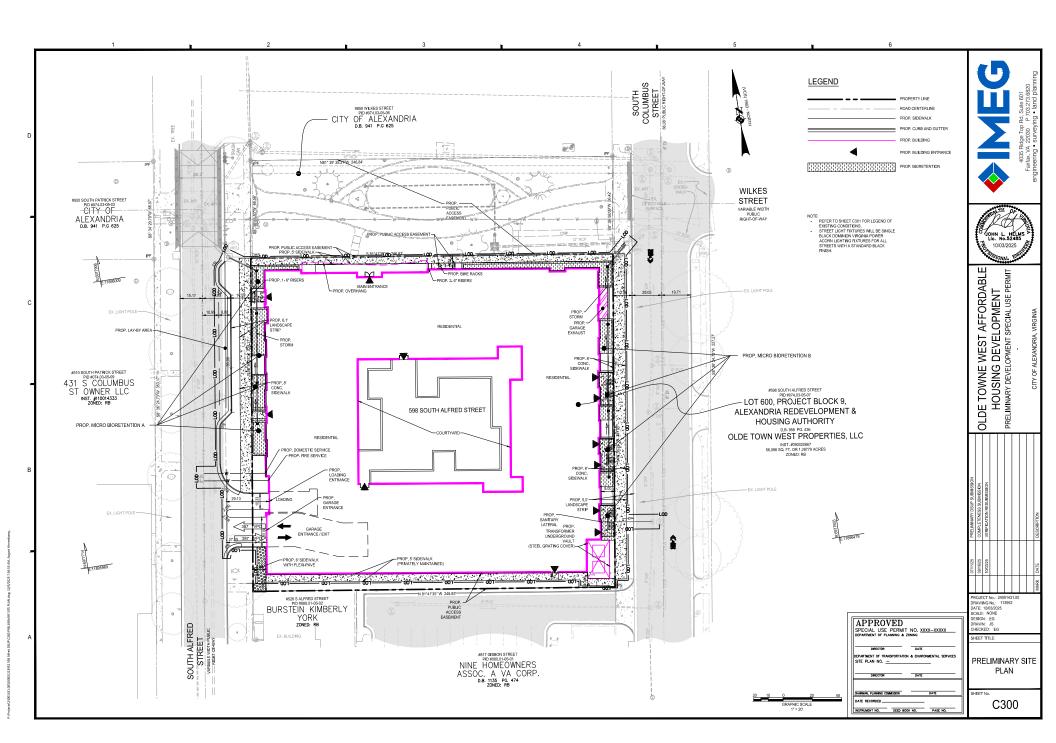
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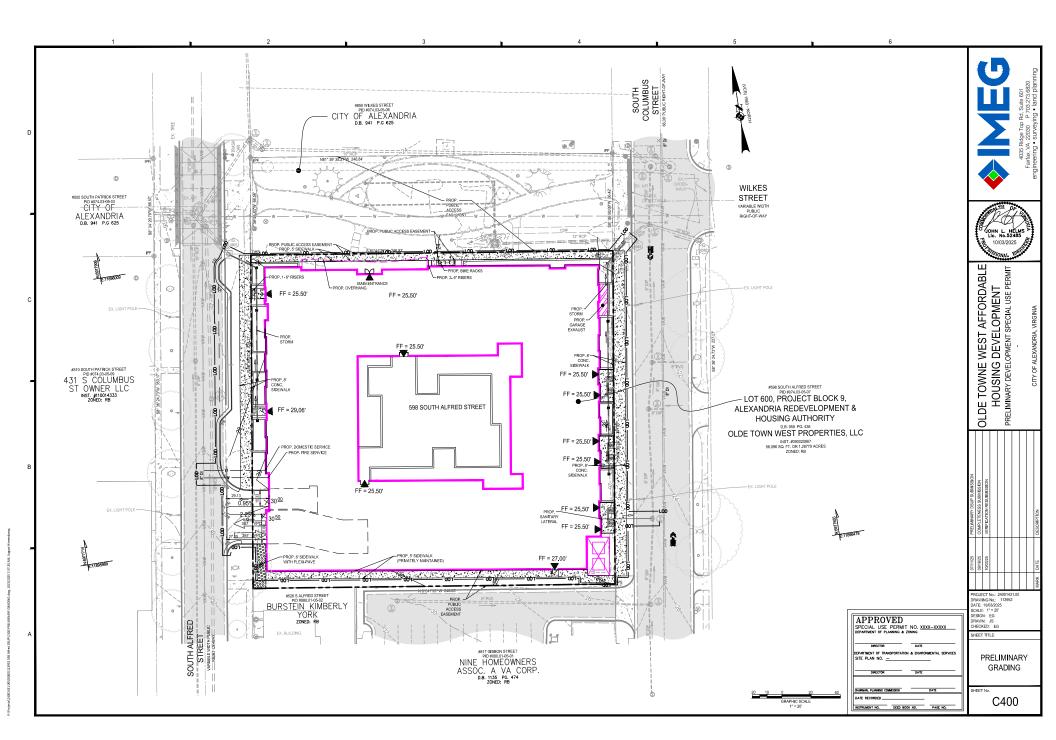
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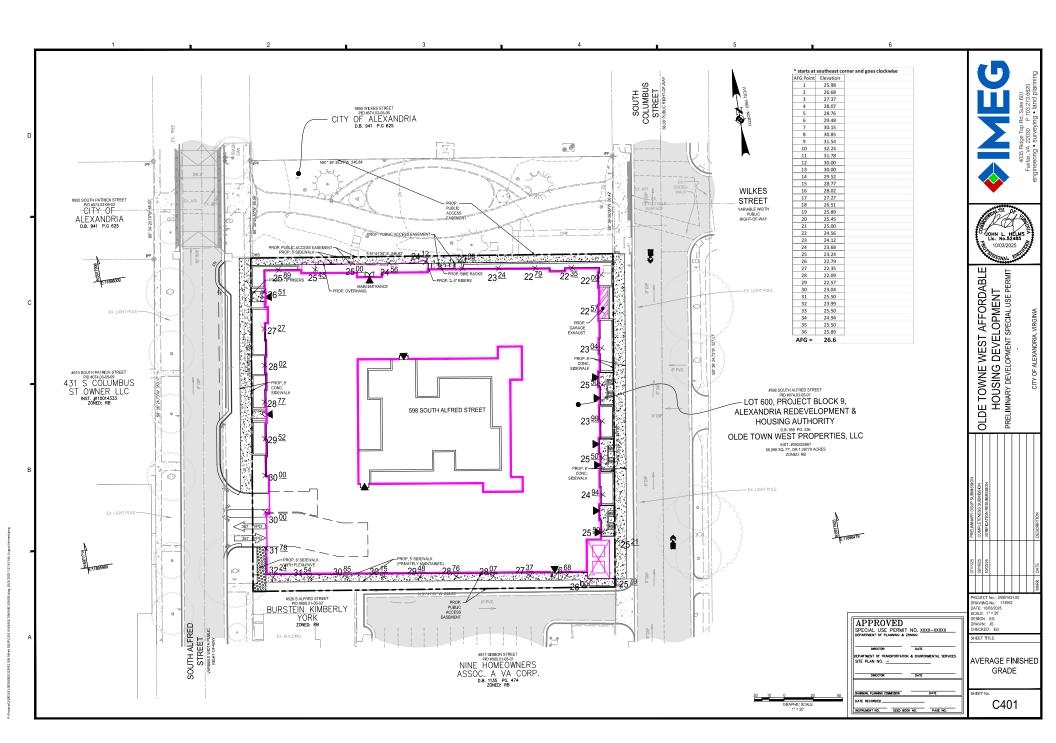








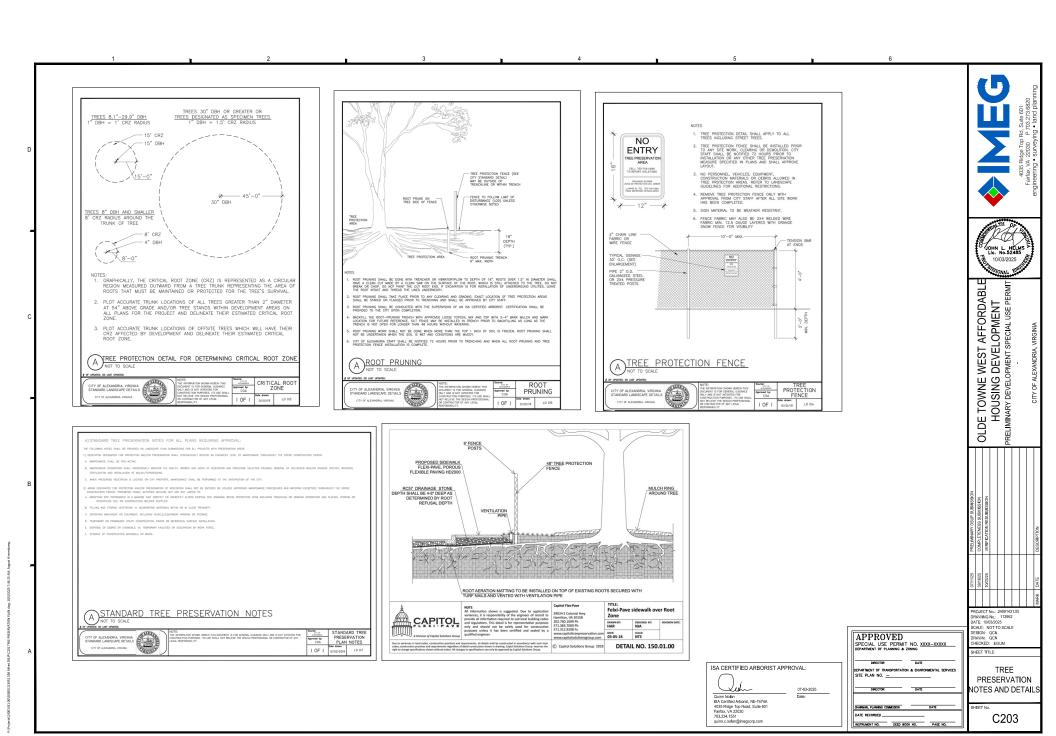


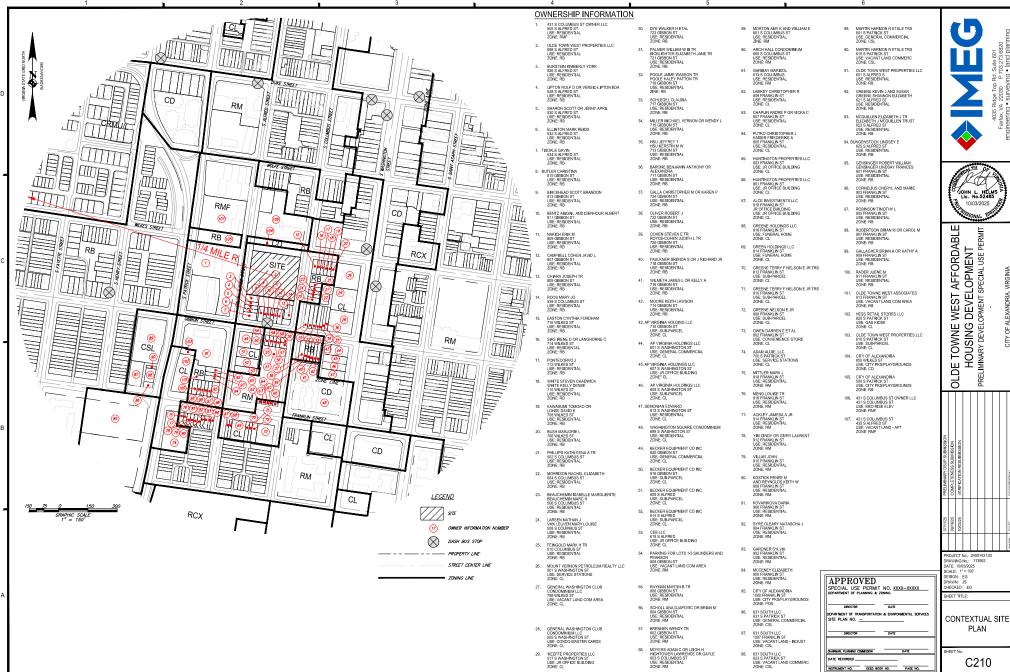





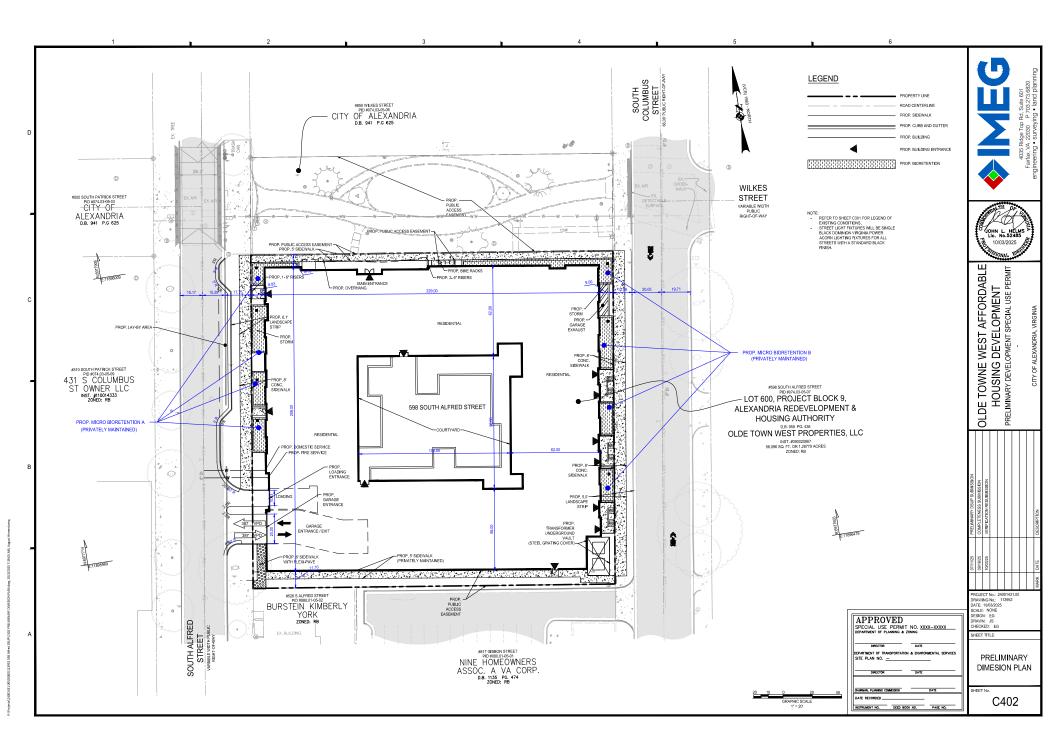


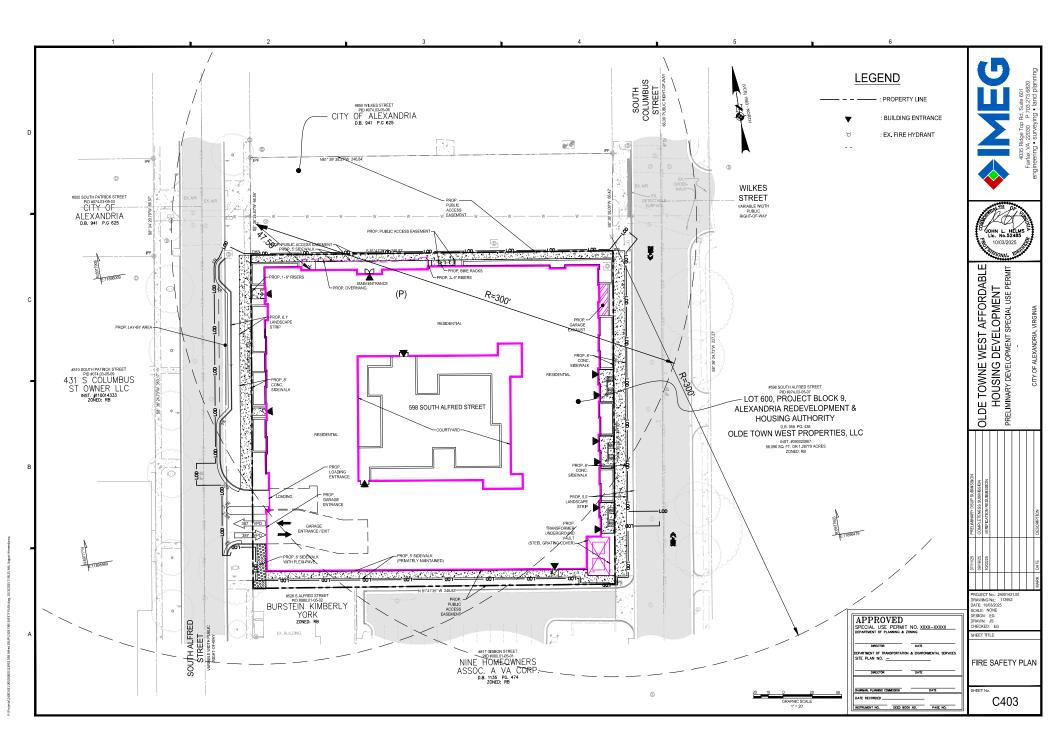


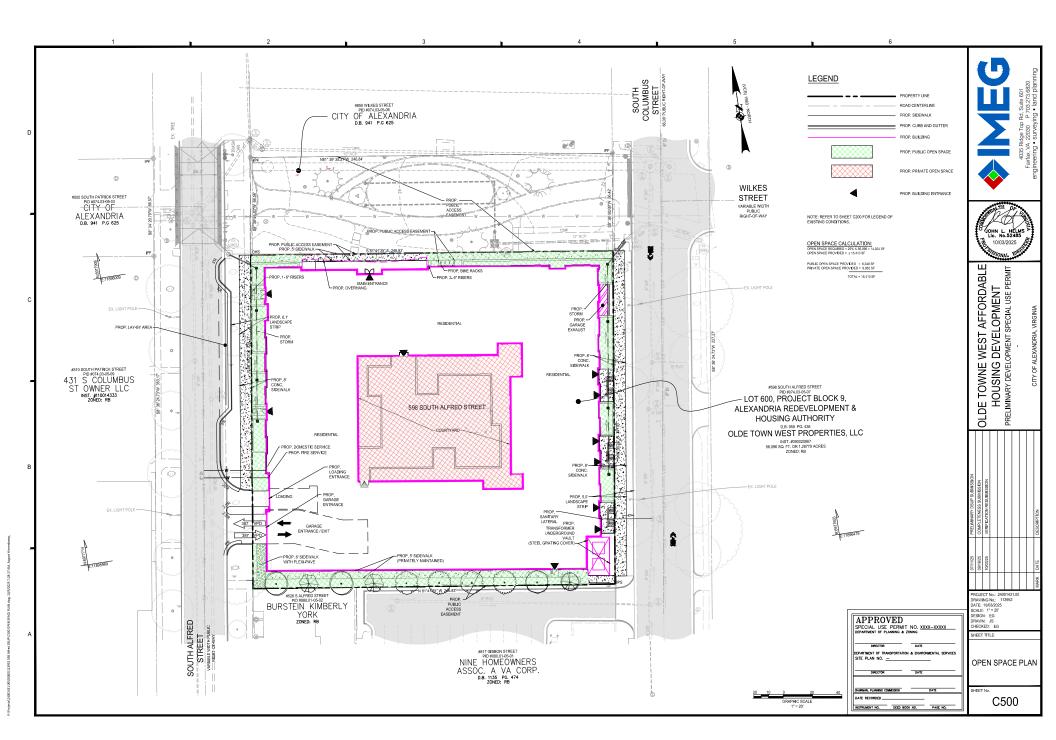


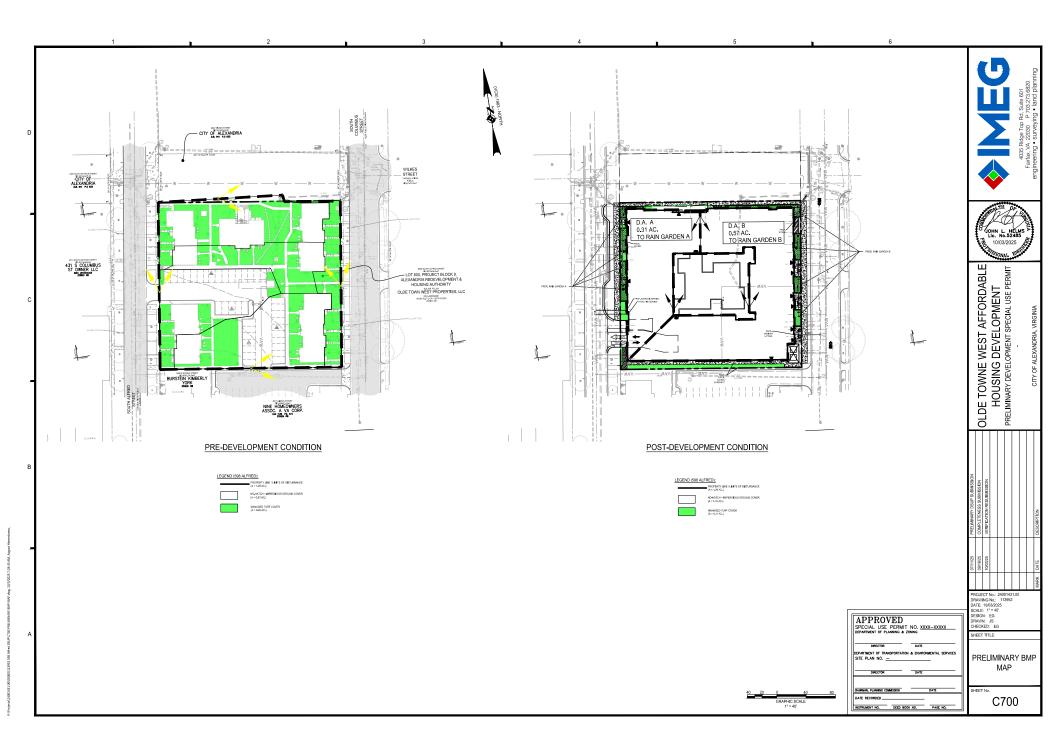


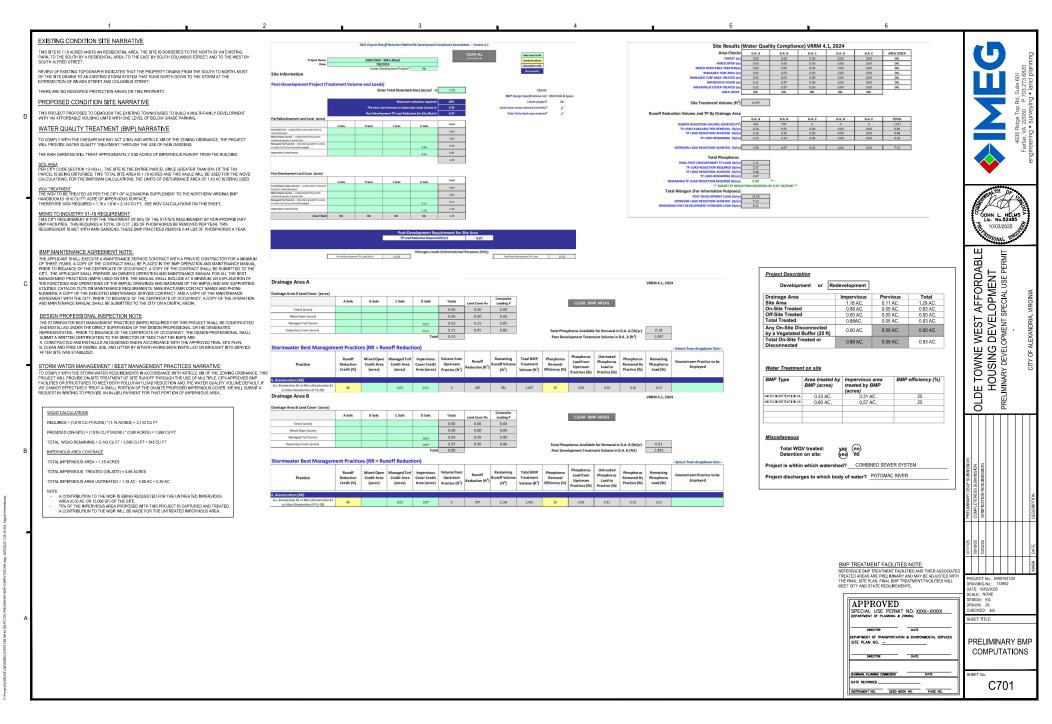


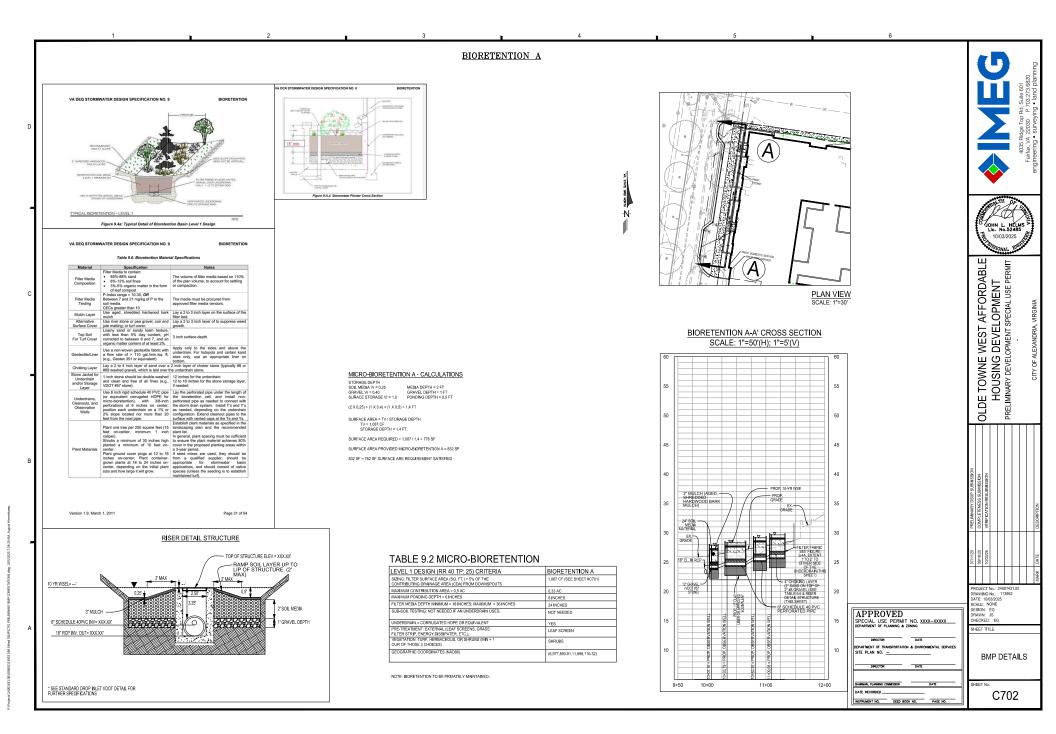


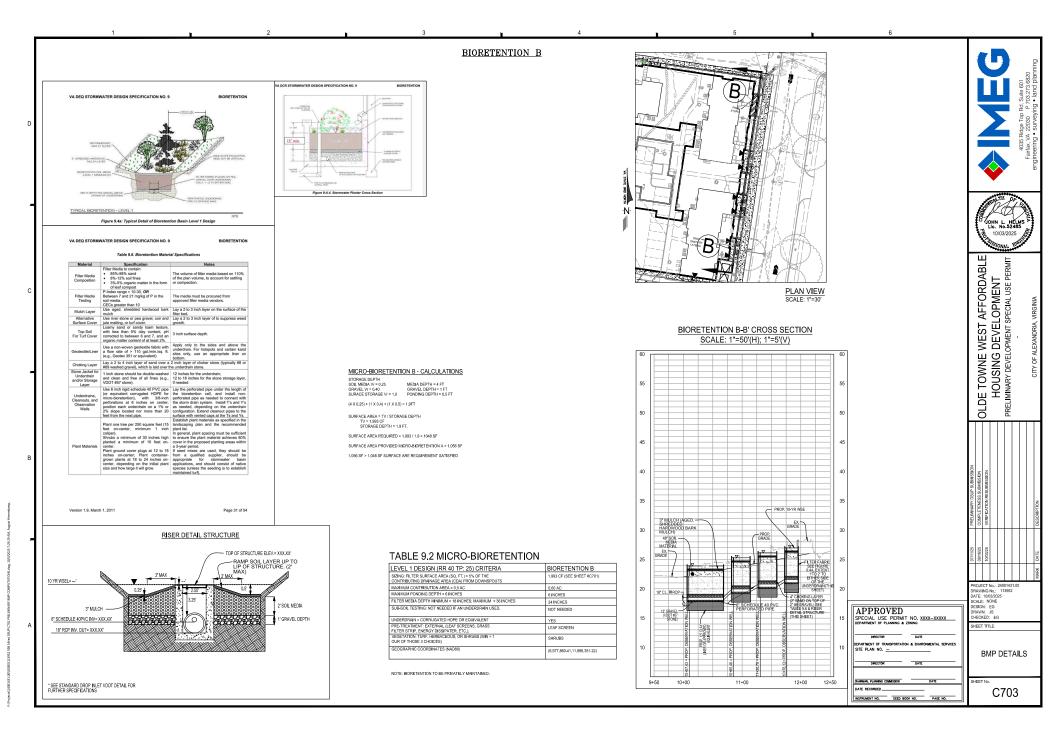

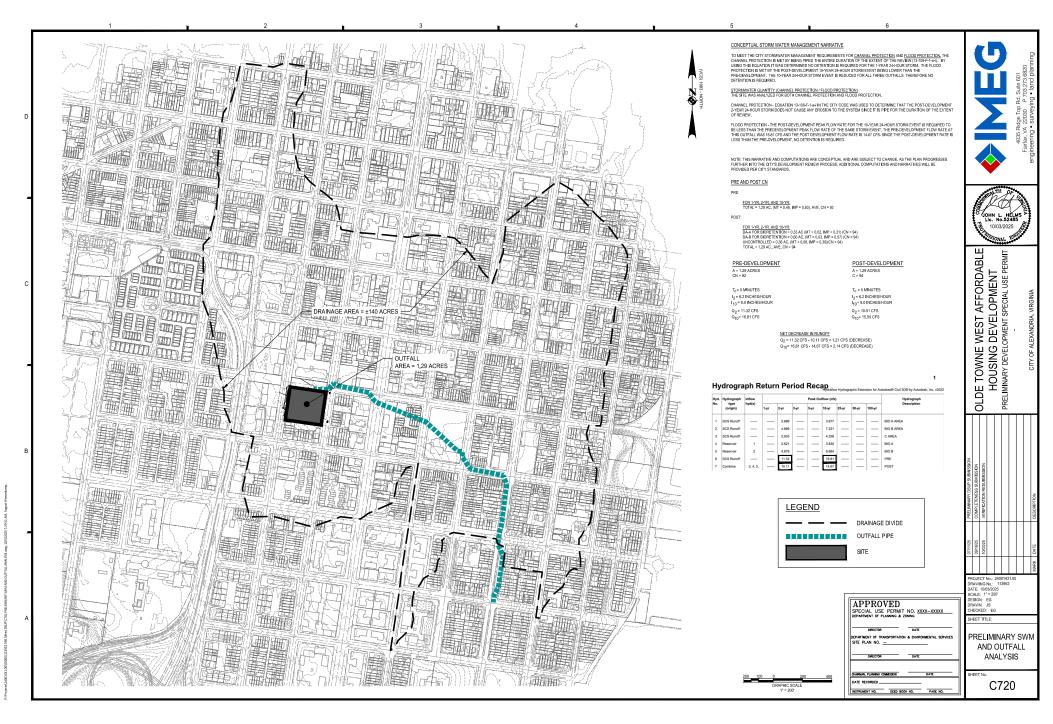


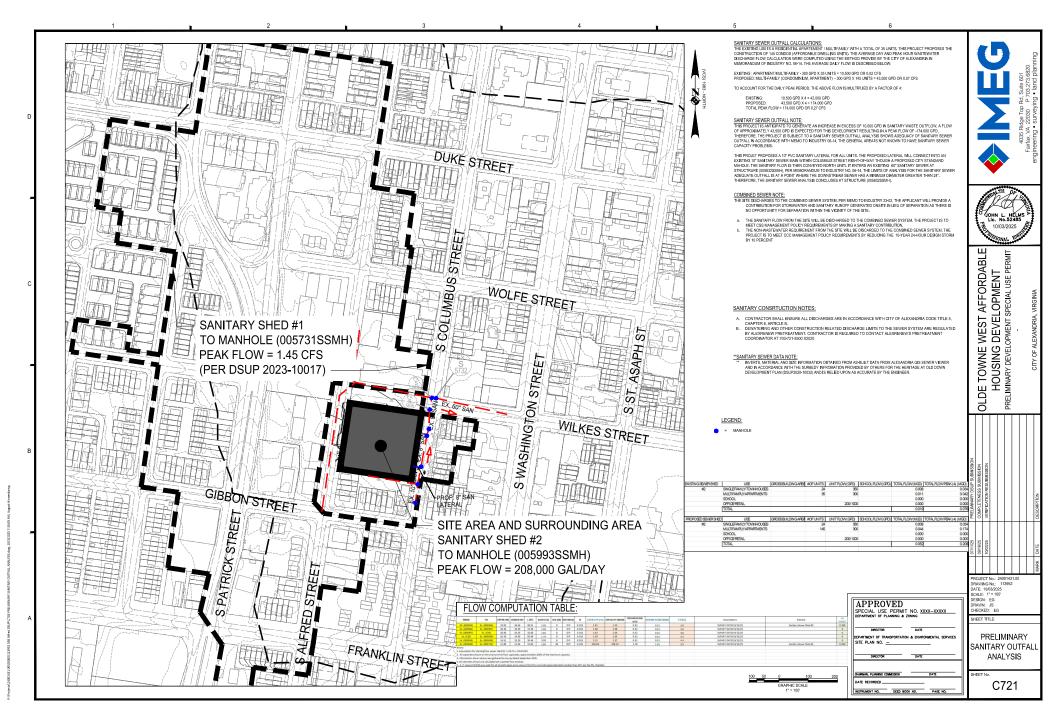


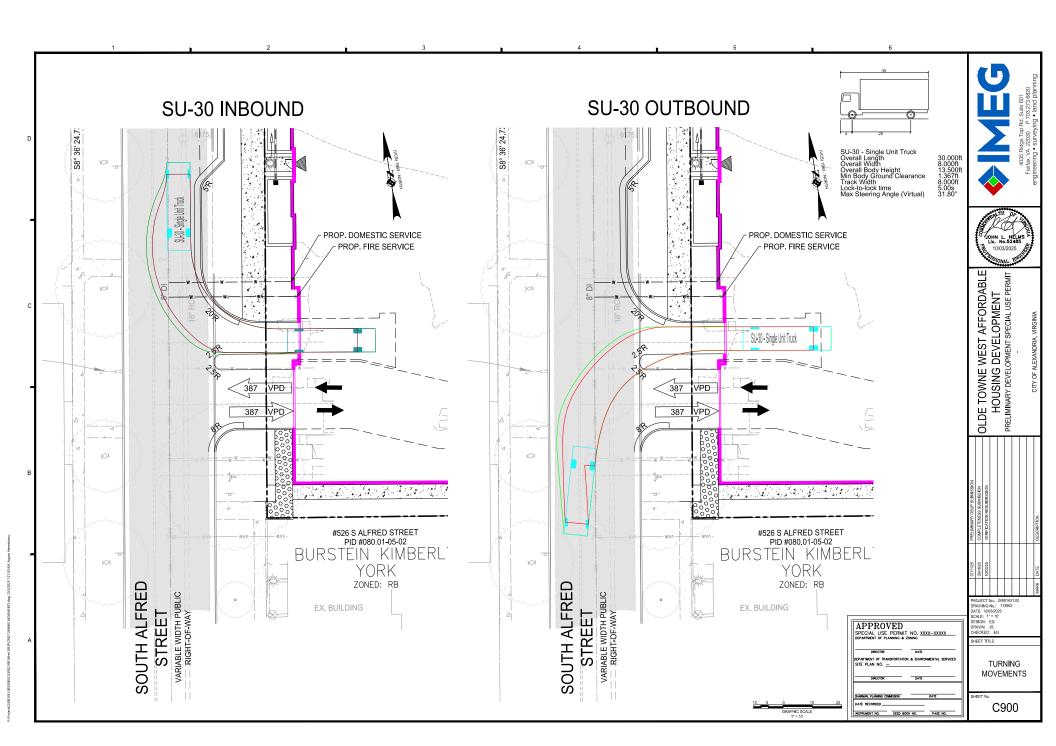


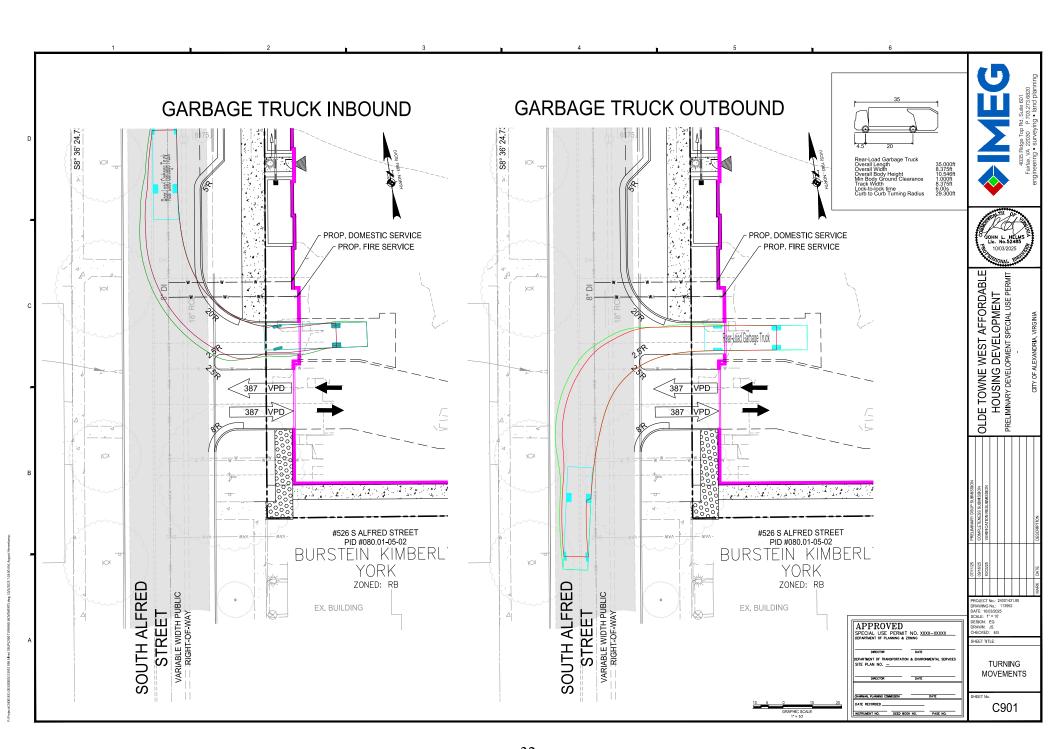




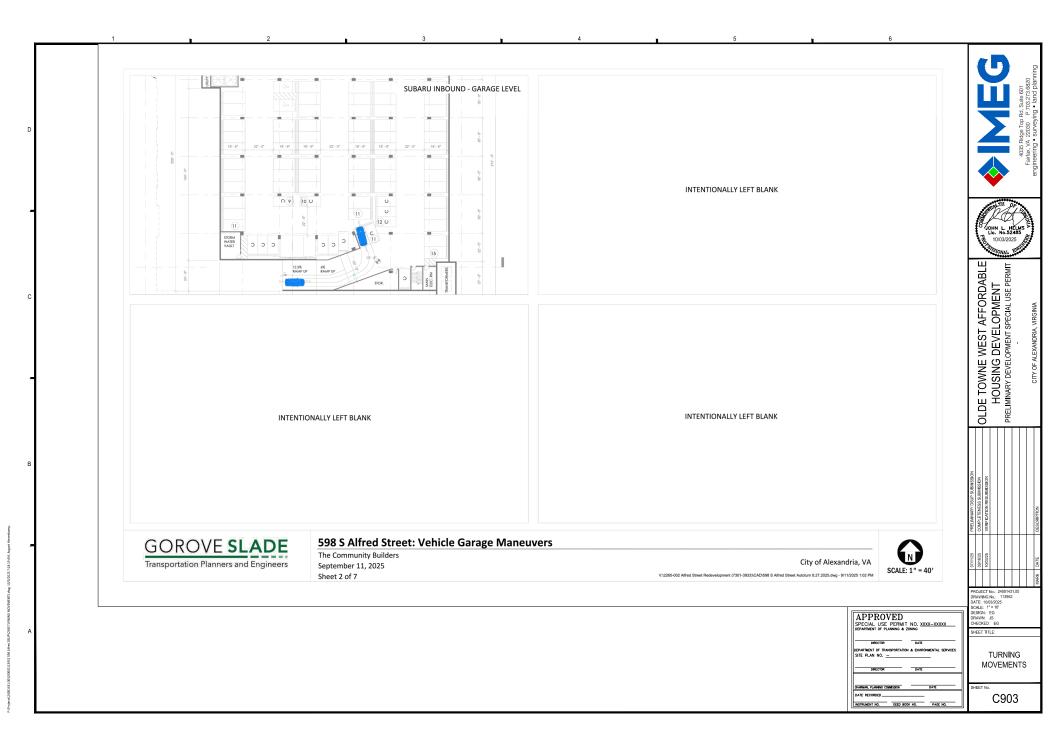


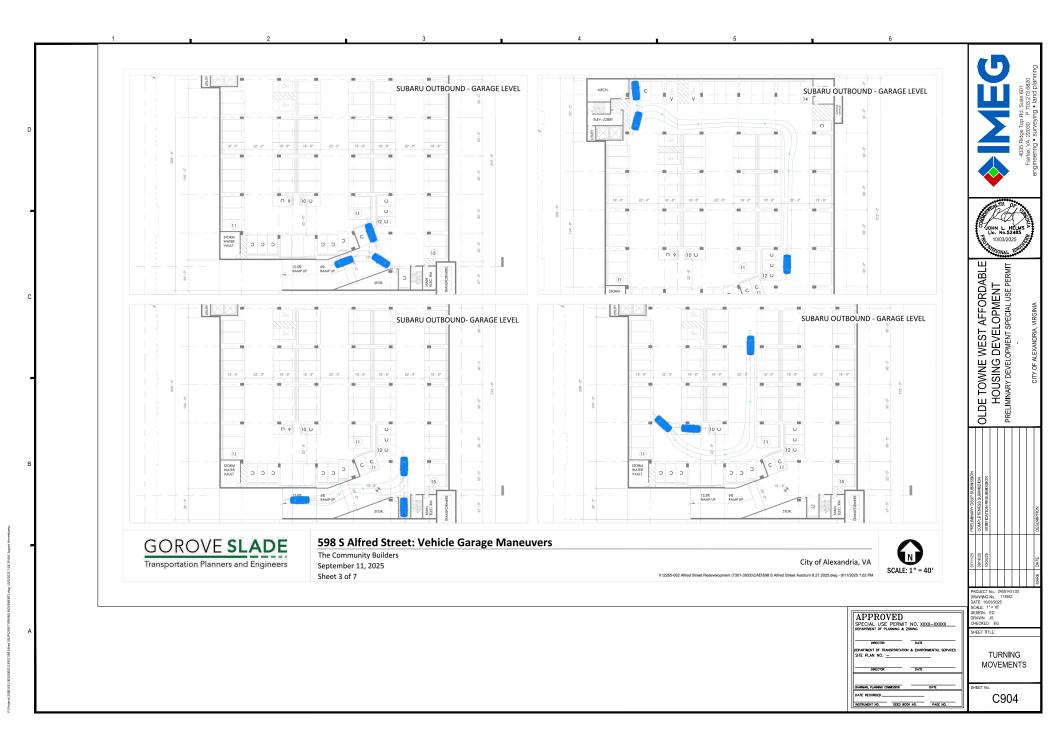


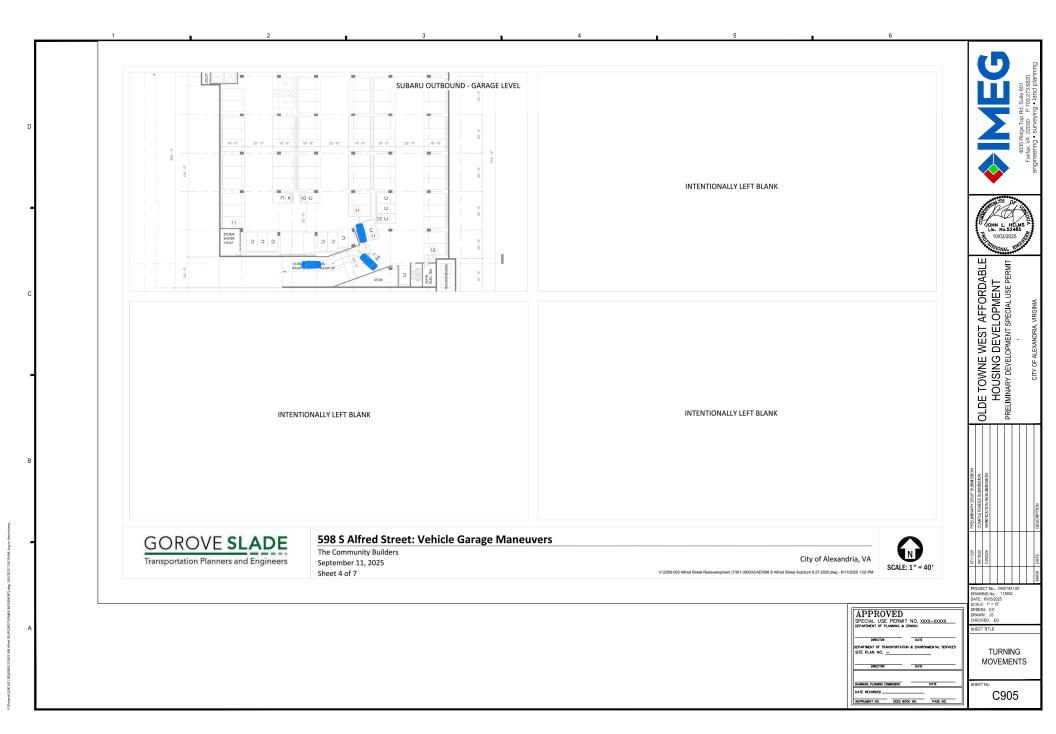





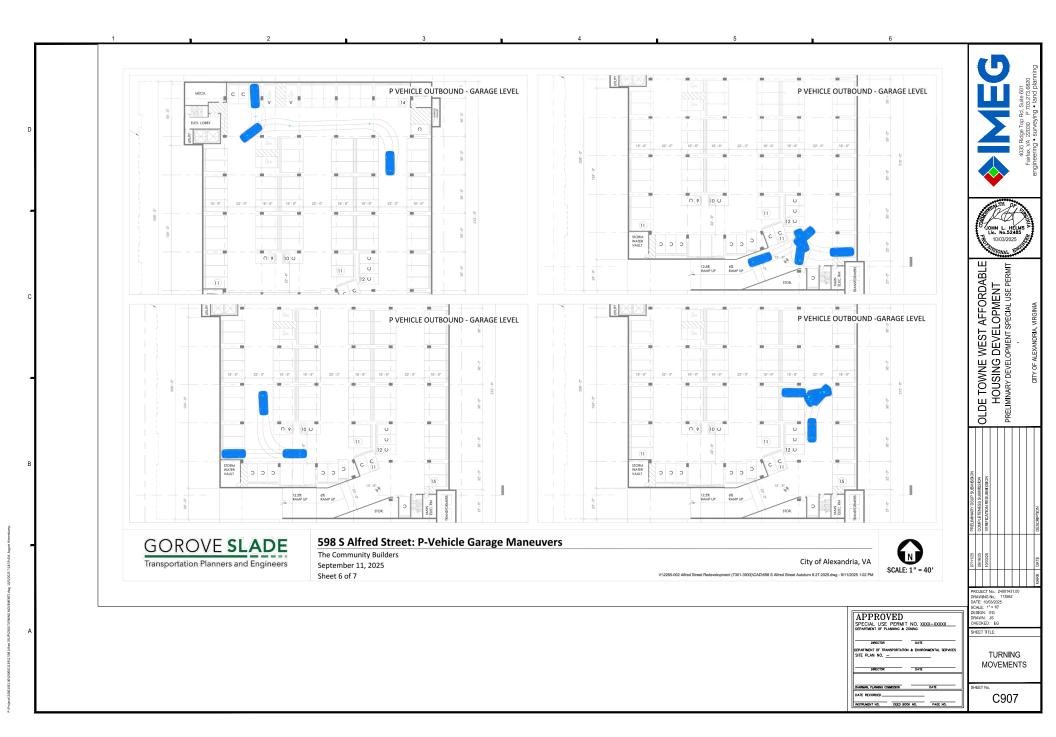


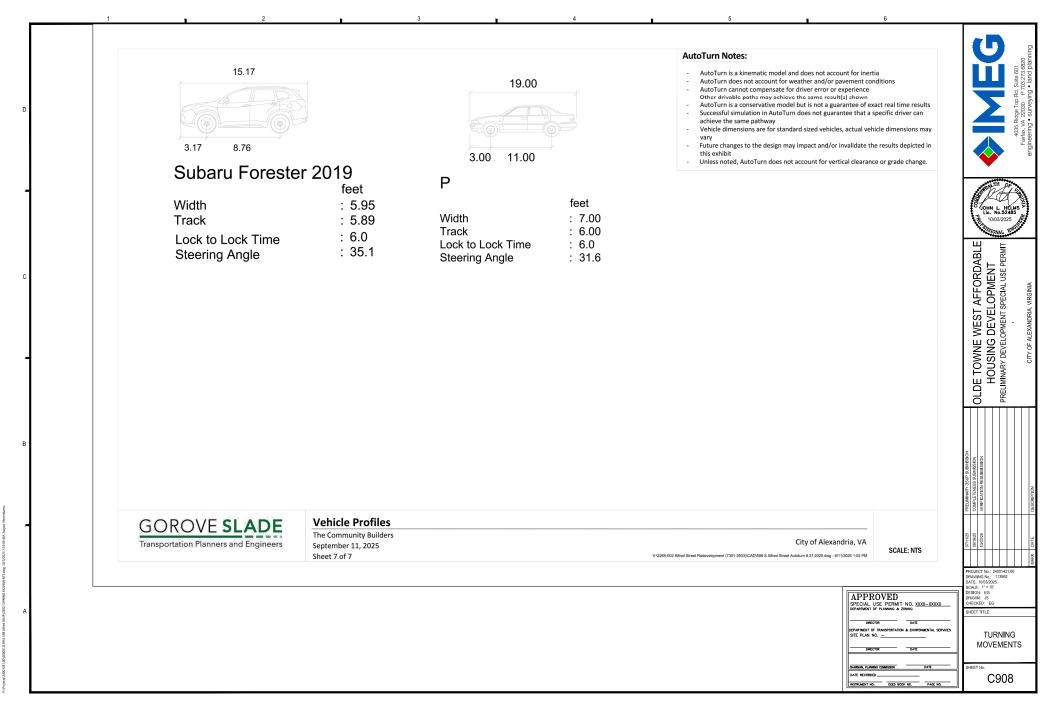

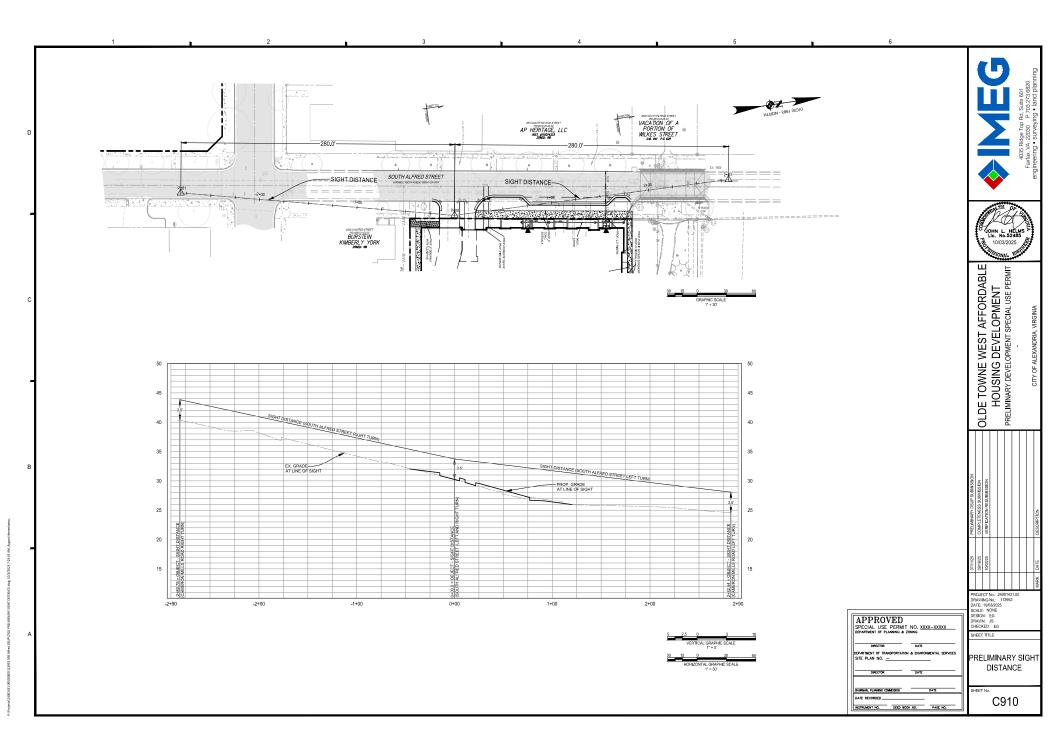

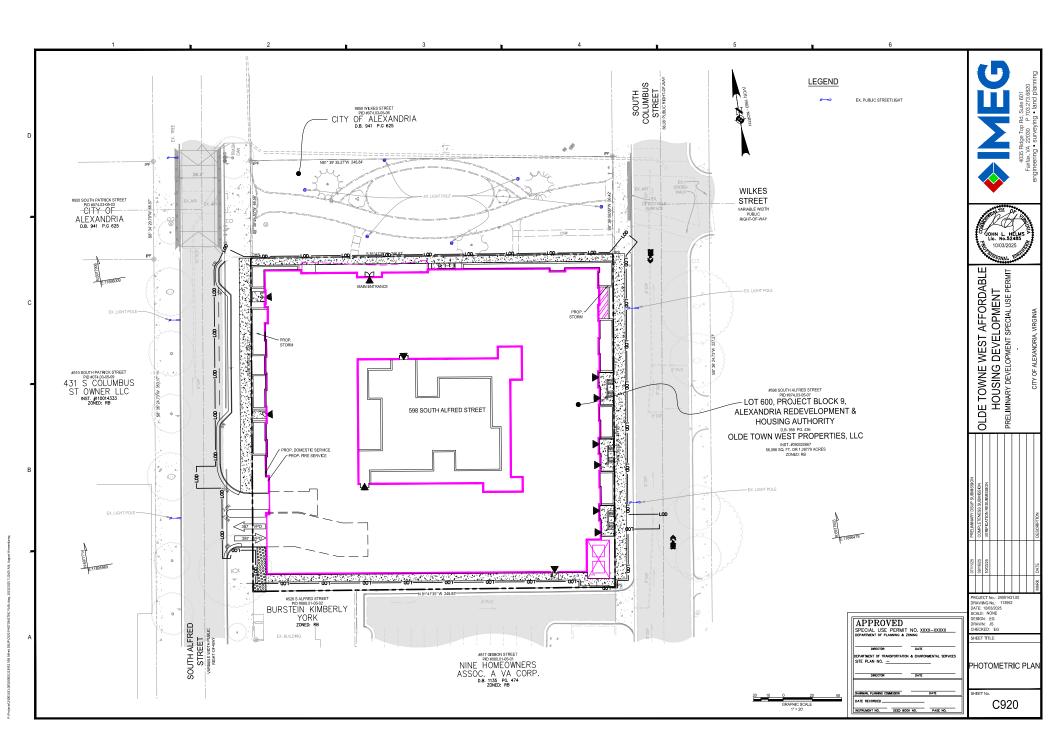

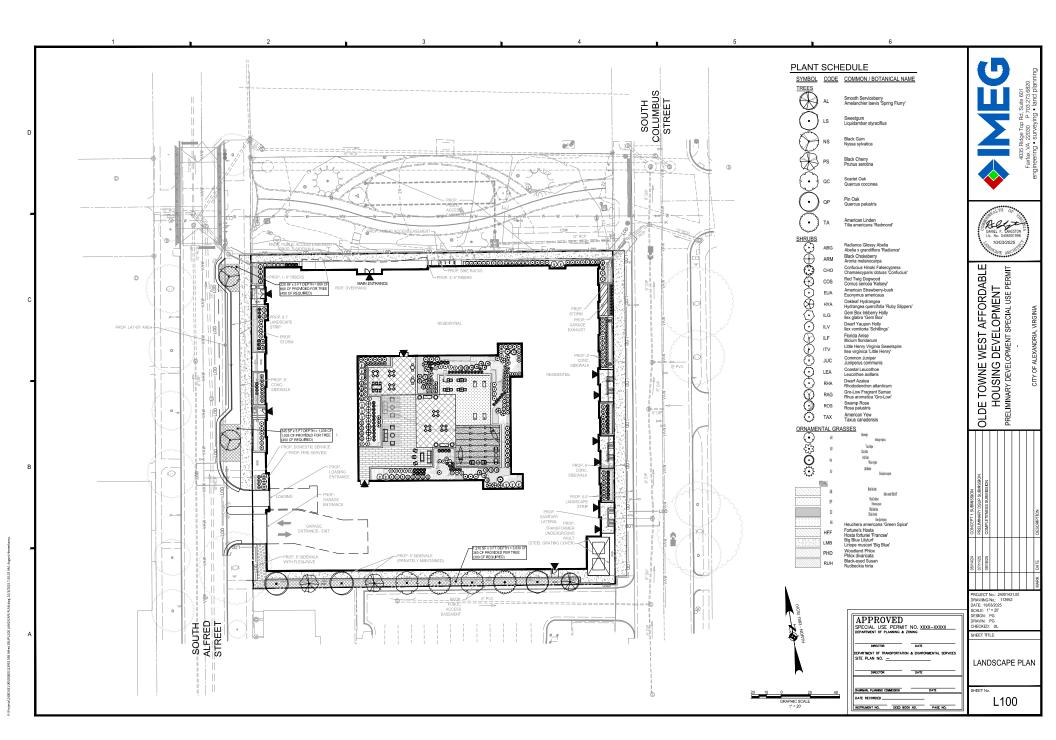

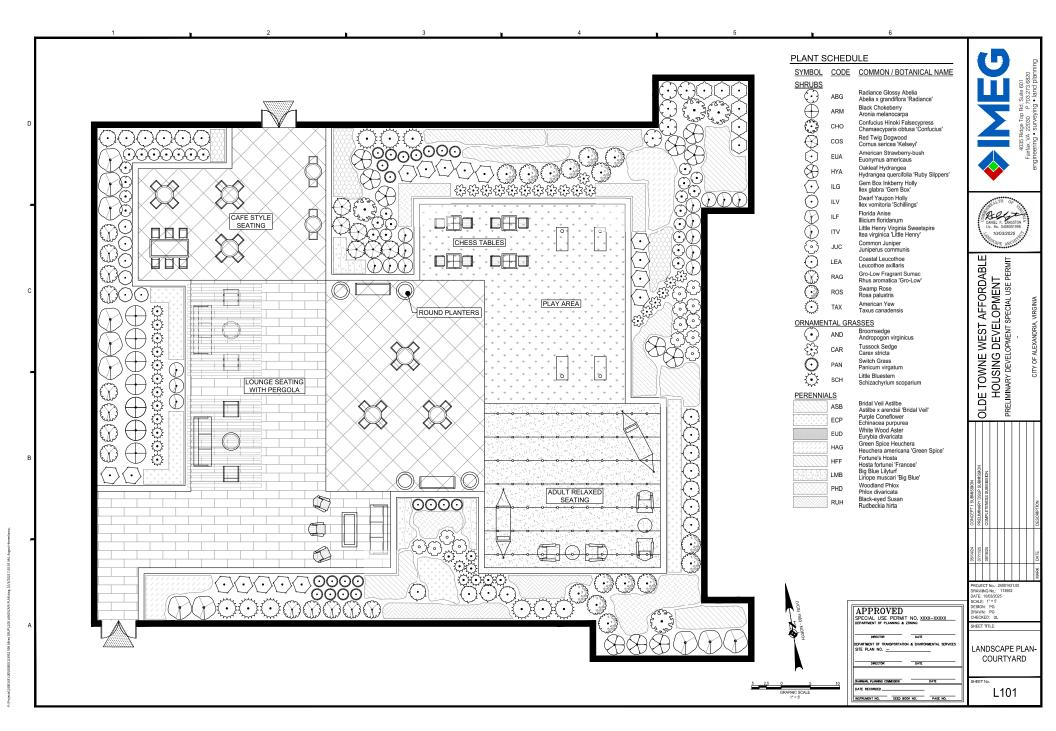

PLANT SCHEDULE PLANT TYPE PLAN INFORMATION BOTANIC/COMMON NAME SIZE NOTES CROWN COVER ALLOWANCE (CCA) NATIVE PLANTS PROVIDED CCA PER TREE (SF) TOTAL CROWN LOCAL/ EASTERN TOTAL QUANTITY SPECIES VAR./CULTIVAR/HYBRID COMMON NAMI CALIPER/HEIGHT ONAL (#) U.S. (#) 2.5"cal./12-14 ft. ht. TOTALS URBAN TREE CCA: 1,500 100.0% 100.0% 100.0% TOTAL CROWN LOCAL/ EASTERN PLAN KEY QUANTITY COMMON NAME CALIPER/HEIGHT COVER (SF) EGIONAL (#) U.S. (#) 2.5"cal./12-14 ft. ht. Spring Flurry Smooth Servicehern Multi-trunk Sweet Gum Black Cherry Scarlet Oak Multi-trunk Symmetrical, single leader Symmetrical, single leader Symmetrical, single leader 1,250 750 1,250 1,250 1,250 1,500 2,500 2,500 STANDARD TREES Pin Oak Symmetrical, single leade 2.5"cal./12-14 ft. ht mmetrical, single leade TOTALS 10 STANDARD TREE CCA: 11,000 TOTAL PROPOSED 12,500 CCA (SF): LOCAL/ EASTERN EGIONAL (#) U.S. (#) TOTAL CROWN CCA PER SHRUBS(SE) TOTAL VAR./CULTIVAR/HYBRID SIZE/CONT 18" HT 18" HT COVER (SF) Radiance Glossy Abelia Confucius Hinoki Falsecypr x grandiflora obtusa Radiance Confucius EUA ILG ILV ILF JUC TAX 18" HT 18" HT 18" HT 18" HT 18" HT American Strawberry-bush Gem Box Gem Box Inkberry Holly Dwarf Yaupon Holly Florida Anise American Yew TOTAL PROPOSED TOTALS 112 1280 CCA (SF): 74.1% 85.7% TOTAL CROWN LOCAL/ EASTERN CCA PER SHRUBS(SF) TOTAL PLAN KEY QUANTITY SPECIES VAR./CULTIVAR/HYBRID COMMON NAME SIZE/CONT COVER (SF) 18" HT
18" HT Black Chokeberry Red Twig Dogwood Oakleaf Hydrangea 12 ARM
COS
HYA
ITV
LEA
RHA
RAG
ROS melanocarp sericea quercifolia Cornus Hydrangea Itea Leucothoe 450 275 230 170 120 500 Ruby Slipper 23 17 12 20 virginica axillaris atlanticum Little Henry Virginia Sweetspire Coastal Leucothoe Dwarf Azalea Gro-Low Fragrant Suma Gro-Low 19 121 91.7% 132 TOTALS 2055 CCA (SF): LOCAL/ EASTERN PLAN KEY QUANTITY SPECIES VAR./CULTIVAR/HYBRID COMMON NAME SIZE/CONT EGIONAL (#) U.S. (#) 1 quart 1 quart 1 quart 1 quart @24" o.c. @24" o.c. @24" o.c. @24" o.c. @24" o.c. 51 Tussock Sedge Bridal Veil Astilbe @18" o.c. 86 111 61 64 0 ASB ECP EUD HAG HFF LMB PHD RUH 86 111 61 64 62 78 115 Bridal Veil @18" o.c. @18" o.c. @24" o.c. @24" o.c. @24" o.c. Echinacea purpurea divaricata Purple Coneflower White Wood Aster 1 quart Eurybia Heuchera Hosta Liriope Phlox White Wood Aster Green Spice Heuchera Fortune's Hosta Big Blue Lilyturf Francee Big Blue 0 @15" o.c. Black-eved Susan @18" o.c. TOTALS 801

CROWN COVER TABULATI	ONS
TOTAL SITE AREA (SF)	56,098
25% CROWN COVER REQUIRED (SF)	14,024
PRESERVED CROWN COVER (SF)	
Crown Cover from Preserved Trees:	0
PROPOSED CROWN COVER (SF)	
Crown Cover from Proposed Trees:	11,000
Crown Cover from Proposed Shrubs:	3,335
TOTAL CROWN COVER PROVIDED (%)	25.6%
TOTAL CROWN COVER PROVIDED (SF)	14,335

QTY. PERCENT OF TOTAL MAXIMUM PERCENT

ALLOWED

PROPOSED

NOTE: PER APPROVED LANDSCAPE GUIDELINES CHAPTER 3, CANOPY COVERAGE STANDARDS 8, STREET TREES OR OTHER PLANTINGS IN PUBLIC R.O.W. DO NOT APPLY TOWARD CROWN COVERAGE ALLOWANCES.

GENERAL NOTES:

1. ALL MATERIALS SPECIFICATIONS SHALL BE IN ACCORDANCE WITH THE INDUSTRY STANDARD FOR GRADING PLANT MATERIAL. THE AMERICAN STANDARD FOR NURSERY STOCK, MISS (260, 1).

2. MAINTENANCE OF ALL TREES AND LANDSCAPE MATERIALS SHALL.

MAIN LEMANCE OF ALL TREES AND LANDISCAPE MAI ENTALS SHALL CONFORM TO ACCEPTED INDUSTRY STANDARDS SET FORTH BY THE LANDSCAPE CONTRACTORS ASSOCIATION, AMERICAN SOCIETY OF LANDSCAPE ARCHITECTS. THE INTERNATIONAL SOCIETY OF ARBORICULTURE AND THE AMERICAN NATIONAL STANDARDS INSTITUTE.
3. PLANT SIZES ARE MINIMUMS AS REQUIRED BY THE CITY OF ALEXANDRIA LANDSCAPE GUIDELINES.
4. TOTAL DISTURBED AREA IS 62,258 SF OR 1.43 AC.

1	
	APPROVED SPECIAL USE PERMIT NO. XXXX—XXXXX DEPARTMENT OF PLANNING & ZONNING

CHARMAN, PLANNING COMMISSION DATE RECORDED INSTRUMENT NO. DEED BOOK NO. PAGE NO.

PLANT TYPE QUANTITY	OHANTITY	NATIVE TYPE	NATIVE TYPE REQUIRED PROVIDED REQUIRED		PROVIDED		REQUIRED	PROVIDED			
	quantili		%	QTY.	%	%	QTY.	%	%	QTY.	%
Urban Trees	2	Regional/Local	10%			15%			20%	2	100.0%
Orban frees	2	Total Natives	25%			25%			50%	2	100.0%
Standard Trees	10	Regional/Local	15%			25%			40%	10	100.0%
Standard Trees	10	Total Natives	40%			60%			80%	10	100.0%
Evergreen	112	Regional/Local	5%			8%			10%	83	74.1%
Shrubs	112	Total Natives	20%			30%			40%	96	85.7%
Deciduous	132	Regional/Local	10%			15%			20%	121	91.7%
Shrubs	132	Total Natives	40%			60%			80%	132	100.0%
iroundcovers		Regional/Local	5%			10%			10%		
roundcovers		Total Natives	10%			20%			20%		
Perennials, Ferns, Ornamental Grasses	801	Regional/Local	10%			15%			25% (perennials) 30% (ferns & grasses)	661	82.5%
		Total Natives	25%			40%			60% (perennials) 80% (ferns & grasses)	661	82.5%
Vines		Total Natives	80%			100%			100%		
				T	DTALS						
TOTAL PLANT	S SPECIFIED	TOTAL SUM C	F REGIONAL/LOCAL	NATIVE PLANT	s		TOTA	L SUM OF	NATIVE PLANTS		
	_		877					9	01		
1057 83.0%					85.2%						
OTES:											
		uantity of each plant type						during the	listed time frames.		
		urposes of providing edible						ed require	ments for native species	regardles	s of plant
ype.											

NATIVE PLANT TABULATIONS

MARCH 2, 2019 – JANUARY 1, 2020 JANUARY 2, 2020 – JANUARY 1, 2024 BEGINNING JANUARY 2, 2024

Ameiancher		0.379	33%	laevis spring riumy		0.379	10%
Nyssa	2	16.7%	33%	sylvatica	2	16.7%	10%
Liquidambar	1	8.3%	33%	styraciflua	1	8.3%	10%
Prunus	2	16.7%	33%	serotina	2	16.7%	10%
Quercus	4	33.3%	33%	coccinea	2	16.7%	10%
				palustris	2	16.7%	10%
Tilia	2	16.7%	33%	americana 'Redmond'	2	16.7%	10%
SHRUBS					_		
TOTAL NUMBER	OF SHRUB	S PROPOSED:	244				
GENUS	QTY.	PERCENT OF TOTAL PROPOSED	MAXIMUM PERCENT ALLOWED	SPECIES	QTY.	PERCENT OF TOTAL PROPOSED	MAXIMUM PERCENT ALLOWED
Abelia	12	4.9%	33%	x grandiflora 'Radiance'	12	4.9%	10%
Aronia	12	4.9%	33%	melanocarpa	12	4.9%	10%
Chamaecyparis	4	1.6%	33%	obtusa 'Confucius'	4	1.6%	10%
Cornus	18	7.4%	33%	sericea 'Kelseyi	18	7.4%	10%
Euonymus	20	8.2%	33%	americaus	20	8.2%	10%
Hydrangea	11	4.5%	33%	quercifolia 'Ruby Slippers'	11	4.5%	10%
llex	27	11.1%	33%	glabra 'Gem Box'	16	6.6%	10%
				vomitoria 'Schillings'	11	4.5%	10%
Illicium	13	5.3%	33%	floridanum	13	5.3%	10%
Itea	23	9.4%	33%	virginica 'Little Henry'	23	9.4%	10%
Juniperus	21	8.6%	33%	communis	21	8.6%	10%
Leucothoe	17	7.0%	33%	axillaris	17	7.0%	10%
Rhododendron	12	4.9%	33%	atlanticum	12	4.9%	10%
Rhus	20	8.2%	33%	aromatic 'Gro-Low'	20	8.2%	10%
Rosa	19	7.8%	33%	palustris	19	7.8%	10%
Taxus	15	6.1%	33%	canadensis	15	6.1%	10%

BIODIVERSITY TABULATIONS

SPECIES

PERCENT OF TOTAL MAXIMUM PERCENT

ALLOWED

PROPOSED

PROJECT No.: 24001431.00 DRAWING No.: 113952 DATE: 10/03/2025 SCALE: NOT TO SCALE DESIGN: PG DRAVIN: PG CHECKED: DL SHEET TITLE: DEPARTMENT OF TRANSPORTATION & ENVIRONMENTAL SERVICES SITE PLAN NO. \_\_\_\_\_ LANDSCAPE SCHEDULE AND CALCULATIONS L200

TREES (URBAN AND STANDARD) TOTAL NUMBER OF TREES PROPOSED:

QTY.

IMEG Corp. General Landscape Specification Summary

Specification: This is a summary of IMEG, Corp. general landscape specification. All work shall follow the procedures outlined in the specifications and details ontained herein, which are designed to exceed current industry standards. Should there exist a discrepancy between this specification and the included construction details, the written specification shall take precedence.

References: In lieu of providing comprehensive proprietary specifications, the following are referenced to be general default specifications with the following modifications. These modifications and the construction details shown in this plan set shall take precedence over the general referenced specifications.

- "Landscape Specification Guidelines" Landscape Contractors Association of MD, DC, VA Most current edition,
- "American Standard for Nursery Stock ANSI Z60.1" by AmericanHort Most Current Edition
- "TT-77 Recommended Turforass Cultivars for Certified Sod Production in Maryland" Maryland Turforass Council
- "Landscape Architecture/Design Specifications for Compost Use" US Composting Council

If there are discrepancies or contradictions in specification sections or details, the stricter specification shall take precedence. A Request for Information (RFI) can also he submitted for clarification

Representative. The Contractor shall furnish and instal all plant materials required to complete the work as shown on the drawings. Quantities in the planting schedule shall take precedence over quantities graphically shown on the plan. Substitutions shall not be made without the written approval of the Owner

Plant Identification: All trees shall be true to name as on plant schedule or shown on planting plans and shall be correctly labeled individually or in groups by genus, species, variety and cultivar. Labels are to remain intact until site is approved through agency inspection, substantial completion approval, or per Owner.

ANSI Z60.1". Above Ground: Trees shall be healthy with the color, shape, size, and distribution of trunk, stems, branches, buds and leaves typical of the plant specified. Any signs of stress, improper handling (wounds or broken branches), insect or disease damage, or dead/distorted branches should not be present. Trees shall have one central leader (unless otherwise specified) and grafts should be fully closed and visible above the soil line. Below Ground: A minimum of 3 structural oots should be reasonably distributed around the trunk (reject a tree with structural roots only on one side), the root crown should not be more than 2 inches below the soil line, the top 2 structural roots should not be more than 3 inches below the soil line when measured 4 inches away from the trunk. The top of the other structural root should not be more than 5 inches below the surface. The root system should be free of potentially stem-girdling or kinked roots above the root collar and main structural roots.

Inspection: Plants are to be inspected upon delivery to contractor by a contractor's representative and/or owner's representative. Trees not presenting proper form, rrect variety, signs of poor health or over-stress, and girlding roots are to be rejected.

Storage & Transport: Plant materials should be protected from dessication during transport via breathable fabric covering the canopy and by watering rootball/pot thoroughly immediately prior to transport. Plant materials should be installed on day of delivery to site. If that is not possible, a temporary storage area can be constructed on-tile. Plants are not to be stored on bear sightle. If storage area is asphalt, cover breas asphalt with a layer of woodships. Storage should be in sharbs, and plants be regularly watered at not-foull level, and spaced so foliage from one plant does not interfer so with foliage of another. Tall plant materials are to remain uporigit during storage. Longer forms storage plants are to be heeled-in or storage in materials are to a continuation of the containemoto stall. Plant materials shall not be remain uporigit during storage. Longer forms storage plants are to be heeled-in or storage in materials are to a containemoto stall. Plant materials shall not be remain uporigit during storage. stored on-site for more than two weeks. Plants stored improperly or for too long may be subject to rejection and replacement dependent on ultimate planting

Planting: Plantings shall be installed in accordance with details and specifications on this sheet. Details and specifications for other specific landscape items, such as tree preservation or erosion control may be found elsewhere in this drawing set on their own respective sheet. For items not specifically addressed by this plan set, refer to the latest edition of the "Landscape Specification Guidelines" developed by the Landscape Contractors Association of MD, DC, and VA. Should there be any ambiuguities or questions, please utilize the formal RFI/Submittal process.

Trees: The planting hole diameter is to be at a minimum three times the diameter of the root ball. The depth of the planting hole shall be dug so that the shoulder of the cost dall is level with the existing grade leaving the root their slightly higher. When planning on a slope, the depth of the hote shall be dug so that the bottom of the root flare is at the level of the existing grade at the sixtles of the hote. If the planning hote is mechanically dug, the hote is to be scarling by slightly entanging hote by hand digging the addes and bottom to prevent glazing. The sixtles of the hote should be vertical or alsoping outwards. Hotes are not to be dug when soil is aturated. For balled and burlapped trees, the wire root ball cage is to be removed and burlap is to be out and completely removed from the top and a minimum of 8" to 12" down the side of the root ball. Do not fold buflap down into hole, it must be removed. Any synthetic materials are to be completely removed from the trunk and root ball. Backfill in lifts using the same soil dug to create the hole, being careful not to over-compact the soil. Inoculate backfill soil or rootball with an approved balanced (Endo/Ecto) commercial mycorrhizae application. Do not amend or add fertilizer unless expressly specified to do so or is part of the approved mycorrhizae nnoculant product. Do not place any soil on top of root ball. Trees are to be mulched to full depth specified immediately after planting. A 1/2 layer of approved compost is to be placed under the mulch layer. Do not place mulch against tree trunk.

Staking: Staking (if any) is to be installed per the accompanying details, utilizing tree webbing straps with grommets to prevent wire from coming in contact with the tree. While not preferred, full tree webbing systems are also permissible if approved through submittal, and installed per manufacturer's instructions. Wire is to be tensioned to allow for 1/2 inch of deflection up or down, and tension shall be rechecked and adjusted on a regular basis. Staking is to be removed as soon as possible after one year. GARDEN HOSE IS NOT TO BE UTILIZED FOR STAKING.

Irrigation: For permanent systems, irrigation should be largely installed prior to plant installation to avoid having to disturb planting beds or move plants to insignation to permiserant agreement ingestion instruction and the large visitoring instruction principles and instruction and of the imaginor ingestion in the large visitoring the large visitoring the large visitoring v temporary irrigation (sprinklars or drip hose) as necessary to reflect local weather conditions. Watering is to be deep into the soil and infrequent, as opposed to light

Shrubs; For container shrubs, the planting hole is to be dug 3 times the width of the intact container. The container is to be completely removed and the sides of the soil root clump scarified with a sterile sharp knife. They shall be planted so that the top of the soil level of the container is no more than 1.5" above the original rade. For balled and burlapped shrubs, remove as much burlap as possible from the top and sides of the rootball. Do not fold burlap into hole. Plant with the root flare slightly higher than the surrounding grade. Backfill with soil dug to create the hole. Do not cover top of root ball/clump.

Ground Covers/Perennials: Beds are to be prepared by tilling well to a minimum depth of 6", and soils shall be amended by incorporating 1" of compost meeting the US Composting Council reference specification, 1" of worm castings and/or well decomposed commercially produced compost, or a Class A biosotid also meeting the referenced US Composting Council specification prior to planting. Apply 3" of shredded non-dyed hardwood mulch immediately after planting.

Compacted or Poorly Drained Soils: For sites with heavily compacted or poorly draining soils, alternate planting methods will need to be employed. Contact project Landscape Architect for additional planting details and specifications should either unforeseen condition be encountered.

Conflicts with Existing Roots: Proposed landscape may be shown to be planted in the Critical Root Zones of existing large trees. Should, in the course of planting, large woody roots be discovered belonging to adjacent large trees that are to be preserved, shift the planting location of the tree to be planted to avoid cutting the woody root. Should a suitable planting location not be found within the proximity of where a proposed tree is to be planted, contact the project landscape architect for alternate planting location and recording of the discrepancy for landscape inspection/approval purposes.

Irrigation: New plant materials are to be watered as necessary to maintain health. If no permanent irrigation system is installed, trees are to be watered until established through the use of temporary water bags. Shrubs, perennials, and ground covers shall be hand-watered. Infrequent deep watering is preferred to more frequent quick/shallow watering.

eded Lawn Area: Areas to be seeded shall have planting soil tilled to a depth of 6" and free of stones greater than 1" diameter or length. Any amendments that are to be added should be tilled into soil prior to seeding. A seed mix composition chart shall be submitted for review prior to installation. Unless specified by the Owner's Representative, the seed mix must contain a minimum of three cultivars or types of grass in the blend, chosen from the recommended cultivars lot of the most recent "TT-77 Recommended Turfgrass Cultivars for Certified Sod Production in Maryland" document produced by the University of Maryland and the Maryland Turforass Council. Use of cultivars also appearing on the Turforass Water Conservation Alliance approved list is encouraged. Seeds coatings that aid in permination, moisture retention and prevent loss to bird consumption are acceptable. Seeded areas are to be covered by a light and loose layer of rapidly degradable mulch such as straw or hydraulically applied cellulose. Use of erosion control blankets or any synthetic webbing is not permissible for lawn areas unle specified by the Owner's Representative.

Sodded Lawn Area: Unless a promietary and is specified by the Owner's Representative, and must be of a Manuland or Virginia certified variety suited to the specific growing requirements of where it is to be installed. Grower and variety to be submitted to Owner's Representative for review prior to ordering. Certification documentation for all sod is to be provided to the Owner's Representative upon delivery. For installation on slopes, the Contractor shall use biodegradable sod spikes to secure sod in place. Metal sod staples are not to be utilized for installation.

Invasive Species: Existing invasive species are to be removed utilizing appropriate approved methods including in the invasive species manage applicable) prior to the installation of new plant materials, and is subject to inspection, and is a factor in the Certification of Installation.

NOTE: These specifications and details are based on those developed by the Urban Tree Foundation, and have been improved to reflect current research and in planting. The ISA has also accepted and reference the UTF details in place of their own. The specifications and details illustrated in this plan set exceed the standards set in the ISA, LCA, and local jurisdictional planting details and specifications

CITY OF ALEXANDRIA STANDARD LANDSCAPE PLAN NOTES:

1. THE PROPERTY OWNER ANDOR APPLICANT, SPECIFIER, CONTRACTOR AND INSTALLER OF PLANT MATERIAL ARE RESPONSIBLE FOR UNDERSTANDING AND ADHERING TO THE STANDARDS SET FORTH IN THE HOST RECENT VERSION OF THE CITY OF ALEXANDRIAL LANDSCAPE GUIDELINES AND APPLICABLE CONDITIONS OF APPROVAL ALL QUESTIONS REGARDING APPLICATION OF, OR ADHERENCE TO, THE STANDARDS AND/OR CON TIONS OF APPROVAL SHALL BE DIRECTED TO THE CITY PRIOR TO COMMENCEMENT OF DEMOLITION, CONSTRUCTION, OR ANY LAND DISTURBING

- ACTIVITY.

  THE CITY-APPROVED CITY-APPROVED LANDSCAPE PLAN SUBMISSION INCLUDING PLANT SCHEDULE. NOTES AND DETAILS SHALL BE THE DOCUMENT USED FOR INSTALLATION PURPOSES AND ALL
- PROCEDURES SET FORTH IN THE LANDSCAPE GUIDELINES MUST BE FOLLOWED.
  THE CONTRACTOR SHALL NOT INTERFERE WITH ANY TREE PROTECTION MEASURES OR IMPACT ANY EXISTING VEGETATION IDENTIFIED TO BE PRESERVED PER THE APPROVED TREE AND

- GATHERSBURG, MARYLAND.

  SUBSTITUTIONS OT THE APPROVED PLANT MATERIAL SHALL NOT OCCUR UNTIL WRITTEN APPROVAL IS PROVIDED BY THE CITY.

  MANTENANCE FOR THIS PROJECT SHALL BE PERFORMED BY THE COWNEY, APPLICANT, SUCCESSORIS) ANDOR ASSIGNS IN PERPETUITY AND IN COMPLIANCE WITH CITY OF ALEXANDRIA

  THE APPROVED BY THE PROJECT SHALL BE PERFORMED BY THE COWNEY, APPLICANT, SUCCESSORIS) ANDOR ASSIGNS IN PERPETUITY AND IN COMPLIANCE WITH CITY OF ALEXANDRIA

  THE APPROVED BY THE PROJECT OF A PROJECT ON MAY BE AN EXPENDED ON THE PROJECT OF A PROJECT ON THE PROJECT ON THE
- CERTIFIES THAT THE PROJECT LANDSCAPE ARCHITECT PERFORMED PRE-SELECTION TAGGING FOR ALL TREES PROPOSED WITHIN THE PUBLIC RIGHT OF WAY AND ON PUBLIC LAND PRIOR TO INSTALLATION. THIS LETTER MUST BE SIGNED AND SEALED BY THE PROJECT LANDSCAPE ARCHITECT, AND 2) A COPY OF THE SOIL BULK DENSITY TEST REPORT VERIFYING THAT MAXIMUM COMPRESSION RATES ARE MET.
- COMPRESSION RATES ARE MET.

  2. ALL CONSTRUCTION WASTE SHALL BE REMOVED PRIOR TO PLANTING.

  13. ALS QUILT DRAWNINGS FOR THIS LANDSCAPE ANDOR IRRIGATION/WATER MANAGEMENT SYSTEM WILL BE PROVIDED IN COMPLIANCE WITH CITY OF A LEXANDRIA LANDSCAPE GUIDELINES, THE CITY

  10. AS QUILT DRAWNINGS IN AD LA PPICAGE LEAVA PREPARATION OF INCECLISTS. AS BUILT DRAWNINGS SHALL INCLUDE CLEAR IDENTIFICATION OF ALL YARIATION(S) AND CHANGES FROM APPROVE

  DRAWNINGS INCLUDING LOCATION, QUANTITY AND SPECIFICATION OF ALL PROJECT ELIBENTS.

  14. AREAS OF BARKS BOLL WILL NOT BE ACCEPTED. MUCLEOR DRAWS AND PLANTING AREAS SHALL BE WEED FREE UPON ACCEPTANCE OF THE PROJECT BY THE CITY

CENTER THEE IN WELL, THUNK FLAKE SHALL BE VISIBLE.

HARDWOOD STAKES

- PLACE TOP OF ROOT BALL FLUSH

-3" MULCH OVER ENTIRE PLANTING BED OR AS APPROVED BY CITY STA

伳

- LOOSEN THE ROOT BALL OF AN

- UNDISTURBED SUBGRADE OR COMPACTED BACKFILL SOL MIXTURE

PEWOVE ALL THINE, SOPE, WIFE,



- 2. CONTRACTOR SHALL MANAGE EXCANATED AREA FOR THEE WELL INTHOUT ADVERSELY IMP LIALESS CHIERWISE ORECTED BY PROJECT SPECIFICATIONS OF CITY STAY, SOL WICLIEF SHALL BE CLEANED
- ALL PLANTS MUST BE WITERED AT INSTALLATION AND AGAIN WITHIN 48-HOURS OF INSTALLATION, ESTABLISHMENT WITERING SHALL BE FIRST THE SPECIFICATIONS ON ALL DETAILS.
- NESKLATON WILL INCLIDE THE FEMONE, OF ALL STAINS MITERAL ONE YEAR AFTER INSTALLATION, ANY HOLES LETT BY REMOVED STAINS SHALL BE FILED WITH APPROVED TOPSOL / BACKFUL WITHER.
- S. CONTRACTOR SHALL USE GAUGNIZED EYESCHEW & TURNBUCKLE INSTEAD OF ARBOR THE ONLY FOR TREES





PLANTING WELL / TRENCH SHALL BE DUG TO ALLOW TOP OF ROOT BALL TO SET FLUSH WITH DISTING GRACE.

SET PLANTS IN EPECT, STABLE, AND UNIFORM POSITIONS, ORIENT BEST FACE OF PLANT TO BE MOST VICINE F.

UNLESS OTHERWISE DIRECTED BY PROJECT SPECIFICATIONS OR CITY STAFF, SOIL MOXTURE SHALL BE CLEANED OF DEBRS, AND MEET SOIL COMPOSITION REQUIREMENTS OF CITY OF

ALL PLANTS MUST BE INTERED AT INSTALLATION AND AGAIN WITHIN 48-HOURS OF INSTALLATION, ESTABLISHMENT WATERING SHALL BE PER THE SPECIFICATIONS ON ALL DETAILS.

A SHRUB PLANTING

PLACE TOP OF ROOT BALL FLUS

FOR CONTAINER: LOOSEN THE ROOT BALL OF ANY ROOT BOLING PLANTS

UNDISTURBED SUBGRADE OR COMPACTED BACKFILL SOIL MIXTURE

- 3" MULCH OVER ENTIRE PLANTING BED





PLANTING WELL / TRENCH SHALL BE DUG TO ALLOW TOP OF ROOT BALL TO SET FLUSH WITH EXISTING GRAPF


SET PLANTS IN ERECT, STABLE, AND UNIFORM POSITIONS, ORIENT BEST FACE OF PLANT TO BE MOST VISIBLE. GROUND COVERS AND PERENNALS SHALL BE INSTALLED WITH TRANSULAR SPACING, REFEL


UNLESS OTHERWISE DIRECTED BY PROJECT SPECIFICATIONS OR DITY STAFF, SOL MIXTURE SHALL BE CLEANED OF DEBRIS, AND MEET SOIL COMPOSITION REQUIREMENTS OF DITY OF ALEXANDRIA LANDSCAPE GUIDELINES.

ALL PLANTS MUST BE WATERED AT INSTALLATION AND AGAIN WITHIN 48-HOURS OF INSTALLATION, PER THE SPECIMENTAME.


A GROUNDCOVER & PERENNIAL PLANTING

TRIANGULAR SPACING PLAN & CHART

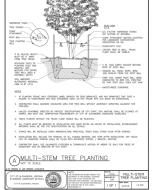

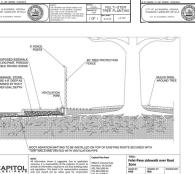

CAPITOL	NOTE: All information shown is suggested. Due to application sarfances, it is responsibility of the engineer of record to provide all information required to sait soul building codes	Capital Flex-Pave 99024 E Colonial Mary Hamilton, VA 20158	Fet Zor	
	and regulations. This detail is for representative purposes only and should not be solely used for construction	202,763,1099 Ph 571,383,7000 Ph 573,312,9238 Fs	HAR	
	purposes unless it has been certified and sealed by a qualified engineer.	www.capitolorepreservation.com www.capitoloolutionsgroup.com	03-C	
	repirements, all details shall be constructed in accordance with such local detail construction shown in drawing. Capital Solutions Group, recovers the	© Capital Solutions Group 2018		

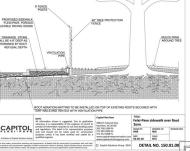



INSTRUMENT NO. DEED BOOK NO. PAGE NO.

2-1-1-2

SET ANGLE 1/2"-1/4" SELOW TOP

STREET TREE PLANTING WELL

- CENTER TREE IN Y TRUNK FLARE SHA BE VISIBLE.

STREET TREE





AFFORDABL ELOPMENT SPECIAL USE PE E TOWNE WEST A HOUSING DEVELC IINARY DEVELOPMENT SPI HOUS 7


ROJECT No.: 24001431.01 AWING No : 113952 HECKED: DI

CALE: NOT TO SCALE SHEET TITLE:

LANDSCAPE SPECIFICATIONS AND DETAILS

L300

45

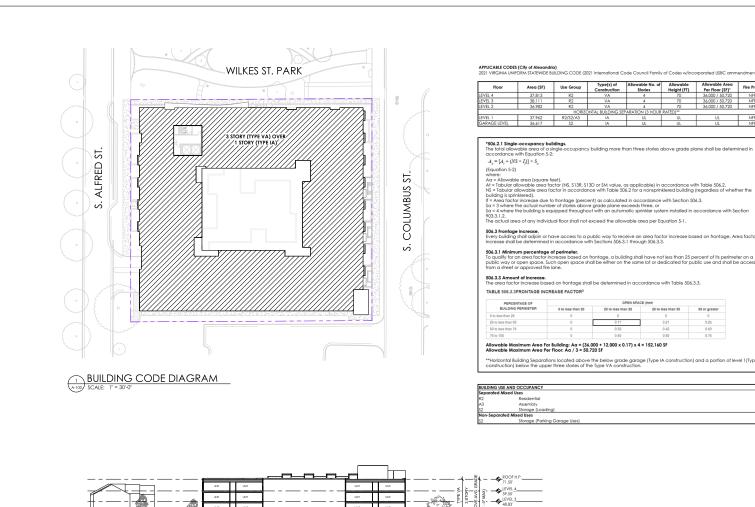

APPLICABLE CODES (City of Alexandria)
2021 VIRGINIA UNIFORM STATEWIDE BUILDING CODE (2021 International Code Council Family of Codes w/incorporated USBC ammendments)

Floor	Area (SF)	Use Group	Type(s) of Construction	Allowable No. of Stories	Allowable Height (FT)	Allowable Area Per Floor (SF)*	Fire Protection		
LEVEL 4	37,813	R2	VA	4	70	36,000 / 50,720	NFPA 13		
LEVEL 3	38,111	R2	VA	4	70	36,000 / 50,720	NFPA 13		
LEVEL 2	36,982	R2	VA	4	70	36.000 / 50.720	NFPA 13		
	HORIZONTAL BUILDING SEPARATION (3 HOUR RATED)**								
LEVEL 1	37,962	R2/S2/A3	IA	UL	UL	UL	NFPA 13		
GARAGE LEVEL	36,617	\$2	IA	UL	UL	UL	NFPA 13		

\*506.2.1 Single-occupancy buildings.
The total allowable area of a single-occupancy building more than three stories above grade plane shall be determined in accordance with Equation 5-4.

50s.3 Frontage Increase.
Every building shall adjoin or have access to a public way to receive an area factor increase based on frontage. Area factor increase shall be determined in accordance with Sections 50s.3.1 through 50s.3.3.

50.3.3 Mishimum percentage of perimeter.
10.2.3 Mishimum percentage of perimeter on a public way or open space. Such open space shall be either on the same lot or dedicated for public way or open space. Such open space shall be either on the same lot or dedicated for public use and shall be accessed from a steet or approved fer lane.

IABLE 300.5.5FRON IAGE INCREASE FACTOR									
PERCENTAGE OF	OPEN SPACE (feet)								
BUILDING PERIMETER	0 to less than 20	20 to less than 25	25 to less than 30	30 or greater					
to less than 25	0	0	0	0					

\*\*Horizontal Building Separations located above the below grade garage (Type IA construction) and a portion of level 1 (Type IA construction) below the upper three stories of the Type VA construction.








## 598 SOUTH ALFRED STREET ALEXANDRIA, VA 22314 THE COMMUNITY BUILDERS, INC. ALFRED STREET BAPTIST CHURCH ALFRED STREET BAPTIST CHURCH HOUSING



DESCRIPTION DSUP SUBMISSION COMPLETENESS SUBMISSION

24001431.00 10/03/2025

CODE ANALYSIS

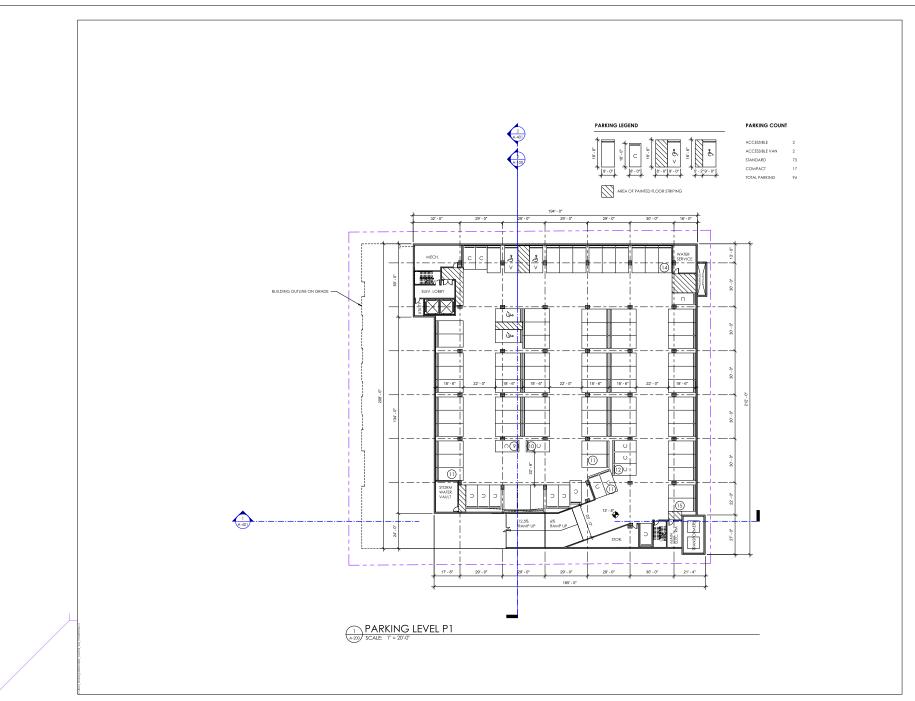





VISIONS NO DATE DESCRIPTION


PROJECT NUMBER

SCALE DRAWING TITLE

GARAGE LEVEL P1 PLAN

AMING NUMBER A-200

24001431.00 10/03/2025

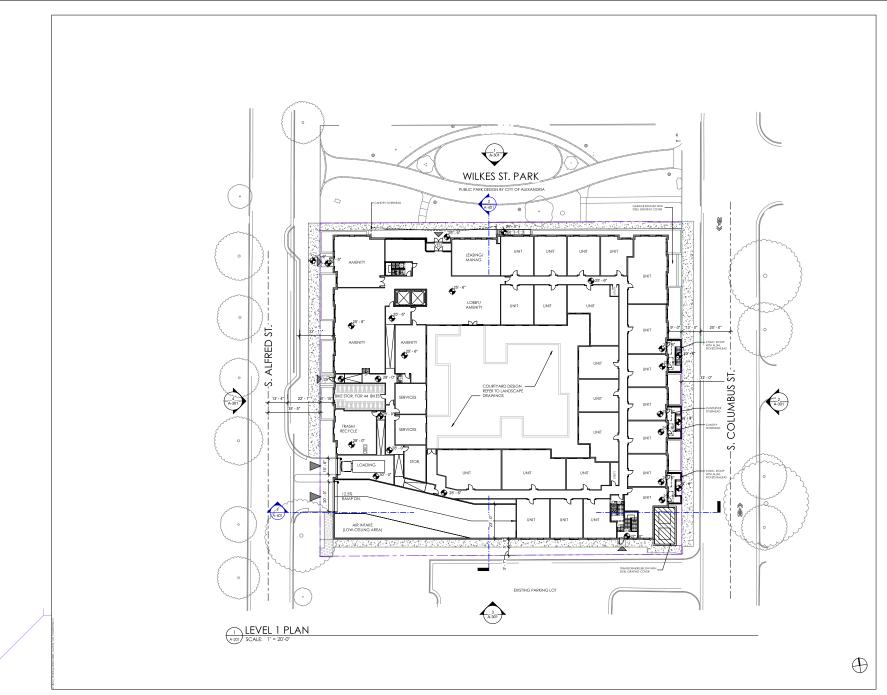








ISSUE DESCRIPTION 07.11.25 DSLP SUBMISSION 09.16.25 COMPLETENESS SUBMISSION 10.03.25 VERIFICATION RESUBMISSION

PROJECT NUMBER 24001431.00
DATE 10/03/2025

SCALE DRAWING TITLE

LEVEL 1 PLAN

IG NUMBER A-201

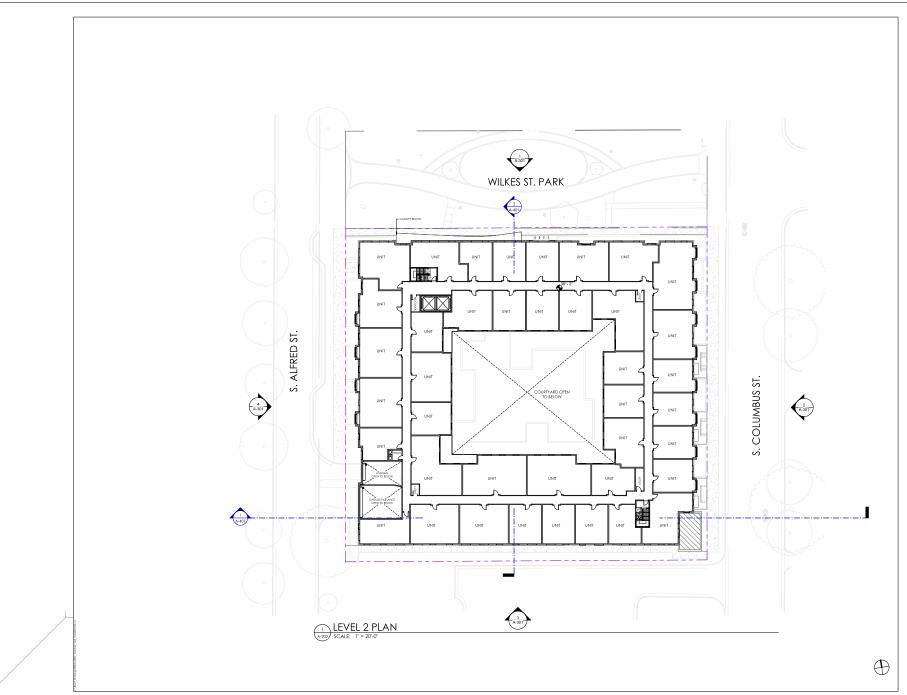








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24001431.00 10/03/2025

LEVEL 2 PLAN



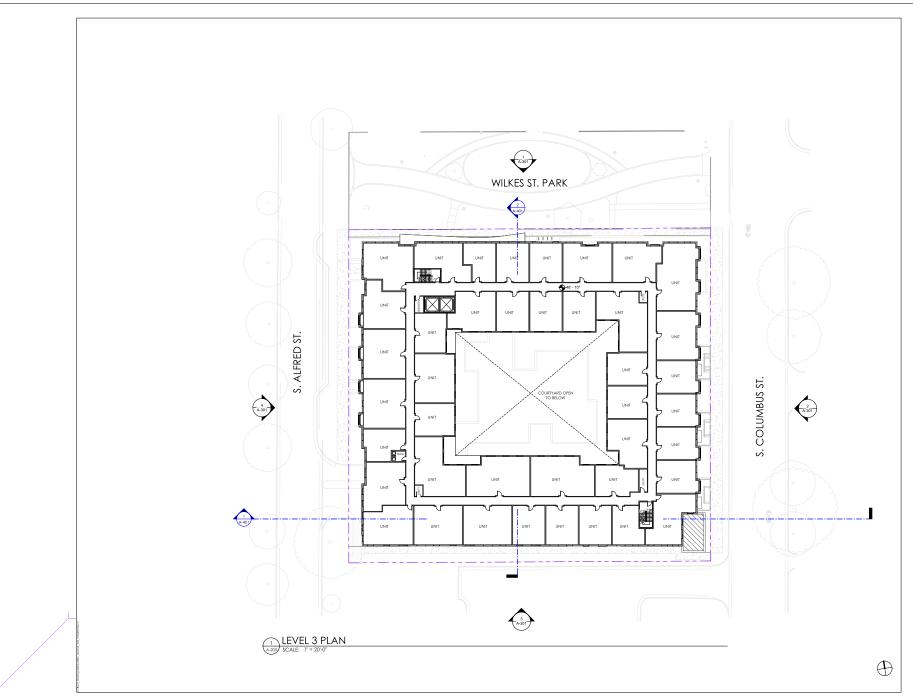






ISSUE DATE 07.11.25 09.16.25 10.03.25 DESCRIPTION
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COMPLETENESS SUBMISSION
MEDICATION PRIJEMISSION

LEVEL 3 PLAN

24001431.00 10/03/2025

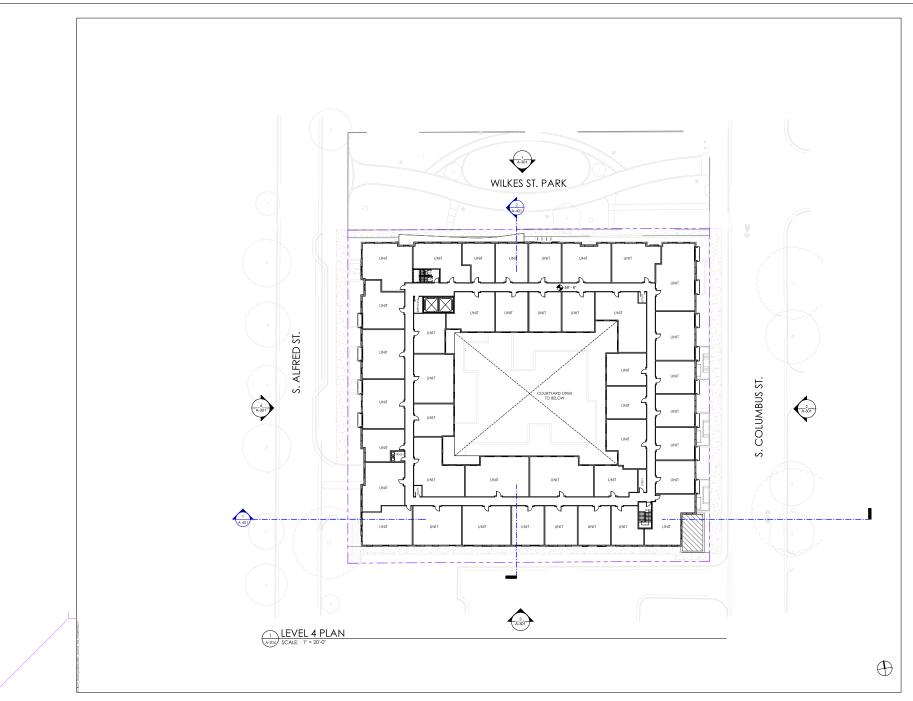






ISSUE DATE 07.11.25 09.16.25 10.03.25 DESCRIPTION
DSUP SUBMISSION
COMPLETENESS SUBMISSION
MEDICATION PRIJEMISSION

LEVEL 4 PLAN

A-204

24001431.00 10/03/2025

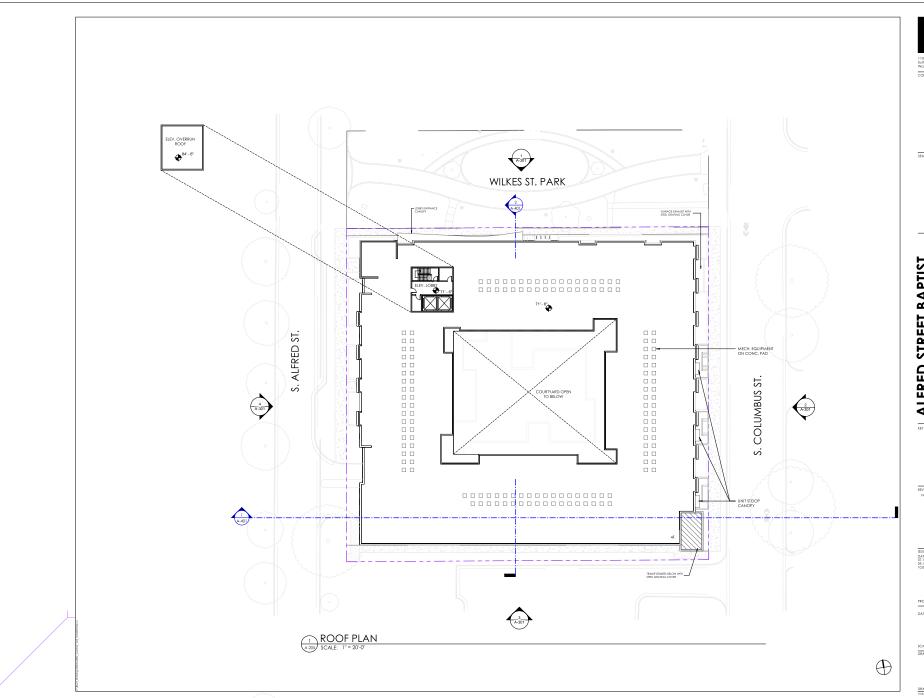








ISSUE
DATE DESCRIPTION
07.11.25 DSLP SUBMISSION
09.16.25 COMPLETENESS SUBMISSION
COMPLETENESS SUBMISSION

PROJECT NUMBER 24001431.00 DATE 24001431.00

SCALE DRAWING TITLE

ROOF PLAN

MING NUMBER A-205

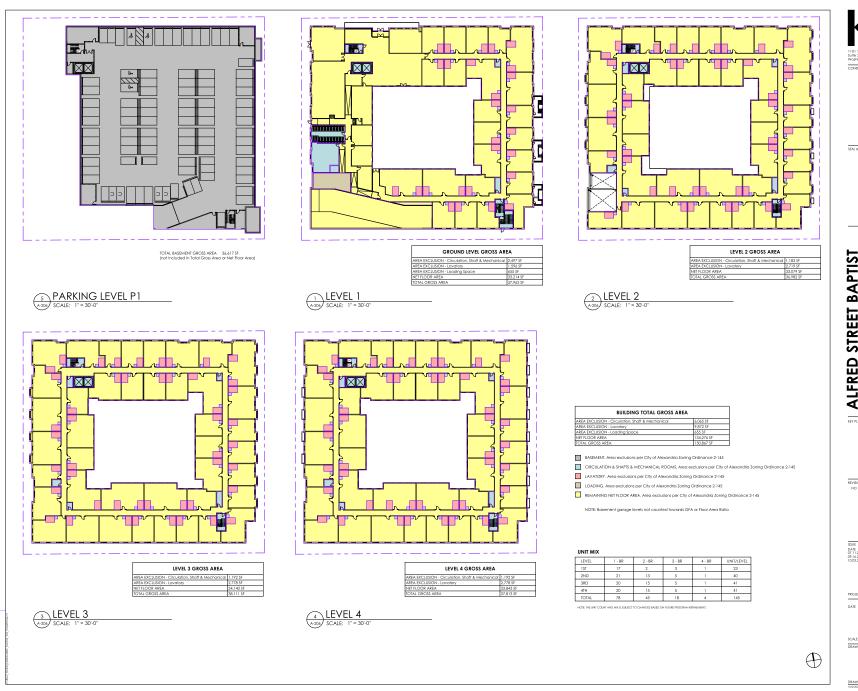





## ALFRED STREET BAPTIST CHURCH HOUSING




DATE DESCRIPTION
07.11.25 DSUP SUBMISSION
09.16.25 COMPLETENESS SUBMISSION
10.03.25 VERIFICATION DESUBMISSION

24001431.00 10/03/2025

AREA PLAN





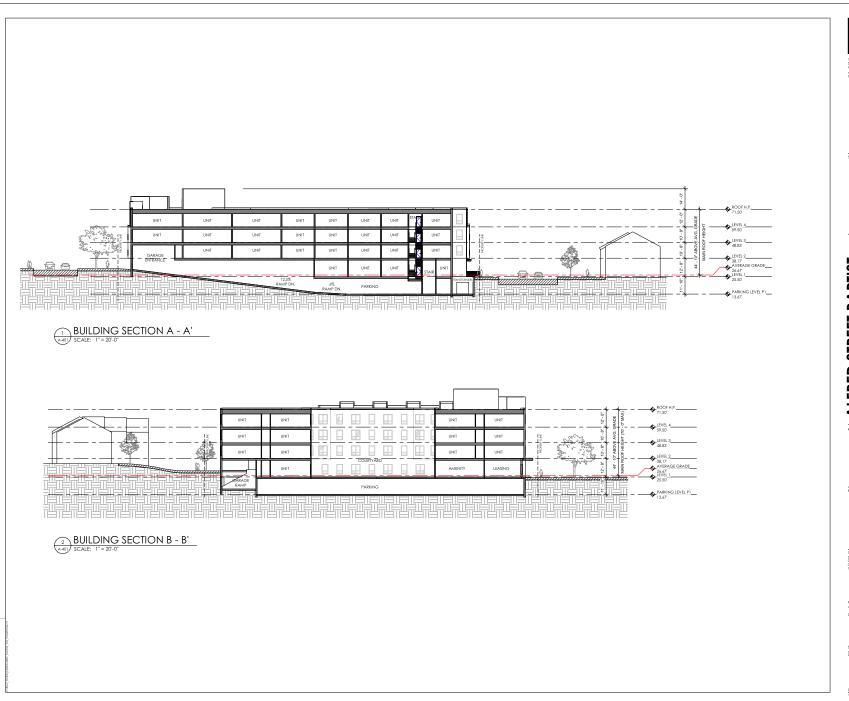







| ISSUE | DESCRIPTION | 07.11.25 | DSUP SUBMISSION | 09.14.25 | COMPLETENS SUBMISSION | 10.03.25 | VERIFICATION RESUBMISSION |

PROJECT NUMBER

DATE 10/03/2025

24001431.00

A-401

SCALE DRAWING TITLE


BUILDING SECTIONS

DRAWING NUMBER 10/2/2025 4:54:47 PM







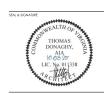

ALFRED STREET BAPTIST
CHURCH HOUSING
598 SOUTH ALFRED STREET

CETTANN A PENSISTE

ISSUE
DATE DESCRIPTION
07.11.25 DSUP SUBMISSION

PROJECT NUMBER

SCALE DRAWING TITLE

AERIAL VIEW


A-501


24001431.00 10/03/2025

DRAWING NUMBER 10/2/2025 4/54/48 PM





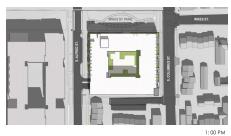

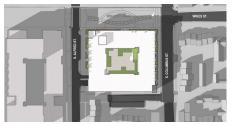







KGD



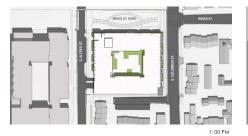


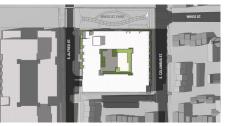

5: 00 PM


SEPTEMBER 22ND




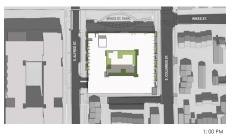




WINTER DECEMBER 22ND

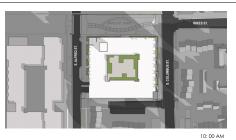

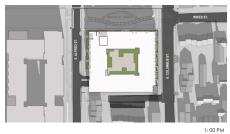

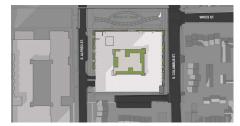

5: 00 PM

SUN-SHADE STUDY

A-502

24001431.00 10/03/2025





NE CORNER PERSPECTIVE - S. ALFRED ST.



NE CORNER PERSECPTIVE - WILKES ST. & S. COLUMBUS ST.



SE CORNER PERSPECTIVE - S. COLUMBUS ST.





**ALFRED STREET BAPTIST** CHURCH HOUSING 598 SOUTH ALFRED STREET ALEXANDRIA, VA 22314

THE COMMUNITY BUILDERS, INC. ALFRED STREET BAPTIST CHURCH

PERSPECTIVE

A-601

24001431.00 10/03/2025

RENDERINGS FOR ARCHITECTURAL ILLUSTRATION ONLY. REFER TO LANDSCAPE DRAWINGS FOR LANDSCAPE DESIGN.